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Communications Engineering Group

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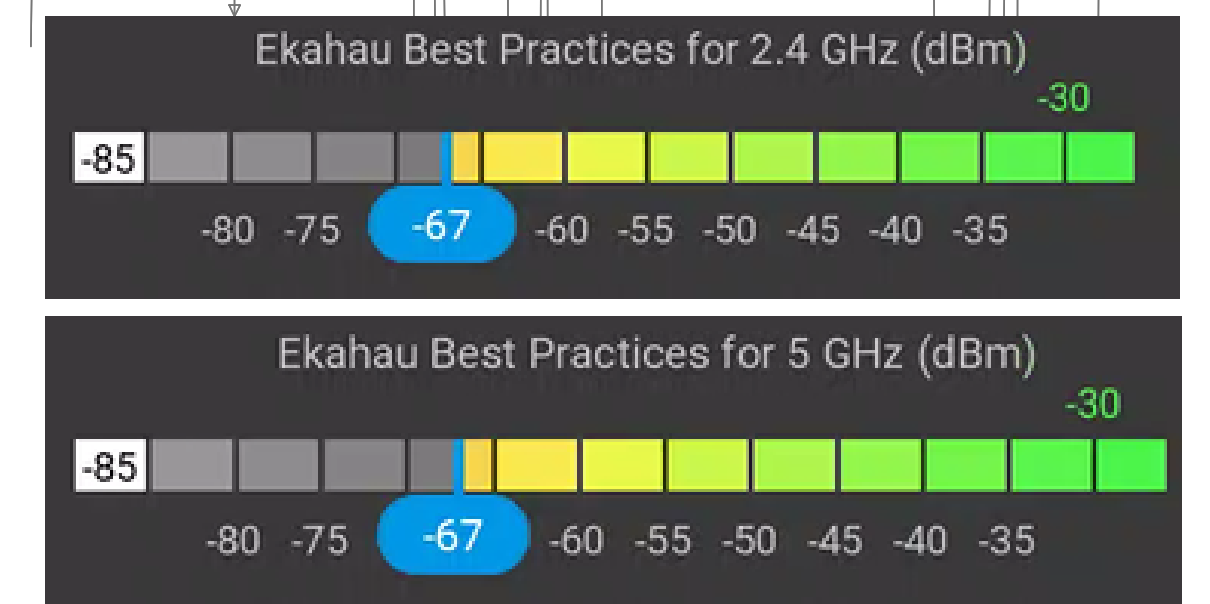
KEYNOTES	
TN1	1-2" C.
TN2	12" X 22" UNDERGROUND CONCRETE PULL BOX WITH PEDESTRIAN LID.
TN3	RACK R40 WITH FRONT AND REAR DOORS WITH INTEGRAL LOCKS.
TN4	2" C. STUB-UP TO BASE OF LIGHT POLE, PROVIDE 2" LIQUID FLEX CONDUIT UP TO PENDANT WIFI MOUNTING BRACKET AT 12'-0" AFF.
TN5	POLE MOUNTED WIRELESS ACCESS POINT MOUNTED AT 12'-0" AFF.
TN6	(2) 2" C.
TN7	(2) 2" C. TO AT&T SERVICE PULL BOX



1 ACCESS POINT DEVICE SITE PLAN

3/64" = 1'-0"

NORTH



KEY PLAN

NO	REVISION DESCRIPTION	DATE

PROJECT
CORN PALACE PARK - SUNNYVALE, CALIFORNIA
WIFI SYSTEMS
ADDRESS: SUNNYVALE, CA

ACCESS POINT DEVICE SITE PLAN

SCALE	FOR 30" x 42" SHEET
JOB NUMBER 2001385A	DRAWING
DRAWN BY PAM	TN1.1
DESIGNED BY PAM	
DATE 09-29-2023	
SHEET	OF