1171 SONORA COURT PLANNING SUBMITTAL #5

07.10.2025

PROJECT DESCRIPTION

THE 1171 SONORA COURT PROJECT AIMS TO ENHANCE THE COMMUNITY BY CREATING A TRANSIT-ORIENTED AND SUSTAINABLE DEVELOPMENT WITHIN THE LAWRENCE STATION AREA PLAN IN SUNNYVALE, CALIFORNIA. THE PROPOSED 7-STORY BUILDING WILL CONSIST OF 5 STORIES OF WOOD FRAMING ABOVE A 2-STORY CONCRETE PODIUM, OFFERING A TOTAL OF 172 UNITS, INCLUDING 170 AFFORDABLE RENTAL UNITS AND TWO ON-SITE MANAGER UNITS.

TO PROMOTE WALKABILITY AND ACTIVATE THE STREET, RESIDENTIAL LOBBIES, MANAGEMENT AND SERVICE OFFICES, AND BIKE KITCHEN WILL BE LOCATED AT THE STREET LEVEL. THE DESIGN PRESERVES EXISTING EVERGREEN TREES TO MAINTAIN THE SITE'S UNIQUE CHARACTER, AND AMENITIES SUCH AS A PEDESTRIAN PLAZA AND PODIUM COURTYARD WILL BE AVAILABLE FOR RESIDENTS.

PARKING WILL BE ACCOMMODATED WITH A RATIO OF 0.5 REGULAR CAR PER UNIT, PROVIDING 89 PARKING SPACES IN THE 2-STORY PODIUM GARAGE.

THE PROJECT WILL EXCEED LOCAL DEVELOPMENT LIMITS ON DENSITY UNDER CALIFORNIA STATE DENSITY BONUS LAW AB 1287 WHICH ALLOWS PROJECT WITHIN ONE HALF MILE OF A MAJOR TRANSIT STOP TO EXCEED LOCAL DEVELOPMENT LIMIT ON DENSITY. WITH CONTEMPORARY ARCHITECTURE AND THOUGHTFUL USE OF MATERIALS, THIS DEVELOPMENT SEEKS TO CREATE A VIBRANT SENSE OF COMMUNITY WHILE CONTRIBUTING MUCH-NEEDED AFFORDABLE HOUSING.

PROJECT TEAM

DEVELOPER

MP 1171 SONORA I ASSOCIATES, L.P. 303 VINTAGE PARK DRIVE, STE. 250 FOSTER CITY, CA 94404 CONTACT: CLAIRE KOSTOHRYZ, ASSOC. PROJECT MANAGER 650-759-1037 CLAIRE.KOSTOHRYZ@MIDPEN-HOUSING.ORG

2 THEATRE SQUARE, STE. 218 **ORINDA**, CA 94563 CONTACT: JESSE MARKMAN, ASLA, RLA 925-254-5422 JESSEM@JETT.LAND

LANDSCAPE ARCHITECT

ARCHITECT STUDIO T-SQ., INC, 1970 BROADWAY, STE. 408 OAKLAND, CA 94612

CIVIL ENGINEER

650.773.2465

1730 N. FIRST ST, STE. 600

CONTACT: DOUGLAS PETERSEN,

SENIOR PROJECT MANAGER

SAN JOSE, CA 95112

DPETERSEN@BKF.COM

CONTACT: HENRY TONG, AIA, NCARB, PRINCIPAL 562.436.3624 HTONG@STUDIOT-SQ.COM

RING.COM

PARKING BUEHLER 5 THIRD STREET, STE. 1125 SAN FRANCISCO, CA 94103 **CONTACT: JOHN HARVEY** SE,LEED AP, BD+C 415-495-1635 JHARVEY@BUEHLERENGINEE

PROJECT SUMMARY

Project Information	
Address	1171 SONORA CT
APN	205-50-024
Lot Area	1.3 AC
Lot Coverage	58%
Current Use	COMMERCIAL
Proposed Use	MULTI- FAMILY RESIDENTIAL
Zoning	MXD-1
Proposed Density	132 DU/AC
FAR	3.54
Occupancy	
Residential	R-2
Garage	S-2
Construction Type	
R-2	TYPE IIIA, FULLY SPRINKLERED
S-2	TYPE IA, FULLY SPRINKLERED
Building Height	
Building CodeE - Type IIIA	85' to Roof membrane
Zoning Allowed	100'
Proposed	76' to Roof membrane, parapets vary
Setback	
Front	25' PROVIDED (N/A REQUIRED)
Side	10' PROVIDED (10' MINIMUM)
Rear	10' PROVIDED (10' MINIMUM)
Usable Open Space	
Required	50 SF PER UNIT
Provided	57.05 SF PER UNIT
Landscaped Area	
Required	20% OF ENTIRE SITE/ 11,346 SF
Provided	11,576 SF/ 68.09 SF PER UNIT
Site Permeability Calculations	
Pervious Area	11,576 SF
Impervious Area	45,154 SF
Concessions And Waivers	
Concessions Requested	4
Waivers Requested	2

Existing Surface Parking						42
Affordable Units	Quan.	Average N.S.F.	Mix	Rentable S.F.	Parking Ratio	Parking Provided
Unit S1	15	452	8.8%	6,780		
Unit S2	11	400	6.5%	4,393		
Unit S3	1	410	0.6%	410		
Studios Total	27	429	15.9%	11,583	0.5	13.5
Unit 1A	6	648	3.5%	3,884		
Unit 1B	51	489	30.0%	24,897		
1 BR Units Total	57	505	33.5%	28781	0.5	28.5
Unit 2A	43	710	25.3%	30514	0.5	21.5
Unit 3A	43	964	25.3%	41467	0.5	21.5
Total Affordable Units	170	663	100%	112,345	0.5	85

Manager's Units	Quan.	Average N.S.F.	Mix	Rentable S.F.	Parking Ratio	Parking Provided
2BR (Unit 2A)	2	721		1442	0.5	2
Total Manager Units	2					

Parking Required	Units	Ratio	Required	Provided
Assigned Residential	170	0.5	85	85
Manager Units	2	0.5	1	2
Staff Parking				1
Total			86	88

	Туре	Code Reference	Required	Level 1	Level 2	Provided
tandard						
	Standard Stall (8'-6" x 18'-0") w/ Level 1 Receptacle	-		8	30	
	EV Ready w/ Level 2 Receptacle (9'-0" x 18'-0")	40% Total Stalls CalGreen 4.106.4.2.2.1b	36	36	0	
	Level 2 EVSE Standard Connection (9'-0" x 18'-0")	CalGreen July 2024 Supplemental 4.106.4.2.2.2b	7	7	0	
Sub Total						
Accessible						
	Standard Accessible (9'-0" x 18'-0")	CBC Table 11b-208.2.3.1	3	1	2	
	Van Accessible (9'-0" x 18'-0")	CBC Table 11b-208.2.4	1	0	1	
	EVCS Standard Accessible (9'-0" x 18'-0")	CBC Table 11b-208.3.2.1	1	1	0	
	EVCS Van Accessible (9'-0" x 18'-0")	CBC Table 11b-208.3.2.1	2*	1	1	
Sub Total						
Total			50			

*One EVCS Capable Van Accessible stall for residents and one for staff

Bike Parking		
Total Bike Parking Required	CLASS I: 1 per 3 units	58
	CLASS II: 1 per 15 units	12
Total Bike Parking Provided	CLASS I	110
	CLASS II	12



- Architecture
- Planning
- **Urban Design**
- 1970 Broadway, Suite 408 Oakland, California 94612
- (510) 451 2850

THIS DOCUMENT CONTAINS INFORMATION PROPRIETARY TO STUDIO T-SQ, INC. AND IS FURNISHED IN CONFIDENCE FOR THE LIMITED PURPOSE OF EVALUATION OR REVIEW. THIS DOCUMENT OR ITS CONTENTS MAY NOT BE USED FOR ANY OTHER PURPOSE AND MAY NOT BE REPRODUCED OR DISCLOSED TO OTHERS WITHOUT THE PRIOR WRITTEN



Sheet Title:

PROJECT SUMMARY

Job No. Scale:


21009 07/10/2025 As indicated Drawn By:

Sheet No:

G 1.0

VICINITY MAP

	Sim 3
	The second section of the second
Central Expy	
	Expy
	awrence
	A COLUMN TO THE
Kifer Rd	(iter 8d
	Zeno way
Sonora Ct. provact	
	Lawrence Caltrain
	Station Again by
Azalea Oy Aster Ave.	
Goodle Farth Control of the Control	Monroe St

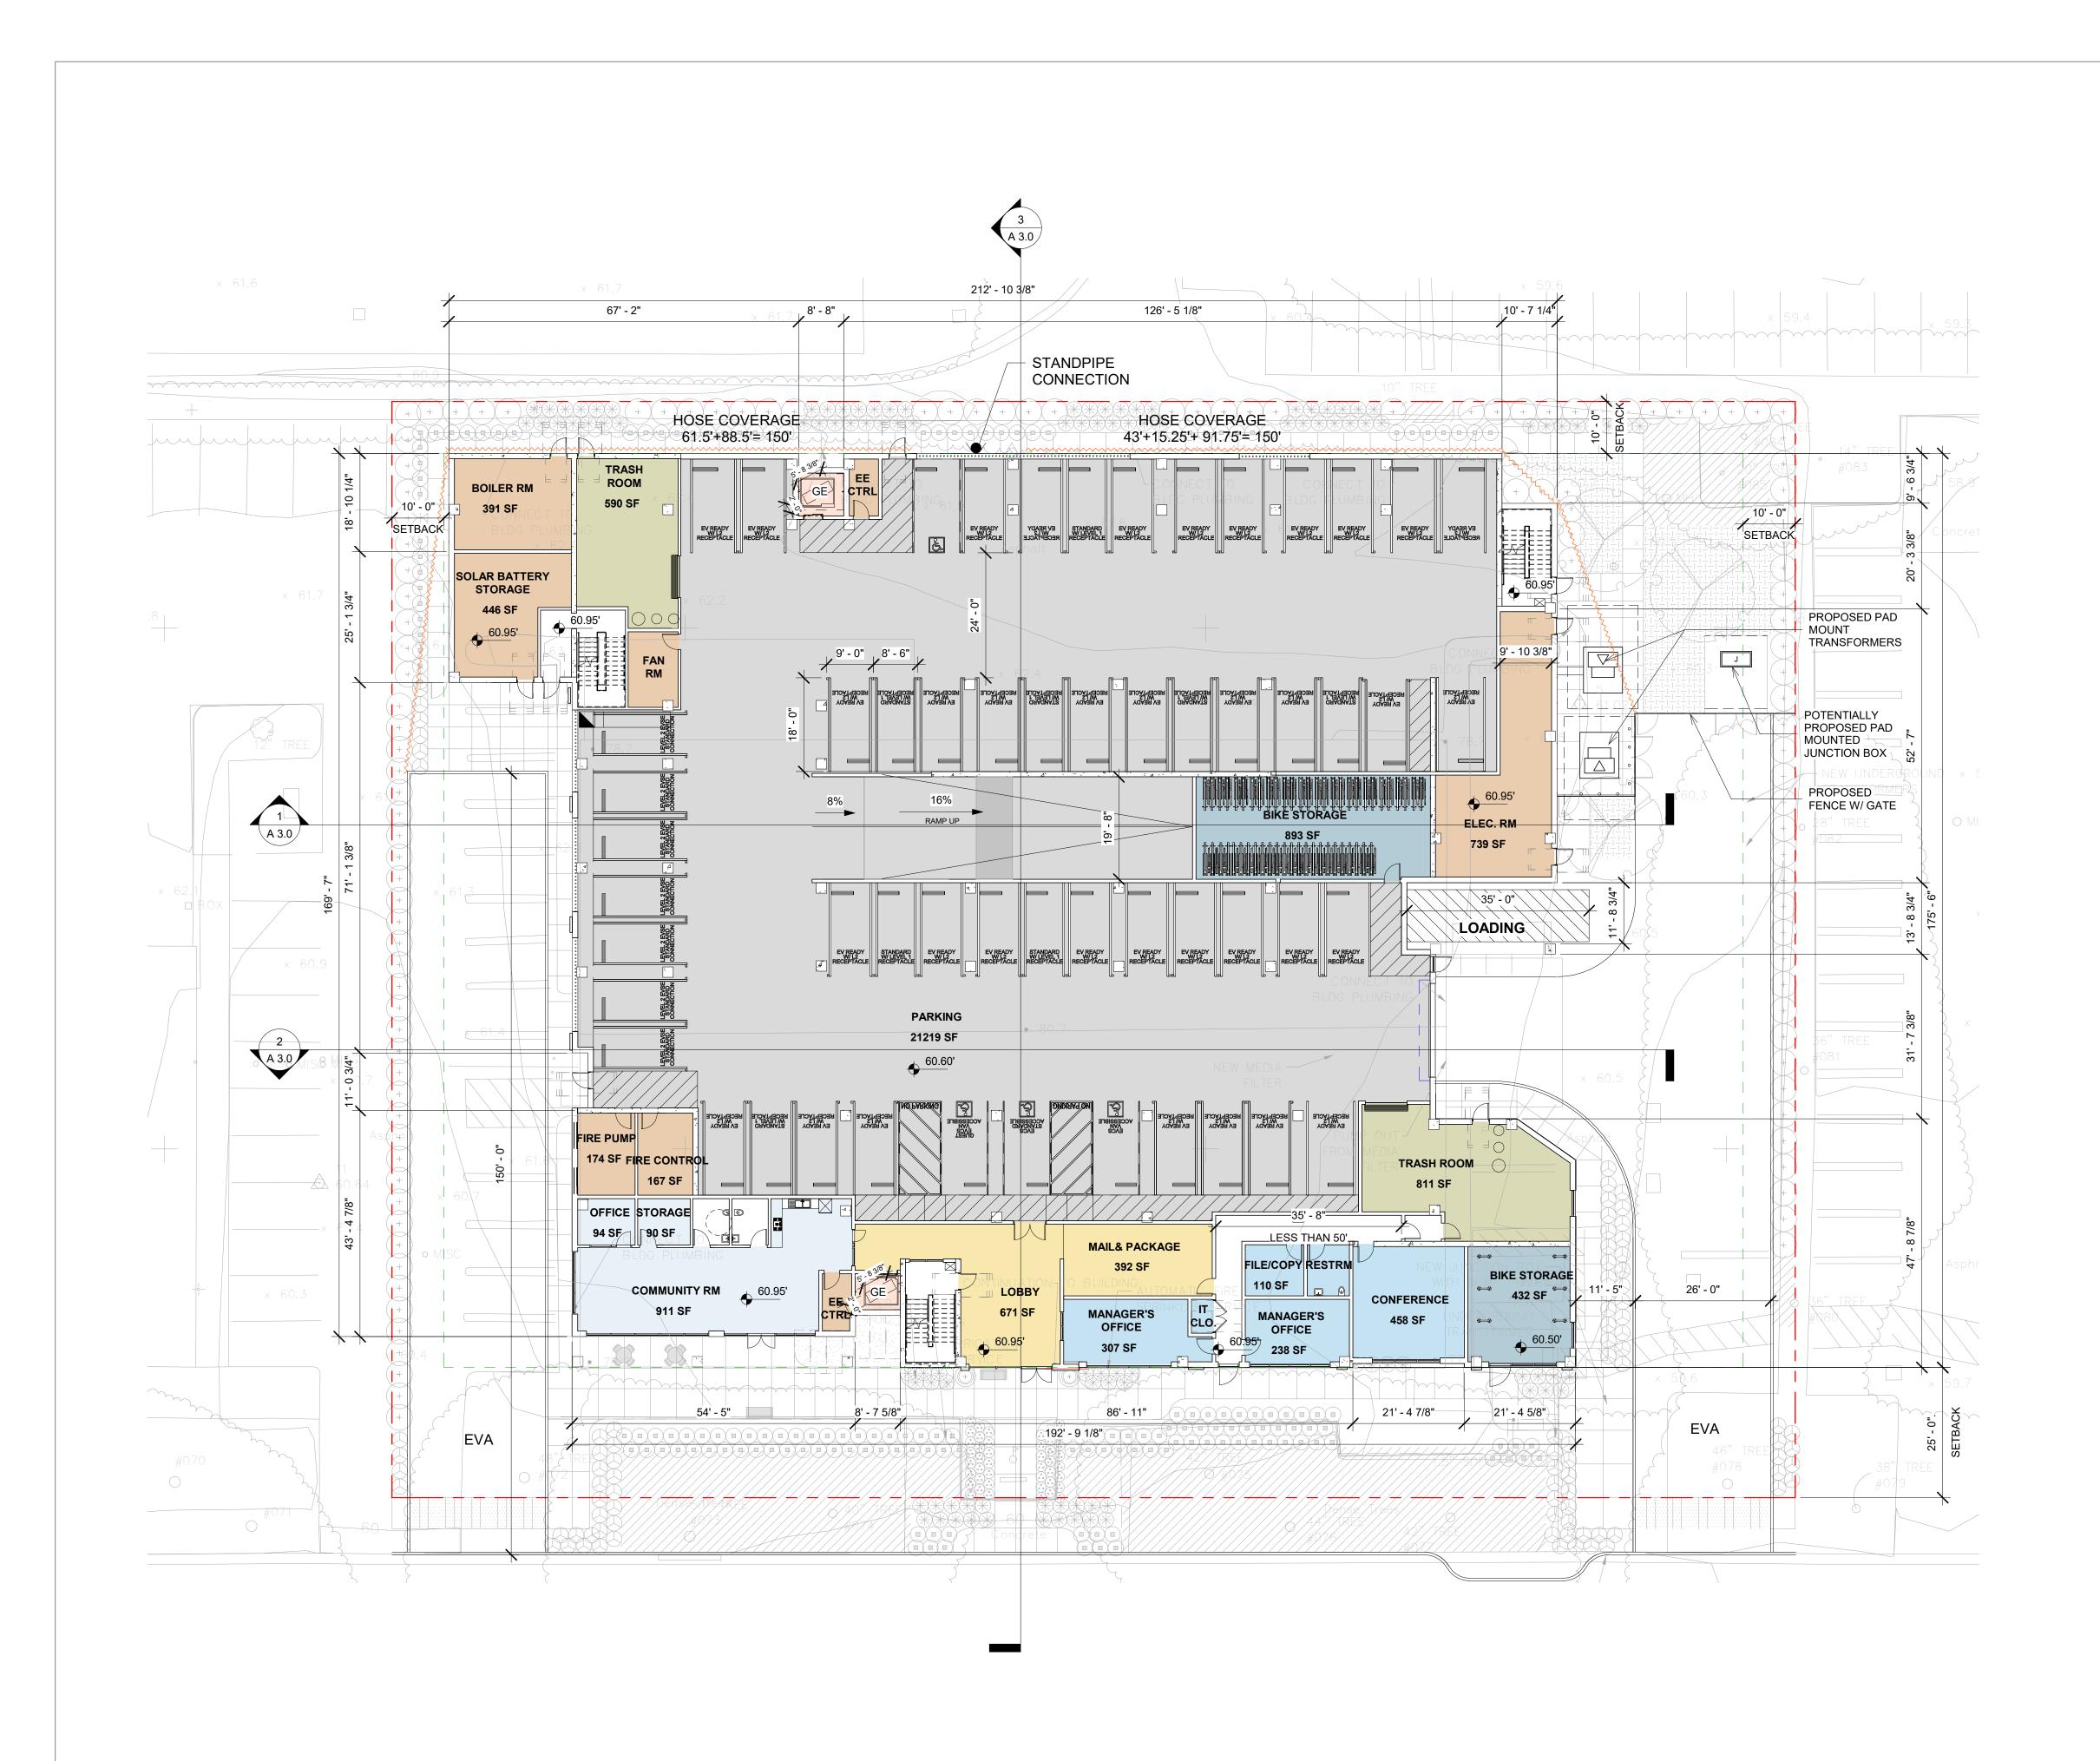



- : Architecture
- Planning
- : Urban Design
- 1970 Broadway, Suite 408 Oakland, California 94612
- (510) 451 2850

THIS DOCUMENT CONTAINS INFORMATION PROPRIETARY TO STUDIO T-SQ, INC. AND IS FURNISHED IN CONFIDENCE FOR THE LIMITED PURPOSE OF EVALUATION OR REVIEW. THIS DOCUMENT OR ITS CONTENTS MAY NOT BE USED FOR ANY OTHER PURPOSE AND MAY NOT BE REPRODUCED OR DISCLOSED TO OTHERS WITHOUT THE PRIOR WRITTEN CONSENT OF STUDIO T-SQ., INC. ALL RIGHTS RESERVED, COPYRIGHT 2021.



SONORA

Sheet Title:


1171


BUILDING PLAN LEVEL 1

Scale: Drawn By:

21009 07/10/2025 1/16" = 1'-0"

Sheet No:

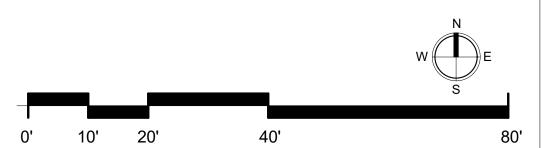

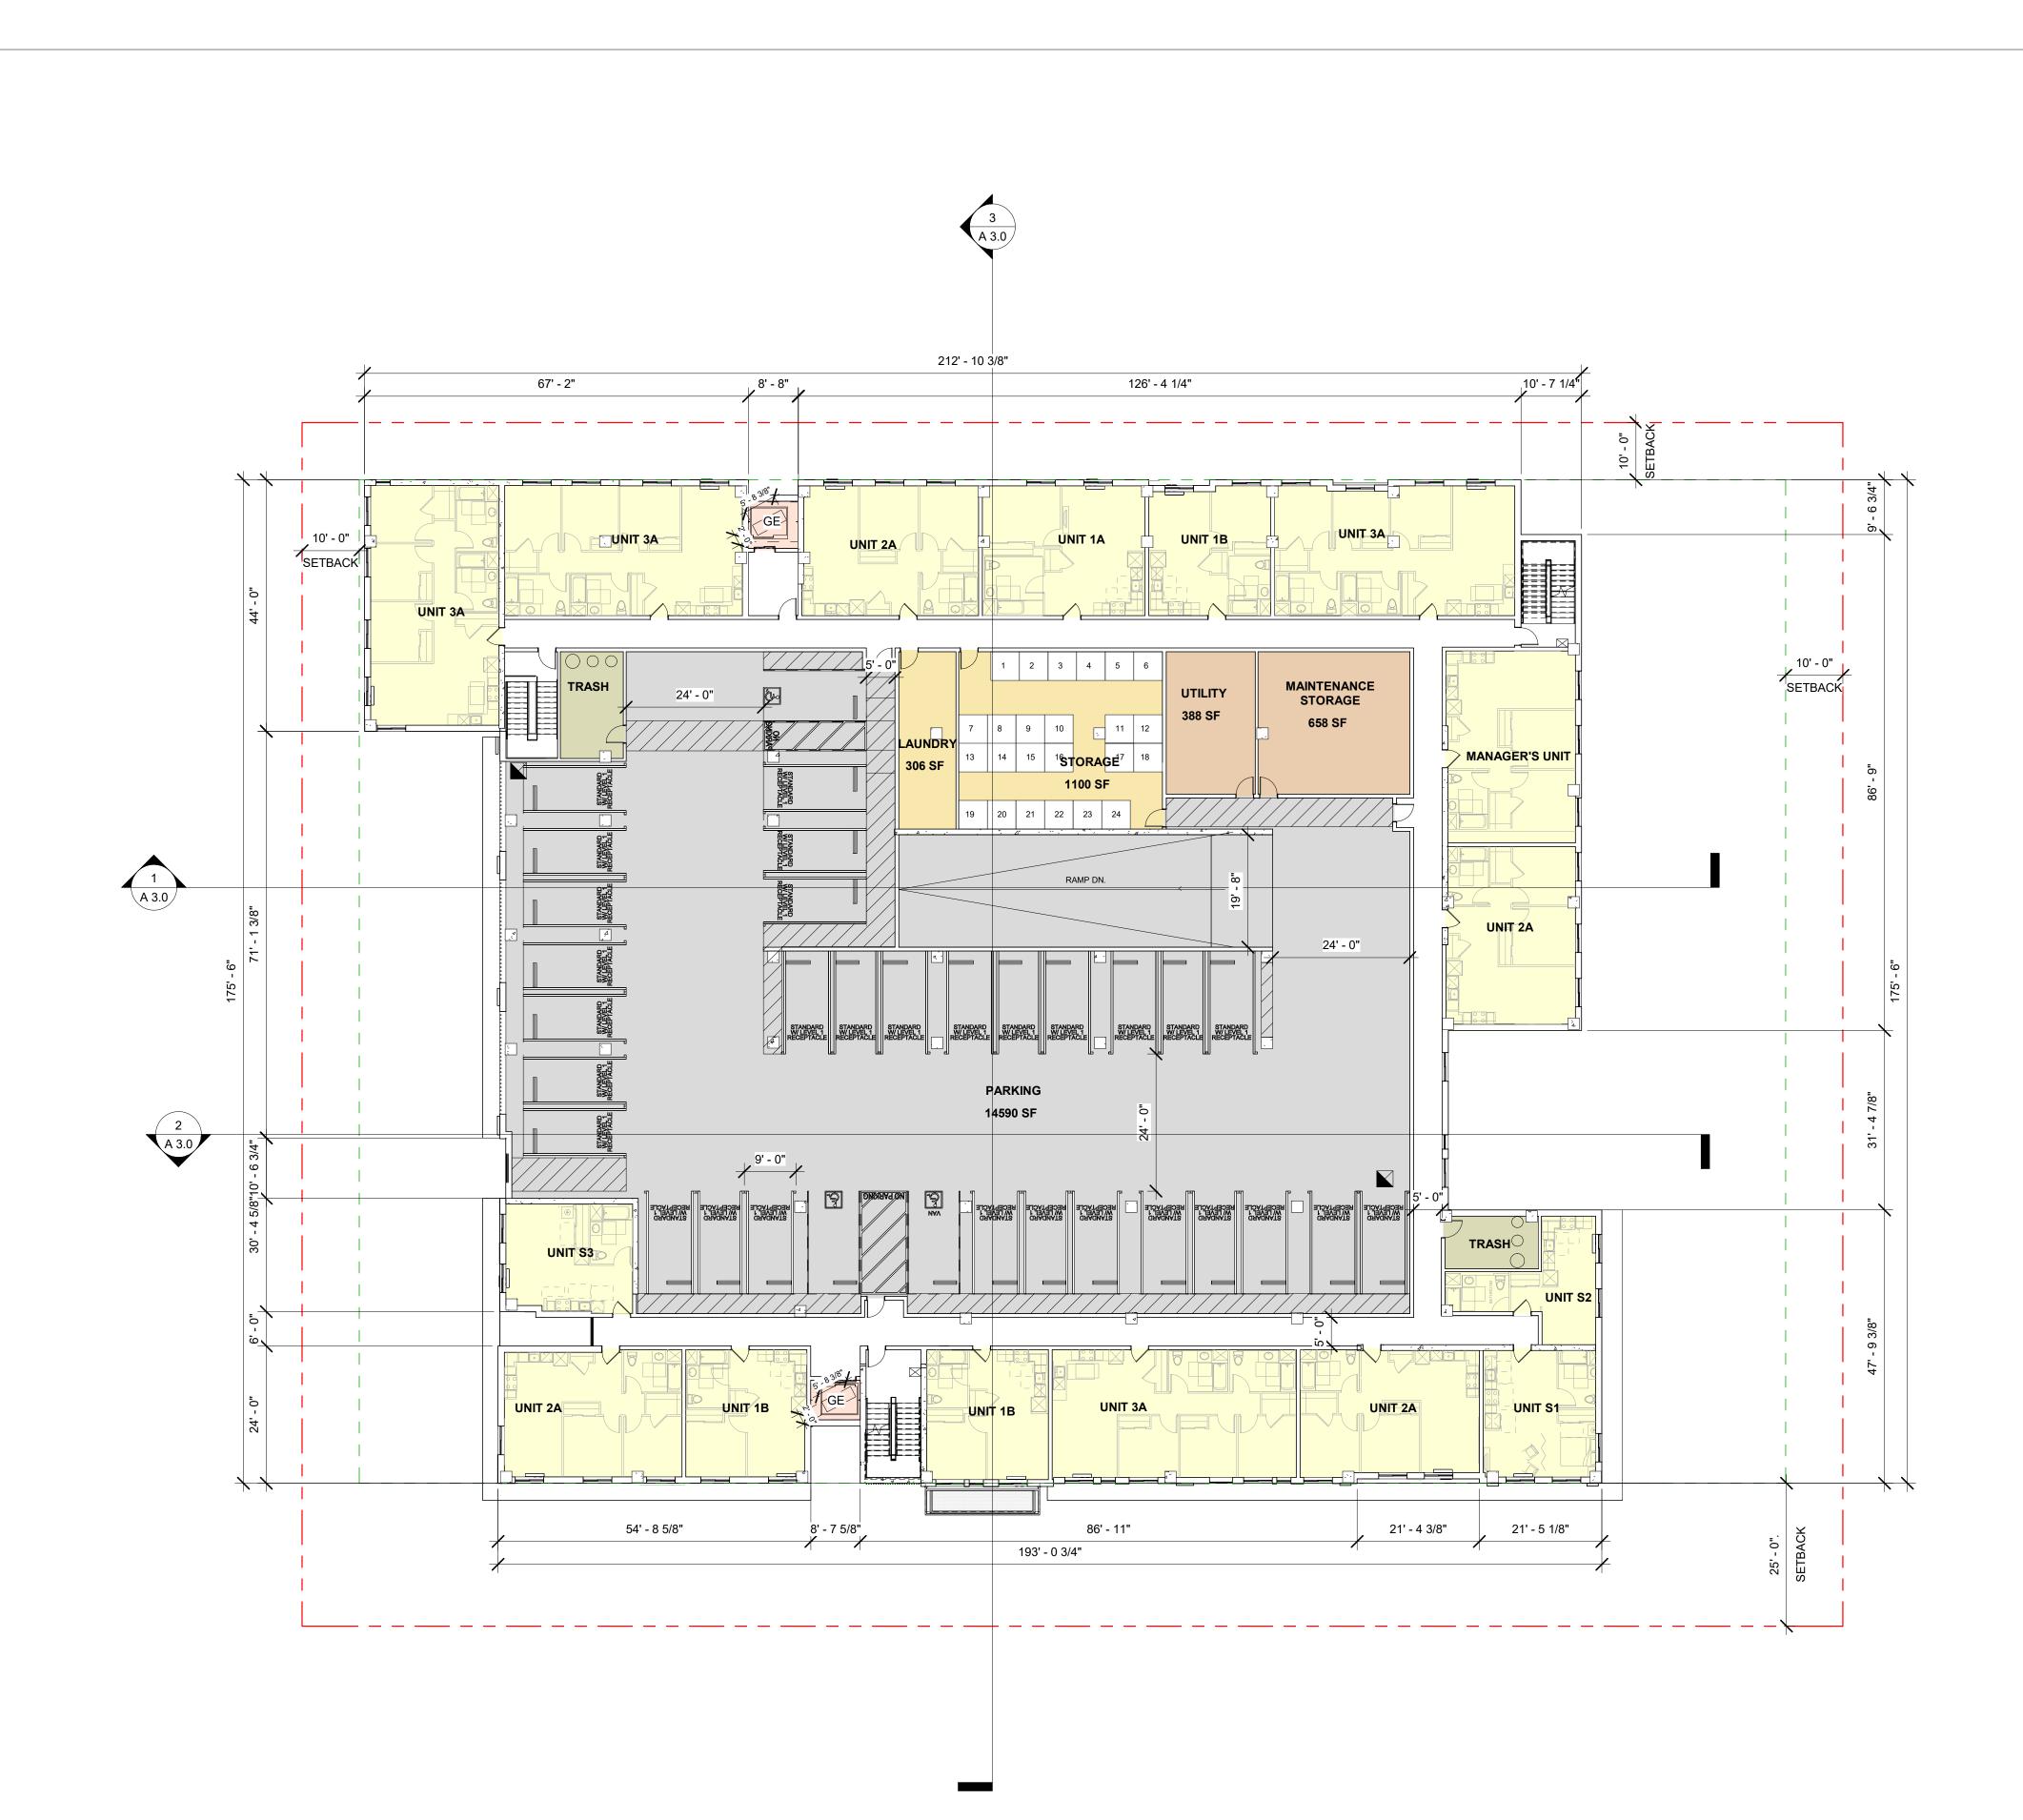



- : Architecture
- Planning
- : Urban Design
- 1970 Broadway, Suite 408 Oakland, California 94612
- (510) 451 2850

THIS DOCUMENT CONTAINS INFORMATION PROPRIETARY TO STUDIO T-SQ, INC. AND IS FURNISHED IN CONFIDENCE FOR THE LIMITED PURPOSE OF EVALUATION OR REVIEW. THIS DOCUMENT OR ITS CONTENTS MAY NOT BE USED FOR ANY OTHER PURPOSE AND MAY NOT BE REPRODUCED OR DISCLOSED TO OTHERS WITHOUT THE PRIOR WRITTEN CONSENT OF STUDIO T-SQ., INC. ALL RIGHTS RESERVED, COPYRIGHT 2021.



SONORA


Sheet Title:

BUILDING PLAN LEVEL 2

21009 Scale: Drawn By:

07/10/2025 1/16" = 1'-0"

Sheet No:

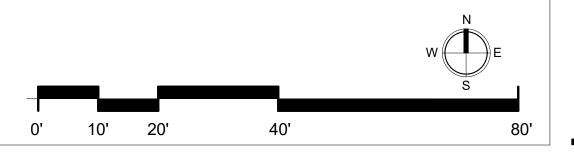





- : Architecture
- : Planning
- : Urban Design
- 1970 Broadway, Suite 408 Oakland, California 94612 (510) 451 - 2850

THIS DOCUMENT CONTAINS INFORMATION
PROPRIETARY TO STUDIO T-SQ, INC. AND IS FURNISHED
IN CONFIDENCE FOR THE LIMITED PURPOSE OF
EVALUATION OR REVIEW. THIS DOCUMENT OR ITS
CONTENTS MAY NOT BE USED FOR ANY OTHER
PURPOSE AND MAY NOT BE REPRODUCED OR
DISCLOSED TO OTHERS WITHOUT THE PRIOR WRITTEN
CONSENT OF STUDIO T-SQ., INC. ALL RIGHTS
RESERVED, COPYRIGHT 2021.



o.'

I ASSOCIATES, I

SONORA COUR

1171 SON Sunnyvale, Califor

Sheet Title:


BUILDING PLAN LEVEL 3

Job No. Date: Scale: Drawn By:

0. 21009 07/10/2025 1/16" = 1'-0" By:

Sheet No:

A 1.

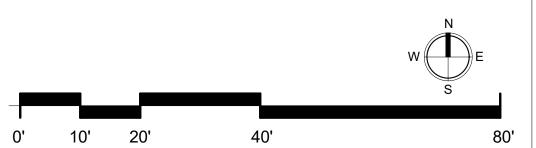



- : Architecture
- Planning
- : Urban Design
- 1970 Broadway, Suite 408 Oakland, California 94612 (510) 451 - 2850

THIS DOCUMENT CONTAINS INFORMATION PROPRIETARY TO STUDIO T-SQ, INC. AND IS FURNISHED IN CONFIDENCE FOR THE LIMITED PURPOSE OF EVALUATION OR REVIEW. THIS DOCUMENT OR ITS CONTENTS MAY NOT BE USED FOR ANY OTHER PURPOSE AND MAY NOT BE REPRODUCED OR DISCLOSED TO OTHERS WITHOUT THE PRIOR WRITTEN CONSENT OF STUDIO T-SQ., INC. ALL RIGHTS RESERVED, COPYRIGHT 2021.



OCIATES, L

Ilifornia

1 SONORA (vale, California

1171 Sunnyval

Sheet Title:

BUILDING PLAN LEVEL 4-6


Job No. Date: Scale: Drawn By:

21009 07/10/2025 1/16" = 1'-0"

Sheet No:

0' 10' 20'

A 1.3

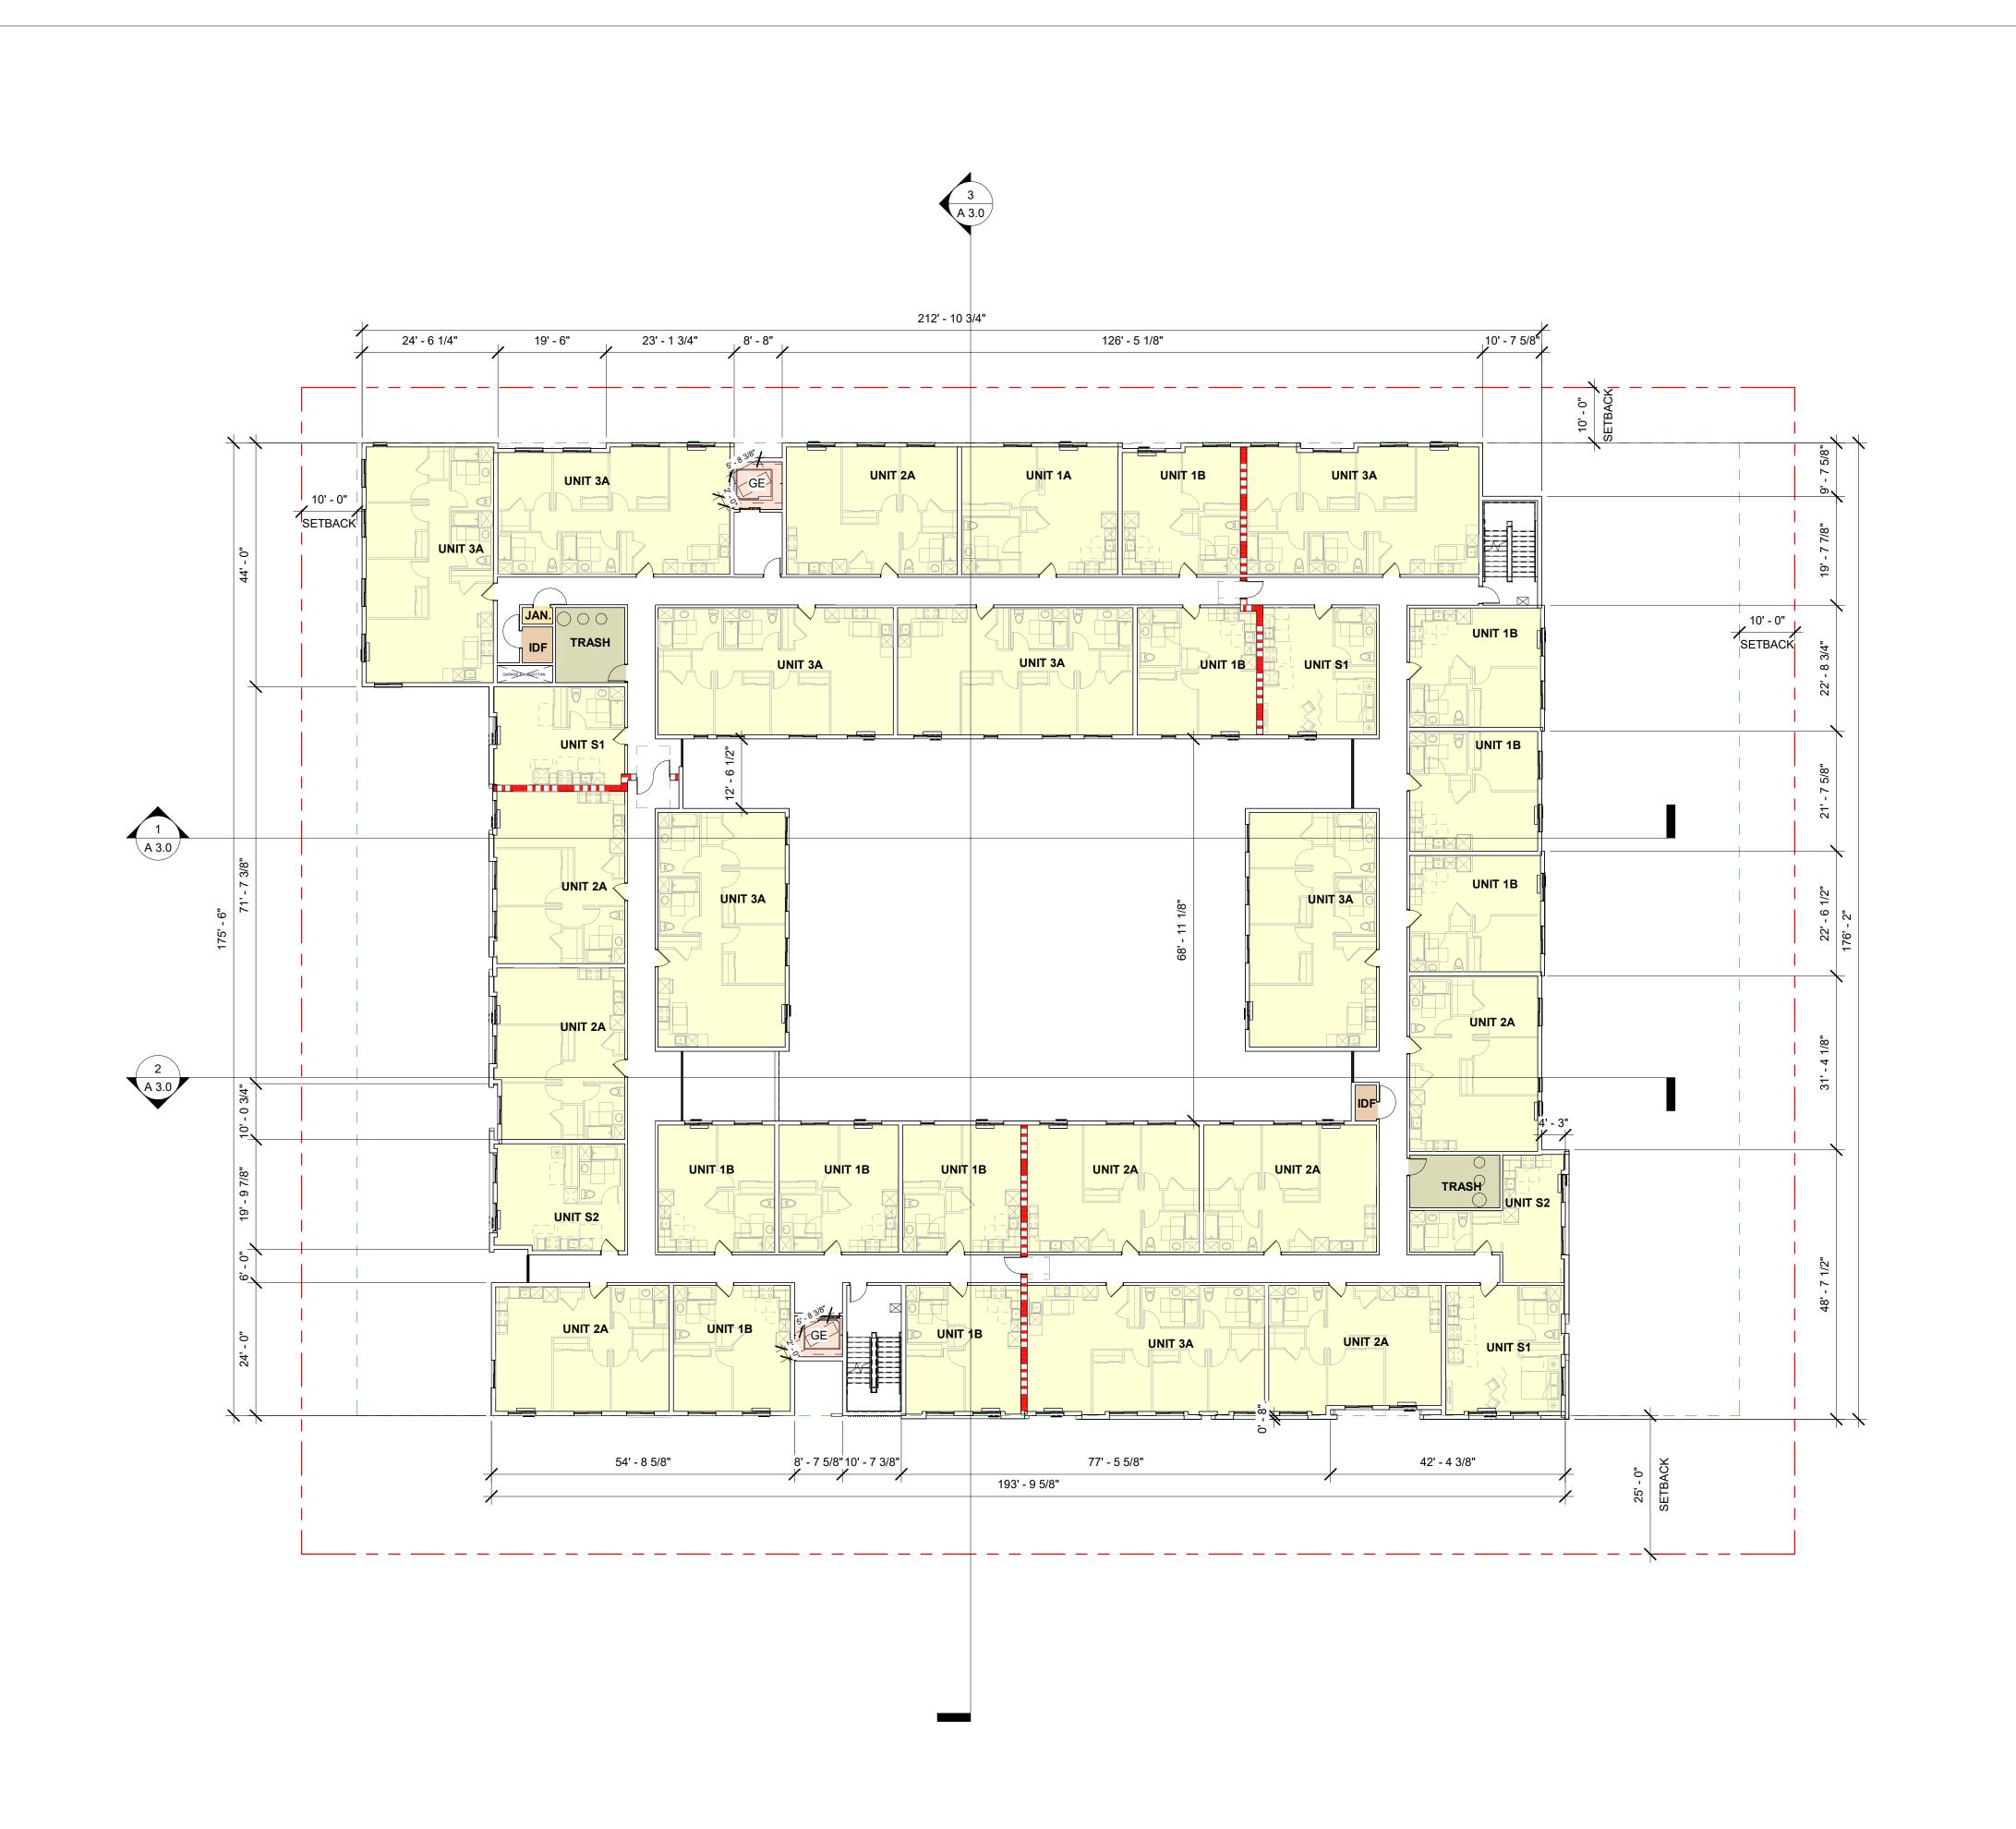



THIS DOCUMENT CONTAINS INFORMATION PROPRIETARY TO STUDIO T-SQ, INC. AND IS FURNISHED IN CONFIDENCE FOR THE LIMITED PURPOSE OF EVALUATION OR REVIEW. THIS DOCUMENT OR ITS CONTENTS MAY NOT BE USED FOR ANY OTHER PURPOSE AND MAY NOT BE REPRODUCED OR DISCLOSED TO OTHERS WITHOUT THE PRIOR WRITTEN CONSENT OF STUDIO T-SQ., INC. ALL RIGHTS RESERVED, COPYRIGHT 2021.



SONORA

1171 Sunnyval

Sheet Title:


BUILDING PLAN LEVEL 7


Job No. Scale: Drawn By:

21009 07/10/2025 1/16" = 1'-0"

Sheet No:



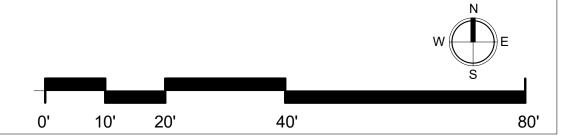

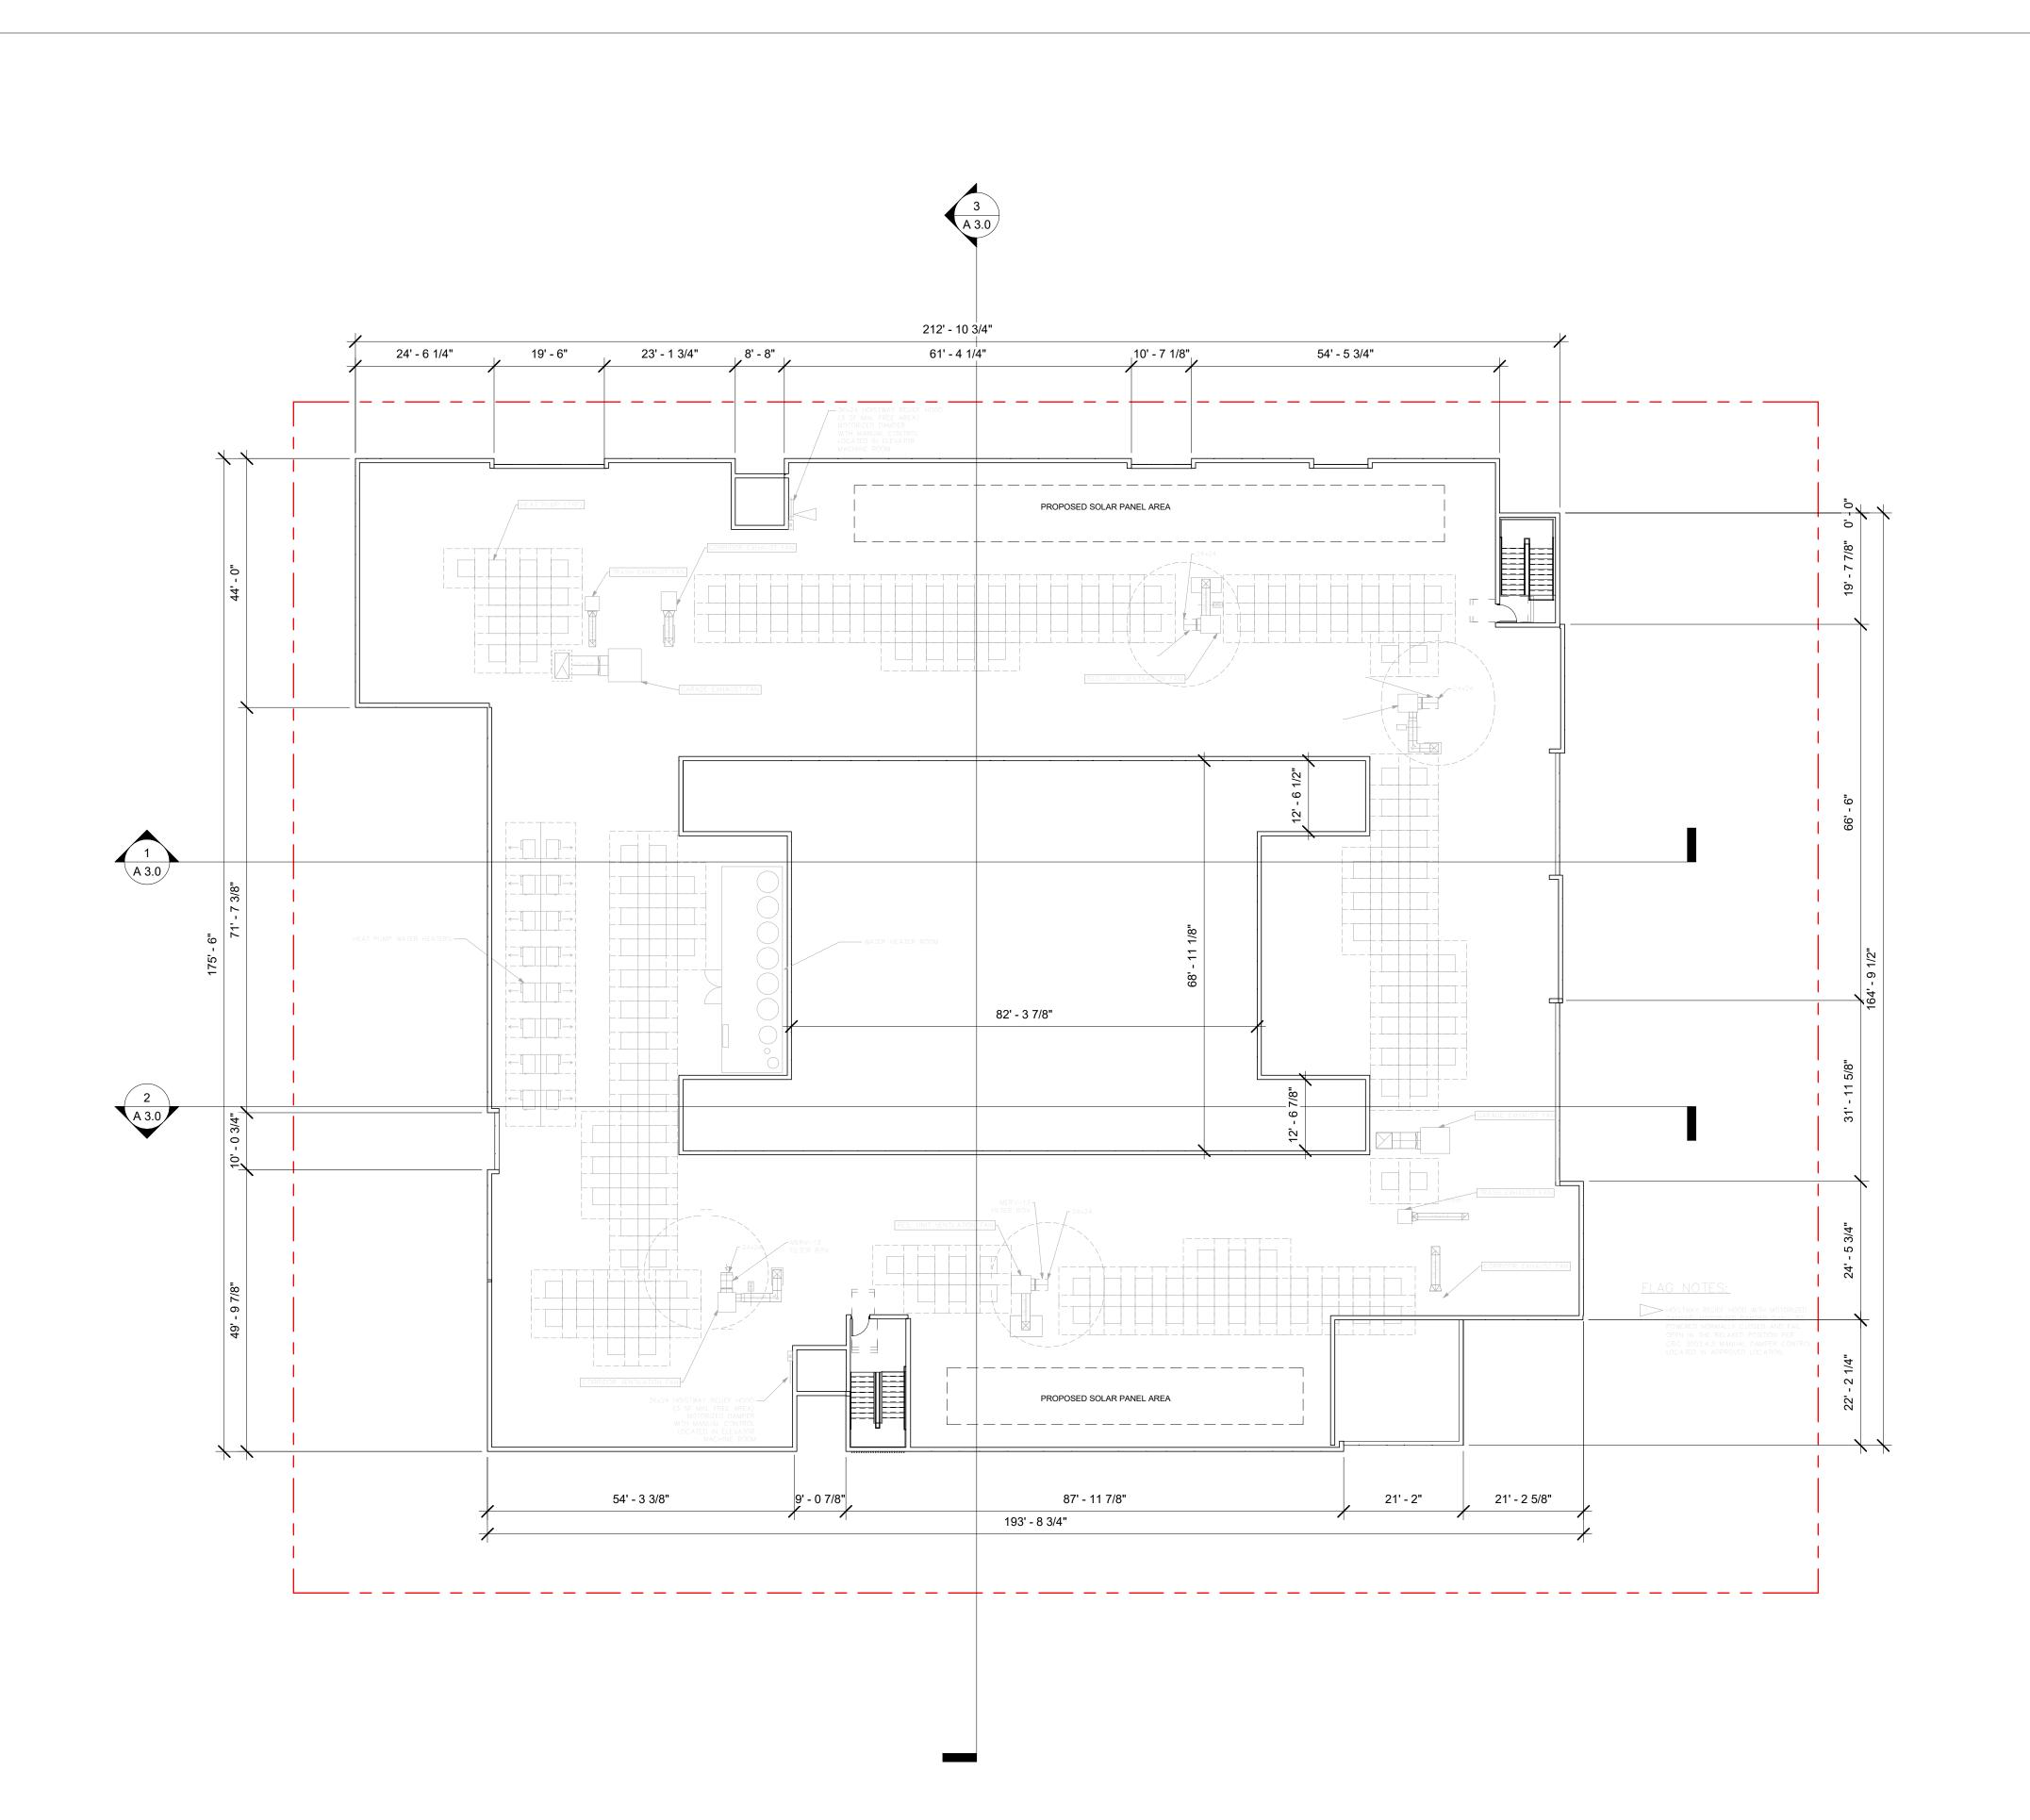



- : Architecture
- Planning
- : Urban Design
- 1970 Broadway, Suite 408
- Oakland, California 94612 (510) 451 - 2850

THIS DOCUMENT CONTAINS INFORMATION PROPRIETARY TO STUDIO T-SQ, INC. AND IS FURNISHED IN CONFIDENCE FOR THE LIMITED PURPOSE OF EVALUATION OR REVIEW. THIS DOCUMENT OR ITS CONTENTS MAY NOT BE USED FOR ANY OTHER PURPOSE AND MAY NOT BE USED FOR ANY OTHER
PURPOSE AND MAY NOT BE REPRODUCED OR
DISCLOSED TO OTHERS WITHOUT THE PRIOR WRITTEN
CONSENT OF STUDIO T-SQ., INC. ALL RIGHTS
RESERVED, COPYRIGHT 2021.



SONORA 117


Sheet Title:


ROOF PLAN

Job No. Date: Scale: Drawn By:

21009 07/10/2025 1/16" = 1'-0"

Sheet No:

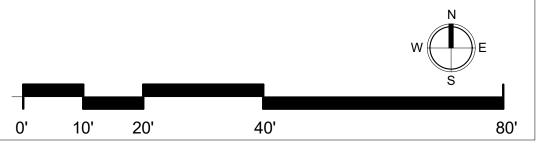

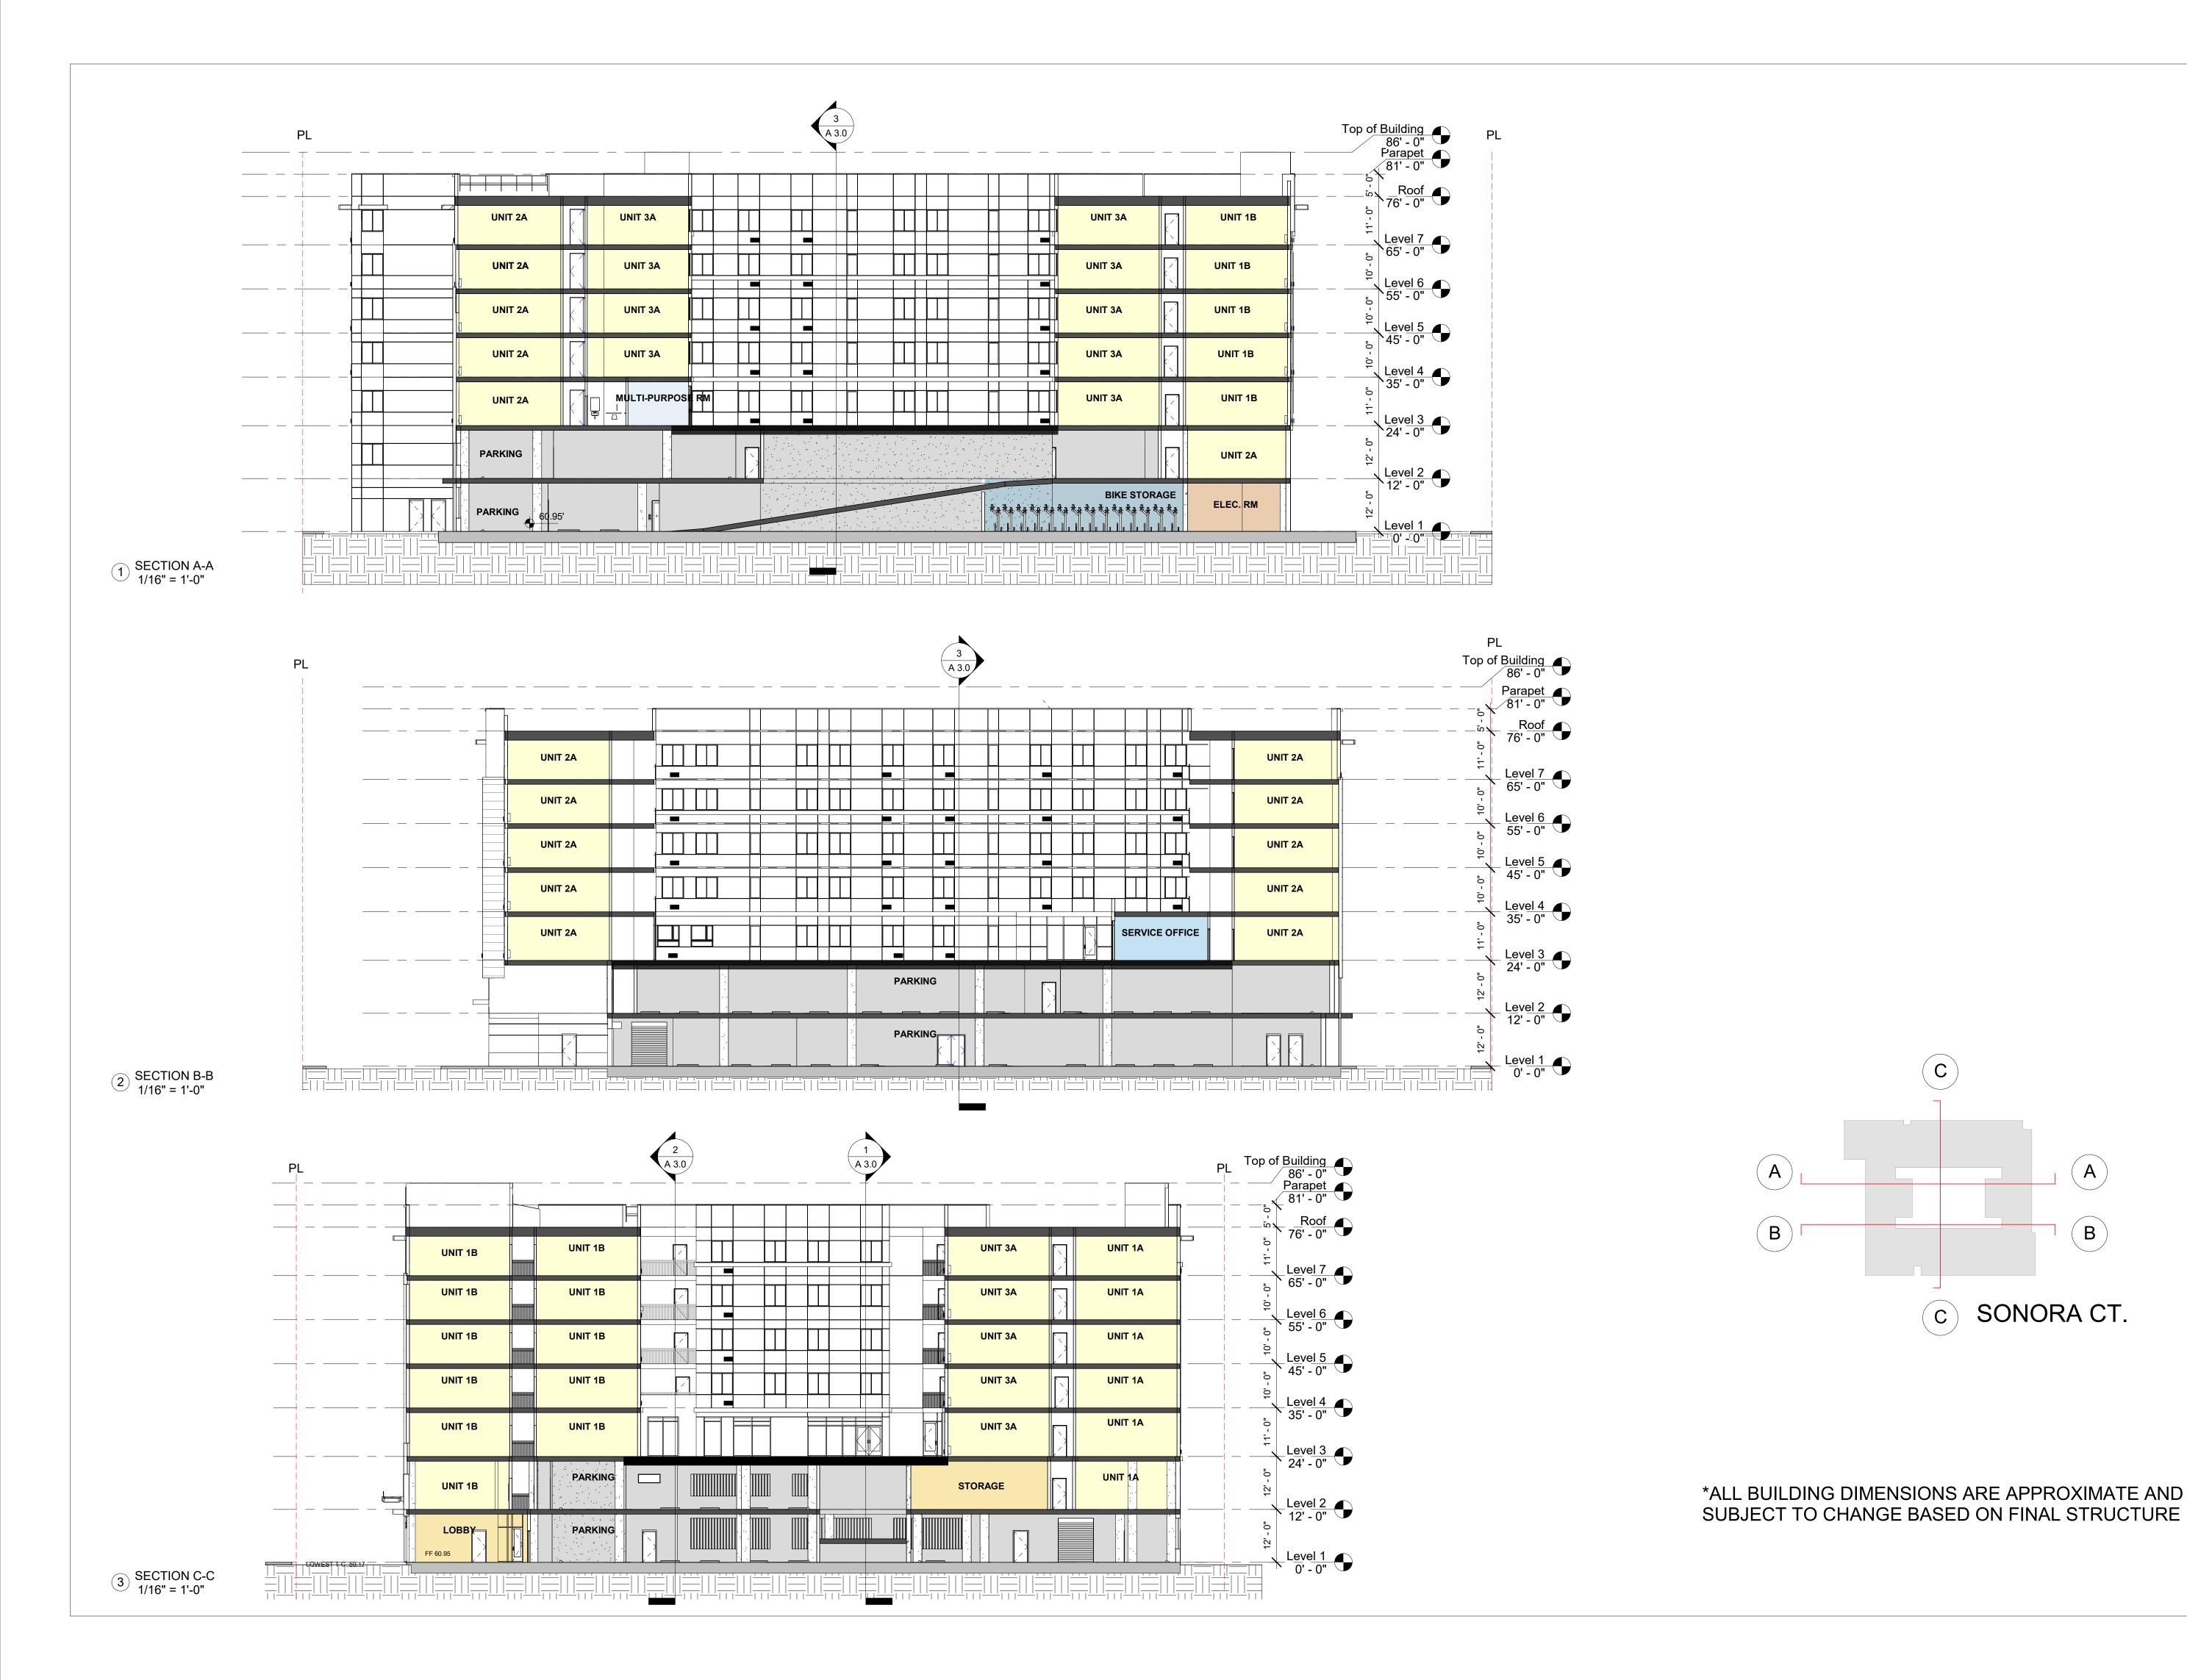



: Architecture

Planning Urban Design

1970 Broadway, Suite 408 Oakland, California 94612 (510) 451 - 2850

THIS DOCUMENT CONTAINS INFORMATION PROPRIETARY TO STUDIO T-SQ, INC. AND IS FURNISHED IN CONFIDENCE FOR THE LIMITED PURPOSE OF EVALUATION OR REVIEW. THIS DOCUMENT OR ITS CONTENTS MAY NOT BE USED FOR ANY OTHER PURPOSE AND MAY NOT BE USED FOR ANY OTHER
PURPOSE AND MAY NOT BE REPRODUCED OR
DISCLOSED TO OTHERS WITHOUT THE PRIOR WRITTEN
CONSENT OF STUDIO T-SQ., INC. ALL RIGHTS
RESERVED, COPYRIGHT 2021.



COURT SONORA SONORA 1171

Sheet Title:

 \bigcirc

(A)

 (B)

c SONORA CT.

(A)

 (B)

BUILDING SECTIONS

Job No. Scale: Drawn By:


21009 07/10/2025 As indicated

Sheet No:

A 3.0



VIEW FROM SOUTHWEST

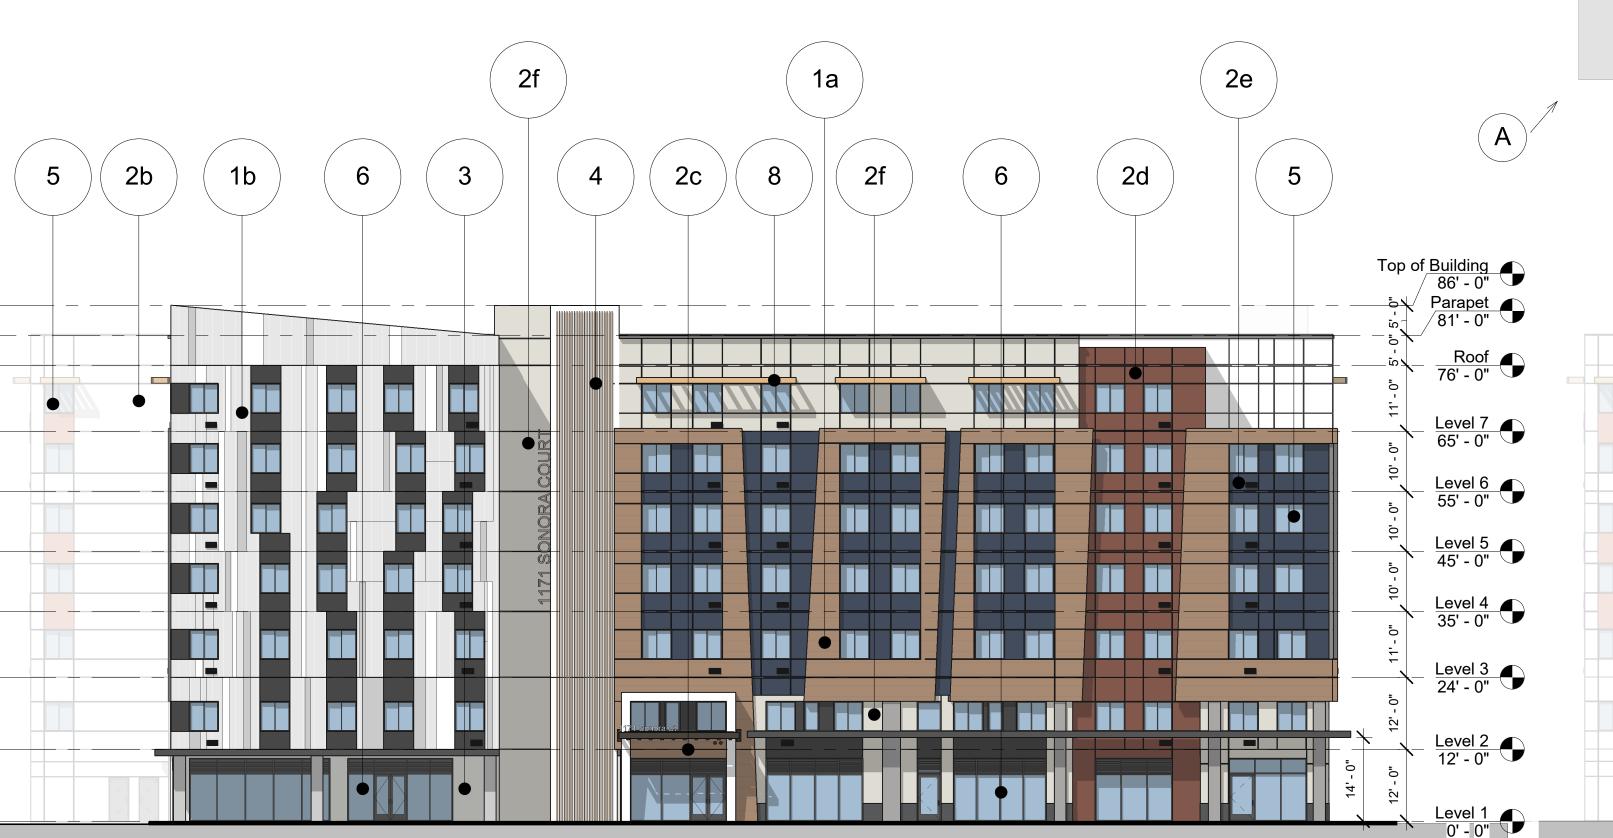

MATERIAL LEGEND

- CEMENT BOARD SIDING_TYPE 1
- CEMENT BOARD SIDING_ TYPE 2
- STUCCO BROWN
- STUCCO WHITE
- STUCCO DARK GRAY
- STUCCO RUST
- STUCCO DARK BLUE
- STUCCO BEIGE
- **BRISE SOLEIL**
- VINYL WINDOW
- **GLAZING SYSTEM**
- VERTICAL GRILLE
- BALCONY RAILING
- 10 AC GRILL

STUDIO

Architecture

T SQUARE

- Planning Urban Design
- 1970 Broadway, Suite 408 Oakland, California 94612 (510) 451 - 2850

THIS DOCUMENT CONTAINS INFORMATION PROPRIETARY TO STUDIO T-SQ, INC. AND IS FURNISHED IN CONFIDENCE FOR THE LIMITED PURPOSE OF EVALUATION OR REVIEW. THIS DOCUMENT OR ITS CONTENTS MAY NOT BE USED FOR ANY OTHER PURPOSE AND MAY NOT BE REPRODUCED OR DISCLOSED TO OTHERS WITHOUT THE PRIOR WRITTEN CONSENT OF STUDIO T-SQ., INC. ALL RIGHTS RESERVED, COPYRIGHT 2021.



SONORA

Sheet Title:

1171

SOUTH ELEVATION

Scale: Drawn By:

21009 07/10/2025 As indicated

Sheet No:

A 4.1

SONORA CT.

B

*ALL BUILDING DIMENSIONS ARE APPROXIMATE AND SUBJECT TO CHANGE BASED ON FINAL STRUCTURE





VIEW FROM SOUTHEAST




MATERIAL LEGEND

- CEMENT BOARD SIDING_TYPE 1
- CEMENT BOARD SIDING_ TYPE 2
- STUCCO BROWN
- STUCCO WHITE
- STUCCO DARK GRAY
- STUCCO RUST
- STUCCO DARK BLUE
- STUCCO BEIGE
- 3
- **BRISE SOLEIL**
- VINYL WINDOW
- **GLAZING SYSTEM**
- VERTICAL GRILLE
- CANOPY
- BALCONY RAILING
- 10 AC GRILL

SONORA CT.

*ALL BUILDING DIMENSIONS ARE APPROXIMATE AND SUBJECT TO CHANGE BASED ON FINAL

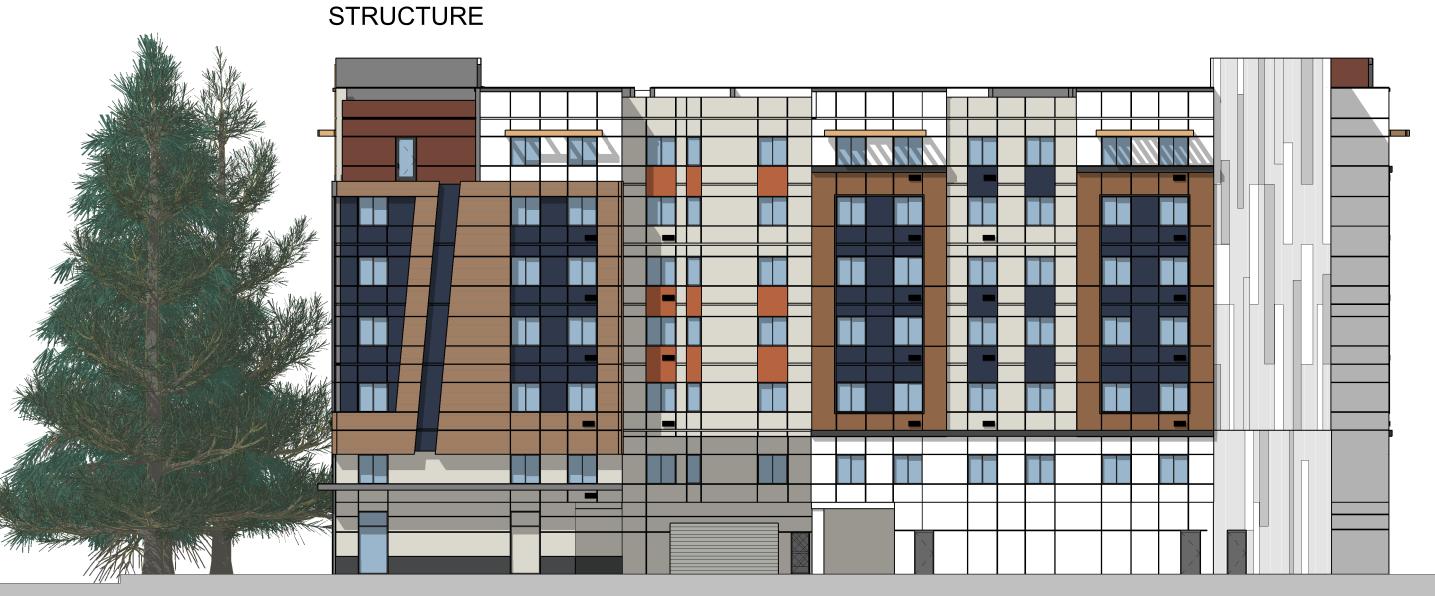



- Architecture
- Planning
- Urban Design
- 1970 Broadway, Suite 408 Oakland, California 94612 (510) 451 - 2850

THIS DOCUMENT CONTAINS INFORMATION PROPRIETARY TO STUDIO T-SQ, INC. AND IS FURNISHED IN CONFIDENCE FOR THE LIMITED PURPOSE OF EVALUATION OR REVIEW. THIS DOCUMENT OR ITS CONTENTS MAY NOT BE USED FOR ANY OTHER PURPOSE AND MAY NOT BE REPRODUCED OR DISCLOSED TO OTHERS WITHOUT THE PRIOR WRITTEN CONSENT OF STUDIO T-SQ., INC. ALL RIGHTS RESERVED, COPYRIGHT 2021.



Sheet Title:

1171

SONORA

EAST ELEVATION

21009 Scale:

07/10/2025 As indicated Drawn By:

Sheet No:

A 4.2

STUDIO

T SQUARE

Architecture

Urban Design


1970 Broadway, Suite 408 Oakland, California 94612

Planning

(510) 451 - 2850



VIEW FROM NORTHEAST

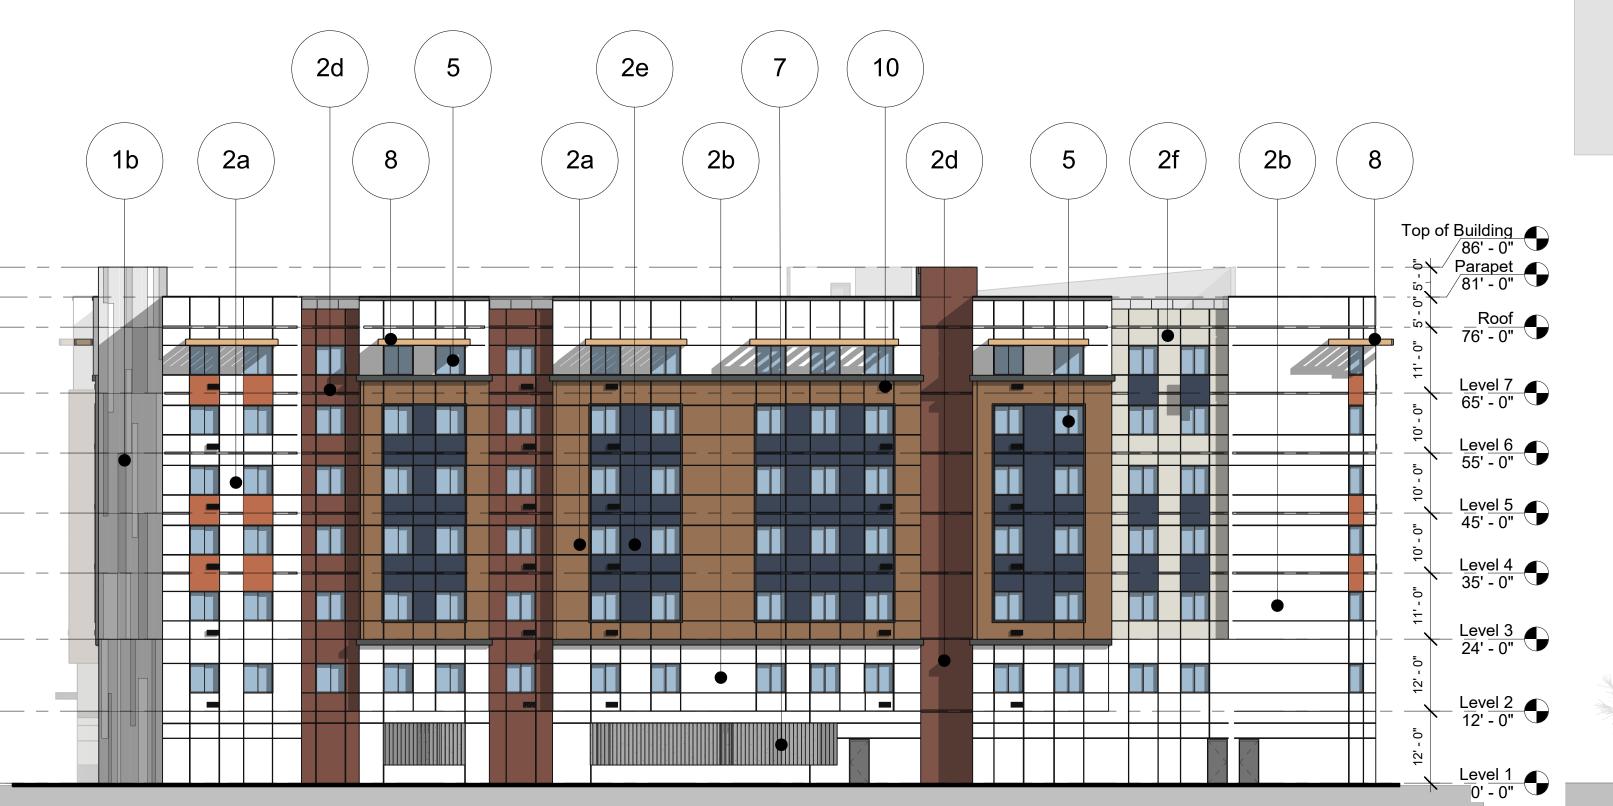

MATERIAL LEGEND

- CEMENT BOARD SIDING_TYPE 1
- CEMENT BOARD SIDING_ TYPE 2
- STUCCO BROWN
- STUCCO WHITE
- STUCCO DARK GRAY
- STUCCO RUST
- STUCCO DARK BLUE
- STUCCO BEIGE
- (3)
- **BRISE SOLEIL**
- VINYL WINDOW
- **GLAZING SYSTEM**
- VERTICAL GRILLE
- CANOPY
- BALCONY RAILING
- (10) AC GRILL

THIS DOCUMENT CONTAINS INFORMATION PROPRIETARY TO STUDIO T-SQ, INC. AND IS FURNISHED IN CONFIDENCE FOR THE LIMITED PURPOSE OF EVALUATION OR REVIEW. THIS DOCUMENT OR ITS CONTENTS MAY NOT BE USED FOR ANY OTHER PURPOSE AND MAY NOT BE REPRODUCED OR DISCLOSED TO OTHERS WITHOUT THE PRIOR WRITTEN CONSENT OF STUDIO T-SQ., INC. ALL RIGHTS RESERVED, COPYRIGHT 2021.

SONORA 1171

Sheet Title:

NORTH ELEVATION

Scale: Drawn By:

21009 07/10/2025 As indicated

Sheet No:

A 4.3



SONORA CT.


 $(\, {f B} \,)$

*ALL BUILDING DIMENSIONS ARE APPROXIMATE AND SUBJECT TO CHANGE BASED ON FINAL STRUCTURE






VIEW FROM NORTHWEST

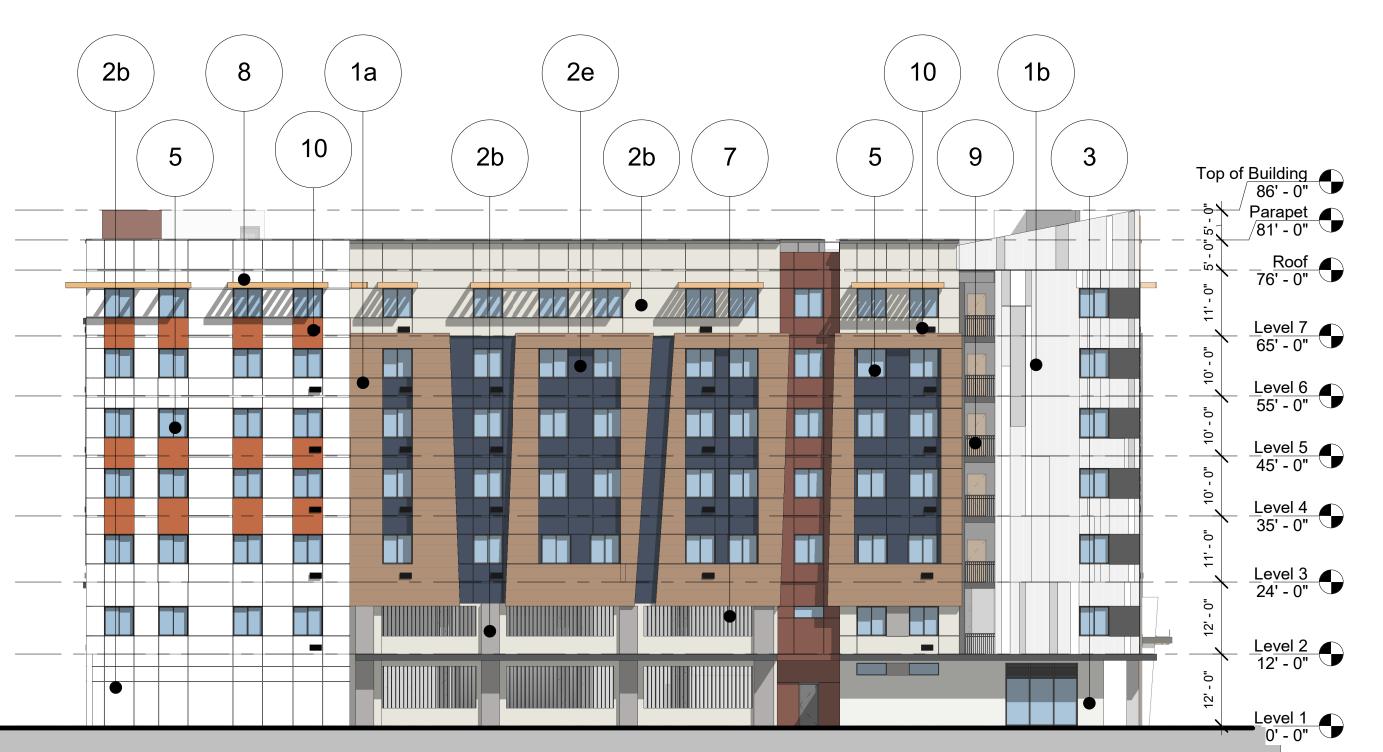

A \bigcirc B \rightarrow

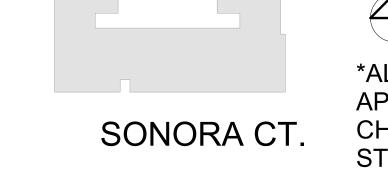



MATERIAL LEGEND

- CEMENT BOARD SIDING_TYPE 1
- CEMENT BOARD SIDING_ TYPE 2
- STUCCO BROWN
- STUCCO WHITE
- STUCCO DARK GRAY
- STUCCO RUST
- STUCCO DARK BLUE
- STUCCO BEIGE
- 3
- **BRISE SOLEIL**
- VINYL WINDOW
- **GLAZING SYSTEM**
- VERTICAL GRILLE
- CANOPY
- BALCONY RAILING
- 10 AC GRILL



- Architecture
- Planning
- Urban Design
- 1970 Broadway, Suite 408 Oakland, California 94612 (510) 451 - 2850

THIS DOCUMENT CONTAINS INFORMATION PROPRIETARY TO STUDIO T-SQ, INC. AND IS FURNISHED IN CONFIDENCE FOR THE LIMITED PURPOSE OF EVALUATION OR REVIEW. THIS DOCUMENT OR ITS CONTENTS MAY NOT BE USED FOR ANY OTHER PURPOSE AND MAY NOT BE REPRODUCED OR DISCLOSED TO OTHERS WITHOUT THE PRIOR WRITTEN CONSENT OF STUDIO T-SQ., INC. ALL RIGHTS RESERVED, COPYRIGHT 2021.



SONORA

1171

Sheet Title:


WEST ELEVATION


21009 Scale: Drawn By:

07/10/2025 As indicated

Sheet No:


A 4.4

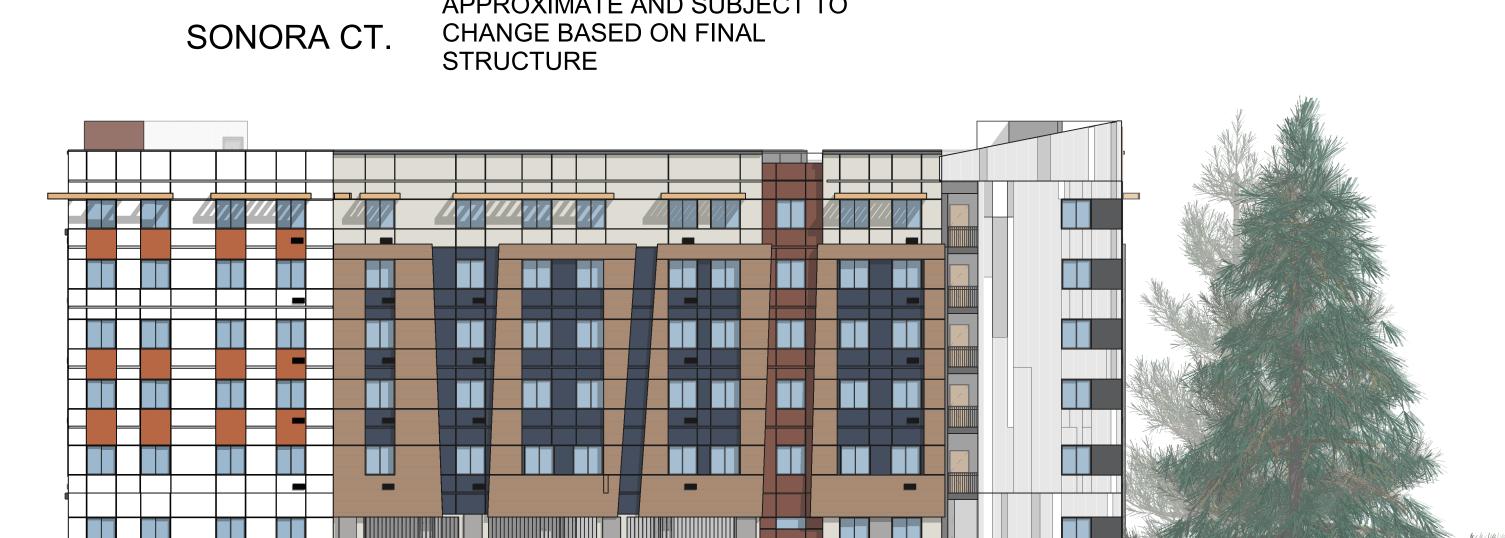

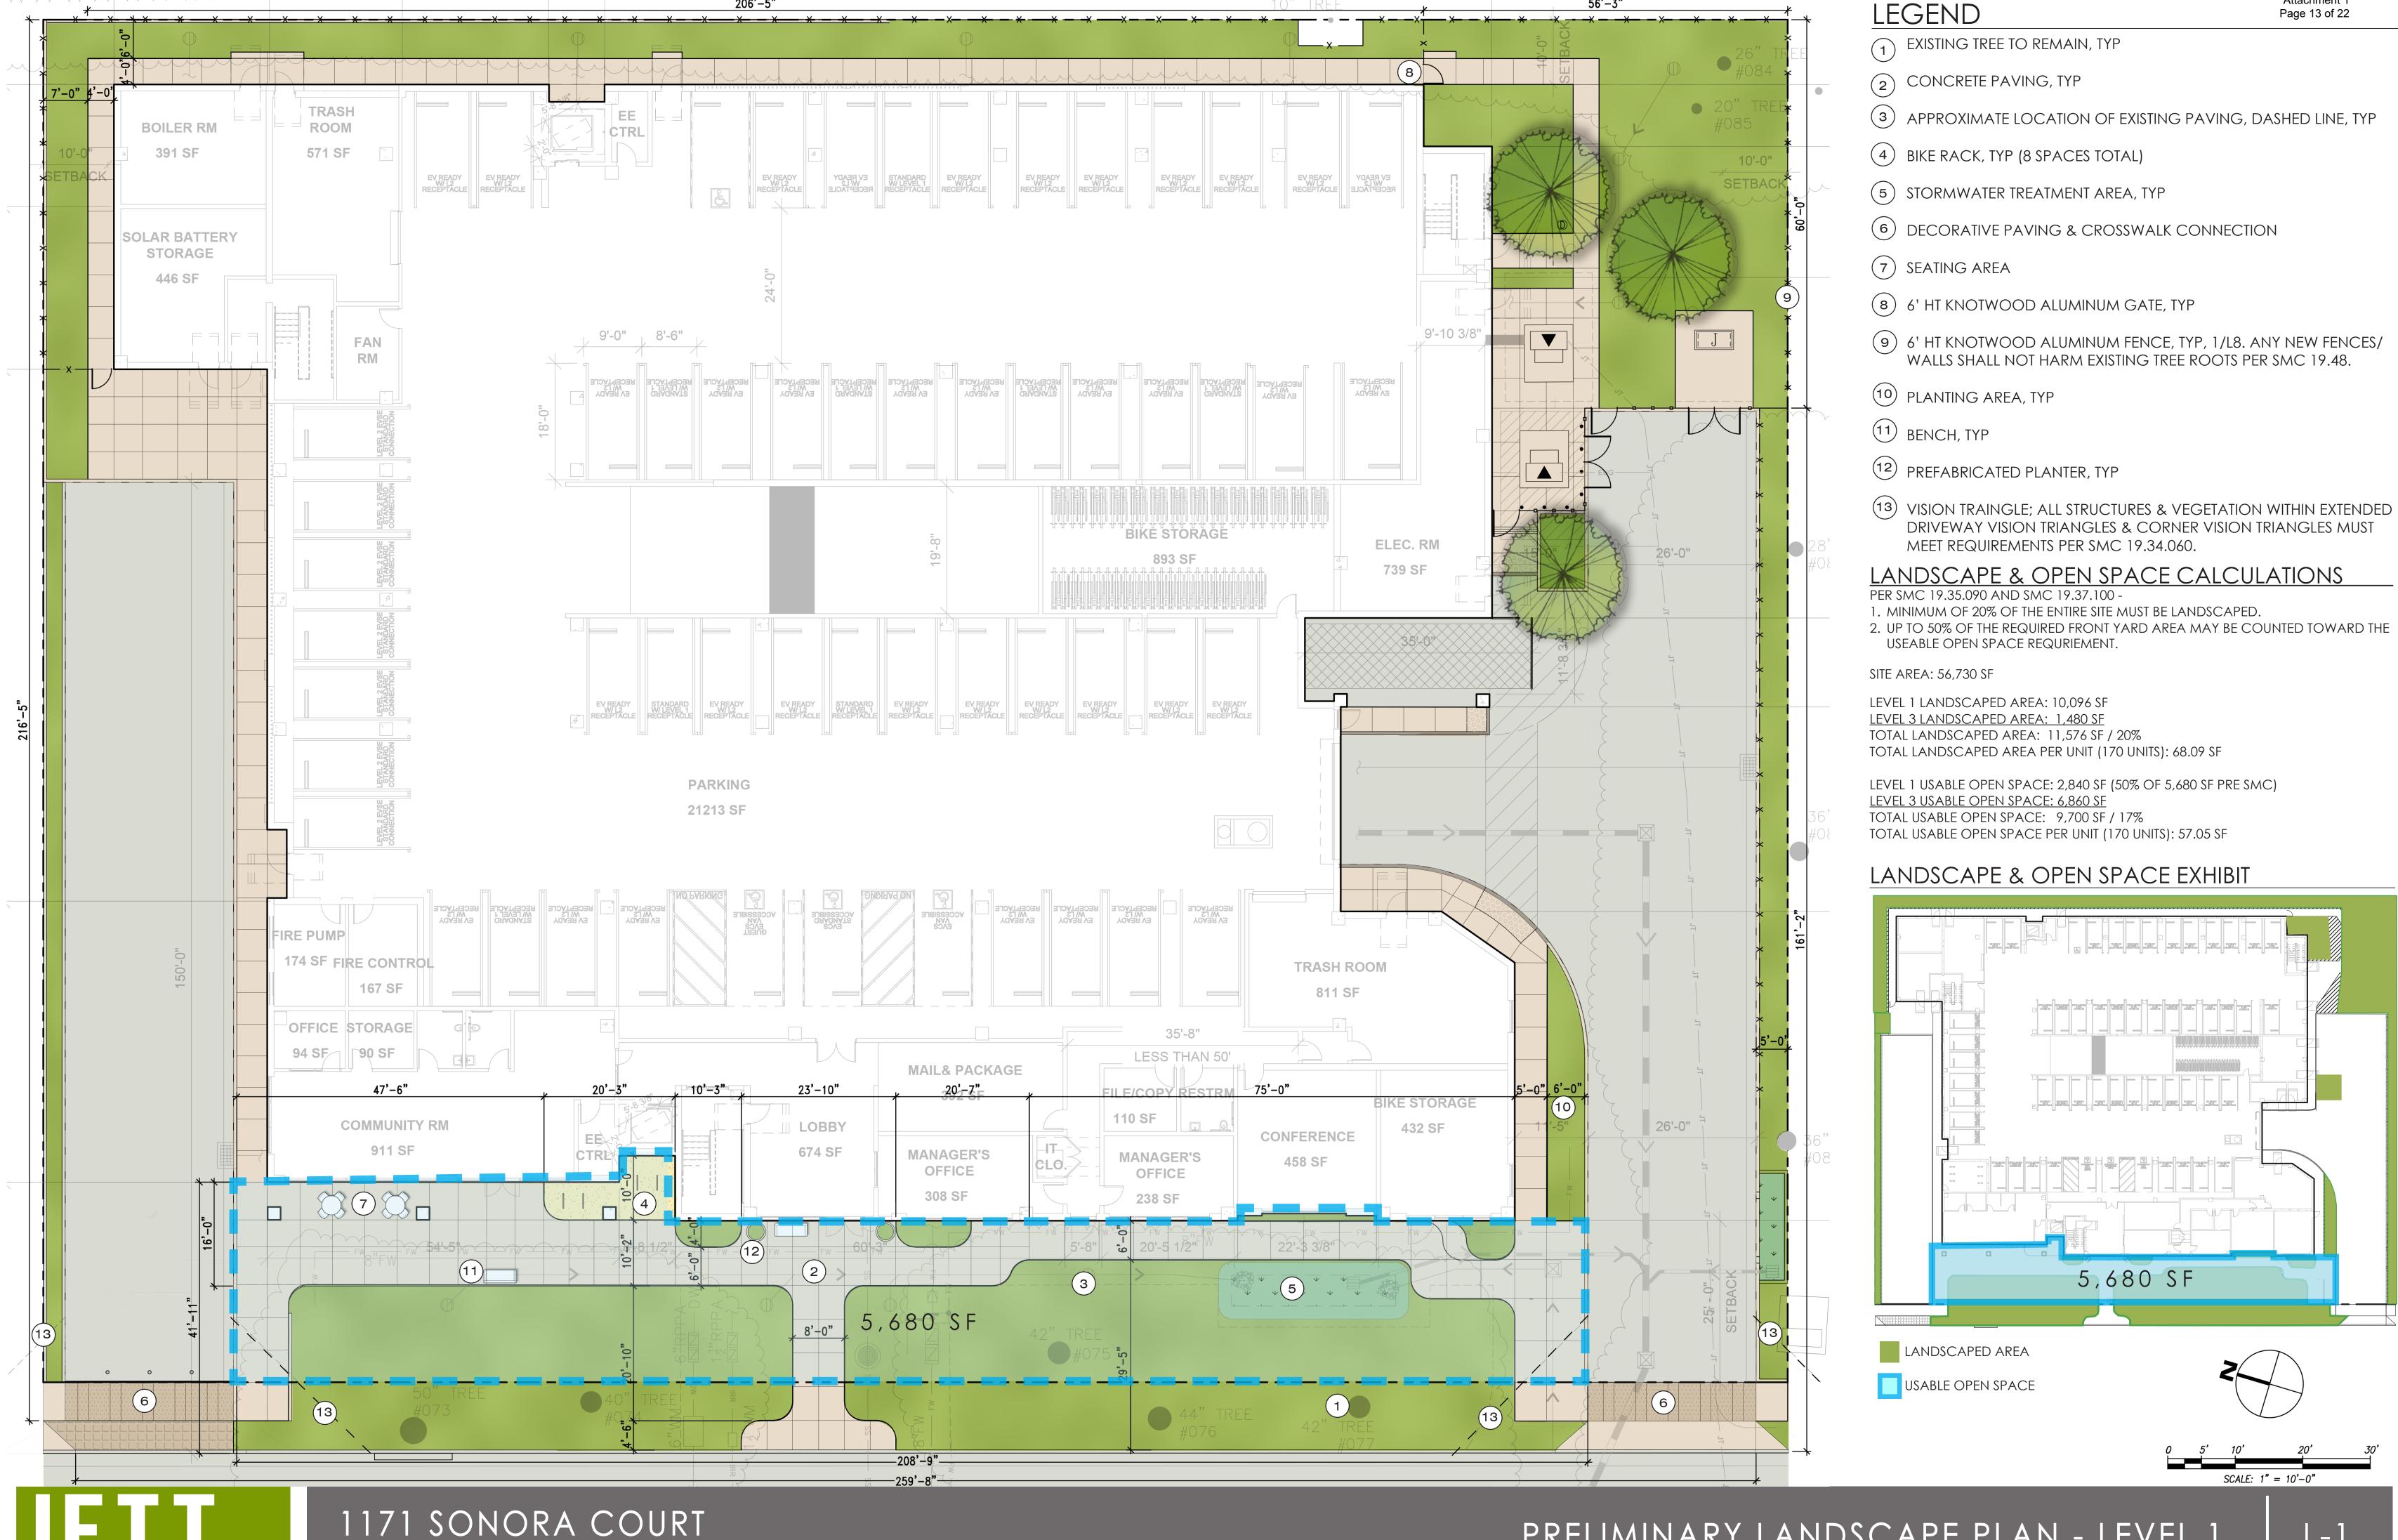

LANDSCAPE ARCHITECTURE + DESIGN

Attachment 1

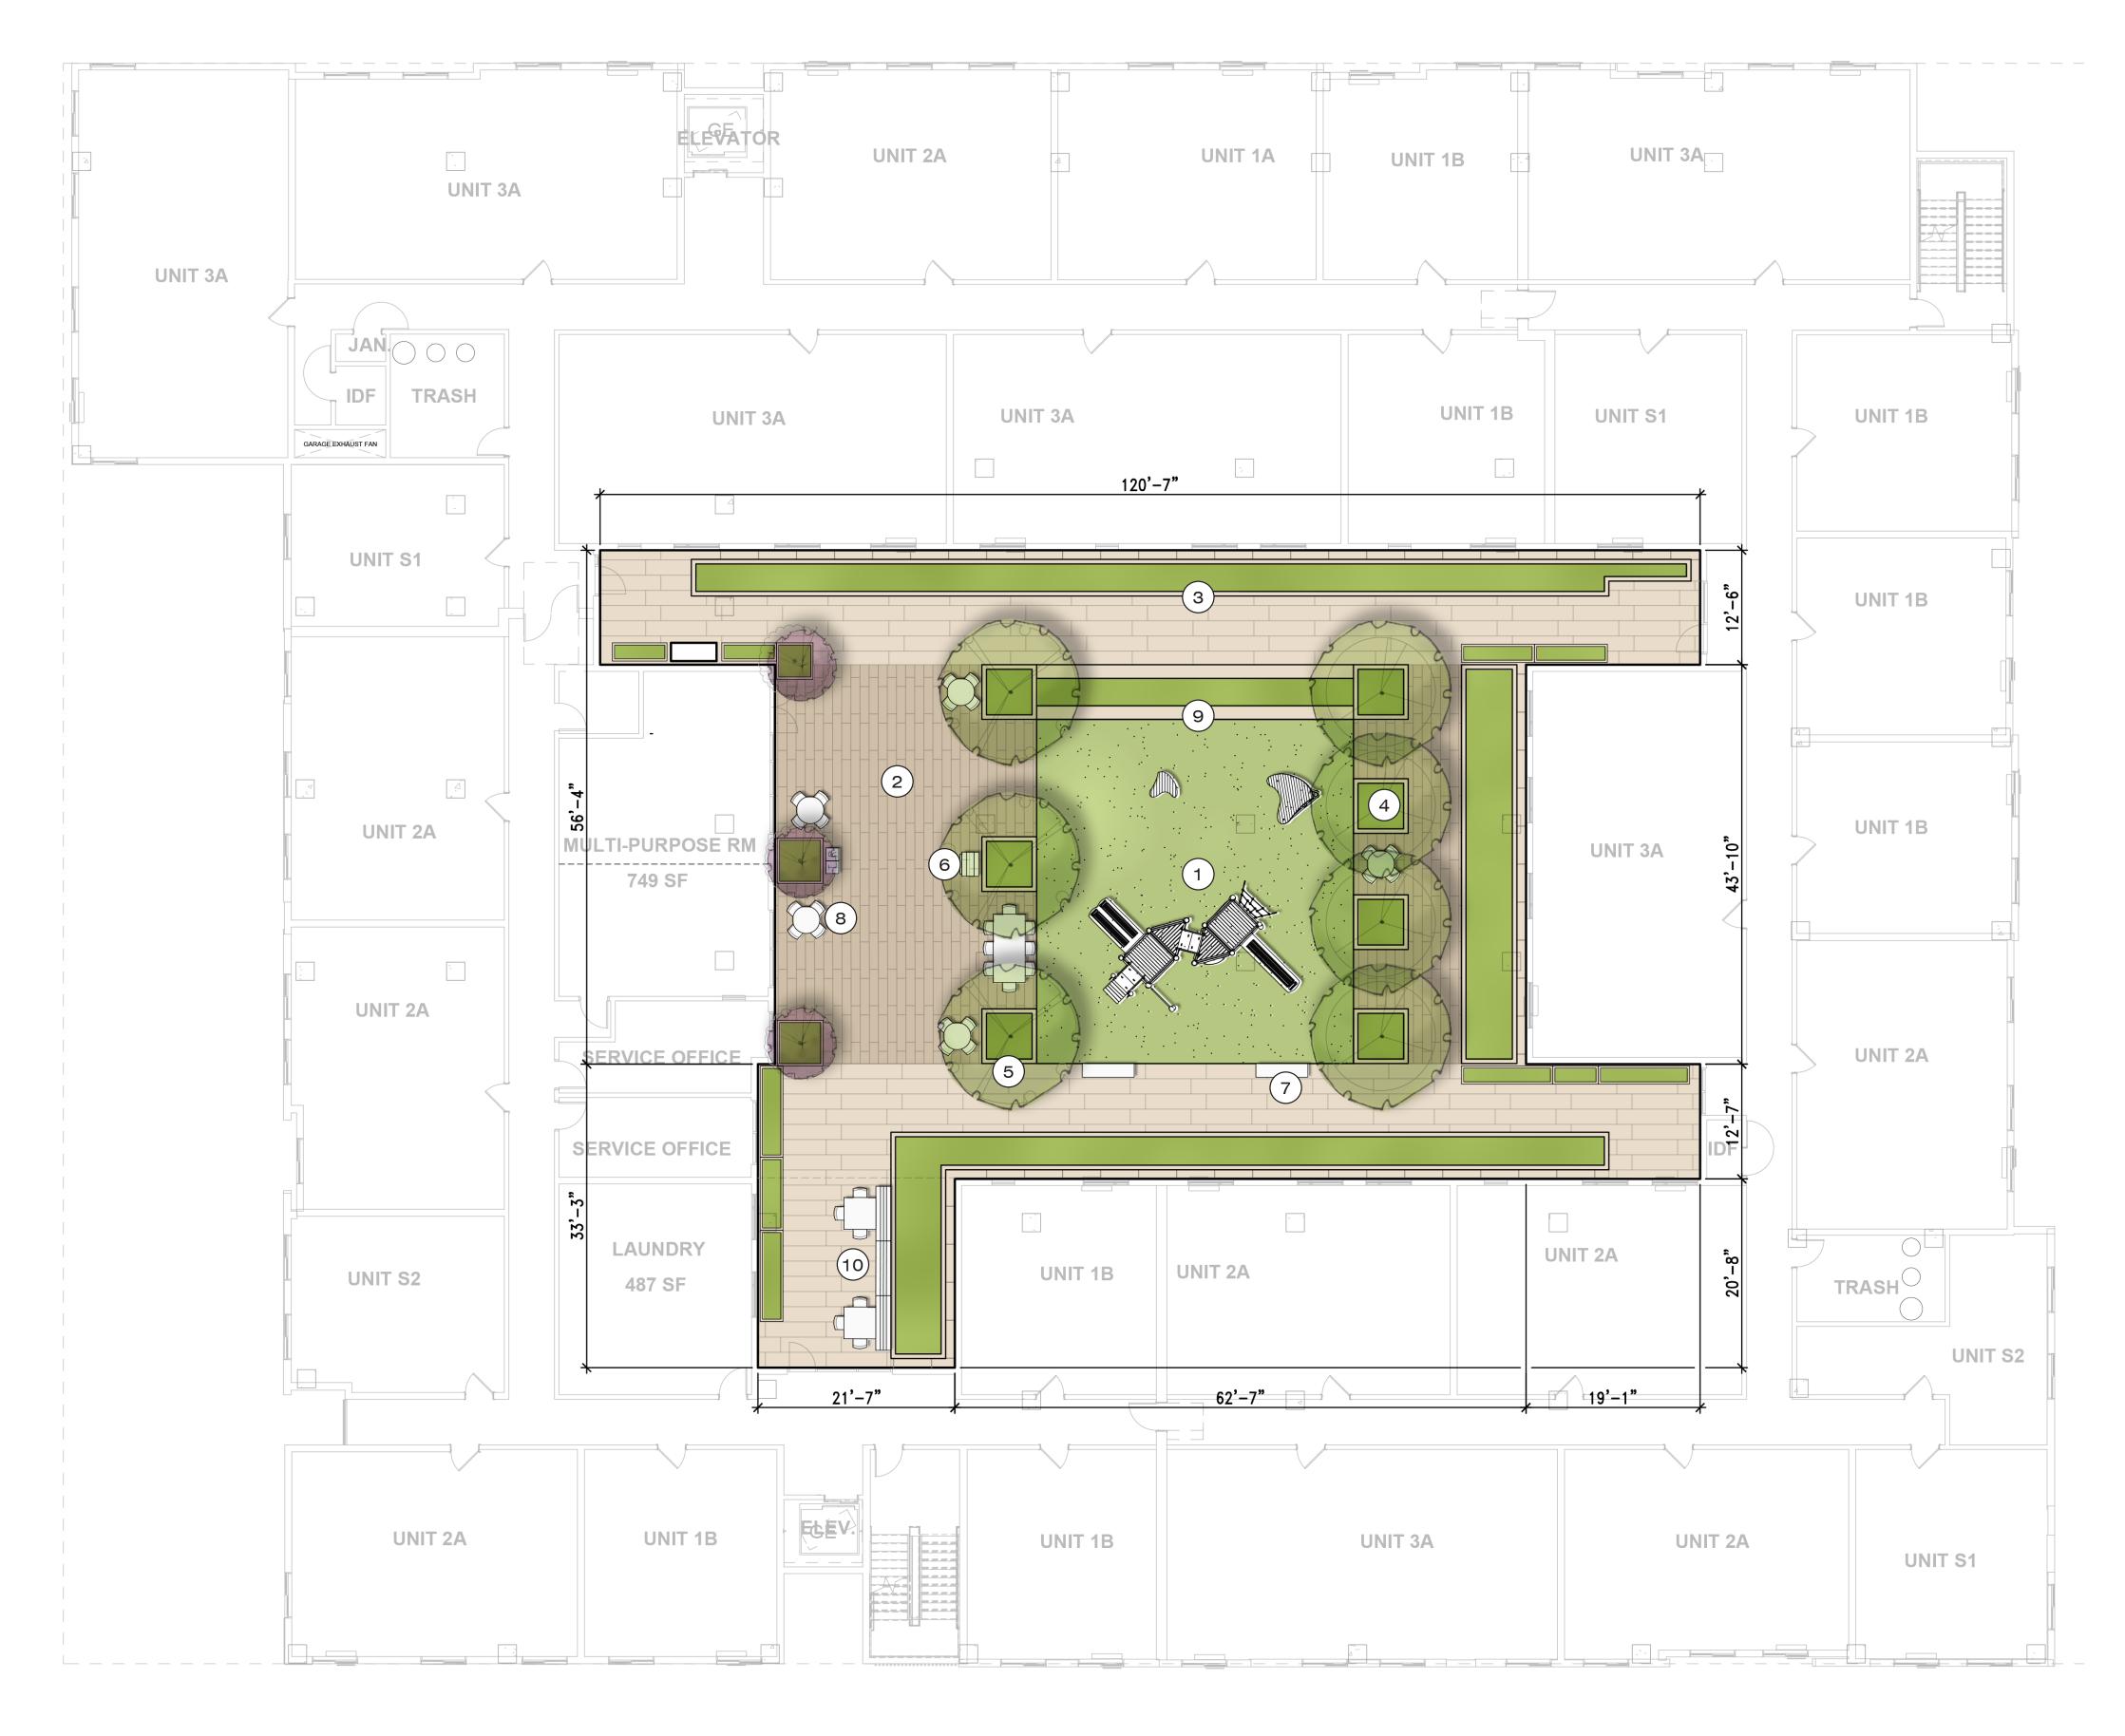



Attachment 1 Page 14 of 22

- 1 PLAY AREA WITH PLAY EQUIPMENT STRUCTURES FOR AGES 2-5 & 5-12 AND PLAY SURFACING. SEE NOTE 1.
- 2 PAVERS ON AGGREGATE, TYP
- 3 24" HEIGHT CMU PLANTER, TYP
- 4) TREE IN RAISED PLANTER, TYP
- 5 PREFAB PLANTER, TYP
- (6) ELECTRIC BBQ
- 7 BENCH, TYP
- 8 TABLE & CHAIRS, TYP
- (9) SEATWALL & SLOPED PLANTER
- 10) BREEZEWAY SEATING AREA

NOTES

CONCEPTUAL PLAY EQUIPMENT STRUCTURES AND LAYOUT ARE SHOWN;
 STRUCTURAL CALCULATIONS SHALL BE PROVIDED WITH PERMIT DRAWINGS.

LANDSCAPE & OPEN SPACE CALCULATIONS

PER SMC 19.35.090 AND SMC 19.37.100 -

1. MINIMUM OF 20% OF THE ENTIRE SITE MUST BE LANDSCAPED.

2. UP TO 50% OF THE REQUIRED FRONT YARD AREA MAY BE COUNTED TOWARD THE USEABLE OPEN SPACE REQURIEMENT.

SITE AREA: 56,730 SF

LEVEL 1 LANDSCAPED AREA: 10,096 SF

LEVEL 3 LANDSCAPED AREA: 1,480 SF

TOTAL LANDSCAPED AREA: 11,576 SF / 20%

TOTAL LANDSCAPED AREA PER UNIT (170 UNITS): 68.09 SF


LEVEL 1 USABLE OPEN SPACE: 2,840 SF (50% OF 5,680 SF PRE SMC)

LEVEL 3 USABLE OPEN SPACE: 6,860 SF

TOTAL USABLE OPEN SPACE: 9,700 SF / 17%


TOTAL USABLE OPEN SPACE PER UNIT (170 UNITS): 57.05 SF


LANDSCAPE & OPEN SPACE EXHIBIT

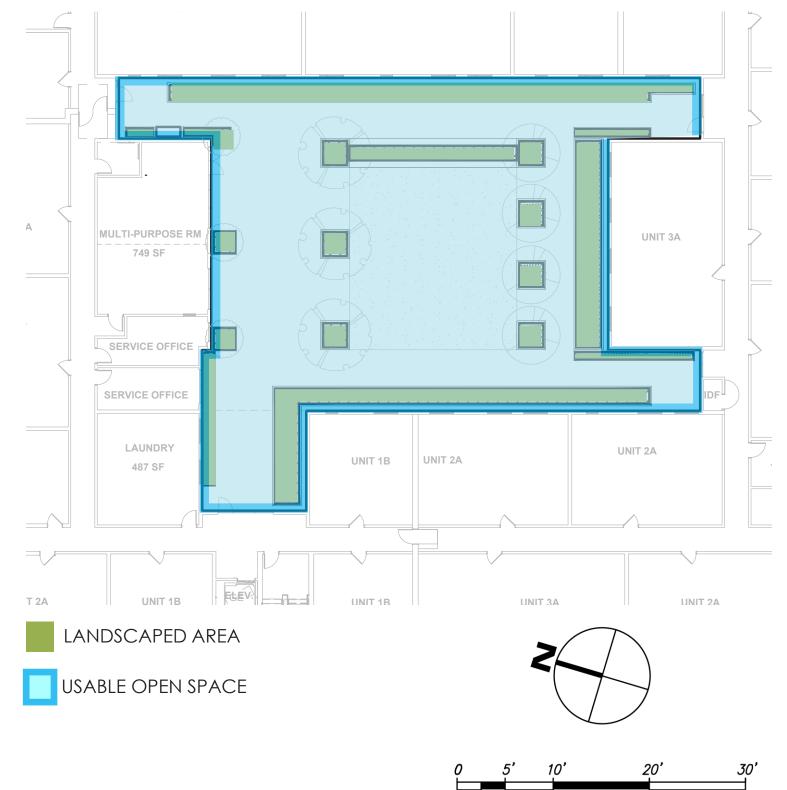



SCALE: 1" = 10'-0"

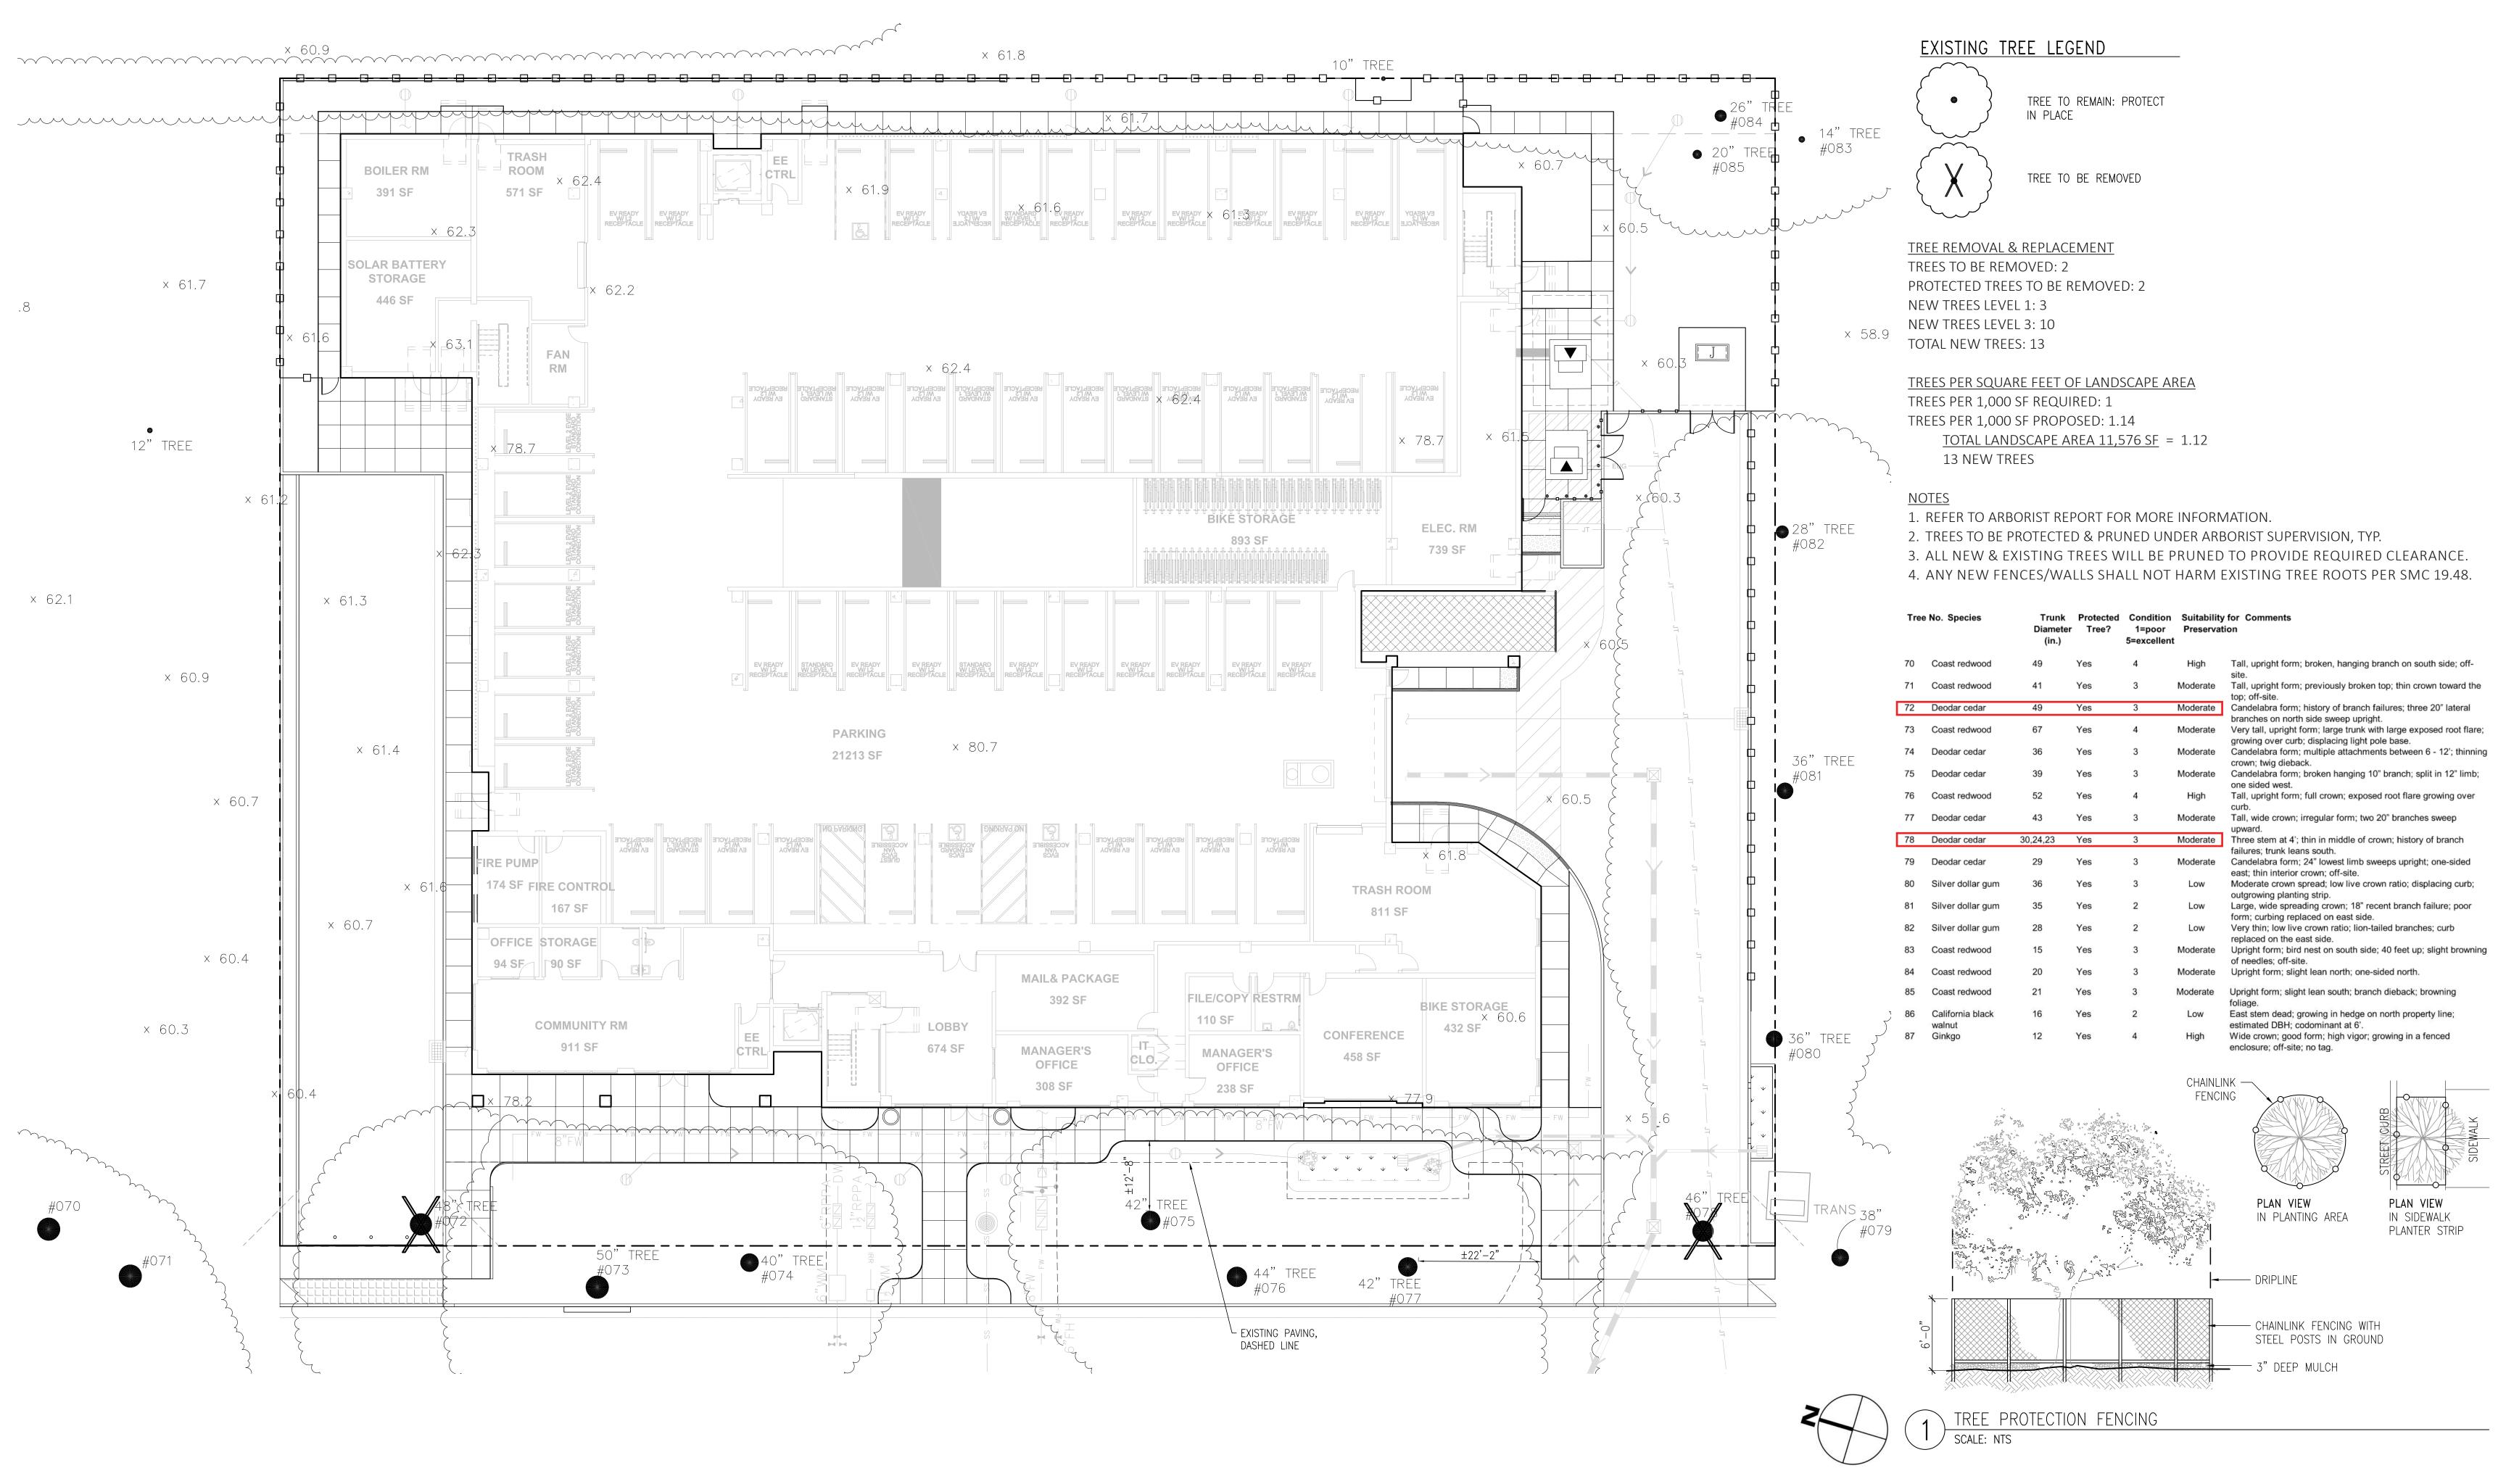

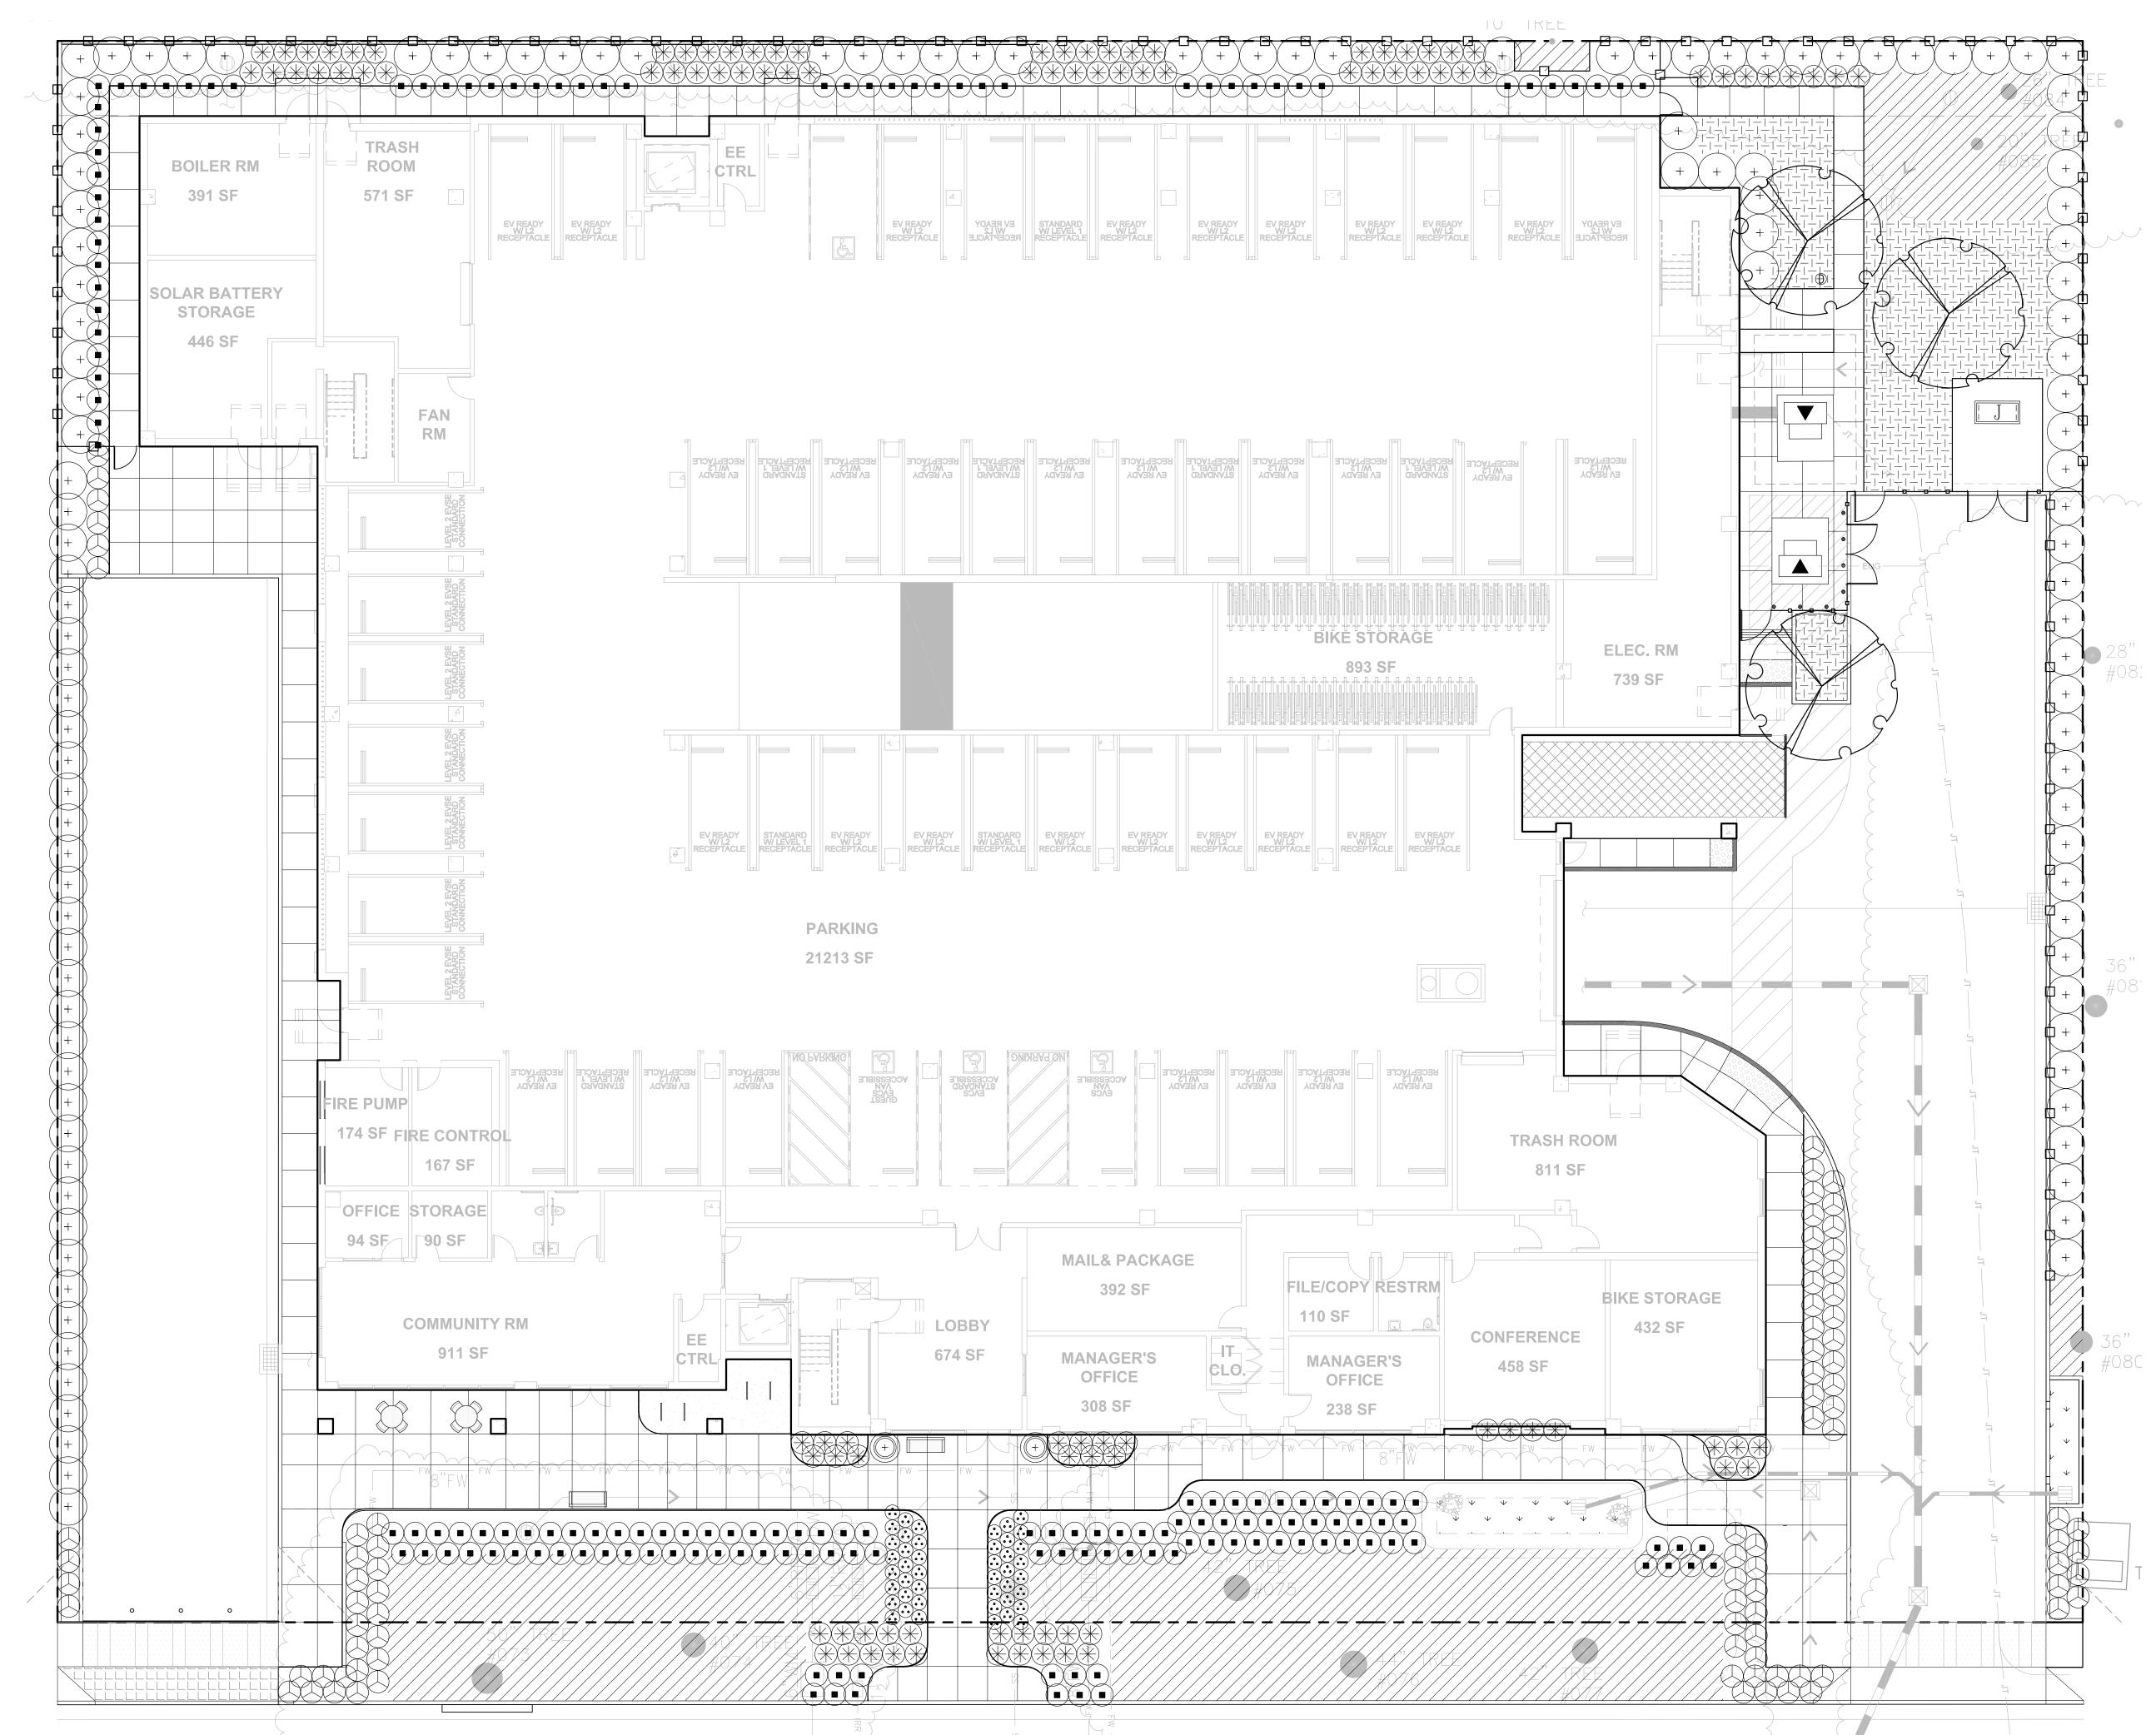


PRFII	MINARY PLANT LIST						
SYMBOL	BOTANICAL NAME	COMMON NAME	SIZE	SPACING	HTxW	QTY	WUCOLS
REES	232						1
	ACER PALMATUM	JAPANESE MAPLE	24" BOY	PER PLAN	20'v15'		М
	ARBUTUS 'MARINA'	STRAWBERRY TREE		PER PLAN			<u> </u>
	CERCIS OCCIDENTALIS	WESTERN REDBUD		PER PLAN			
	LAGERSTROEMIA 'MUSKOGEE'	CRAPE MYRTLE		PER PLAN			
	QUERCUS AGRIFOLIA	COAST LIVE OAK		PER PLAN			VL
	QUERCUS LOBATA	VALLEY OAK		PER PLAN			L
-	PLATANUS ACERIFOLIA 'COLUMBIA'	LONDON PLANE TREE		PER PLAN			M
	SHRUBS	LONDON 1 DANE TILL	Z4 DUX	I LIX I LAIN	40 X30		IVI
ANGE S		MANIZANUTA	15 CAL	c' o" oo	4' 6'		
	ARCTOSTAPHYLOS SPP.	MANZANITA		6'-0" OC	4'x6'		L
+)	CEANOTHUS 'JOYCE COULTER'	WILD LILAC	5 GAL	4'-0" OC	4'x9'		L
	LEUCADENDRON 'JESTER'	SUNSHINE CONEBUSH	15 GAL	4'-0" OC	4'x4'		L
(EDILLY	RIBES SANGUINEUM V. GLUTINOSUM SHRUBS & GRASSES	FLOWERING CURRANT	5 GAL	4'-0" OC	4'x4'		L
LUIUM	AGAVE PARRYI	CENTURY PLANT	5 GAL	0, 0, 00	0'. 7'		T
				2'-0" OC	2'x3'		
	LOMANDRA LONGIFOLIA 'BREEZE'	DWARF MAT RUSH	5 GAL	3'-0" OC	3'x3'		L
	LIMONIUM PEREZII	SEA LAVENDER	5 GAL	3'-0" OC	3'x3'		L
(\mathbb{R})	MIMULUS AURANTIACUS	MONKEYFLOWER	5 GAL	3'-0" OC	3'x4'		L
_	ROSMARINUS SPP.	ROSEMARY	5 GAL	3'-0" OC	3'x4'		L
	SALVIA SPP.	SAGE	5 GAL	3'-0" OC	3'x3'		L
MALL S	SHRUBS & GRASSES		5 044	-1 -7	_, _,		
	ANIGOZANTHOS SPP.	KANGAROO PAW	5 GAL	6'-0" OC	3'x2'		L
	BULBINE FRUTESCENS 'ORANGE'	ORANGE BULBINE	1 GAL	2'-0" OC	1'x2'		L
	CORREA 'CARMINE BELLS'	AUSTRALIAN FUCHSIA	5 GAL	3'-0" OC	2'x3'		L
	EPILOBIUM CANUM	CALIFORNIA FUCHSIA	1 GAL	2'-0" OC	1'x2'		L
	LIBERTIA PEREGRINANS	ORANGE LIBERTIA	1 GAL	5'-0" OC	2'x2'		L
	PENSTEMON 'MARGARITA BOP'	PENSTEMON	1 GAL	2'-0" OC	1'x2'		L
1-1-	COVERS	T	1				
<u>-</u> - -	ARCTOSTAPHYLOS SPP.	MANZANITA	1 GAL	6'-0" OC	1'x6'		L
T-LT-	COTONEASTER 'CORAL BEAUTY'	COTONEASTER	1 GAL	4'-0" OC	1'x4'		L
I+I+	RIBES VIBURNIFOLIUM	EVERGREEN CURRANT	1 GAL	4'-0" OC	3'x4'		L
1717-	SEDUM SPP.	SEDUM	1 GAL	3'-0" OC	1'x2'		L
<u> </u>	SENECIO MANDRALISCAE	BLUE FINGER	1 GAL	3'-0" OC	2'x3'		L
<u> </u>	SYMPHORICARPOS MOLLIS	CREEPING SNOWBERRY	1 GAL	3'-0" OC	2'x4'		L
IORETE	NTION AREAS						,
Ψ Ψ ·	ACHILLEA MILLEFOLIUM	YARROW	1 GAL	2'-0" OC	2'x2'		L
* *	CHONDROPETALUM TECTORUM	CAPE RUSH	5 GAL	3'-0" OC	3'x3'		L
Ψ Ψ	IRIS DOUGLASIANA	DOUGLAS IRIS	BULB	2'-0" OC	2'x2'		L
ψ · ·	JUNCUS PATENS	CA. GRAY RUSH	1 GAL	2'-0" OC	2'x2'		L
Ψ .	HETEROMELES ARBUTIFOLIA	TOYON	5 GAL	5'-0" OC	6'x6'		L
Ψ Ψ	SISYRINCHIUM BELLUM	BLUE-EYED GRASS	1 GAL	2'-0" OC	1'x2'		L


GENERAL PLANTING NOTES

- ALL PLANTING AREAS SHALL BE TOP-DRESSED WITH A 3" LAYER OF ORGANIC, UN-DYED MULCH RECYCLED FROM LOCAL ORGANIC MATERIALS SUCH AS TREE TRIMMINGS, PLANT, OR CLEAN WOOD WASTE
- 50% OF ALL SHRUBS AND GROUNDCOVER SHALL BE A MINIMUM OF 5-GALLON SIZE OR LARGER
 ALL NEW AND EXISTING TREES WILL BE PRUNED TO PROVIDE REQUIRED CLEARANCE.
- 4. ALL STRUCTURES & VEGETATION WITHIN EXTENDED DRIVEWAY VISION TRIANGLES &
- CORNER VISION TRIANGLES MUST MEET REQUIREMENTS PER SMC 19.34.060.
- 5. MINIMUM SOIL DEPTH FOR GROUND COVER :12 INCHES MINIMUM SOIL DEPTH FOR FOR SHRUBS : 20 INCHES MINIMUM SOIL DEPTH FOR TREES: 36 INCHES
- 6. ALL TREES WITHIN 5'-0" OF PAVING SHALL HAVE 24" DEEP LINEAR ROOT BARRIERS.


SOIL DEPTH

1	PLANTING DEPTH TYPE A: ON GRADE	24"
2	PLANTING DEPTH TYPE B: ON STRUCTURE	32"
3	PLANTING DEPTH TYPE C: TREES ON STRUCTURE	36"

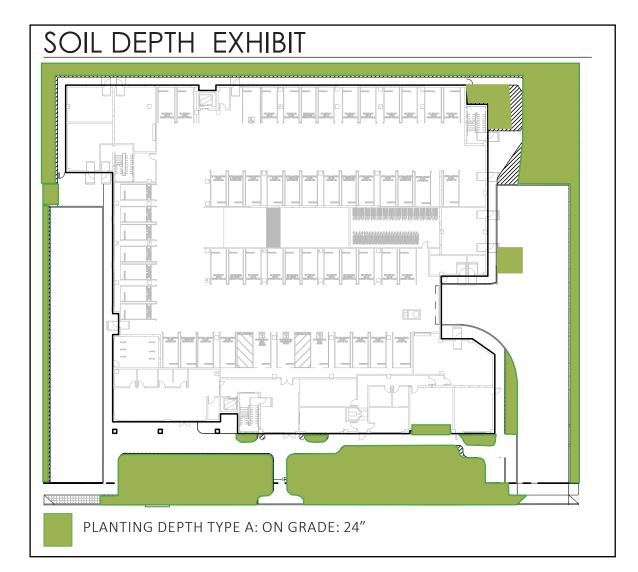

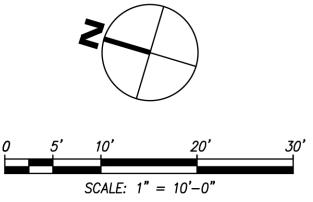



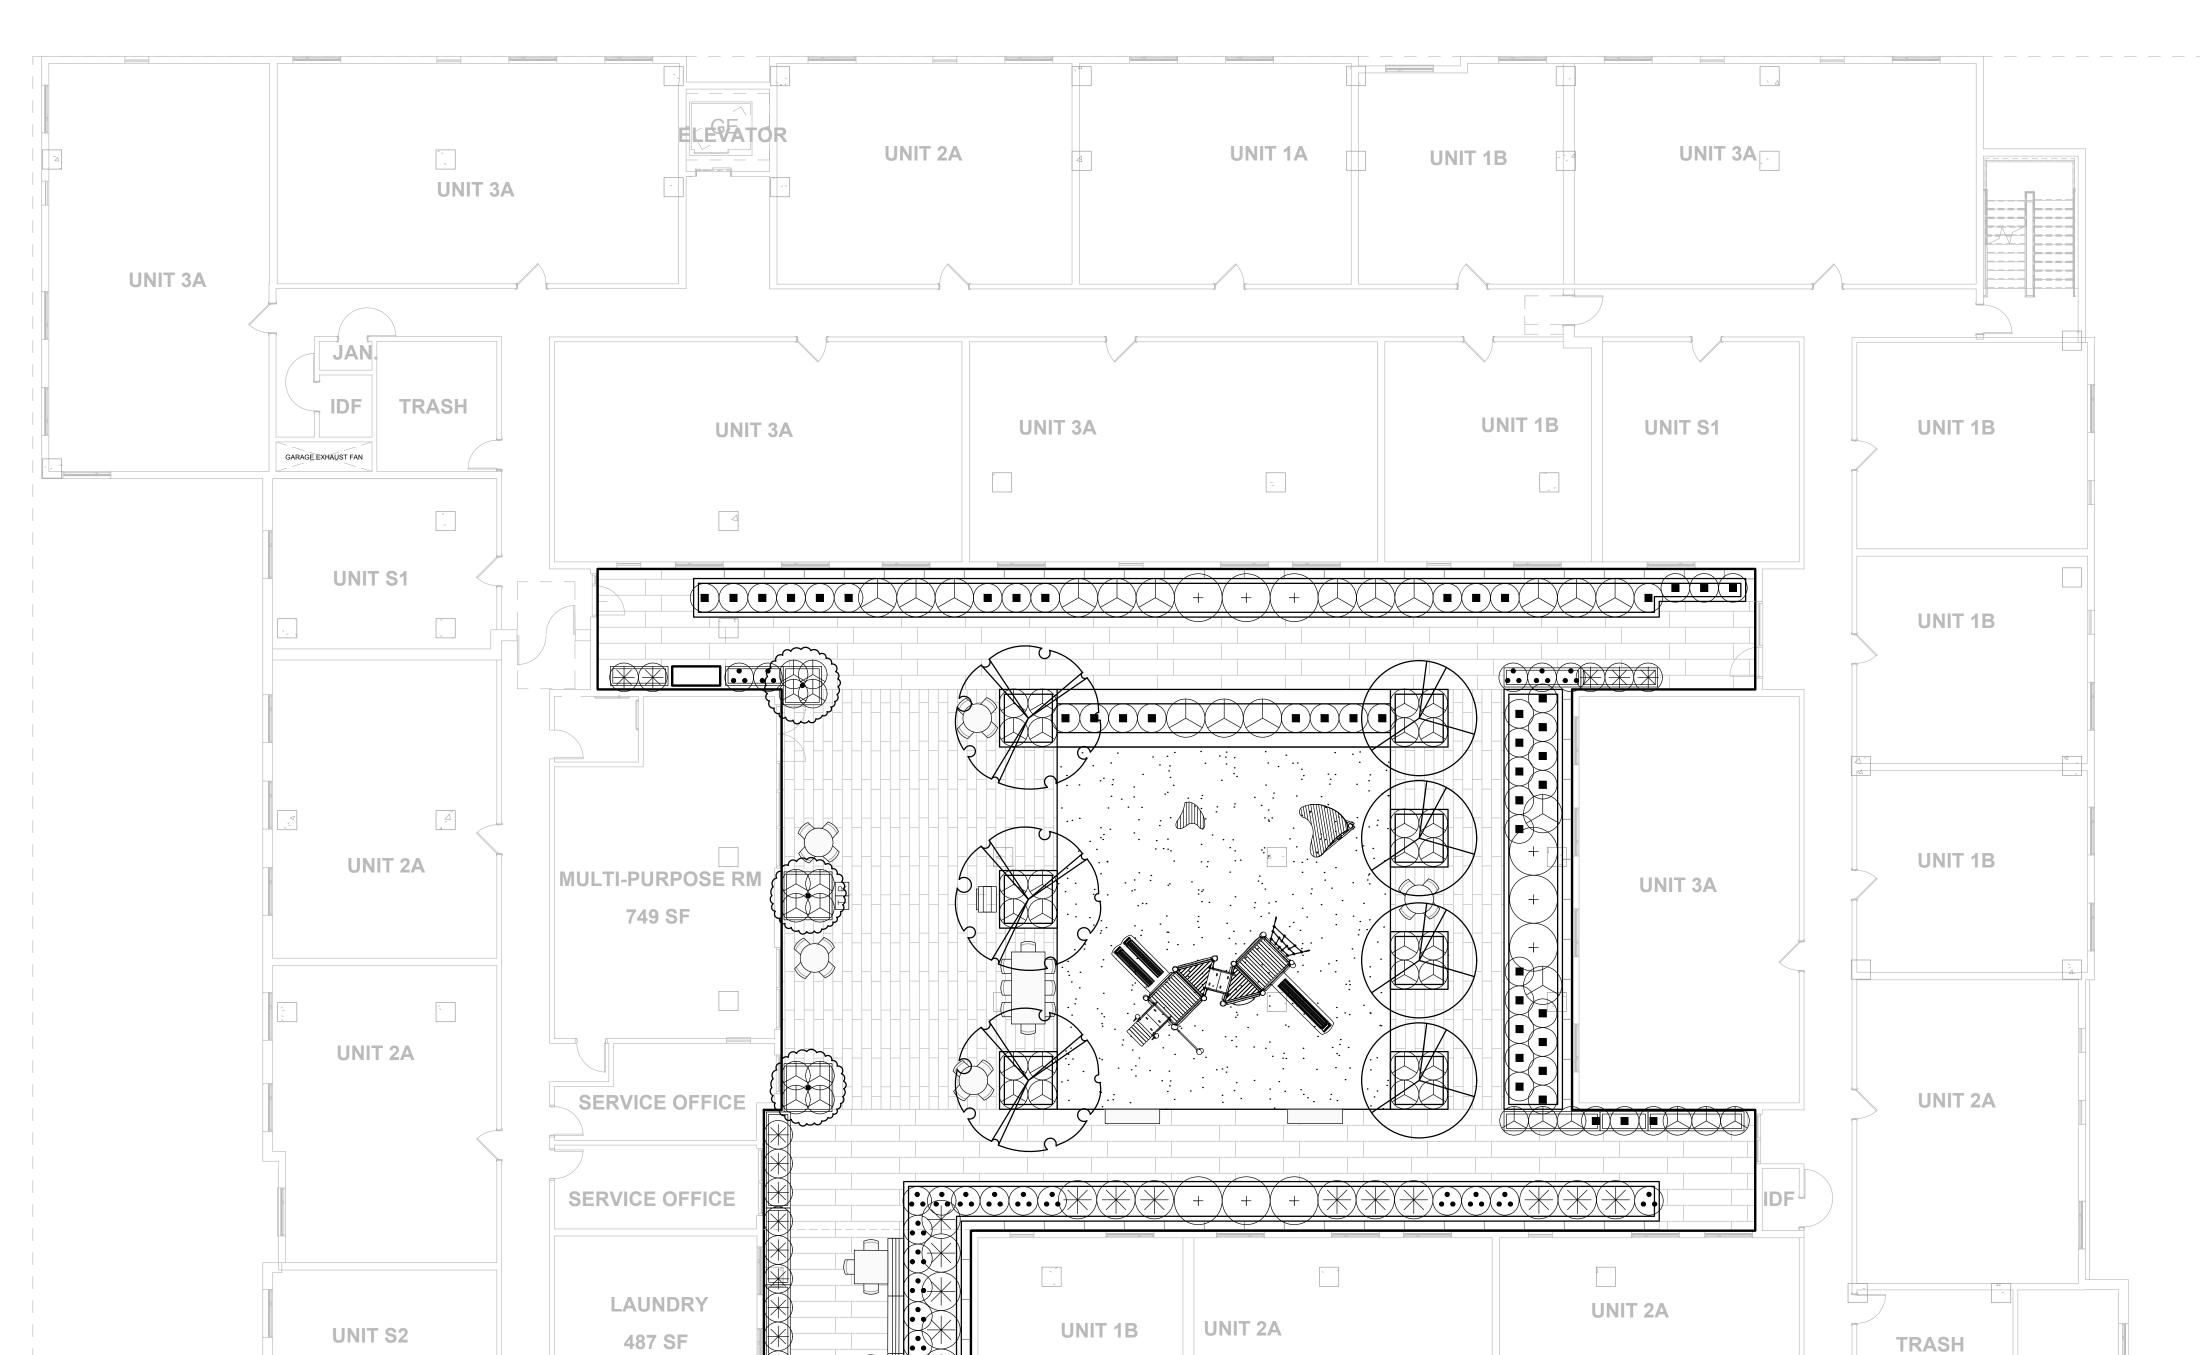

UNIT 1B

UNIT 3A

UNIT 2A

SYMBOL	BOTANICAL NAME	COMMON NAME	SIZE	SPACING	HTxW	QTY	WUCOLS
TREES			I				-
ACE PA	ACER PALMATUM	JAPANESE MAPLE	24" BOX	PER PLAN	20'x15'		М
	ARBUTUS 'MARINA'	STRAWBERRY TREE		PER PLAN			L
	CERCIS OCCIDENTALIS	WESTERN REDBUD		PER PLAN			L
LAG MU	LAGERSTROEMIA 'MUSKOGEE'	CRAPE MYRTLE		PER PLAN			L
	QUERCUS AGRIFOLIA	COAST LIVE OAK		PER PLAN			VL
QUE LO	QUERCUS LOBATA	VALLEY OAK		PER PLAN			L
PLA CO	PLATANUS ACERIFOLIA 'COLUMBIA'	LONDON PLANE TREE		PER PLAN	40'x30'		М
LARGE S	HRUBS						
	ARCTOSTAPHYLOS SPP.	MANZANITA	15 GAL	6'-0" OC	4'x6'		L
+	CEANOTHUS 'JOYCE COULTER'	WILD LILAC	5 GAL	4'-0" OC	4'x9'		L
	LEUCADENDRON 'JESTER'	SUNSHINE CONEBUSH	15 GAL	4'-0" OC	4'x4'		L
	RIBES SANGUINEUM V. GLUTINOSUM	FLOWERING CURRANT	5 GAL	4'-0" OC	4'x4'		L
MEDIUM	SHRUBS & GRASSES	1					
	AGAVE PARRYI	CENTURY PLANT	5 GAL	2'-0" OC	2'x3'		L
\bigcirc	LOMANDRA LONGIFOLIA 'BREEZE'	DWARF MAT RUSH	5 GAL	3'-0" OC	3'x3'		L
$\langle \cdot \rangle$	LIMONIUM PEREZII	SEA LAVENDER	5 GAL	3'-0" OC	3'x3'		L
	MIMULUS AURANTIACUS	MONKEYFLOWER	5 GAL	3'-0" OC	3'x4'		L
$(\!$	ROSMARINUS SPP.	ROSEMARY	5 GAL	3'-0" OC	3'x4'		L
	SALVIA SPP.	SAGE	5 GAL	3'-0" OC	3'x3'		L
SMALL S	HRUBS & GRASSES						
	ANIGOZANTHOS SPP.	KANGAROO PAW	5 GAL	6'-0" OC	3'x2'		L
\bigcirc	BULBINE FRUTESCENS 'ORANGE'	ORANGE BULBINE	1 GAL	2'-0" OC	1'x2'		L
	CORREA 'CARMINE BELLS'	AUSTRALIAN FUCHSIA	5 GAL	3'-0" OC	2'x3'		L
••	EPILOBIUM CANUM	CALIFORNIA FUCHSIA	1 GAL	2'-0" OC	1'x2'		L
\bigcirc	LIBERTIA PEREGRINANS	ORANGE LIBERTIA	1 GAL	5'-0" OC	2'x2'		L
	PENSTEMON 'MARGARITA BOP'	PENSTEMON	1 GAL	2'-0" OC	1'x2'		L
GROUND	COVERS						
	ARCTOSTAPHYLOS SPP.	MANZANITA	1 GAL	6'-0" OC	1'x6'		L
- - -	COTONEASTER 'CORAL BEAUTY'	COTONEASTER	1 GAL	4'-0" OC	1'x4'		L
<u> </u> - - -	RIBES VIBURNIFOLIUM SEDUM SPP.	EVERGREEN CURRANT	1 GAL	4'-0" OC	3'x4'		L
	SEDUM SPP.	SEDUM	1 GAL	3'-0" OC	1'x2'		L
	SENECIO MANDRALISCAE	BLUE FINGER	1 GAL	3'-0" OC	2'x3'		L
	SYMPHORICARPOS MOLLIS	CREEPING SNOWBERRY	1 GAL	3'-0" OC	2'x4'		L
BIORETE	NTION AREAS						
* * *	ACHILLEA MILLEFOLIUM	YARROW	1 GAL	2'-0" OC	2'x2'		L
¥ ¥	CHONDROPETALUM TECTORUM	CAPE RUSH	5 GAL	3'-0" OC	3'x3'		L
* *	IRIS DOUGLASIANA	DOUGLAS IRIS	BULB	2'-0" OC	2'x2'		L
· · ·	JUNCUS PATENS	CA. GRAY RUSH	1 GAL	2'-0" OC	2'x2'		L
•	HETEROMELES ARBUTIFOLIA	TOYON	5 GAL	5'-0" OC	6'x6'		L
¥ ¥	SISYRINCHIUM BELLUM	BLUE-EYED GRASS	1 GAL	2'-0" OC	1'x2'		L

GENERAL PLANTING NOTES


- ALL PLANTING AREAS SHALL BE TOP-DRESSED WITH A 3" LAYER OF ORGANIC, UN-DYED MULCH RECYCLED FROM LOCAL ORGANIC MATERIALS SUCH AS TREE TRIMMINGS, PLANT, OR CLEAN WOOD WASTE.
- 50% OF ALL SHRUBS AND GROUNDCOVER SHALL BE A MINIMUM OF 5-GALLON SIZE OR LARGER.
 ALL NEW AND EXISTING TREES WILL BE PRUNED TO PROVIDE REQUIRED CLEARANCE.
- 4. ALL STRUCTURES & VEGETATION WITHIN EXTENDED DRIVEWAY VISION TRIANGLES &
- CORNER VISION TRIANGLES MUST MEET REQUIREMENTS PER SMC 19.34.060.
- 5. MINIMUM SOIL DEPTH FOR GROUND COVER :12 INCHES MINIMUM SOIL DEPTH FOR FOR SHRUBS : 20 INCHES MINIMUM SOIL DEPTH FOR TREES: 36 INCHES
- 6. ALL TREES WITHIN 5'-0" OF PAVING SHALL HAVE 24" DEEP LINEAR ROOT BARRIERS.


SOIL DEPTH

UNIT S2

UNIT S1

1	PLANTING DEPTH TYPE A: ON GRADE	24"
2	PLANTING DEPTH TYPE B: ON STRUCTURE	32"
3	PLANTING DEPTH TYPE C: TREES ON STRUCTURE	36"

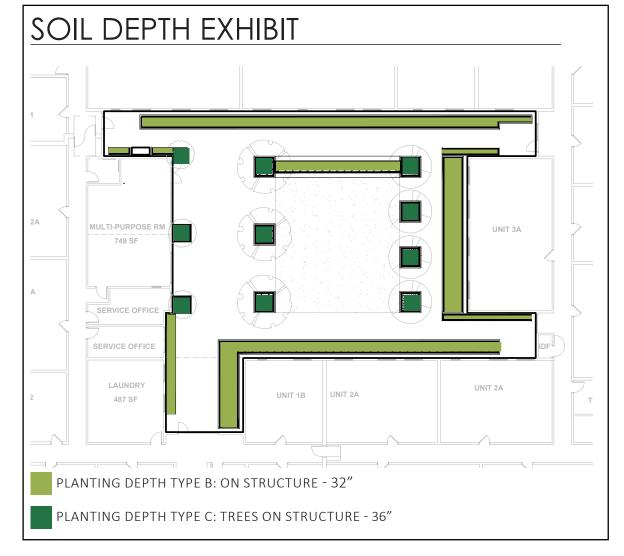

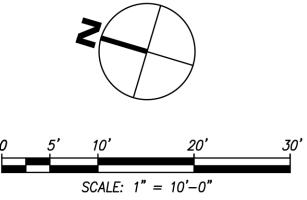



UNIT 2A

UNIT 1B

TREES











SHRUBS & GRASSES




















































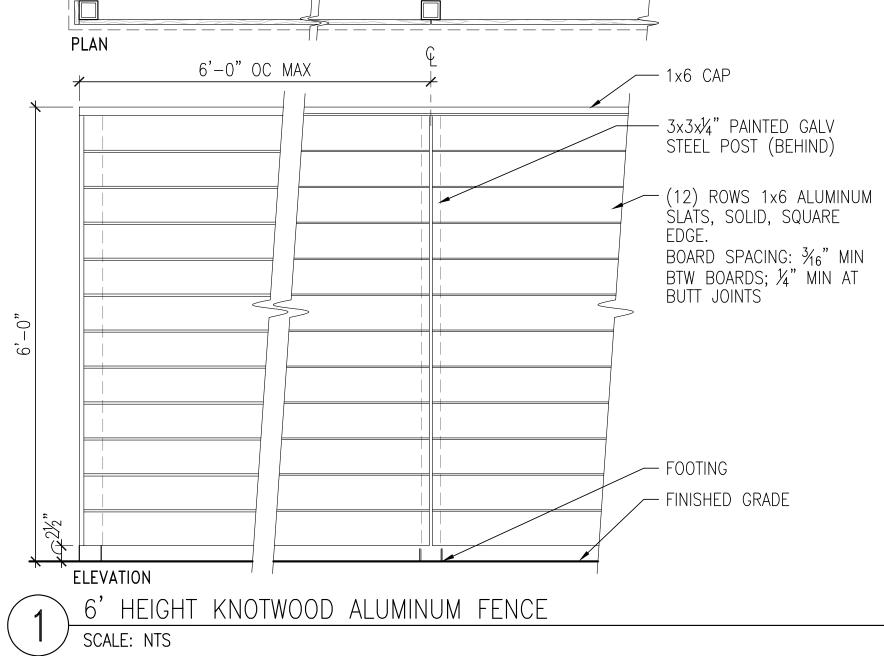

VINES







2.3 Multifamily Residential Transition Space

Intent: To promote a sense of privacy and separation from the public/pedestrian realm for residents of street-facing residential projects. Low-, Mid- and High-Rise Multifamily Residential development shall include a street-facing transition space that incorporates a combination of design approaches from Table 2B to score at least 50 points. This standard also applies to residential buildings that are part of a Horizontal Mixed-Use project to provide a transition between commercial spaces and residential buildings.

	Category	Approach	Points
a.	Entryway Design	Entryways accented by a change in external building material or application of a non-structural façade accent.	20
b.	Projecting Shade Features	Integration of a continuous architectural shade feature spanning at least 50 percent of the building frontage.	20
C.	Building Materials to Articulate Ground Surface	Use of paving stones, tile, masonry or patterned and colored concrete on the ground fronting all entryways.	10
	Total		50

193' - 2"

Overall

97' - 0"

Architectural shade

a. A non-structural frame at the main entrance

b. Total length of the building frontage: 192'-7 7/8"

Length of continuous architectural shade feature: 97'-0"

Percentage: 97'-0" / 193'-2" = 50.2% > 50%

3.5 Massing and Bulk

Intent: To ensure each new building becomes an attractive, complementary addition to its surroundings by moderating its apparent size and scale. New structures will achieve this natural fit through context-responsive form and a variety of methods to break down large facades.

Table 3B includes standards for dividing the length of buildings of various size in order to modulate mass and scale.

	Table 3B. Division of Building Length Standards				
	Standard	100' or more building width			
a.	General requirement	Building elevations shall be vertically divided by major recesses at maximum 75' intervals.			
b.	Division Standards	1. 1. At least 10' wide by 5' deep from ground level to roof level; and			
		2. of a color or material that contrasts with surrounding volumes, and			
		3. incorporated anywhere within a 75-foot segment of horizontal elevation.			


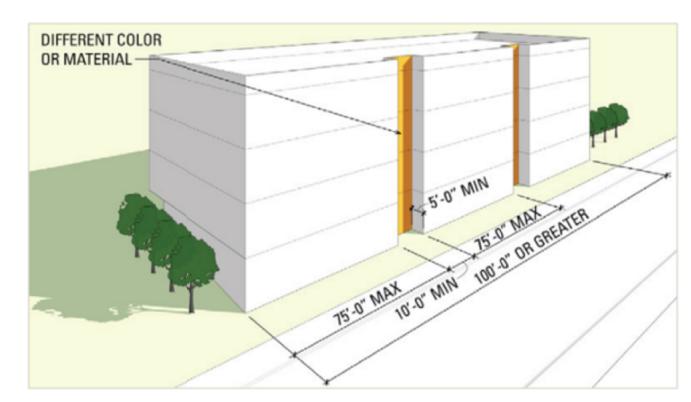



Figure 3-6 Division of building length; 100' or wider mid- and high-rise buildings.






SOUTH ELEVATION

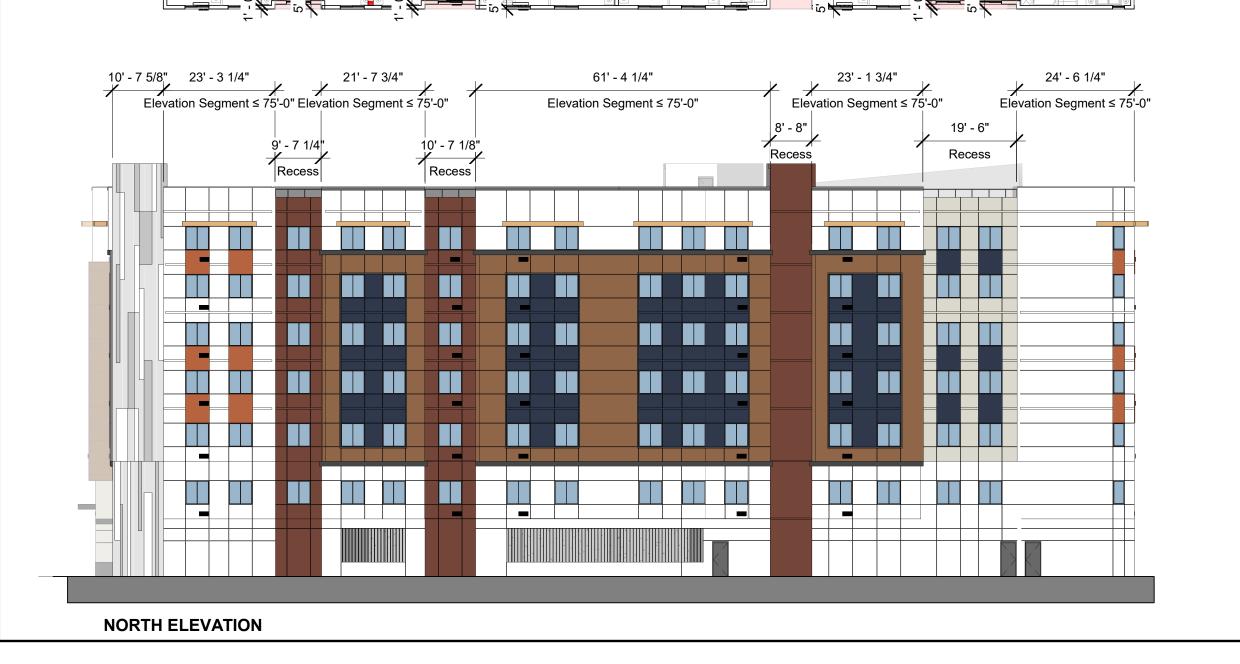

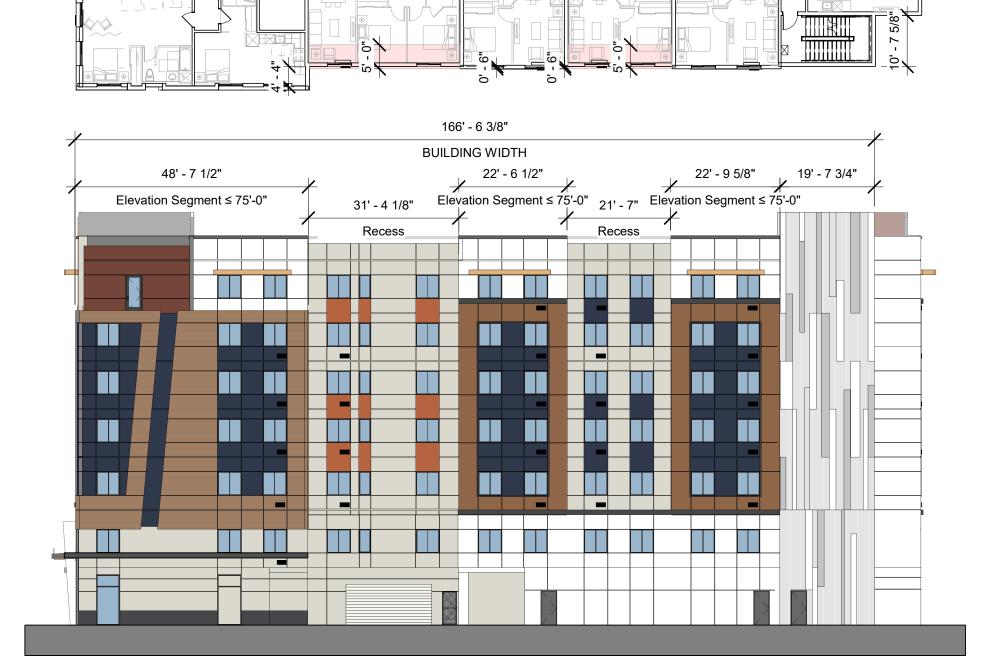

EAST ELEVATION

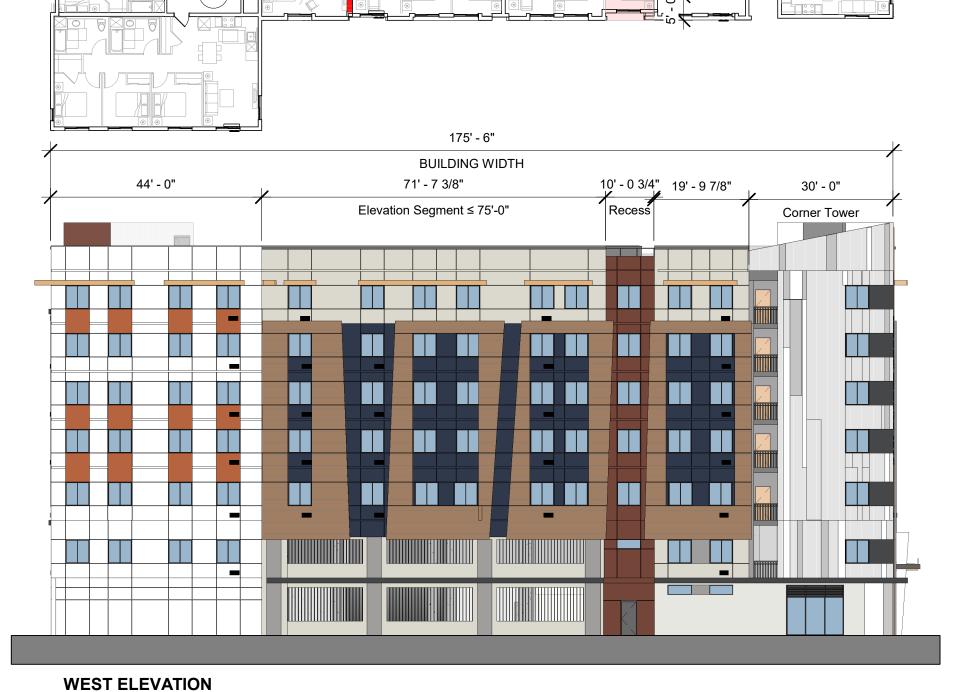



- : Architecture
- : Planning
- : Urban Design
- : 1970 Broadway, Suite 408: Oakland, California 94612
- : Oakland, California 94612: (510) 451 2850

THIS DOCUMENT CONTAINS INFORMATION
PROPRIETARY TO STUDIO T-SQ, INC. AND IS FURNISHED
IN CONFIDENCE FOR THE LIMITED PURPOSE OF
EVALUATION OR REVIEW. THIS DOCUMENT OR ITS
CONTENTS MAY NOT BE USED FOR ANY OTHER

PURPOSE AND MAY NOT BE REPRODUCED OR
DISCLOSED TO OTHERS WITHOUT THE PRIOR WRITTEN

CONSENT OF STUDIO T-SQ., INC. ALL RIGHTS RESERVED, COPYRIGHT 2021.



SOCIATES, L.F

SONORA

SONORA COU

Sheet Title:

/

_

OBJECTIVE DESIGN STANDARDS COMPLIANCE DIAGRAMS

Job No. 21009
Date: 07/10/2025
Scale: 1" = 20'-0"
Drawn By:

Sheet No:

3.5.1 Mid-Rise and High-Rise Corner Buildings

1. A change in architectural massing of at least 30 feet horizontally on each side of the corner. This change shall be expressed by at least two of the following:


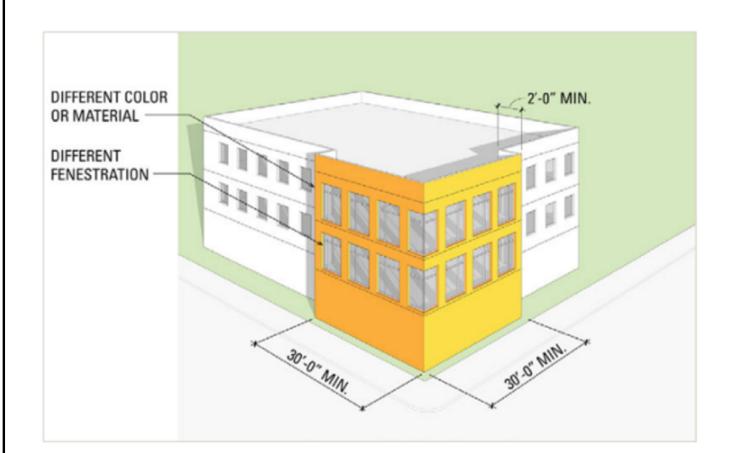


Figure 3-7 Approaches to corner architectural massing.


3.5.1 Mid-Rise and High-Rise Corner Buildings

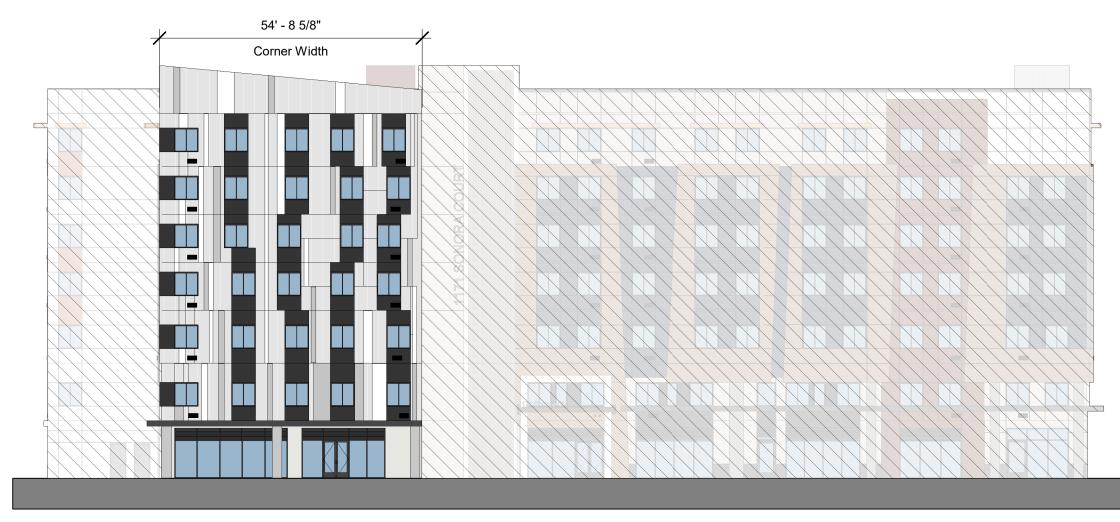

SOUTH ELEVATION

A change in architectural massing occurs at 54'-8 5/8" and 30' horizontally on south and west.

- Use of different building materials from the main wall plane; Contrasting colors from the main wall plane

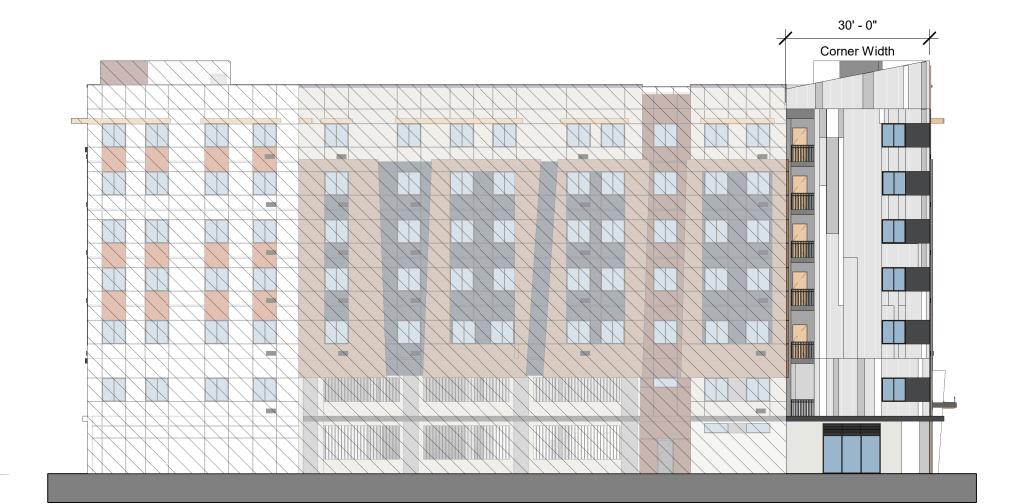

WEST ELEVATION

T SQUARE

Architecture

Planning

Urban Design

1970 Broadway, Suite 408 Oakland, California 94612

(510) 451 - 2850

THIS DOCUMENT CONTAINS INFORMATION PROPRIETARY TO STUDIO T-SQ, INC. AND IS FURNISHED IN CONFIDENCE FOR THE LIMITED PURPOSE OF EVALUATION OR REVIEW. THIS DOCUMENT OR ITS CONTENTS MAY NOT BE USED FOR ANY OTHER PURPOSE AND MAY NOT BE USED FOR ANY OTHER
PURPOSE AND MAY NOT BE REPRODUCED OR
DISCLOSED TO OTHERS WITHOUT THE PRIOR WRITTEN
CONSENT OF STUDIO T-SQ., INC. ALL RIGHTS
RESERVED, COPYRIGHT 2021.



3.6.2 Mid-Rise and High-Rise Residential Articulation Standards

New mid-rise and high-rise residential development projects shall provide vertical elevation articulation in the form of a well-defined ground floor, a body (middle floors) and a cap (upper floor) to break up the building plane. The ground floor, middle and cap shall have visually distinct design features that adhere to all of the following requirements:

1. The ground floor elevation

A line of awnings or canopies over ground floor storefronts or amenity space windows extending at least 75 percent of the elevation width.

2. The body/middle floor(s) shall have a greater vertical dimension than the ground floor and the cap and shall be a different material, color or texture than either the ground floor or the cap.

3. The cap/upper floor is at the top of the building (not including any stepback or high-rise tower)

A change in exterior cladding material at the entirety of the top story that is different than the story below, effectively using the top story as a wall cap.


4. Architectural features marking main entries to buildings may extend above the ground floor.

5. Vertical elements such as towers are not required to adhere to these standards.

Architectural feature



SOUTH ELEVATION

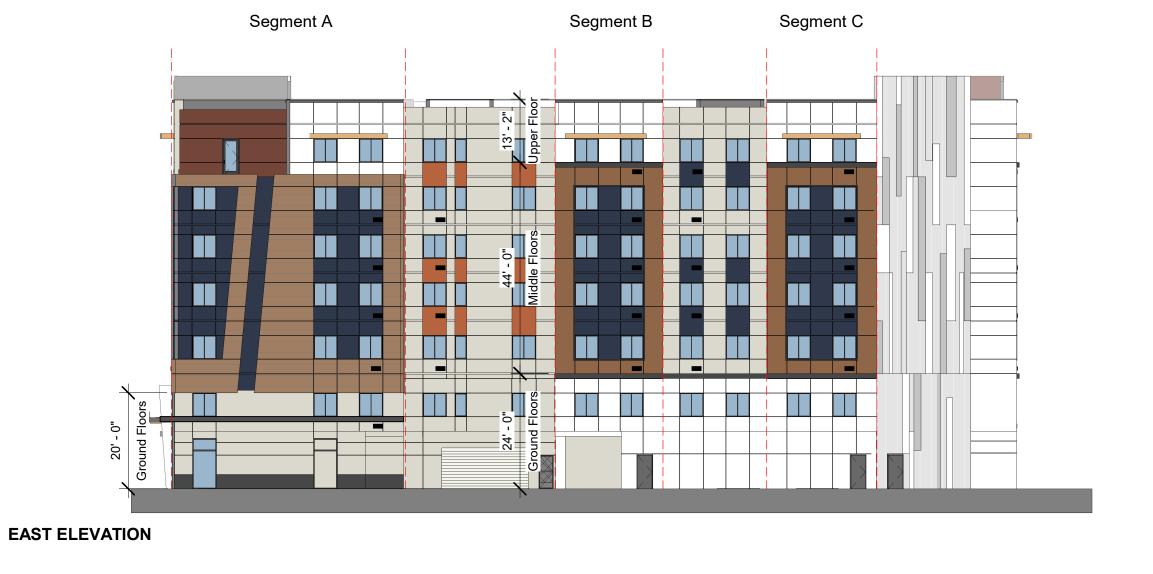

1. The ground floor elevation canopies width: 75% of the building elevation:

151'-510" > 144'- 10 1/2"

" A line of awnings or canopies over ground floor storefronts or amenity space windows extending at least 75 percent of the elevation width."

54'-10" + 97'-0" = 151'-10"

193'-2" x 75% = 144'- 10 1/2"

2. Vertical dimension

Middle/Body floors: 45'-6" 20'-0" Ground floors: 15'-8" Upper floor:

"The body/middle floor(s) shall have a greater vertical dimension than the ground floor and the cap and shall be a different material, color or texture than either the ground floor or the cap. "

4. Architectural feature

Complies with

"Architectural features marking main entries to buildings may extend above the ground floor."

2. Vertical dimension

Segment A: Middle/Body floors: 45'-6" Ground floors: 20'-0" Upper floor: 15'-8"

Segment B& C: Middle/Body floors: 44'-0" Ground floors: 24'-0" Upper floor: 13'-2"

Complies with

" The body/middle floor(s) shall have a greater vertical dimension than the ground floor and the cap and shall be a different material, color or texture than either the ground floor or the cap. "

SOCIAT

SONORA

Sheet Title:

/ ~

COURT

SONORA

OBJECTIVE DESIGN STANDARDS COMPLIANCE **DIAGRAMS**

21009 Job No. 07/10/2025 Date: 1" = 20'-0" Scale:

Sheet No:

Drawn By:

3.6.2 Mid-Rise and High-Rise Residential Articulation Standards

New mid-rise and high-rise residential development projects shall provide vertical elevation articulation in the form of a well-defined ground floor, a body (middle floors) and a cap (upper floor) to break up the building plane. The ground floor, middle and cap shall have visually distinct design features that adhere to all of the following requirements:

1. The ground floor elevation

- A line of awnings or canopies over ground floor storefronts or amenity space windows extending at least 75 percent of the elevation width.
- 2. The body/middle floor(s) shall have a greater vertical dimension than the ground floor and the cap and shall be a different material, color or texture than either the ground floor or the cap.
- 3. The cap/upper floor is at the top of the building (not including any stepback or high-rise tower)
- A change in exterior cladding material at the entirety of the top story that is different than the story below, effectively using the top story as a wall cap.
- 4. Architectural features marking main entries to buildings may extend above the ground floor.
- 5. Vertical elements such as towers are not required to adhere to these standards.



Segment A

The circled windows on Level 2 vary in size

from all the other windows on the south

elevation

2. Vertical dimension Segment A, B& C:

Middle/Body floors: 44'-0" Ground floors: 24'-0" Upper floor: 13'-2"

Complies with

"The body/middle floor(s) shall have a greater vertical dimension than the ground floor and the cap and shall be a different material, color or texture than either the ground floor or the cap. "



- : Architecture
- Planning
- **Urban Design**
- 1970 Broadway, Suite 408 Oakland, California 94612
- (510) 451 2850

THIS DOCUMENT CONTAINS INFORMATION PROPRIETARY TO STUDIO T-SQ, INC. AND IS FURNISHED IN CONFIDENCE FOR THE LIMITED PURPOSE OF EVALUATION OR REVIEW. THIS DOCUMENT OR ITS CONTENTS MAY NOT BE USED FOR ANY OTHER PURPOSE AND MAY NOT BE USED FOR ANY OTHER
PURPOSE AND MAY NOT BE REPRODUCED OR
DISCLOSED TO OTHERS WITHOUT THE PRIOR WRITTEN
CONSENT OF STUDIO T-SQ., INC. ALL RIGHTS
RESERVED, COPYRIGHT 2021.



2. Vertical dimension

Segment A& B: Middle/Body floors: 45'-6" Ground floors: 20'-0" Upper floor: 15'-8"

e. Pilasters extending two stories.

"The body/middle floor(s) shall have a greater vertical dimension than the ground floor and the cap and shall be a different material, color or texture than either the ground floor or the cap. "

4.2.1.2 Variety in Building Elevation

All building elevations shall incorporate a combination of design strategies from Table 4A to score at least 100 points.

WEST ELEVATION

	Table 4A. Building Elevation Design Strategies				
	Strategy	Building Detail Element	Points		
a.	Window and Entry Articulation	Recess all windows by three and one-half inches or more	30		
b.	Window and Entry Articulation	Window size variation – include at least three windows that vary in size from all other windows on each elevation.	20		
C.	Elevation Articulation	Include terraces above the first floor, a minimum of 10 feet in all directions and a total of at least 120 square feet in area, with railings that are no more than 42 inches in height, on at least one public street-facing exterior building elevation.	20		
d.	Elevation Articulation	A building entry feature of at least two stories.	10		
e.	Elevation Articulation	Pilasters or piers extending at least two stories.	10		
f.	Elevation Articulation	Incorporation of scoring lines, reveals or expansion joints at least four inches wide at each floor of stucco/cement plaster wall surfaces.	10		
Total					



SOUTH ELEVATION

Segment B

SOCIAT SONORA

COURT SONORA

/ ~

Sheet Title:

OBJECTIVE DESIGN STANDARDS COMPLIANCE **DIAGRAMS**


21009 Job No. 07/10/2025 Date: Scale: 1" = 20'-0" Drawn By:

Sheet No:

4.2.1.2 Variety in Building Elevation

All building elevations shall incorporate a combination of design strategies from Table 4A to score at least 100 points.

	Strategy	Building Detail Element	Points
a.	Window and Entry Articulation	Recess all windows by three and one-half inches or more	30
b.	Window and Entry Articulation	Window size variation – include at least three windows that vary in size from all other windows on each elevation.	20
C.	Elevation Articulation	Include terraces above the first floor, a minimum of 10 feet in all directions and a total of at least 120 square feet in area, with railings that are no more than 42 inches in height, on at least one public street-facing exterior building elevation.	20
d.	Elevation Articulation	A building entry feature of at least two stories.	10
e.	Elevation Articulation	Pilasters or piers extending at least two stories.	10
f.	Elevation Articulation	Incorporation of scoring lines, reveals or expansion joints at least four inches wide at each floor of stucco/cement plaster wall surfaces.	10
Total			100

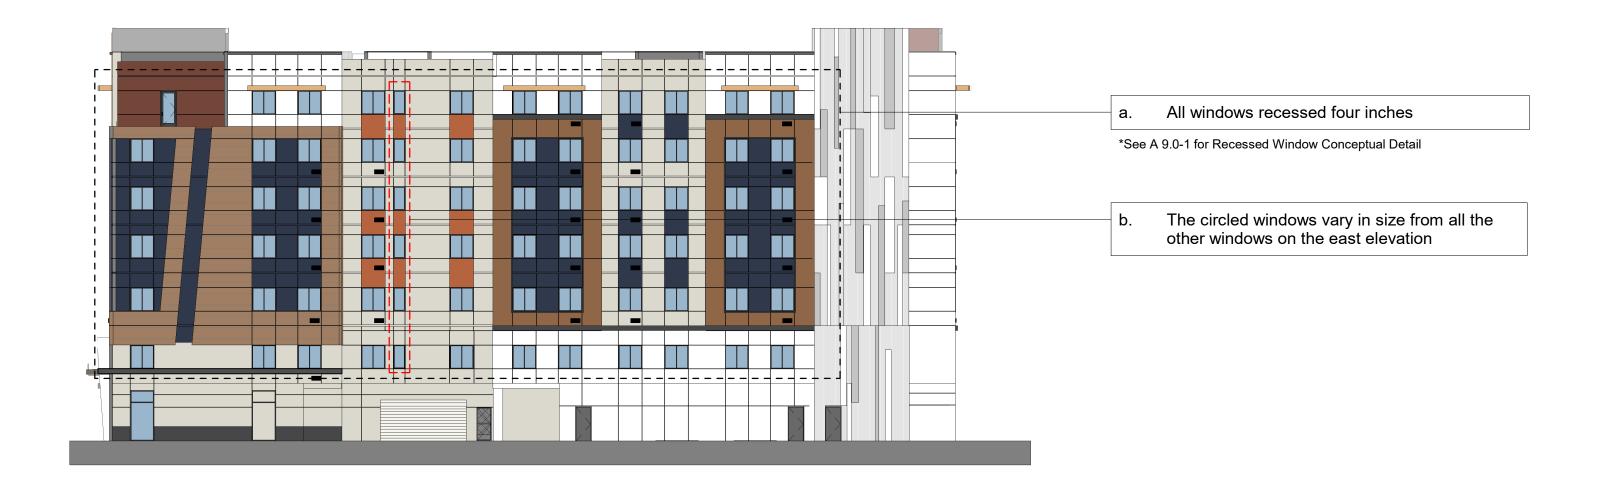

EAST ELEVATION

NORTH ELEVATION







- : Architecture
- : Planning
- : Urban Design
- : 1970 Broadway, Suite 408: Oakland, California 94612
- : Oakland, California 94612: (510) 451 2850

THIS DOCUMENT CONTAINS INFORMATION PROPRIETARY TO STUDIO T-SQ, INC. AND IS FURNISHED IN CONFIDENCE FOR THE LIMITED PURPOSE OF EVALUATION OR REVIEW. THIS DOCUMENT OR ITS CONTENTS MAY NOT BE USED FOR ANY OTHER PURPOSE AND MAY NOT BE REPRODUCED OR DISCLOSED TO OTHERS WITHOUT THE PRIOR WRITTEN CONSENT OF STUDIO T-SQ., INC. ALL RIGHTS RESERVED, COPYRIGHT 2021.



ASSOCIATES, L.

SONORA

le, California

117

Sheet Title:

SONORA

OBJECTIVE DESIGN STANDARDS COMPLIANCE DIAGRAMS

Job No. 21009

Date: 07/10/2025

Scale: 1" = 20'-0"

Drawn By:

Sheet No: