## CHING RESIDENCE REMODEL

TEL

T&G

TOC

## 938 W CARDINAL DR SUNNYVALE

towel ba

terazzo

telephone

top of curb

top of plate

television

top of wall

ventilation

typical

vertical

vestibule

volumn

wood

window

without

wainscot

water closet

wide flange

waterproof(ing)

toungue & groove

top of pavement toilet paper dispenser

tempered plate glass

toilet seat cover dispenser

vertical grain Douglas Fir

toilet paper holder

#### **GENERAL CODE NOTES**

- DOOR BETWEEN HOUSE & GARAGE SHALL BE TIGHT-FITTING, 1-3/8", 20 MIN. RATED, SOLID CORE EOUIPPED WITH SELF-CLOSING AND SELF-LATCHING DEVICE OR IN COMPLIANCE W/ CRC SECT. R302.5.1
- 2. USEABLE AREA UNDER STAIRS SHALL BE PROTECTED WITH 5/8" TYPE "X" GYPSUM BOARD, MINIMUM REQUIREMENTS FOR R-3 OCCUPANCY IS 1/2" GYP. BOARD, CRC SECTION R302.7.
- HANDRAILS SHALL HAVE A PERIMETER DIMENSION OF AT LEAST 4" AND NOT GREATER THAN 6 1/4" WITH A MAX. CROSS SECTION DIMENSION OF 2 1/4". EDGES SHALL HAVE A MIN. RADIUS OF 0.01". CRC R311.7.7, R311.7.8, R311.7.8.1, R311.7.8.2, R311.7.8.3
- SHALL HAVE A HEIGHT OF NOT LESS THAN 34" AND NOT MORE THAN 38" MEASURED VERTICALLY FROM A LINE CONNECTING THE LEADING EDGES OF THE TREADS. GUARDS SHALL NOT HAVE AN OPENING FROM THE WALKWAY SURFACE TO THE REQUIRED HEIGHT WHICH ALLOW PASSAGE OF A 4" DIAMETER SPHERE. CRC R312.1.3
- CLEAR OPENING WITHOUT THE USE OF SEPARATE TOOLS. ESCAPE WINDOWS SHALL HAVE A MINIMUM NET CLEAR OPENABLE AREA OF 5.7 SF, AND 5.0 SF AT GRADE FLOOR OPENINGS. MINIMUM NET CLEAR HEIGHT 24", WIDTH OF 20" MINIMUM, AND BOTTOM OF THE CLEAR OPENING SHALL NOT BE GREATER THAN 44" MEASURE FROM THE FLOOR.(R310.2.2.)
- FOR EXCEPTIONS, PER CRC SECTIONS R303.1. BATHROOMS SHALL COMPLY WITH MIN. AREA FOR NATURAL LIGHT OR MEET REQUIREMENTS FOR EXCEPTIONS. PER CRC SECT. R303.3. BATHROOMS AND LAUNDRY ROOMS SHALL BE PROVIDED WITH EXHAUST FANS THAT COMPLY WITH CRC SECT. R303.4 & R303.5 AND THE CALIFORNIA MECHANICAL CODE.
- GLAZING IS LESS THAN 60" ABOVE A STANDING SURFACE AND DRAIN INLET, GLAZING IN WINDOWS ADJACENT TO DOORS WITHIN 24" ARC OF EITHER VERTICAL EDGE OF THE DOOR IN A CLOSED POSITION AND WHERE THE BOTTOM EDGE OF THE GLAZING IS LESS THAN 60" ABOVE THE WALKING SURFACE.
- 8. SMOKE ALARMS AND CARBON MONOXIDE ALARMS SHALL BE INSTALLED PER CRC SECTION R314 AND R315.LOCATE ALARMS OUTSIDE EACH SLEEPING ROOM IN THE IMMEDIATE VICINITY OF BEDROOMS.PROVIDE APPROVED SMOKE DETECTORS AND CARBON MONOXIDE DETECTORS THROUGHOUT EACH STRUCTURE.
- INSTALLATION INSTRUCTIONS PER CPC 504.3.1. UNLISTED WATER HEATERS SHALL BE INSTALLED WITH A CLEARANCE OF 12" ON ALL SIDES AND REAR PER CPC 504.3.2. COMBUSTION AIR SHALL BE PROVIDED IN ACCORDANCE WITH CMC SECTION 701. WATER HEATER CLOSET OPENING SHALL HAVE A MINIMUM OF 1 SQ. IN. PER 1000 BTU INPUT, BUT NOT LESS THAN 100 SQ. IN. AND HAVE 1/2 LOCATED WITHIN 12" OF THE CEILING AND 1/2 LOCATED WITHIN 12" OF FLOOR PER CMC 701.5.
- 10. GAS PIPE CONNECTION TO EACH APPLIANCE SHALL HAVE AN ACCESSIBLE SHUT-OFF VALVE AND BE INSTALLED WITH FLEX-CONNECTORS.
- GAS APPLIANCES INSTALLED IN THE GARAGE SHALL BE ELEVATED SO THAT PILOTS AND BURNERS ARE AT LEAST 18" ABOVE THE FLOOR PER CPC 507.13. PROTECT APPLIANCES FROM DAMAGE BY INSTALLING A PROTECTIVE STEEL POST, 3" DIA. X 24" HIGH, 12" IN FRONT OF APPLIANCE, UNLESS LOCATED OUTSIDE THE NORMAL PATH OF A VEHICLE.
- 12. VENTING OF GAS APPLIANCES SHALL BE IN ACCORDANCE WITH THE CMC AND CPC. VERIFY RUN, OFFSETS, SLOPES AND DIRECTION OF VENTS THROUGH FRAMING TO PROVIDE MINIMUM CLEARANCE TO COMBUSTIBLES FOR TYPE FLUE USED.
- 13. SHOWER AND TUB-SHOWER VALVES SHALL BE PRESSURE BALANCED OR THERMOSTATIC MIXING VALVES SHALL COMPLY WITH
- 14. WATER HEATER PRESSURE RELIEF VALVES SHALL BE EQUIPPED WITH PIPING DIRECTLY TO THE EXTERIOR AND TERMINATING NOT LESS THAN 6" ABOVE GRADE, INSTALL HOSE BIBBS AT LOCATIONS NOTED HB, USE FAUCET TYPE EQUIPPED WITH BACKFLOW OR BACK SIPHONAGE PROTECTION PER CPC SECTION 603.5.7.
- 15. INSTALL WATER CLOSETS (TOILETS) HAVING A 1.28 GALLONS/FLUSH MAXIMUM. PER CALIFORNIA CIVIL CODE ARTICLE 1101.4 AND CALGREEN SECTION 301.1 THE WATER CLOSET SPACE SHALL BE SET NO CLOSER THAN 15" FROM ITS CENTER TO A SIDE WALL AND NO CLOSER THAN 30" CENTER TO CENTER TO A SIMILAR FIXTURE. CLEARANCE IN FRONT OF WATER CLOSET SHALL BE NOT LESS THAN 24" PER CPC SECTION 402.5.
- 16. INSTALL UNDERFLOOR ACCESS WITH ACCESSIBLE MINIMUM CLEARANCE 18" x 24" AND FREE FROM PIPES, DUCTS AND SIMILAR OBSTRUCTION, CRC SECTION R408.4.
- 17. INSTALL ATTIC ACCESS WITH MINIMUM 22" x 30" ROUGH OPENING LOCATED IN HALLWAY OR OTHER READILY ACCESSIBLE LOCATION, HAVING A 30" MINIMUM UNOBSTRUCTED HEADROOM IN THE ATTIC SPACE, ABOVE THE OPENING, CRC R807.1.
- 18. WHIRLPOOL TUB SHALL COMPLY WITH CPC SECTION 409.0 AND THE CEC. ELECTRICAL POWER SOURCE SHALL BE EQUIPPED WITH GROUND-FAULT CIRCUIT INTERRUPTER PROTECTION.
- 19. LIGHT FIXTURES INSTALLED IN CLOSETS SHALL BE SURFACE MOUNTED FLUORESCENT, LOCATED ON THE WALL ABOVE THE DOOR A MIN HEIGHT OF 6 FEET AND HAVE MINIMUM CLEARANCES OF 12" TO STORAGE SHELVES AND SIDED, PER CEC SECTION 410.2.
- 20. ELECTRICAL RECEPTACLES LOCATED IN THE GARAGE, (SEE EXCEPTIONS FOR SPECIFIC EQUIPMENT) EXTERIOR (WATERPROOF), CRAWL SPACE. BATHROOMS. KITCHEN COUNTERS AND WITHIN 6' AND WITHIN 6' EACH WAY FROM SINKS OR LAVATORIES, SHALL BE GROUND\_FAULT CIRCUIT INTERRUPTER PROTECTED (GFI) IN ACCORDANCE WITH CEC SECTION 210.8(A).
- 21. INSTALL LIGHT FIXTURES, LOCATED IN KITCHENS AND ROOMS HAVING WATER CLOSETS THAT DO NOT EXCEED 40 LUMENS/WATT (FLUORESCENT TYPE) PER CALIFORNIA TITLE 24. INSTALL FIXTURES RATED FOR DAMP LOCATIONS (DL), EXTERIOR AND IN SHOWER OR TUB COMPARTMENTS. INSTALL FIXTURES RECESSED IN THE CEILINGS RATED FOR INSULATION PROTECTION (IC/AT) AND AIRTIGHT. CEC 406.9.
- 22. INSTALL SOLID BACKING AT WALLS AND WATERPROOF MEMBRANE AT SHOWER PAN, SEAMLESS TYPE "OATEY" UP 12" MIN WALLS AND OVER SHOWER CURB. SHAPE SHOWER PAN FLOOR USING 3/4" PLYWOOD SHIMMED TO FORM SLOPE TO DRAIN. INSTALL 4
- 23. INSTALL WATERPROOF MATERIAL SUCH AS TILE, ON SHOWER WALLS +72" MIN ABOVE THE FLOOR PER CBC R307.2
- 24. FINISHED ROOFING MATERIAL SHALL BE INSTALLED AND COMPLETED PRIOR TO FRAME INSPECTION.

X 4 PTDF CURB, PER CPC 408.5 - 408.7

- 25. ALL SHOWER HEADS IN THE EXISTING RESIDENCE WITH A FLOW RATE GREATER THAN 2.5 GPM WILL NEED TO BE REPLACED WITH A MAXIMUM 2.0 GPM SHOWER HEAD. FAUCETS WITH A FLOW RATE GREATER THAN 2.2 GPM WILL NEED TO BE REPLACED WITH MAXIMUM FLOW RATE OF 1.2 GPM FOR LAVATORY FAUCETS AND 1.8 GPM FOR KITCHEN FAUCETS PER CALIFORNIA CIVIL CODE ARTICLE 1101.4 AND CALGREEN SECTION 4.303.
- 26. HABITABLE SPACE, HALLWAYS AND PORTIONS OF BASEMENTS CONTAINING THESE SPACES SHALL HAVE A CEILING HEIGHT OF NOT LESS THAN 7 FEET. BATHROOMS, TOILET ROOMS AND LAUNDRY ROOMS SHALL HAVE A CEILING HEIGHT OF NOT LESS THAN 6 FEET

**APPROX** 

ARCH

AVE

AVG

BLDG

BLK

**BVLD** 

CEM

CLG

CLKG

CLR

CNTR

CONC

CONN

CONT

CORR

CTR

CYL

DEPT

DISP

DWR

**EQUIP** 

**EXIST** 

**FLOUR** 

**GALV** 

GYP

CONST

centerline **HDWE** diameter HDWD pound/number НМ HORIZ existing anchor bolt asphaltic concrete aggregate alternate aluminum approximate architect asbestos average bulletinboard

STANDARD ABBREVIATIONS

asphalt

avenue

board

bituminous

boulevard

benchmark/beam

catch basin/chalkboard

building

cement cast iron

caulking

counter

cleanout

concrete

connection

contruction

continuous

department

dimension

dispenser

downspout

dishwasher

electric panelboard

equipment

existing

exterior

exposed

fire alarm

floor drain

foundation

full size

foot/feet

footing

furnish

furring

grab bar

grade

gypsum

galvanized

drawing

dowel

drawer

Douglas Fir/drinking fountain OD

corridor

center

cylinder

column

clear

control joint

TOP hollow metal horizontal TPG TSCH inside diameter TYP VENT insulation **VERT VEST VGDF** VOL kiln dried lavatorv

WIN W/O WSCT medicine cabinet medium density fiberboard mechanical membrane

metal manufacture(r) manhole minimum mirror miscellaneous masonry opening module/modular mounted

hollow core

hot dipped

hardware

hardwood

height

heating

heater

interior

janitor

material

maximum

MAX

MC

MDF

MET

MOD

MECH

mullion not in contract number

nominal not to scale on center outside diamete

opening

plate glass

plywood

quarry tile

property line

pressure treated

partition provided/supplied by owner PERP perpendicular

expansion joint **PLYWD** elevation electrical elevator emergency enclosure

> rise/radius roof drain reiforce/reinforcing reference refridgerator required

RESIL resiliant REV revision RMrough opening

fire extinguisher fire extinguisher cabinet fire hose cabinet flashing SECT flourescent SEL face of concrete SD face of finish SG face of stud fire proof

> sheet SHWR shower similar sanitary napkin dispenser sanitary napkin recepticle specification square stainless steel SSK service sink

redwood

section

select


rain water leader

soap dispenser

sheet glass

STD standard STL STRUCT structural suspend(ed) symetrical

Do not scale from these plans, use dimensions. This set is intended to be printed on Arch D (24"x36") sized paper. If the plans are printed on any size other than Arch D size, the plans are NOT TO SCALE.

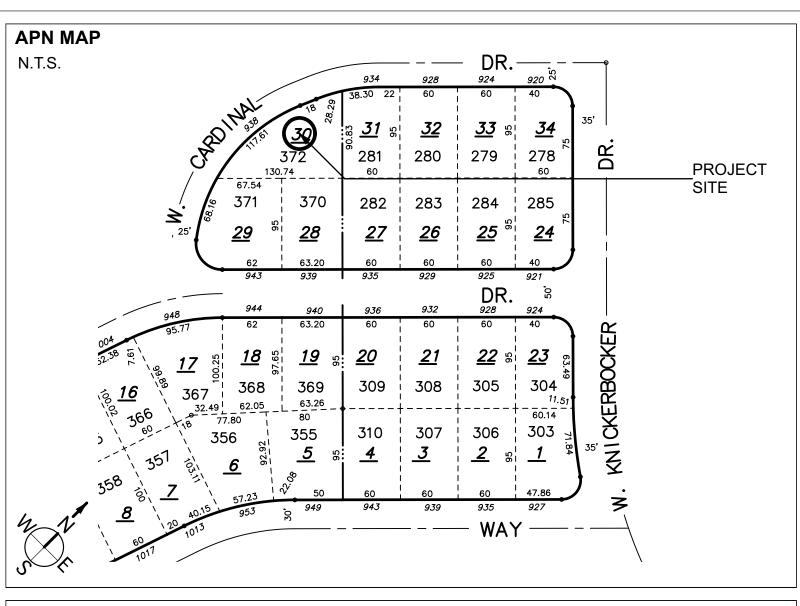

#### APPLICABLE CODES:

2022 CALIFORNIA BUILDING CODE (CBC) 2022 CALIFORNIA PLUMBING CODE (CPC) 2022 CALIFORNIA MECHANICAL CODE (CMC) 2022 CALIFORNIA RESIDENTIAL CODE (CRC)

2022 CALIFORNIA ELECTRICAL CODE (CEC) 2022 CALIFORNIA ENERGY CODE(CEnC) 2022 CALIFORNIA GREEN BUILDING STANDARDS CODE (CALGreen)

SUNNYVALE MUNICIPAL CODE

#### **OPERATIONAL MANUAL**

OPERATION AND MAINTENANCE MANUAL, AT THE TIME OF FINAL INSPECTION, A MANUAL, COMPACT DISC, WEB-BASED REFERENCE OR OTHER MEDIA ACCEPTABLE TO THE ENFORCING AGENCY WHICH INCLUDES ALL OF THE FOLLOWING SHALL BE PLACED IN THE

- 1. DIRECTIONS TO THE OWNER OR OCCUPANT THAT THE MANUAL SHALL REMAIN WITH THE BUILDING THROUGHOUT THE LIFE CYCLE OF THE STRUCTURE.
- . OPERATION AND MAINTENANCE INSTRUCTIONS FOR THE FOLLOWING: A. FOUIPMENT AND APPLIANCES. INCLUDING WATER-SAVING DEVICES AND SYSTEMS, HV AC SYSTEMS, WATER-HEATING SYSTEMS AND OTHER MAJOR APPLIANCES AND EQUIPMENT. B. ROOF AND YARD DRAINAGE, INCLUDING GUTTERS AND DOWNSPOUTS, C. SPACE CONDITIONING SYSTEMS, INCLUDING CONDENSERS AND AIR FILTERS. D. LANDSCAPE IRRIGATION SYSTEMS
- 3. INFORMATION FROM LOCAL UTILITY, WATER AND WASTE RECOVERY PROVIDERS ON METHODS TO FURTHER REDUCE RESOURCE
- CONSUMPTION, INCLUDING RECYCLE PROGRAMS AND LOCATIONS.
- 4. PUBLIC TRANSPORTATION AND/OR CARPOOL OPTIONS AVAILABLE IN THE AREA. 5. EDUCATIONAL MATERIAL ON THE POSITIVE IMPACTS OF AN INTERIOR RELATIVE HUMIDITY BETWEEN 30-60 PERCENT AND WHAT
- METHODS AN OCCUPANT MAY USE TO MAINTAIN THE RELATIVE HUMIDITY LEVEL IN THAT RANGE. 6. INFORMATION ABOUT WATER-CONSERVING LANDSCAPE AND IRRIGATION DESIGN AND CONTROLLERS WHICH CONSERVE WATER. 7. INSTRUCTIONS FOR MAINTAINING GUTTERS AND DOWNSPOUTS AND THE IMPORTANCE OF DIVERTING WATER AT LEAST 5 FEET AWAY
- 8. INFORMATION ON REQUIRED ROUTINE MAINTENANCE MEASURES, INCLUDING, BUT NOT LIMITED TO, CAULKING, PAINTING, GRADING AROUND THE BUILDING, ETC.
- 9. INFORMATION ABOUT STATE SOLAR ENERGY AND INCENTIVE PROGRAMS AVAILABLE. 10. A COPY OF ALL SPECIAL INSPECTION VERIFICATIONS REQUIRED BY THE ENFORCING AGENCY OR THIS CODE.

http://www.energy.ca.gov/2015publications/CEC-400-2015-032/appendices/forms/CF2R/


THE BUILDER/CONTRACTOR TO PROVIDE THE OWNER AND THE FIELD INSPECTOR WITH A COPY OF THE VARIOUS CERTIFICATES OF INSTALLATION FOR THE VARIOUS APPLICABLE PORTIONS OF THE CONSTRCUTION AND/OR INSTALLATION. (BUILDING ENERGY EFFICIENCY STANDARDS SECTION 10-103 (a) (3)) NOTE: PRESCRIPTIVE CERTIFICATES OF INSTALLATION CAN BE OBTAINED AT THE FOLLOWING LOCATION:

COMPLY WITH ALL APPLICABLE REQUIREMENTS OF THE SUNNYVALE MUNICIPAL CODE (SMC), CALIFORNIA FIRE CODE (CFC), TITLE 19 CALIFORNIA CODE OF REGULATIONS, AND SUNNYVALE FIRE PREVENTION PROCEDURES/REQUIREMENTS.

PROVIDE APPROVED SMOKE DETECTORS AND CARBON MONOXIDE DETECTORS THROUGHOUT EACH

### TABLE OF CONTENTS

No.	Sheet Title	
G1.0	COVER SHEET	
AB00	SURVEY	
A1.0	(E) SITE PLAN	
A1.1	(N) SITE PLAN	
A2.0	(E) FLOOR AND DEMO PLAN	
A2.1	(N) FLOOR PLAN	
A3.0	(E) ELEVATIONS	
A3.1	(N) ELEVATIONS	
A3.2	STREET ELEVATION	
A4.0	(E) ROOF PLAN	
A4.1	(N) ROOF PLAN	
A4.2	COLOR AND MATERIAL BOARD	
A5.0	SECTION AA	
13	TOTAL SHEETS THIS SET	

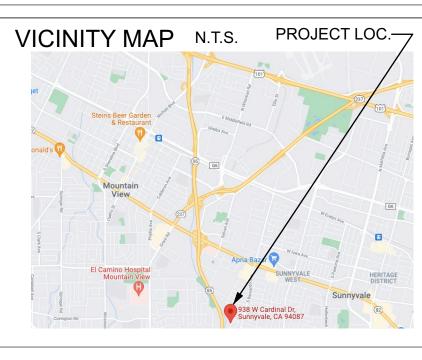

#### PROJECT INFORMATION

**ALVIN Y CHING** 938 W CARDINAL DR SUNNYVALE

**PLAN PREPARER** LAKSHMI SUBRAMANIAN

12429 DE SANKA AV SARATOGA CA 95070 (408) 203 7814

#### **PROJECT DESCRIPTION:** 1.VARIANCE FOR FRONT SETBACK

- 2.TEARING DOWN (E) GARAGE AND NON COMPLIANT SHED AND BUILDING (N) GARAGE. 3.ADDING (N) WET BAR, KITCHEN, LIVING, DINING, LAUNDRY AND PANTRY.
- 4. REMOVING (E) WOOD FIREPLACE.
- 5. REMOVING BRICK SIDING AND CONVERTING
- TO STUCCO AND SIDING EXTERIOR. 6. REPLACING (E) ROOF FROM ASPHALT SHINGLE
- TO METAL ROOF. 8.CONVERTING (E) LIVING AND (E) BEDROOM TO
- (N) MASTER SUITE. 9. CONVERTING (E) DINING AND KITCHEN TO
- 10.CONVERTING (E) LAUNDRY AND BATHROOM AREA TO (N) WET BAR.
- 11.ADDING (N) ELECTRIC FIREPLACE TO GREAT
- <u>APN#</u>: 198-41-030
- **ZONING**: R0 TYPE: VB - SPRINKLED
- OCCUPANCY GROUP: R-3/U SLOPE OF ENTIRE SITE: LEVEL

(E) AREAS

(E) LIVING AREA

#### **AREA CALCULATIONS TABLE**

(E) SF

1290 SF

(2) 21 11 10 7 11 (2) 1	1200 01
(E) LIVING AREA	0 SF
(E) GARAGE	399 SF
(E) SHED	191 SF
(E) COVERED WALKWAY	51 SF
(E) FLOOR AREA	1931 SF
(N) AREAS	(N) SF
(N) LIVING AREA	430 SF
(N) GARAGE	513 SF
(N) FLOOR AREA	2233 SF
(N) FLOOR AREA RATIO	29%
(N) LOT CALCULATIONS	
LAND AREA	7728 SF
LOT COVERAGE AREA	2355 SF
LOT COVERAGE	30%
REQUIRED REAR YARD AREA SF	1990 SI
PROVIDED REAR YARD AREA SF	1561 SF
ONE STORY REAR YARD ENCROACHMENT AREA	428 SF
	720 01
ONE STORY REAR YARD	



**PUBLIC HEARING** 

**APRIL 30TH 2025** 

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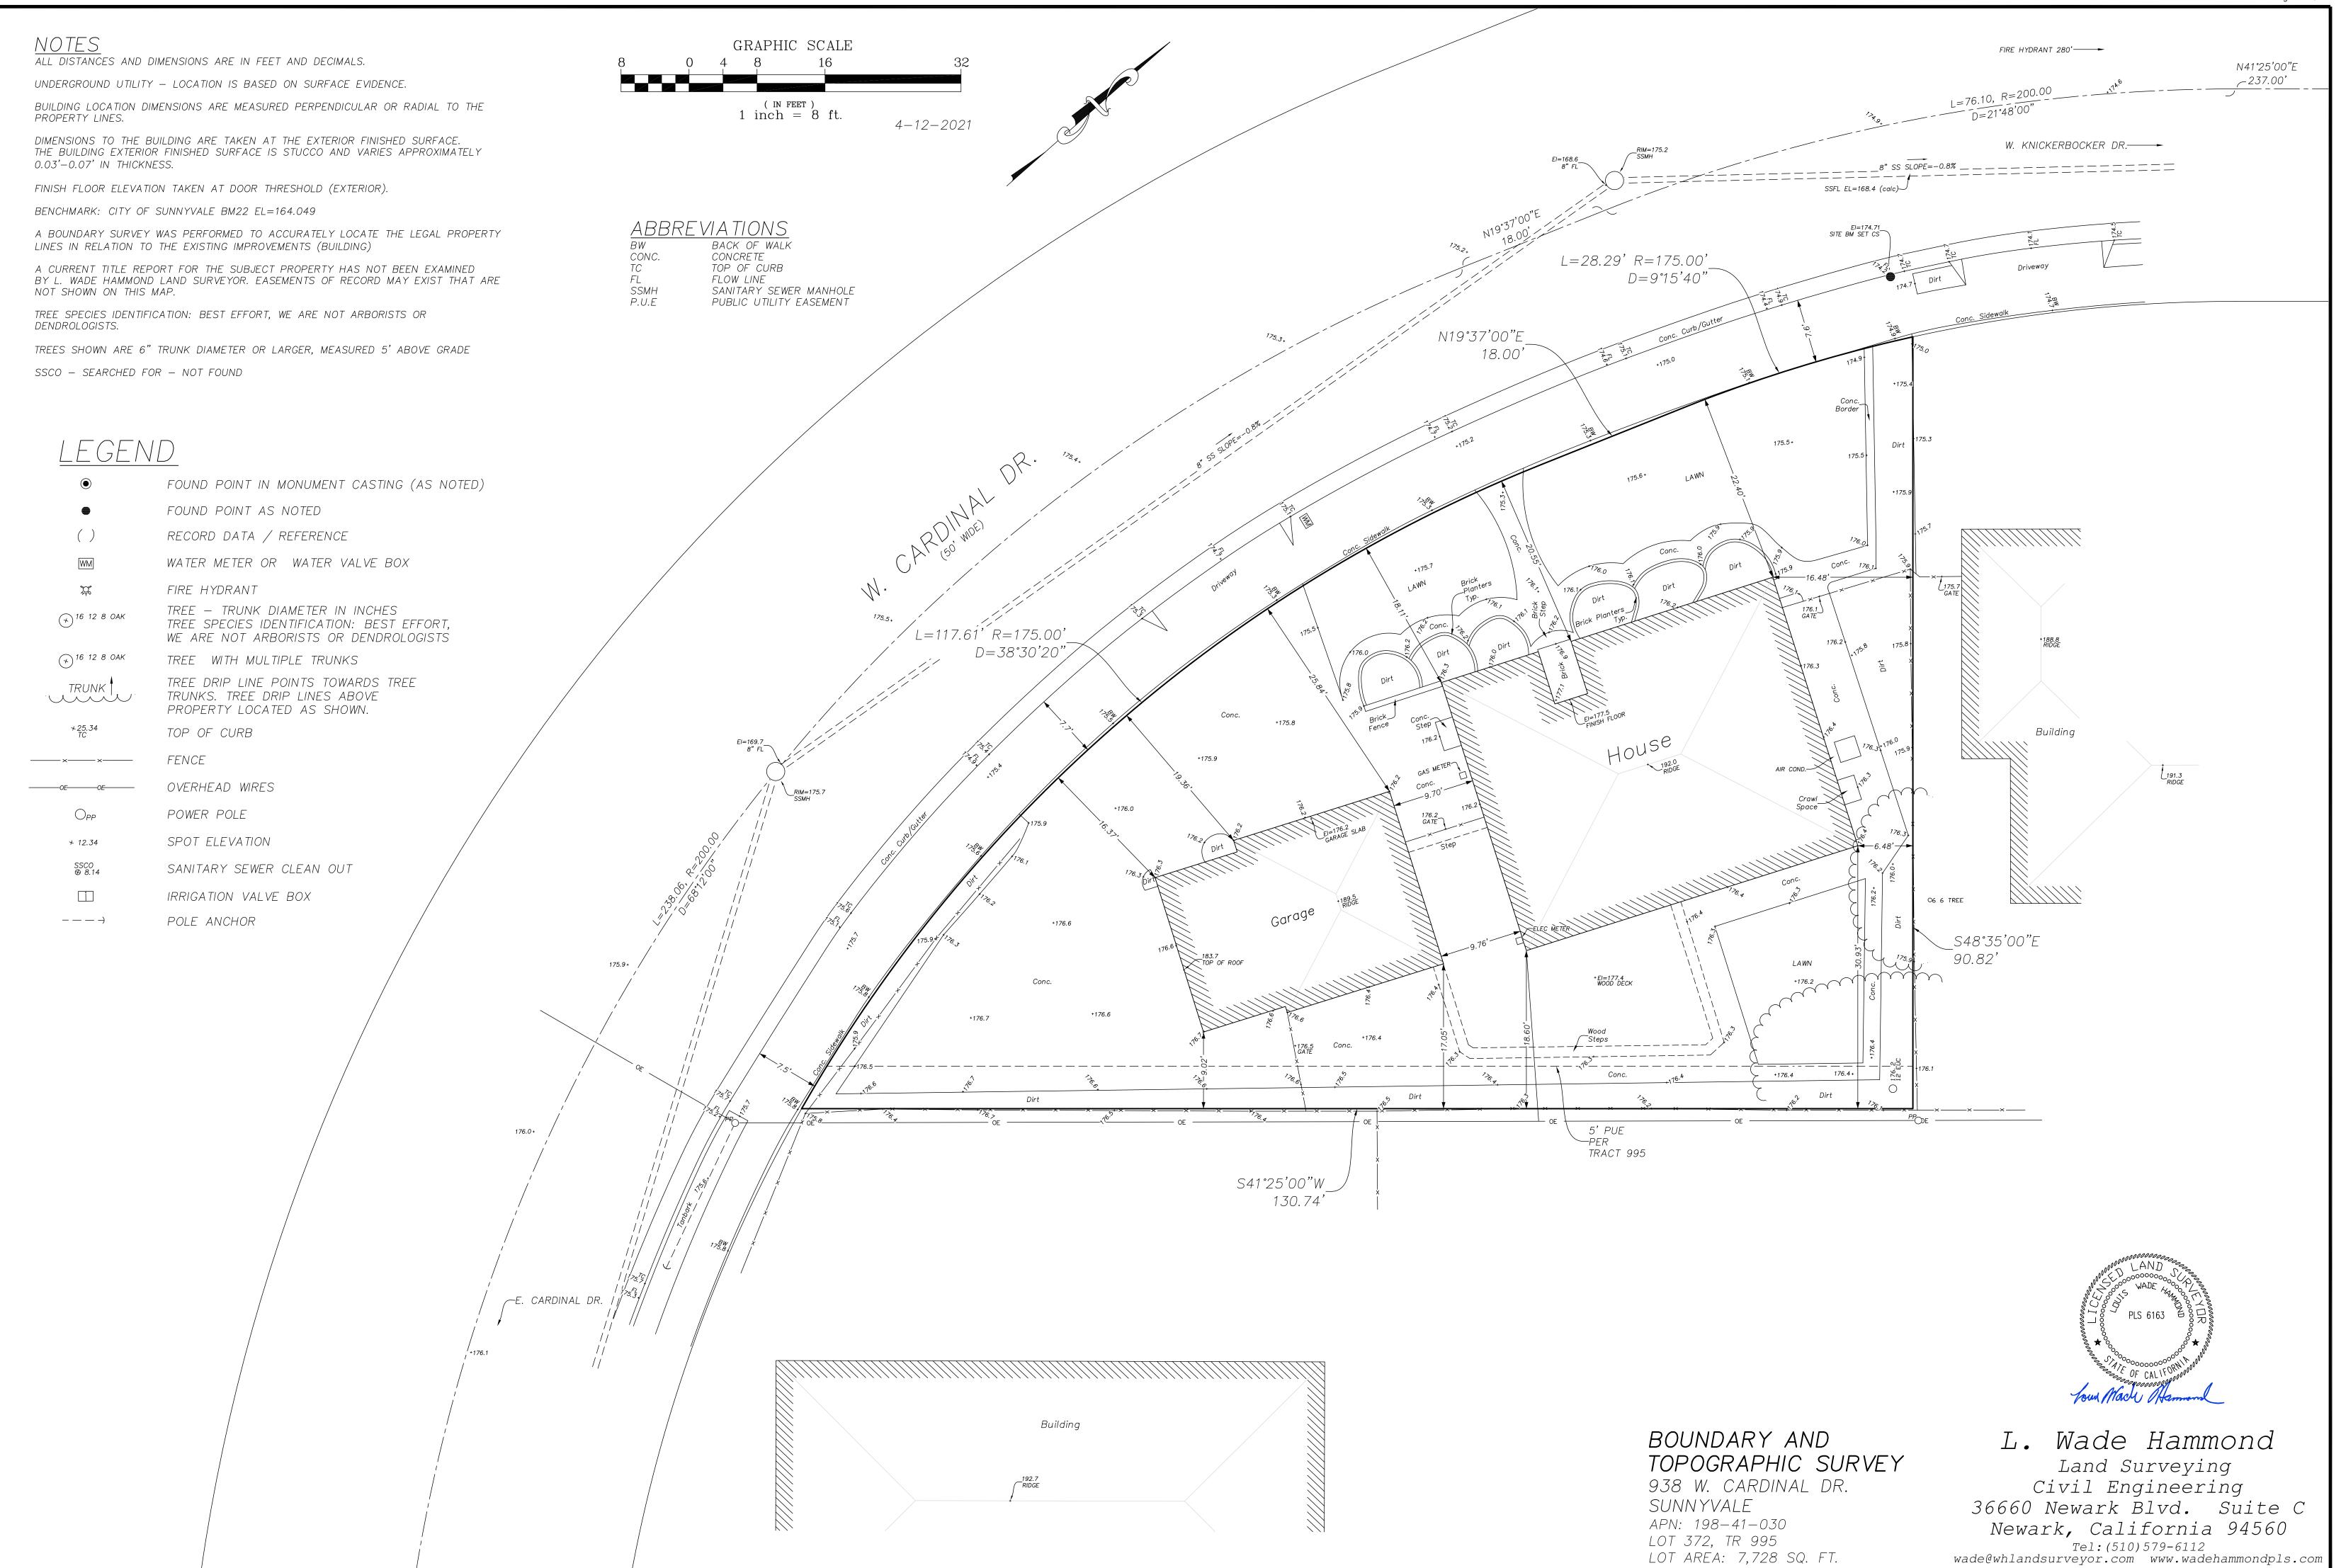
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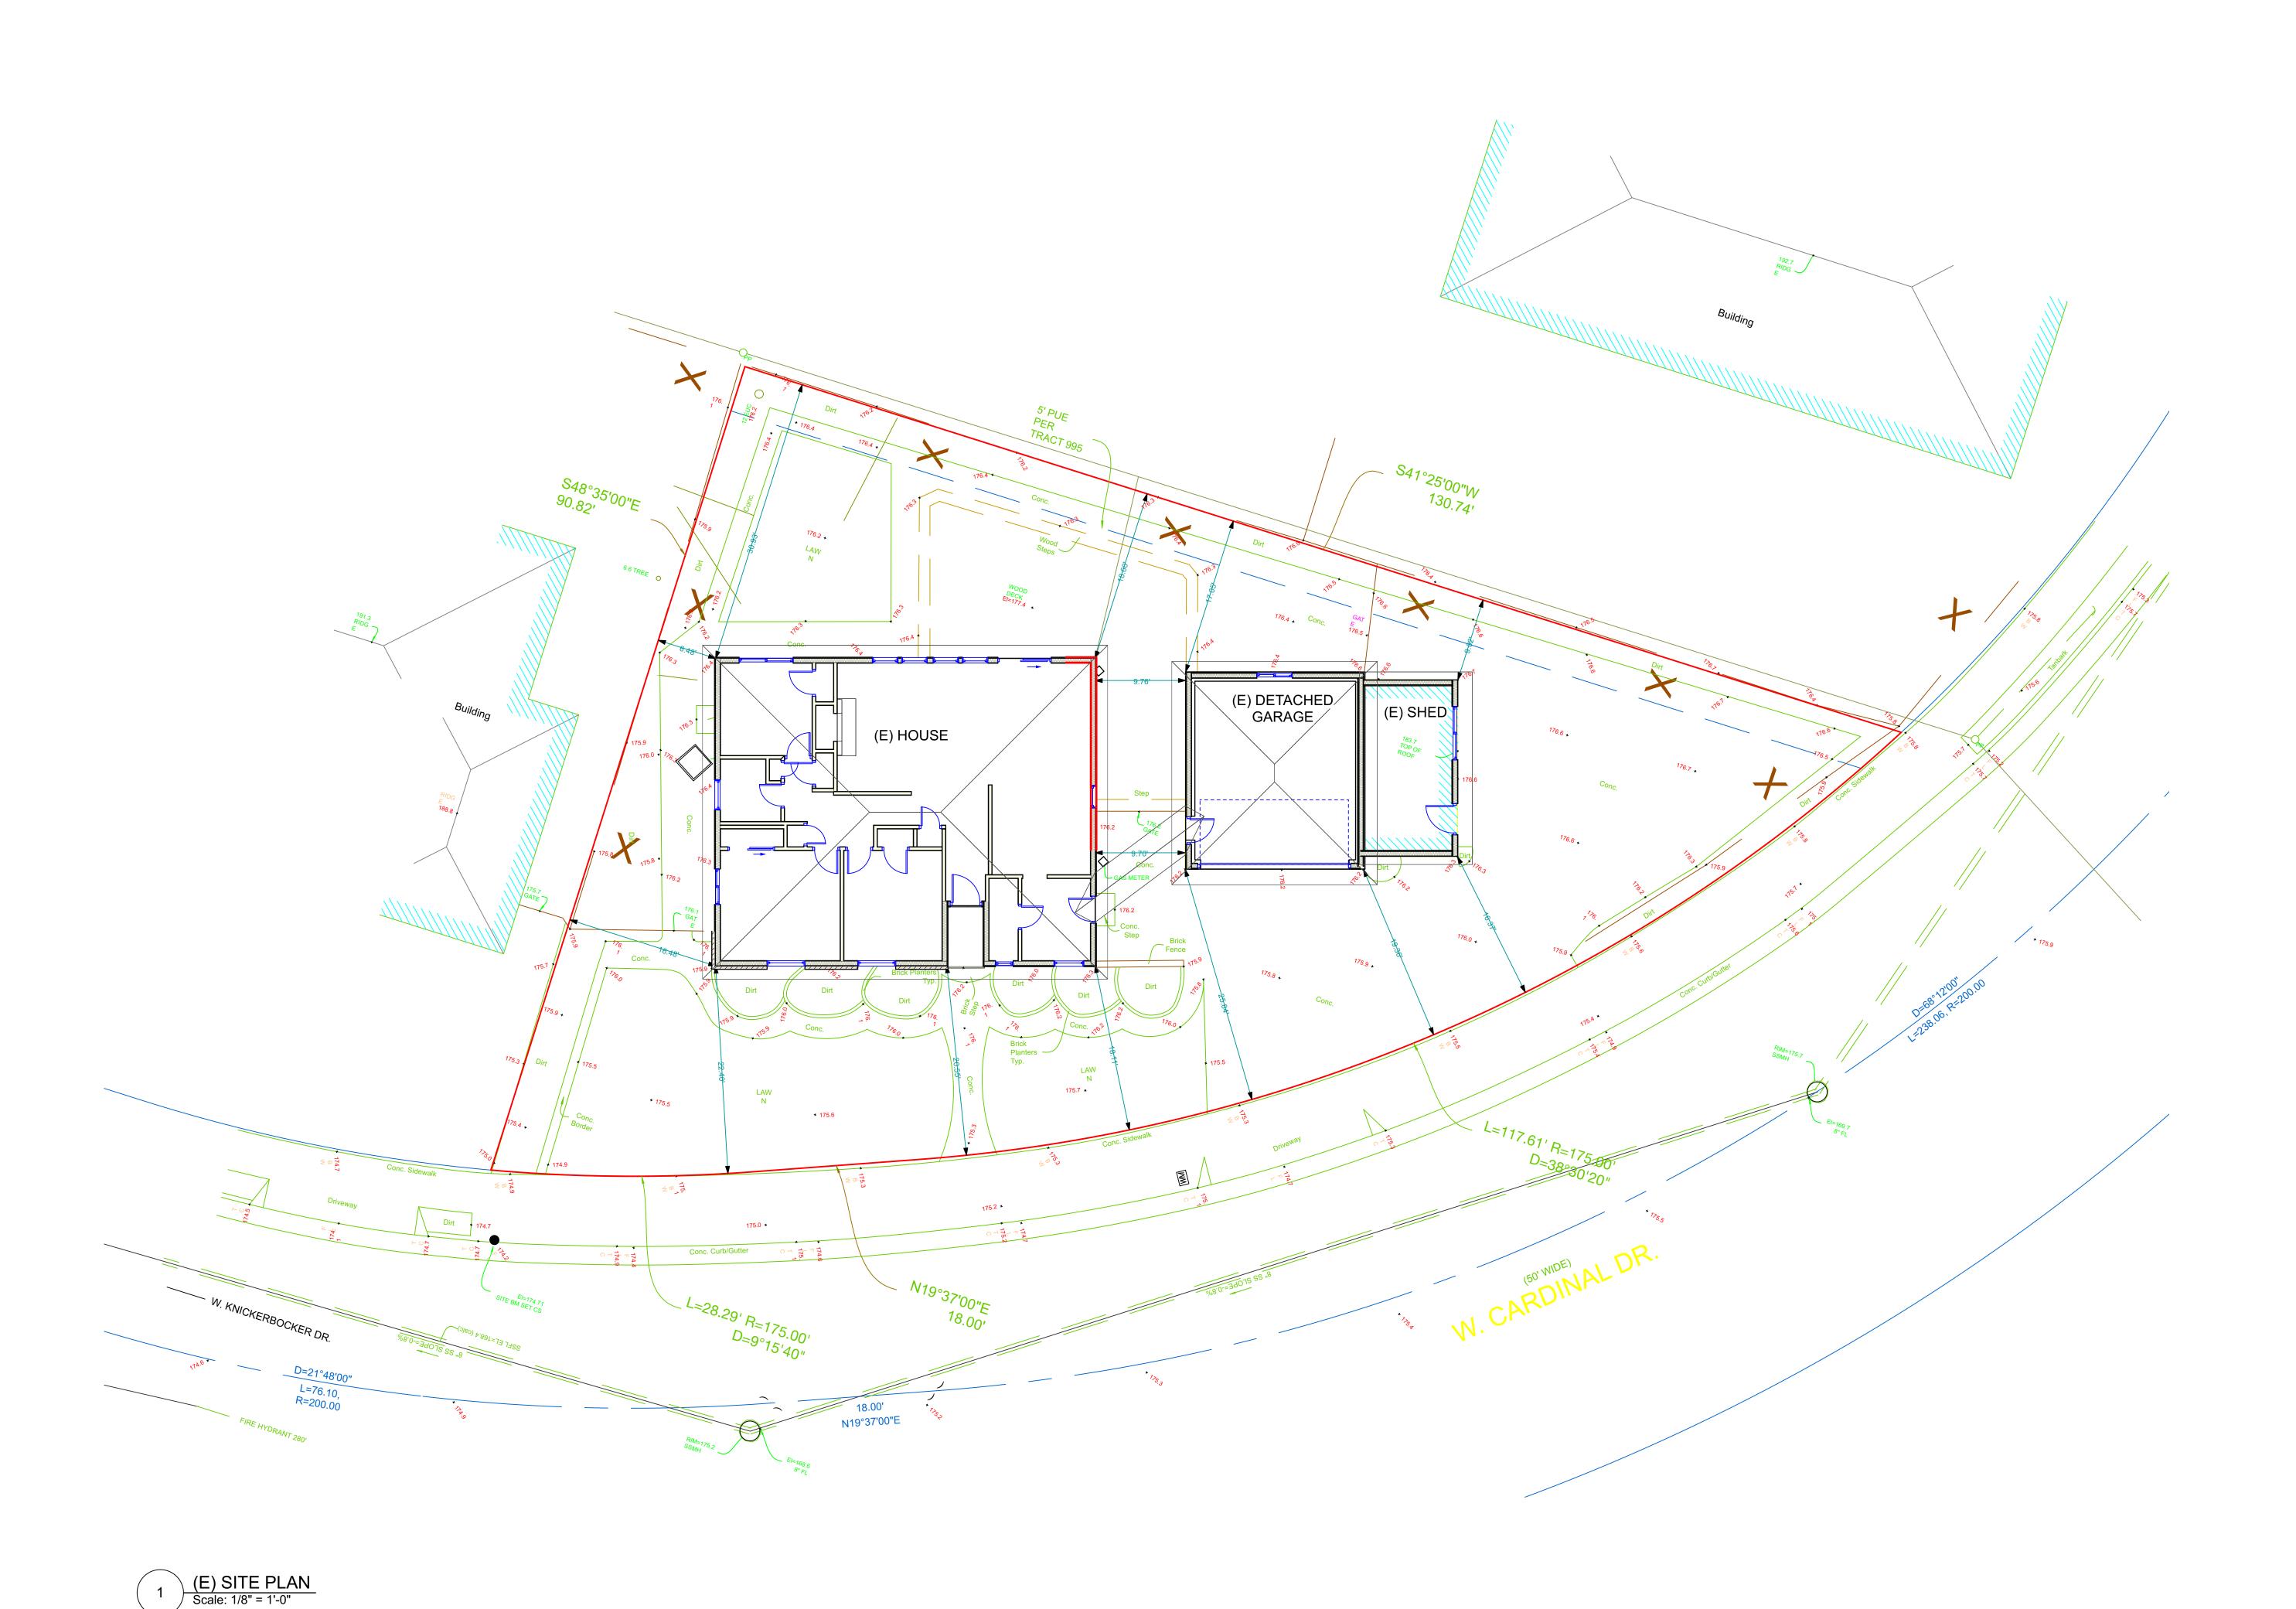
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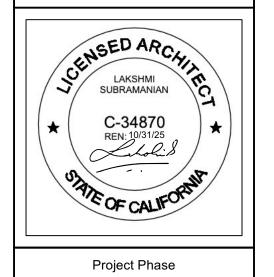
HEARING

**COVER SHEET** 

**Drawing Number** 







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Issue Date APRIL 30TH 2025

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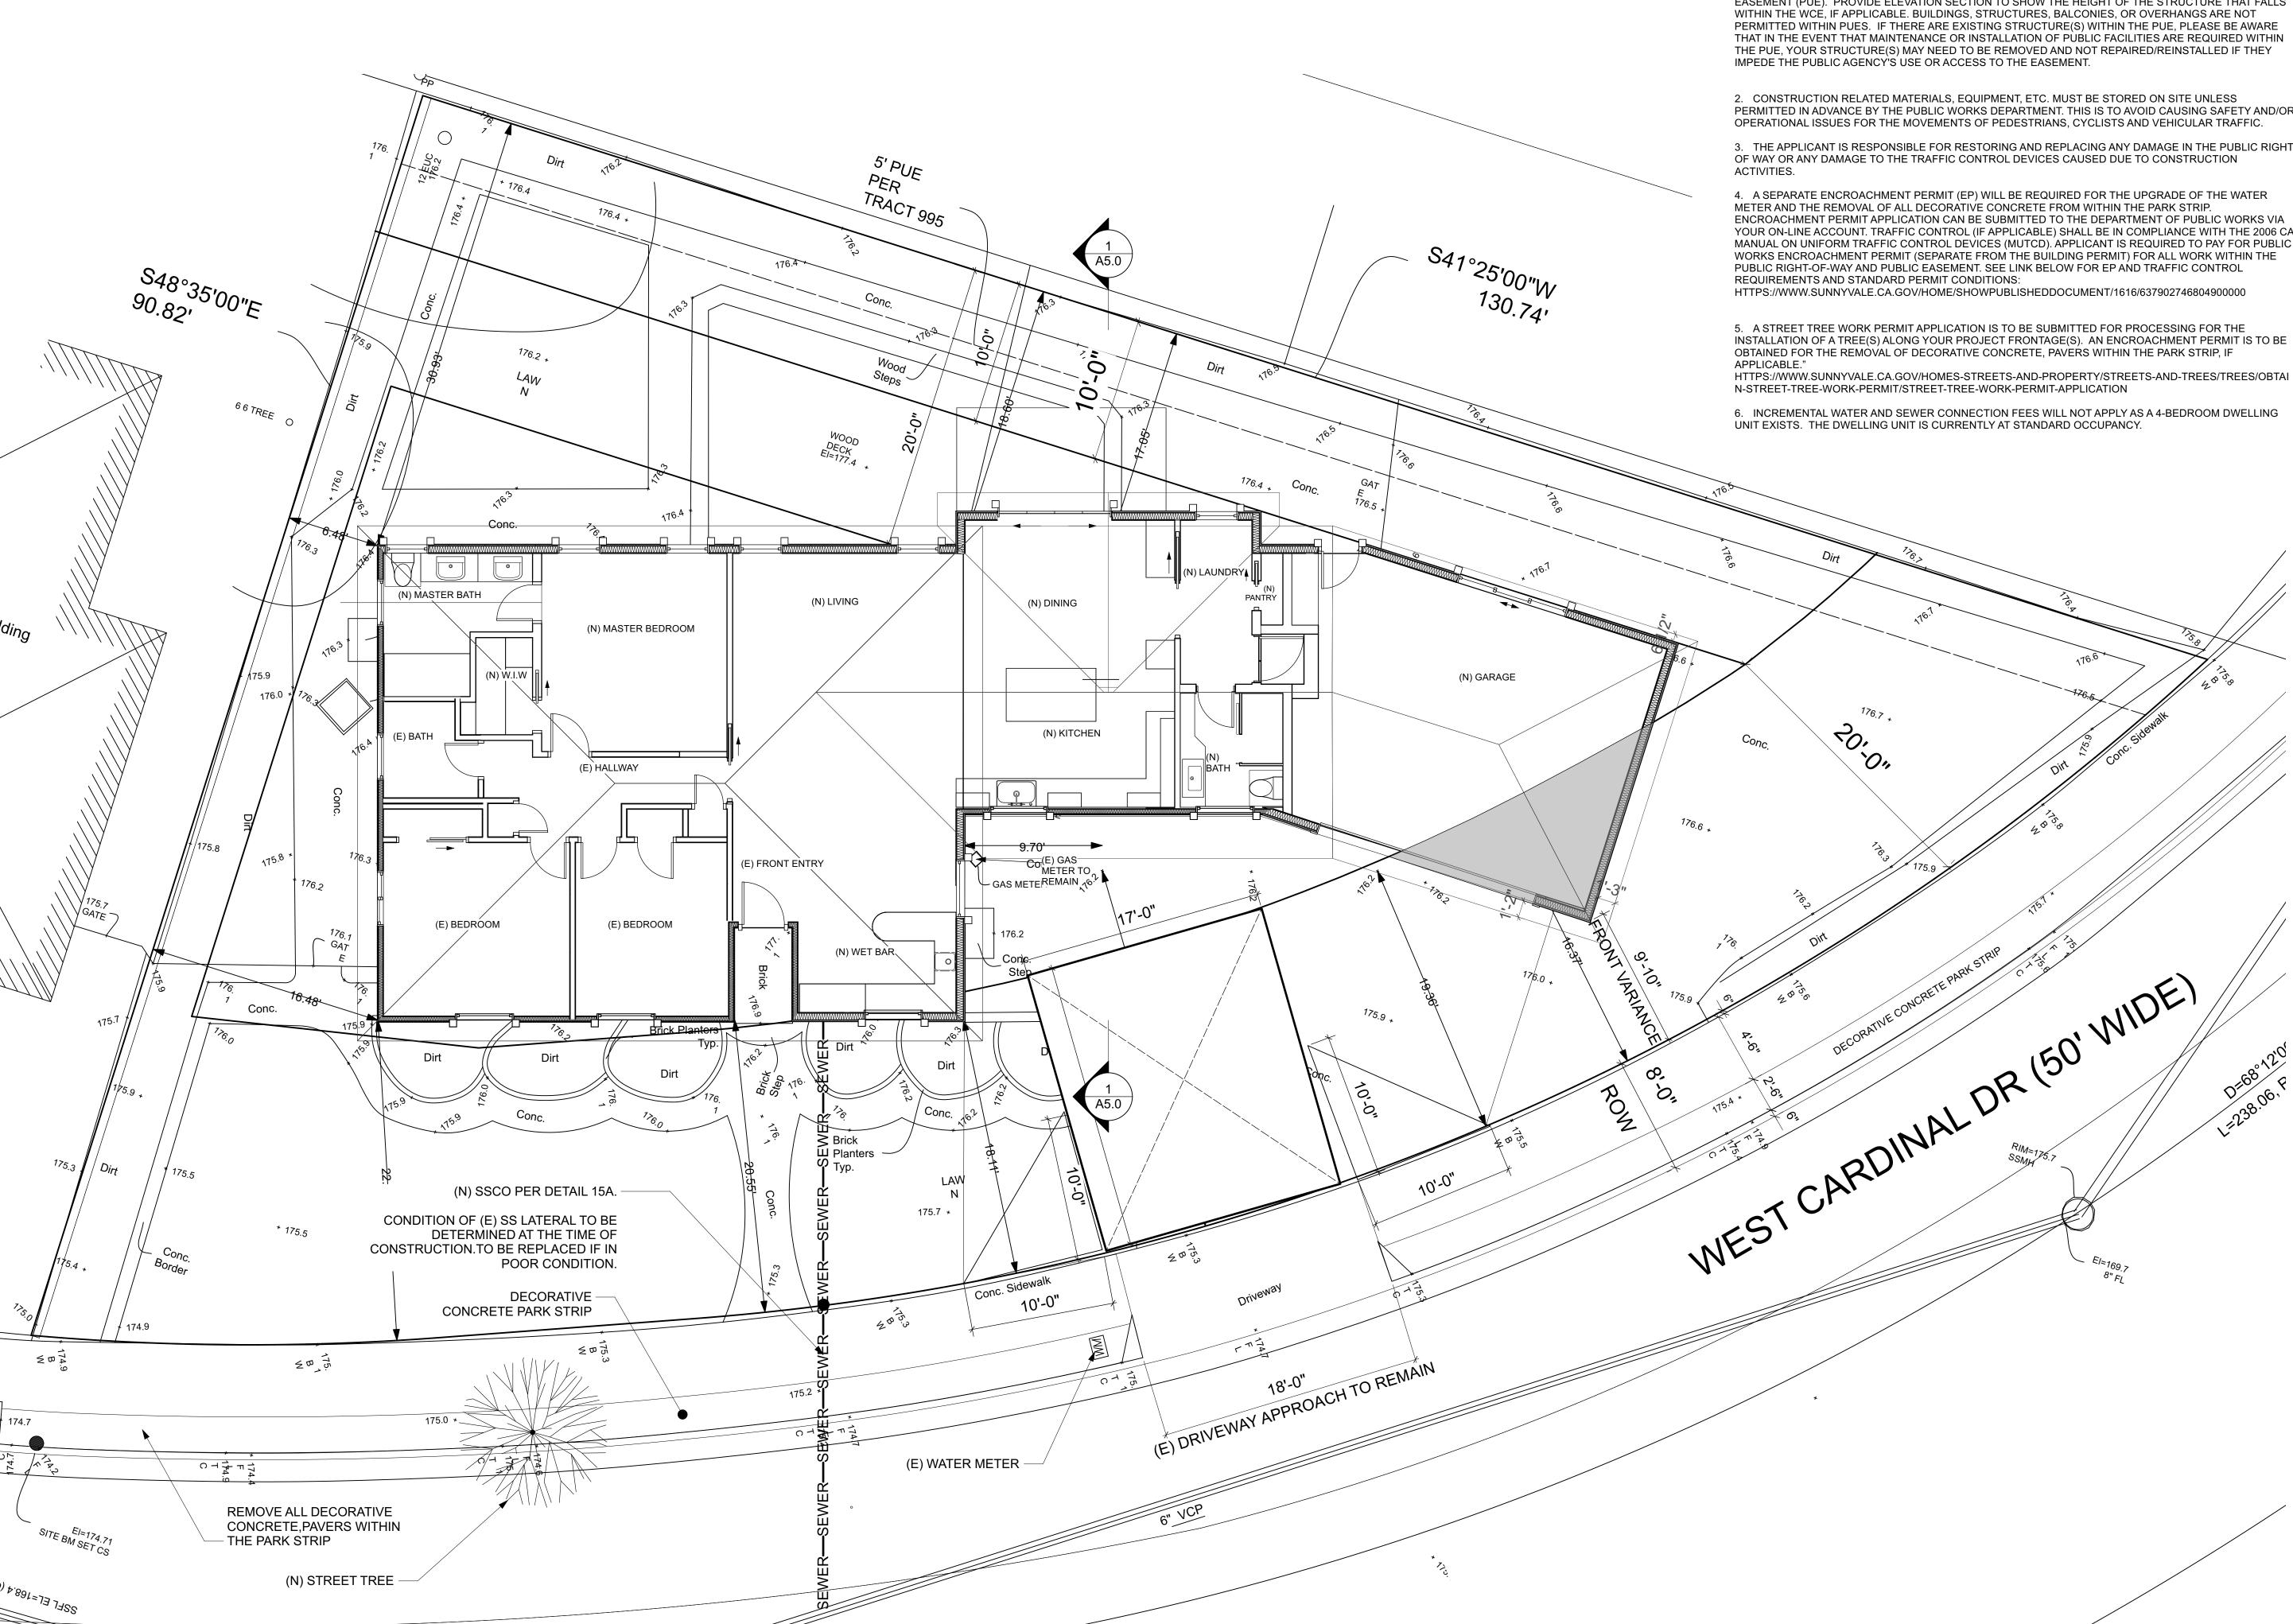
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PUBLIC

938 W CARDINAL DR SUNNYVALE CHING RESIDENCE

(E) SITE PLAN

Drawing Number



(N) SITE PLAN Scale: 3/16" = 1'-0"

**DEPARTMENT OF PUBLIC WORKS NOTES** 

1. THE CONSTRUCTION OF PERMANENT STRUCTURES IS NOT PERMITTED WITHIN THE PUBLIC UTILITY EASEMENT (PUE). PROVIDE ELEVATION SECTION TO SHOW THE HEIGHT OF THE STRUCTURE THAT FALLS PERMITTED WITHIN PUES. IF THERE ARE EXISTING STRUCTURE(S) WITHIN THE PUE, PLEASE BE AWARE THAT IN THE EVENT THAT MAINTENANCE OR INSTALLATION OF PUBLIC FACILITIES ARE REQUIRED WITHIN THE PUE, YOUR STRUCTURE(S) MAY NEED TO BE REMOVED AND NOT REPAIRED/REINSTALLED IF THEY

PERMITTED IN ADVANCE BY THE PUBLIC WORKS DEPARTMENT. THIS IS TO AVOID CAUSING SAFETY AND/OR

3. THE APPLICANT IS RESPONSIBLE FOR RESTORING AND REPLACING ANY DAMAGE IN THE PUBLIC RIGHT

ENCROACHMENT PERMIT APPLICATION CAN BE SUBMITTED TO THE DEPARTMENT OF PUBLIC WORKS VIA YOUR ON-LINE ACCOUNT. TRAFFIC CONTROL (IF APPLICABLE) SHALL BE IN COMPLIANCE WITH THE 2006 CA MANUAL ON UNIFORM TRAFFIC CONTROL DEVICES (MUTCD). APPLICANT IS REQUIRED TO PAY FOR PUBLIC

INSTALLATION OF A TREE(S) ALONG YOUR PROJECT FRONTAGE(S). AN ENCROACHMENT PERMIT IS TO BE

AV 070  $\bigcirc$ 



Project Phase **PUBLIC HEARING** 

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PUBLIC 04/30/25 **HEARING** 

CHING RESIDENCE

W CARDINAL SUNNYVALE 938


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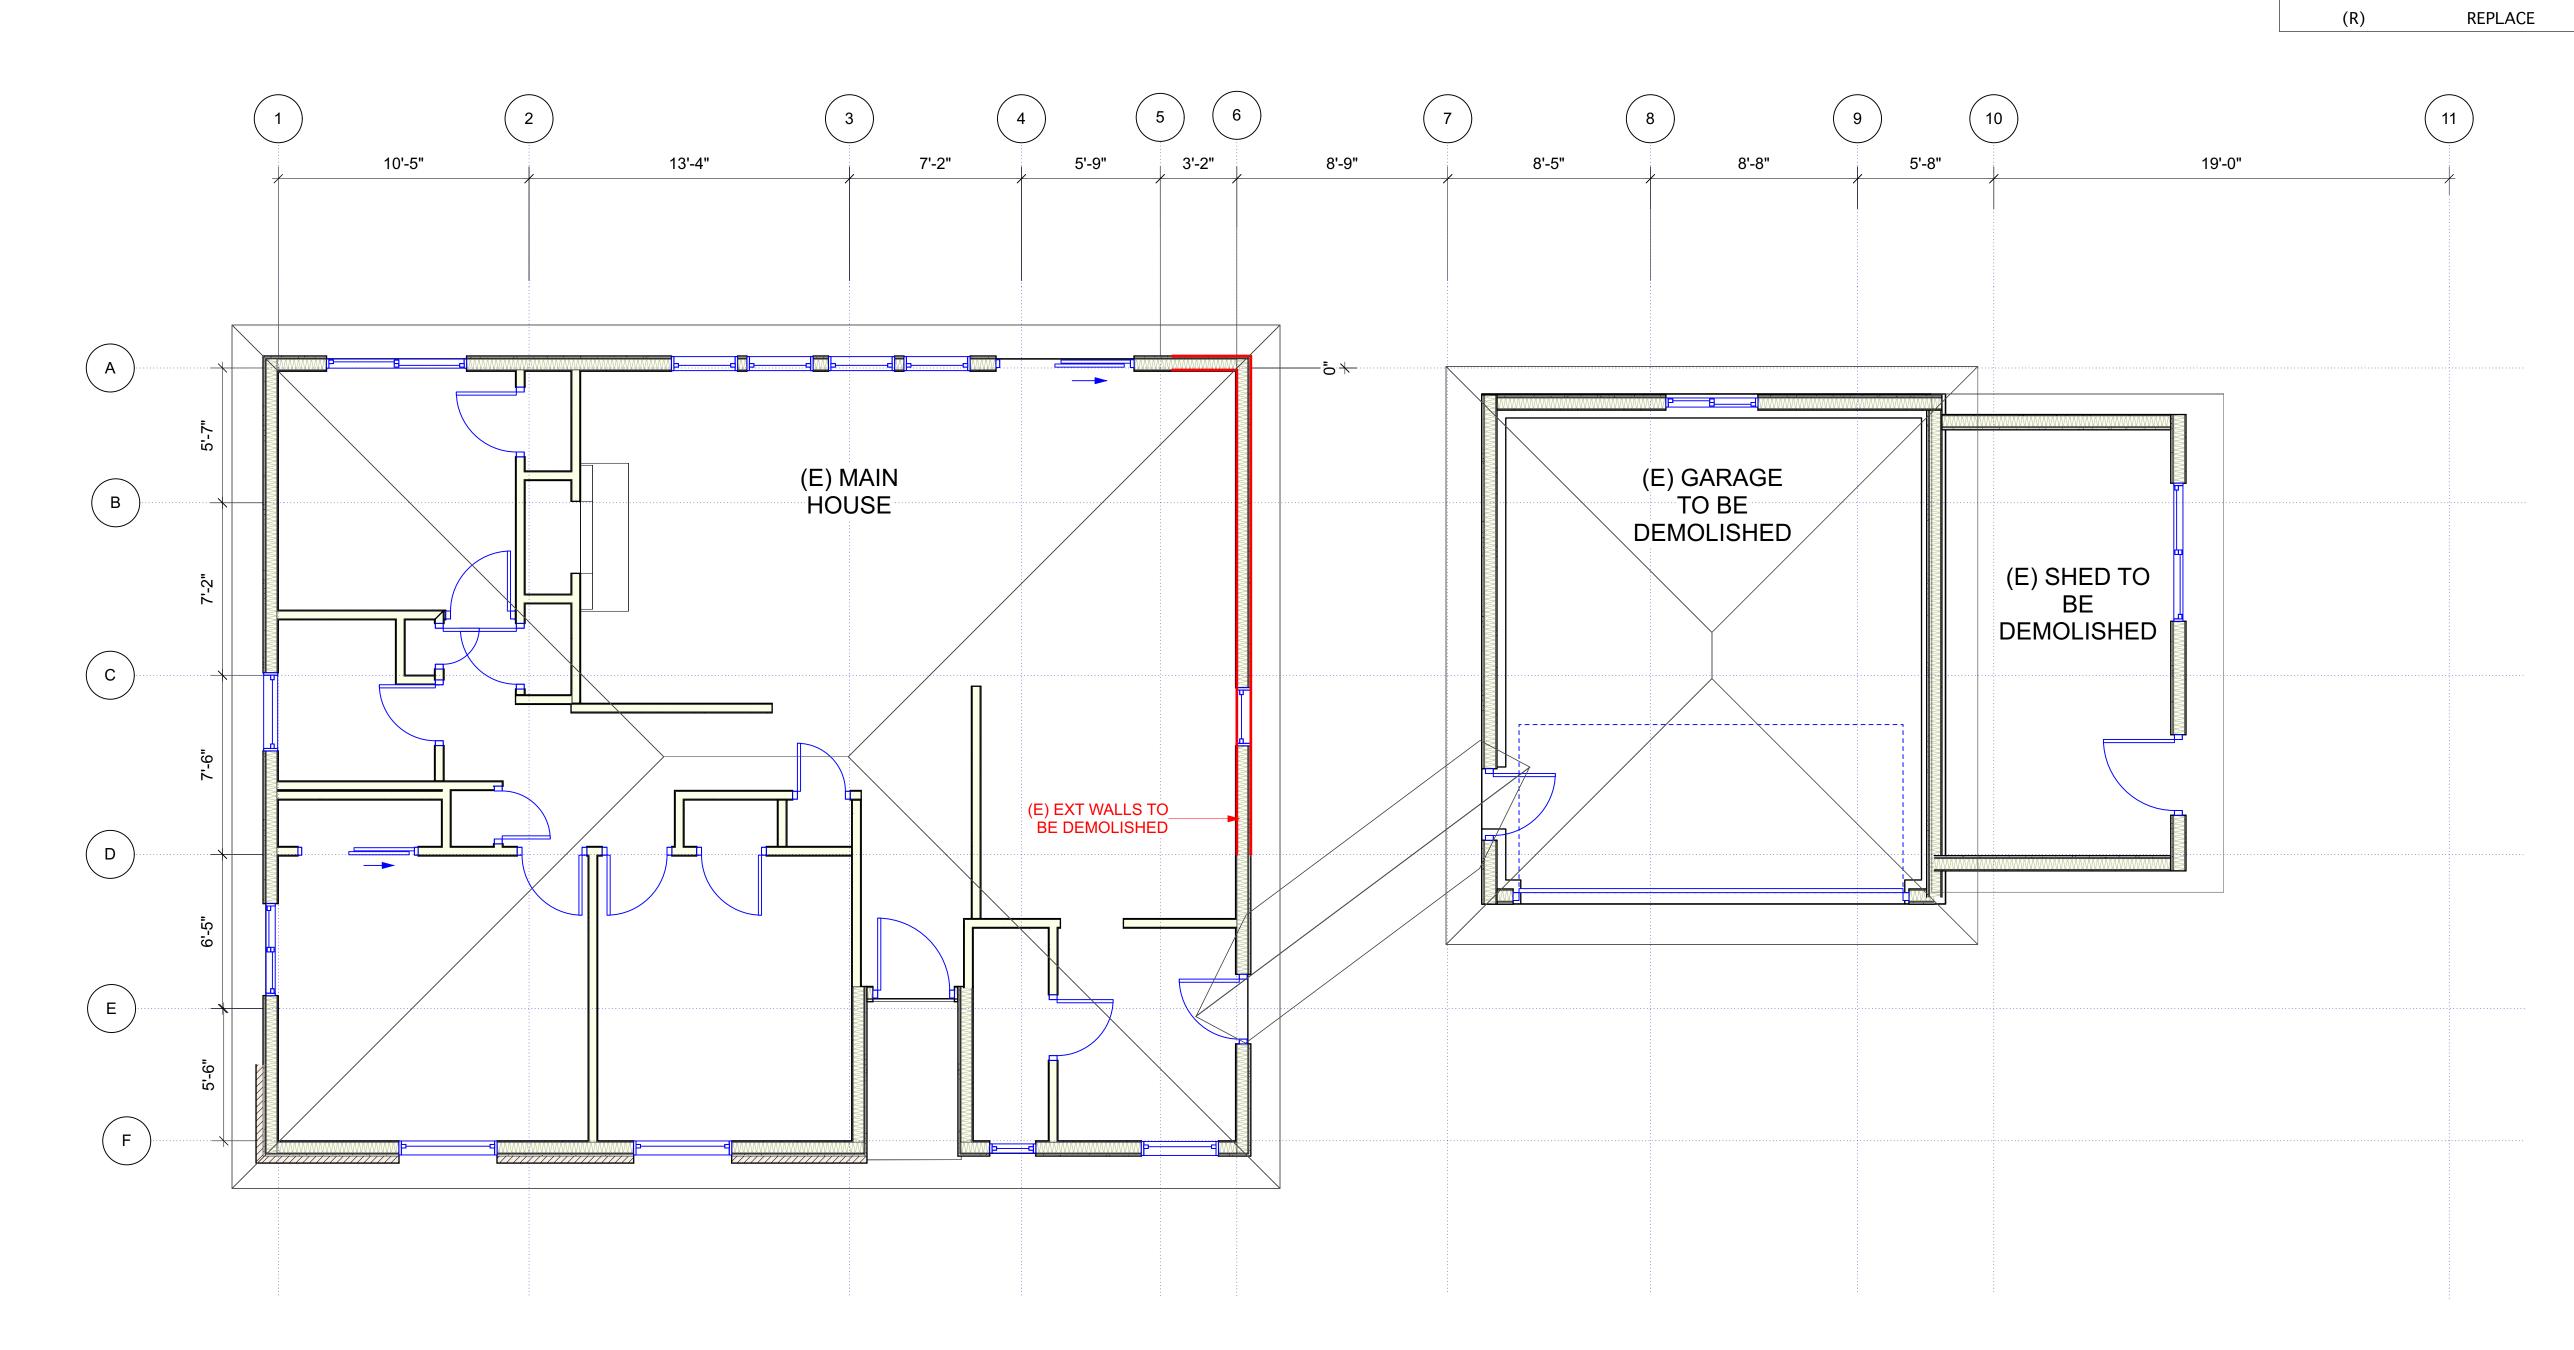
**Drawing Number** 

(E) PERMITER OF MAIN HOUSE: 160'-10"

PROPOSED DEMO PERIMETER: 34'-0"

% OF WALLS TO BE DEMO'D: 21.25%



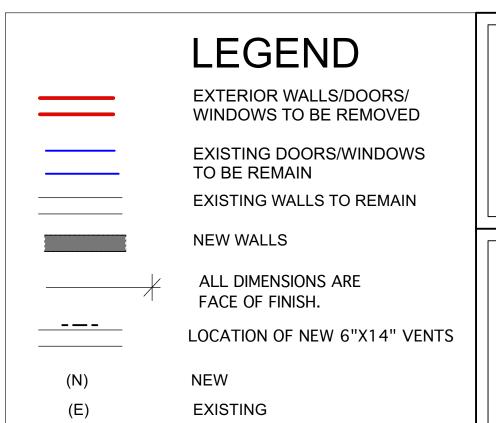

(E) FLOOR PLAN

Scale: 1/4" = 1'-0"

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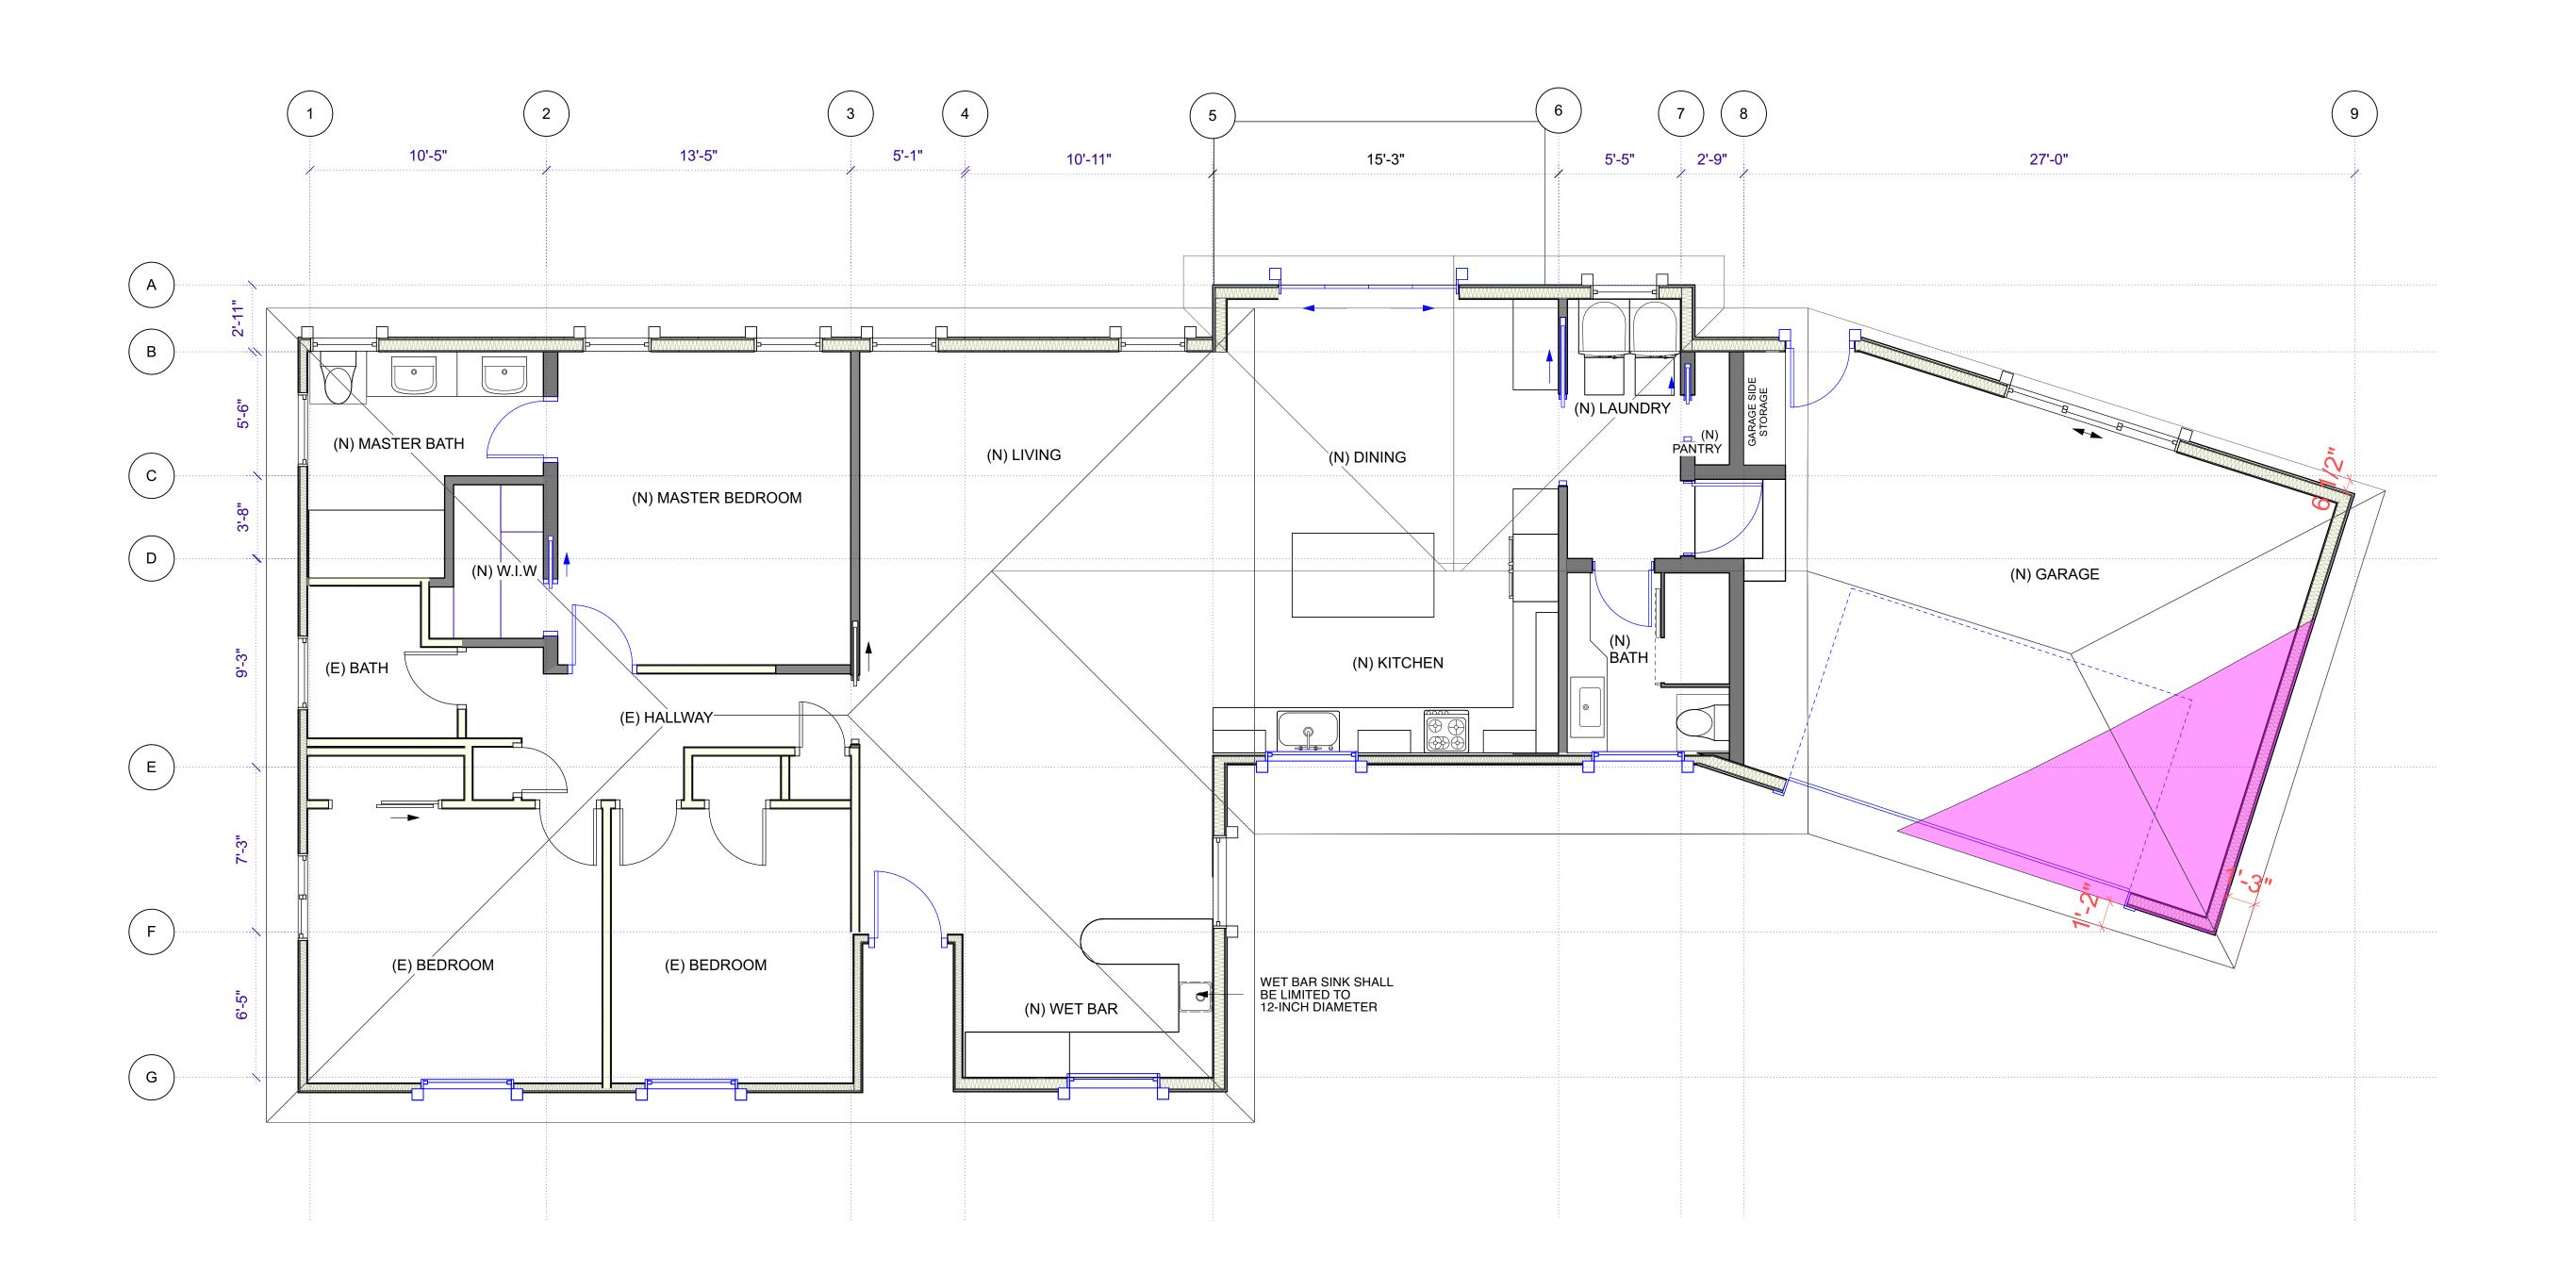
HEARING

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SUNNYVALE


(E) FLOOR PLAN

Prawing Number

A2.0



AN APPROVED AUTOMATIC FIRE SPRINKLER SYSTEM DESIGNED AND INSTALLED IN ACCORDANCE WITH NFPA 13D IS REQUIRED PER SMC 16.17.080 R313.2

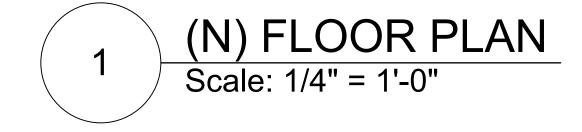

NOTE: 5' PUE ALONG THE EASTERLY PROPERTY LINE. MAINTAIN THIS EASEMENT AT ALL TIMES.

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(N) FLOOR PLAN

Prawing Number



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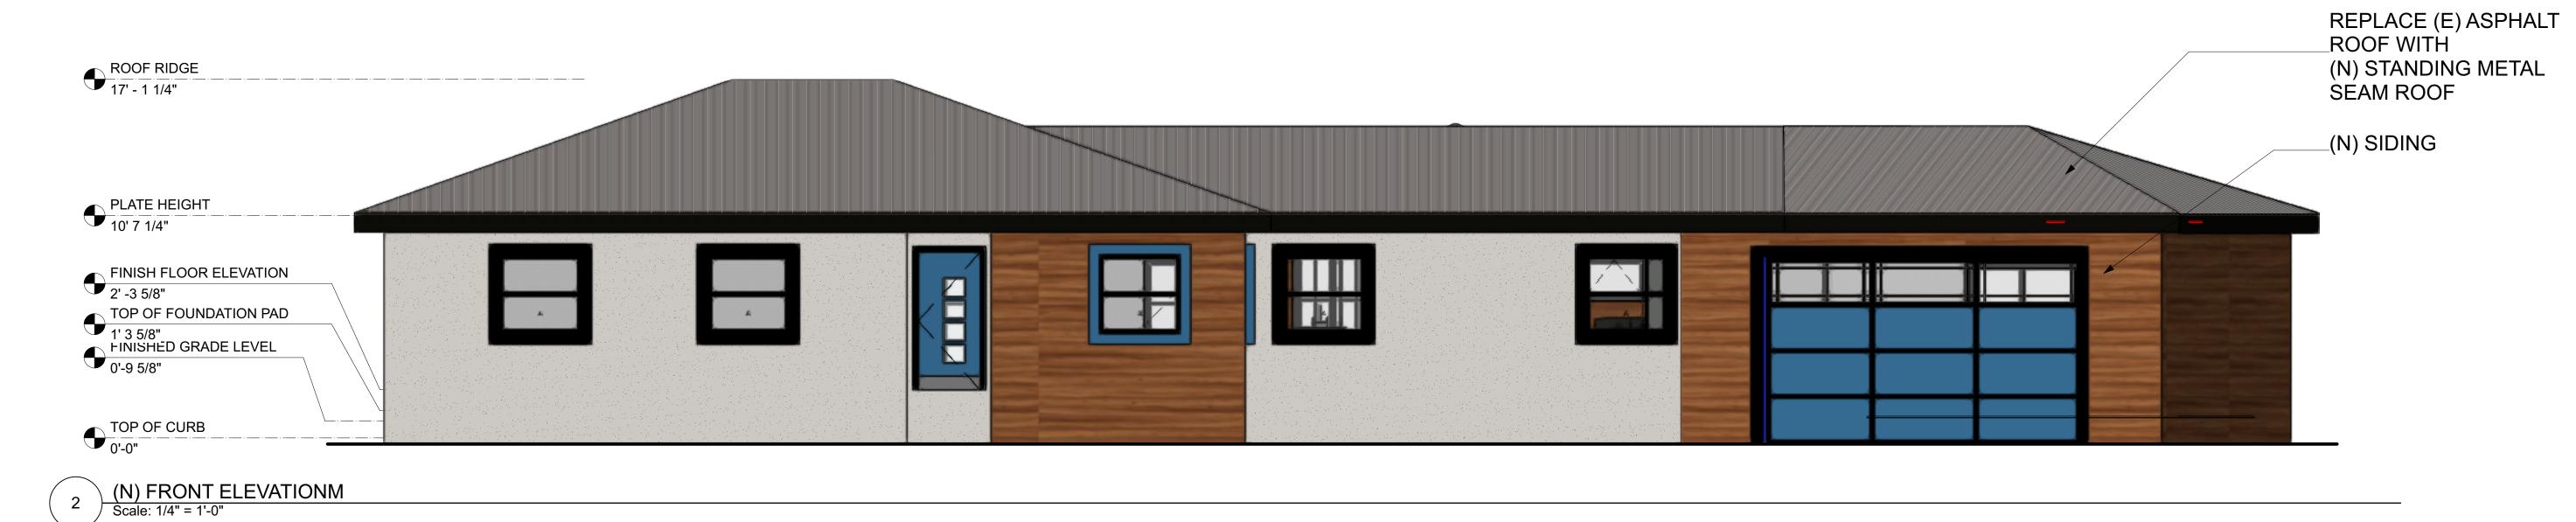
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CHING RESIDENCE
338 W CARDINAL DR

(E) ELEVATIONS

Prawing Number

A3.0




(N) RIGHT ELEVATION
Soul: 14" = 1-2"

(N) RIGHT ELEVATION
Soul: 14" = 1-2"



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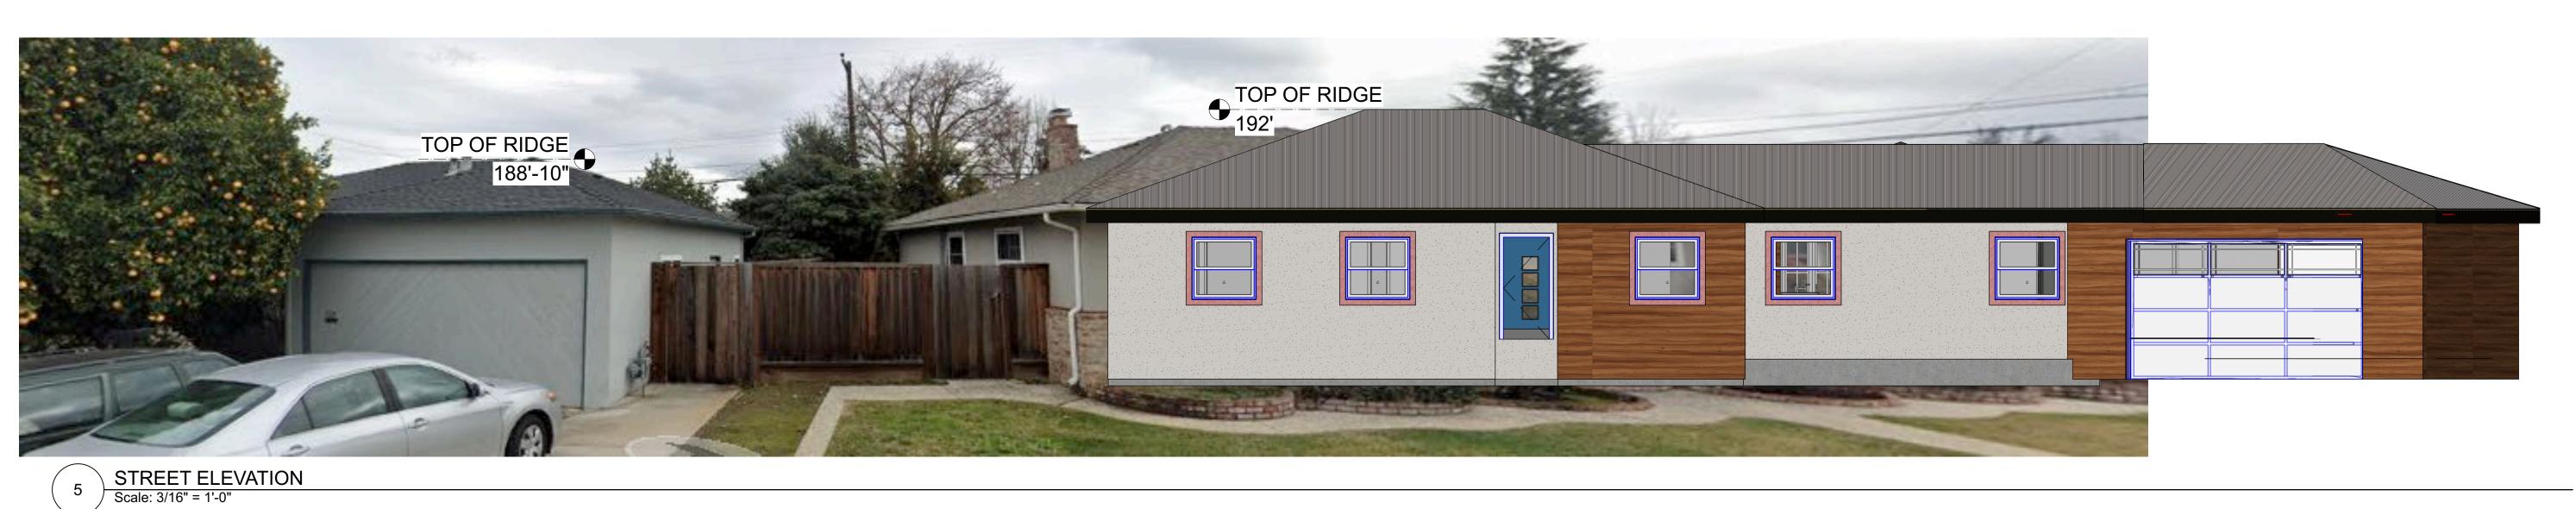
04/30/25 PUBLIC
HEARING


CHING RESIDENCE
938 W CARDINAL DR
SUNNYVALE

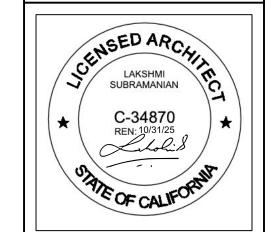(N) ELEVATIONS

Prawing Number

A3.1



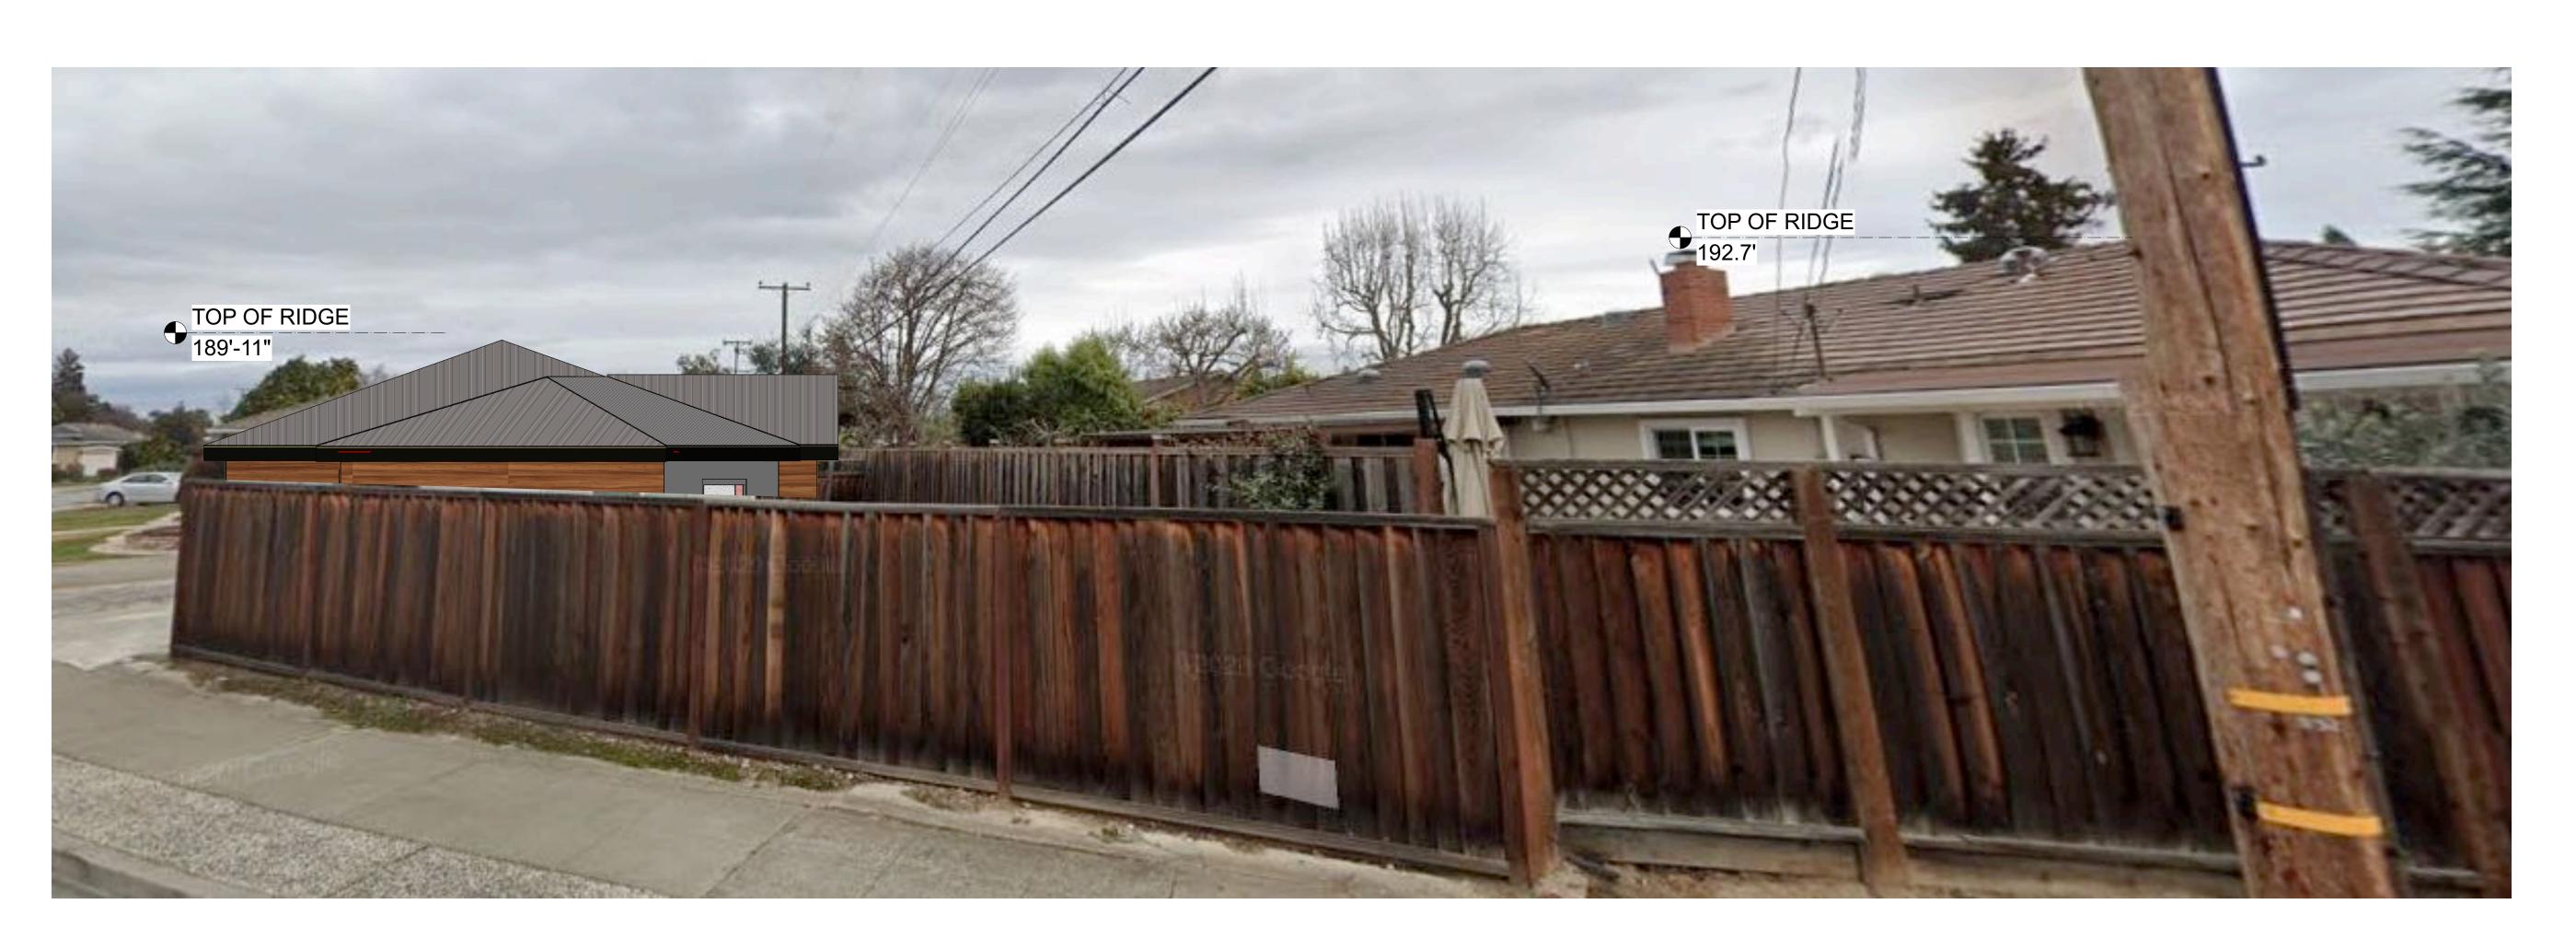

1 CORNER STREET ELEVATION
Scale: 3/16" = 1'-0"

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Lean Lens Architect
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## Project Phase PUBLIC HEARING

APRIL 30TH 2025

File Name
W CARDINAL 04302025 .vwx

5/29/24 PCC 1

11/12/24 PCC 2

21/02/25 PCC 3

04/30/25 PUBLIC


HEARING

CHING RESIDENCE
938 W CARDINAL DR
SUNNYVALE

STREET ELEVATION

Prawing Number

A3.2

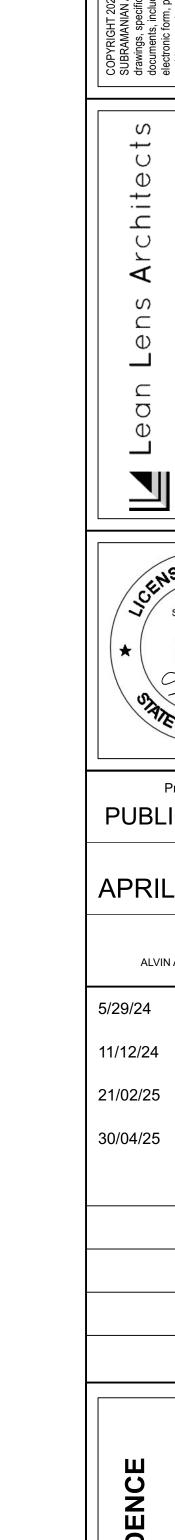

Project Phase **PUBLIC HEARING** 

Issue Date APRIL 30TH 2025

> File Name ALVIN ASBUILT FINAL.vwx

> > PCC 1


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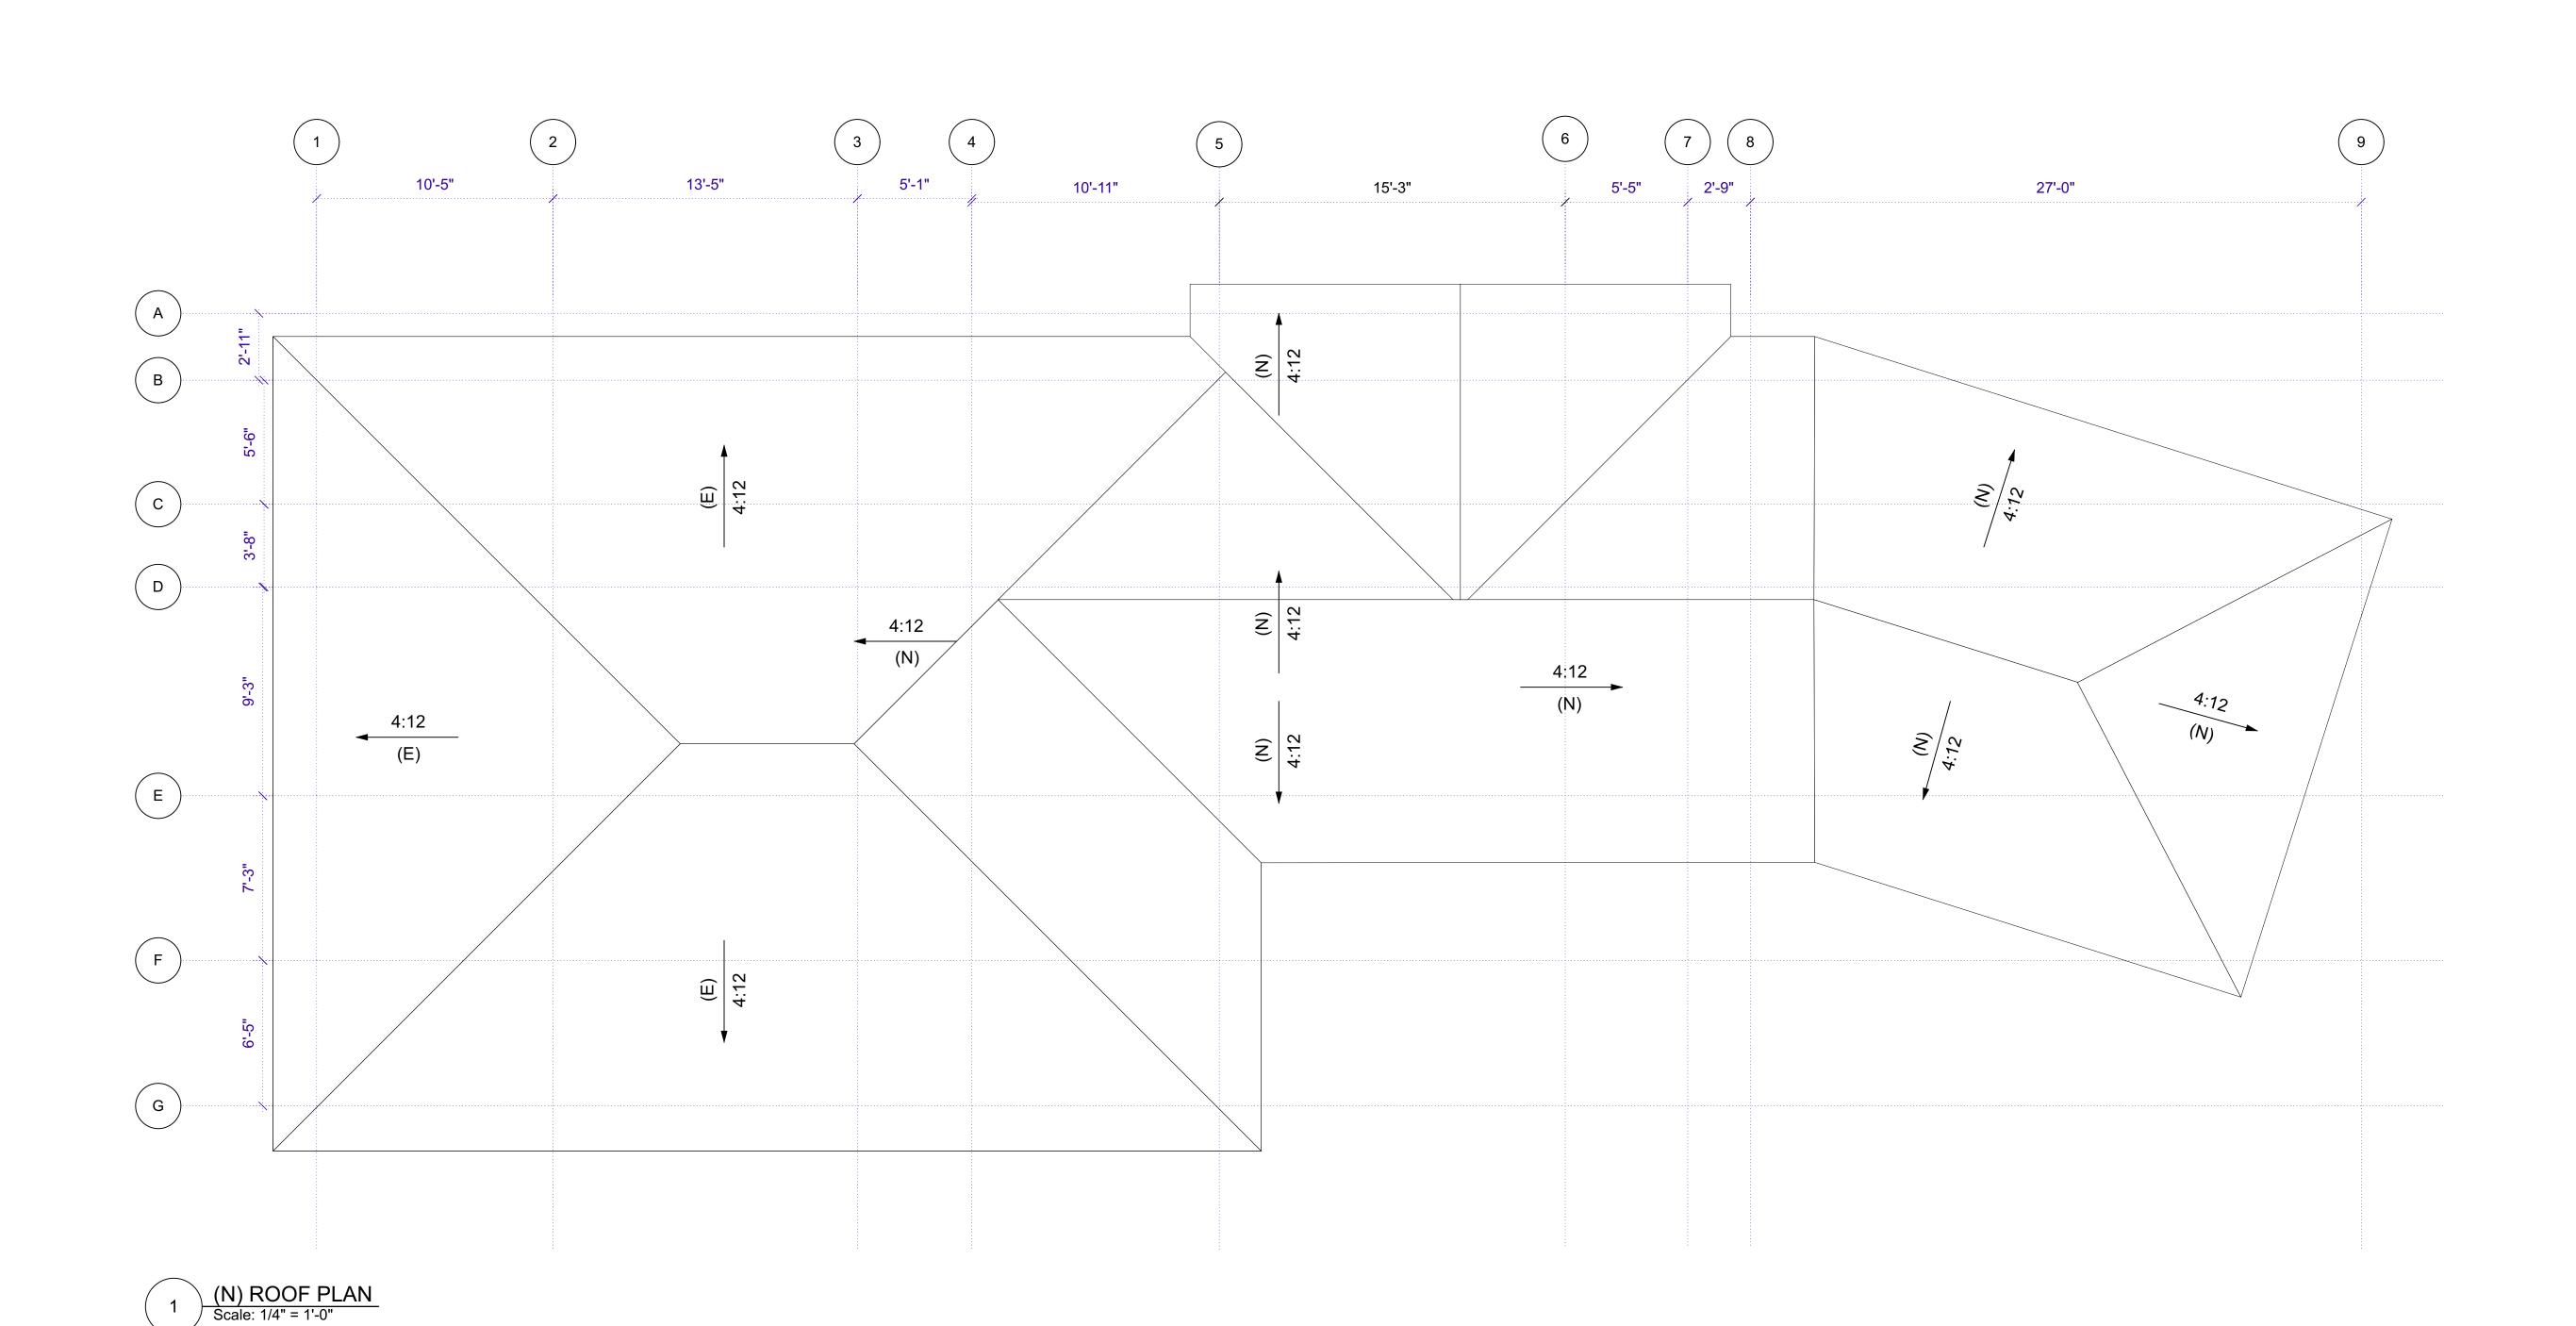
PUBLIC HEARING

938 W CARDINAL DR SUNNYVALE CHING RESIDENCE

(E) ROOF PLAN


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Project Phase
PUBLIC HEARING

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File Name
W CARDINAL 04302025 .vwx

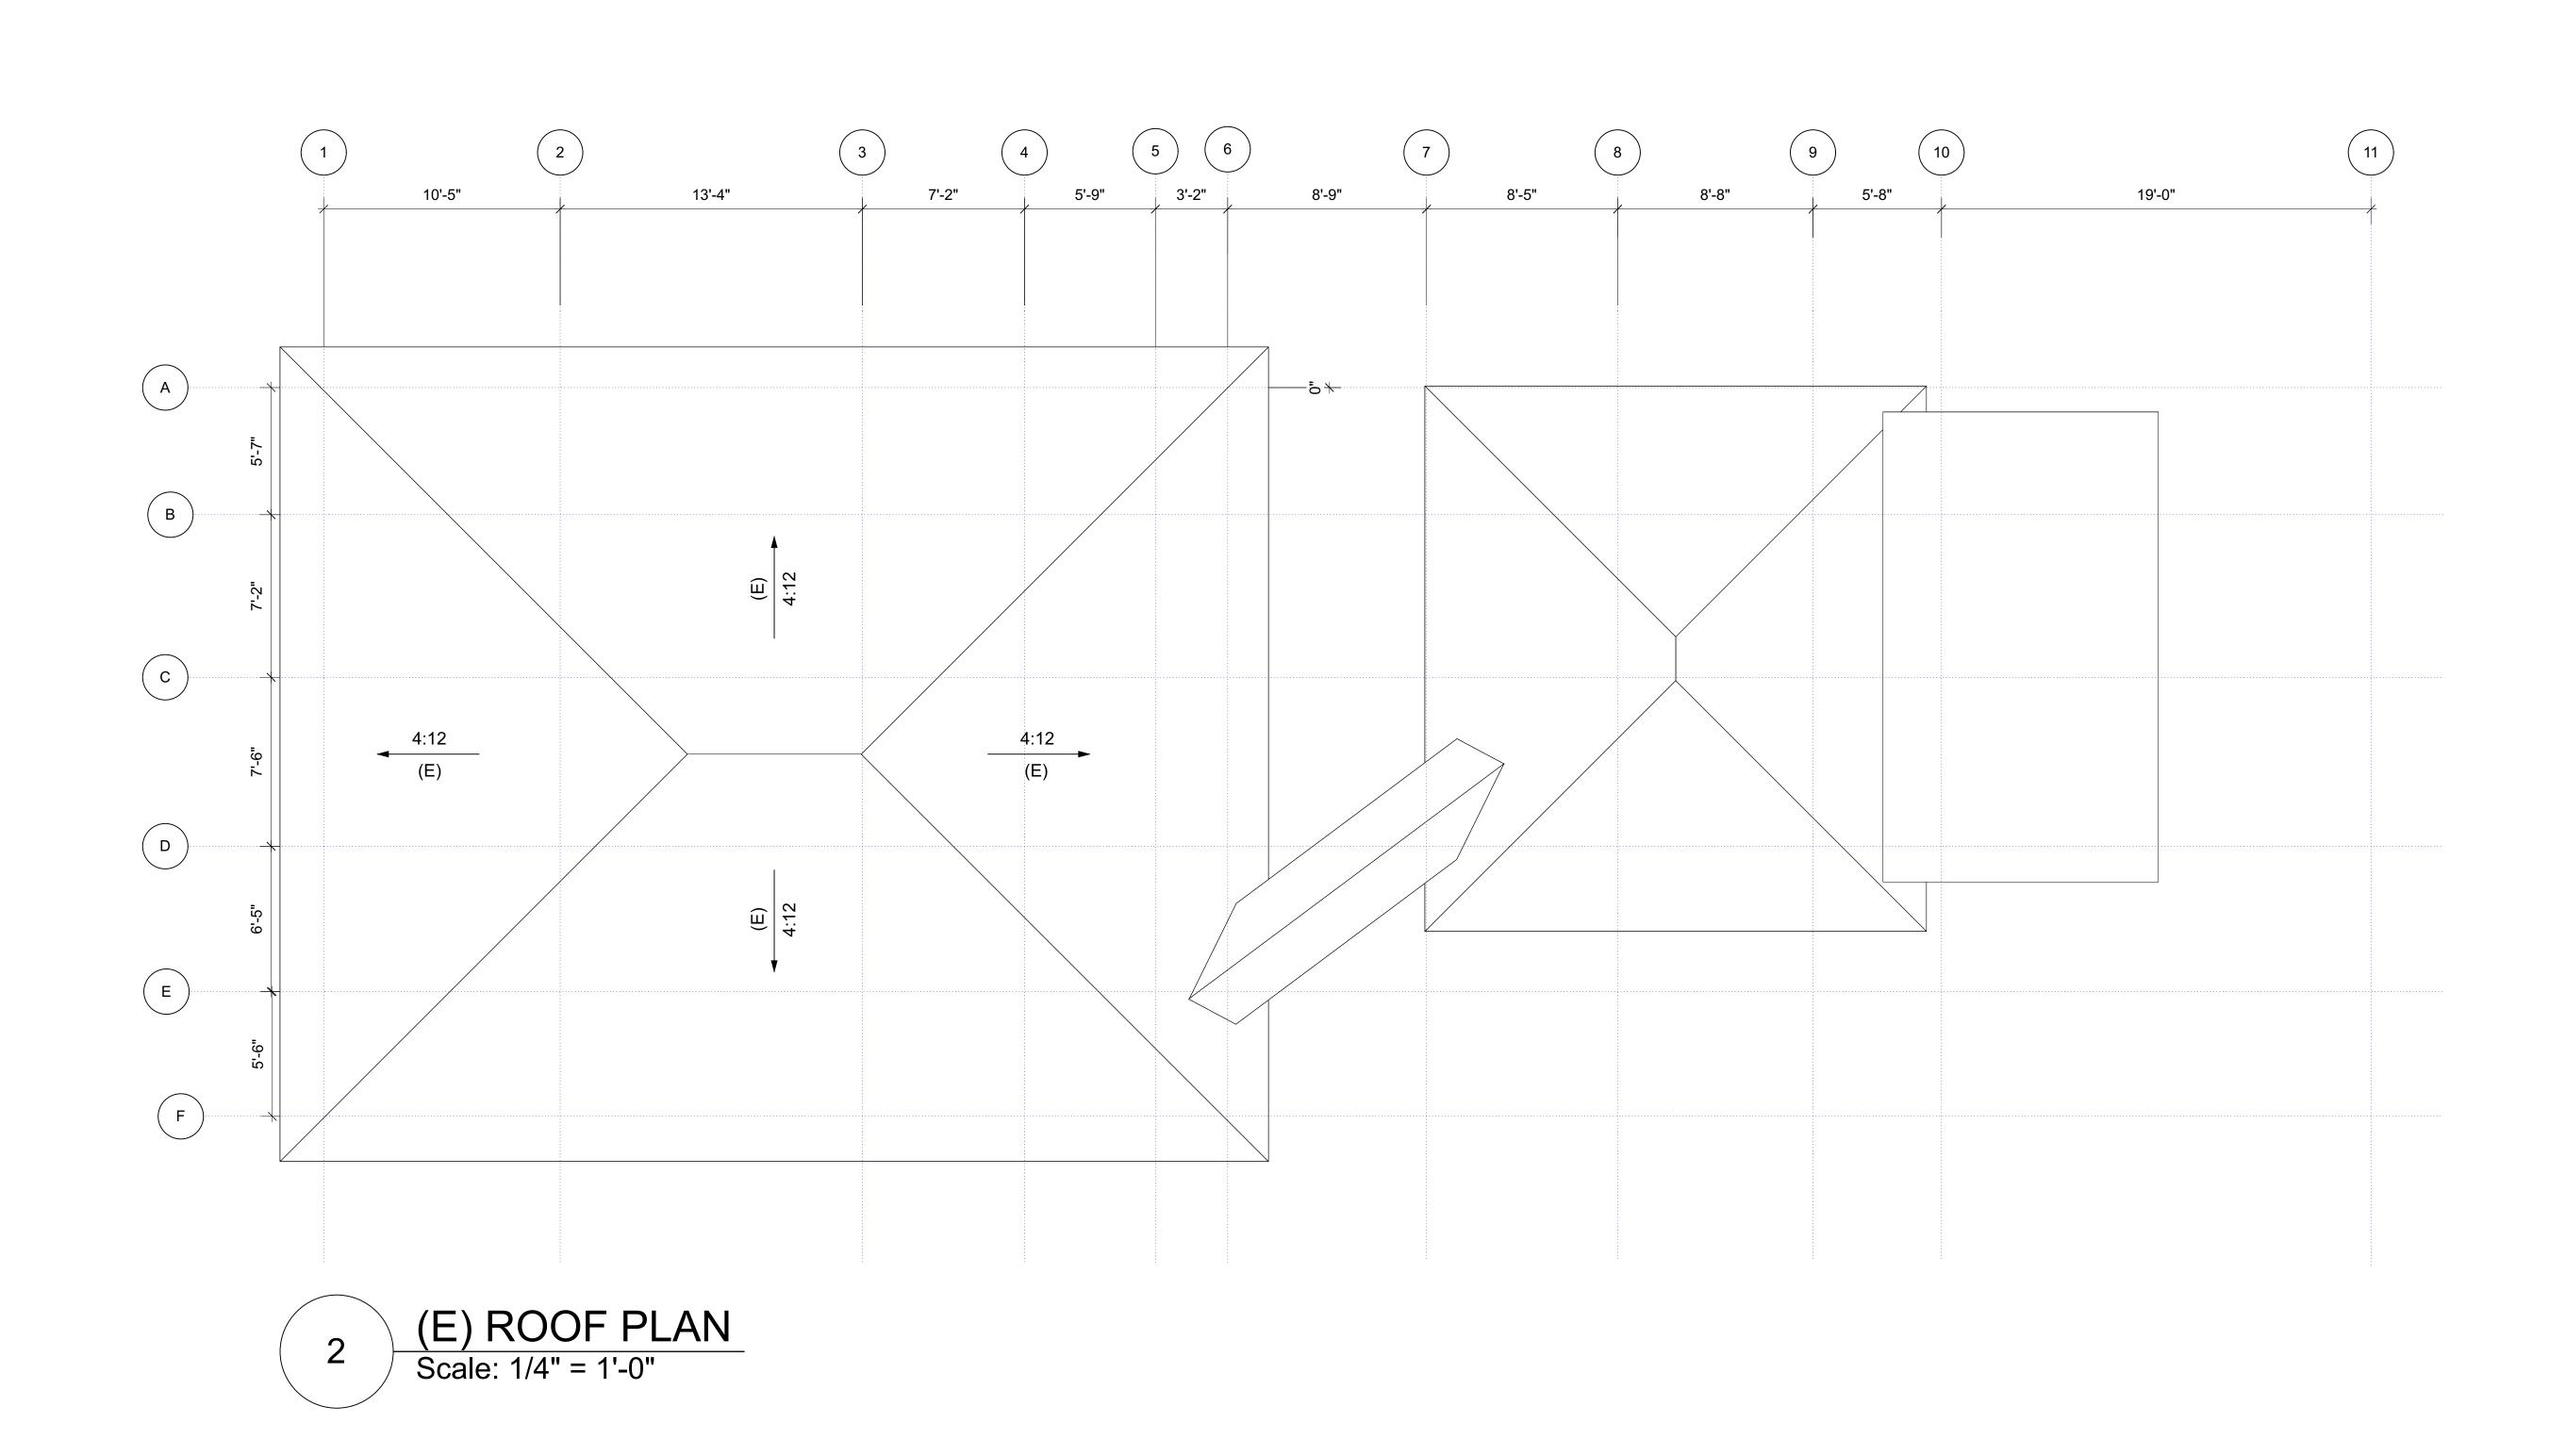5/29/24 PCC 1 11/12/24 PCC 2 21/02/25 PCC 3

CHING RESIDENCE
938 W CARDINAL DR
SUNNYVALE

(N) ROOF PLAN

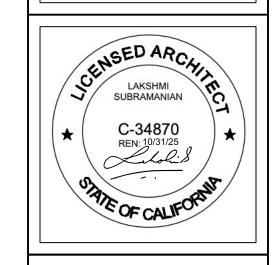Drawing Number

A4.1

AV 070

NSED ARCK

LAKSHMI

Project Phase

**PUBLIC HEARING** 

Issue Date

# ROOF

#### STANDING METAL SEAM CUSTOM BILT 150 STORM GRAY COLOR WITH BLACK GUTTERS





# WALLS

NICHIHA FIBER CEMENT SIDING:

Polished sophistication in color.

WOOD HIGHLIGHTS: VINTAGE WOOD SIDING

WINDOW TRIM: ILLUMINATION BAY BLUE AND RAVEN

**EXTERIOR WALLS: STUCCO OR NICHIHA SMOOTH** 


# 3D VIEW


## WINDOWS

MARVIN FIBERGLASS WINDOWS:


MARVIN MODERN SERIES WITH SINGLE HUNG WINDOWS TO MATCH EXISTING WINDOW STYLE


TRIM ILLUMINATION BY NICHIHA BAY BLUE AND RAVEN

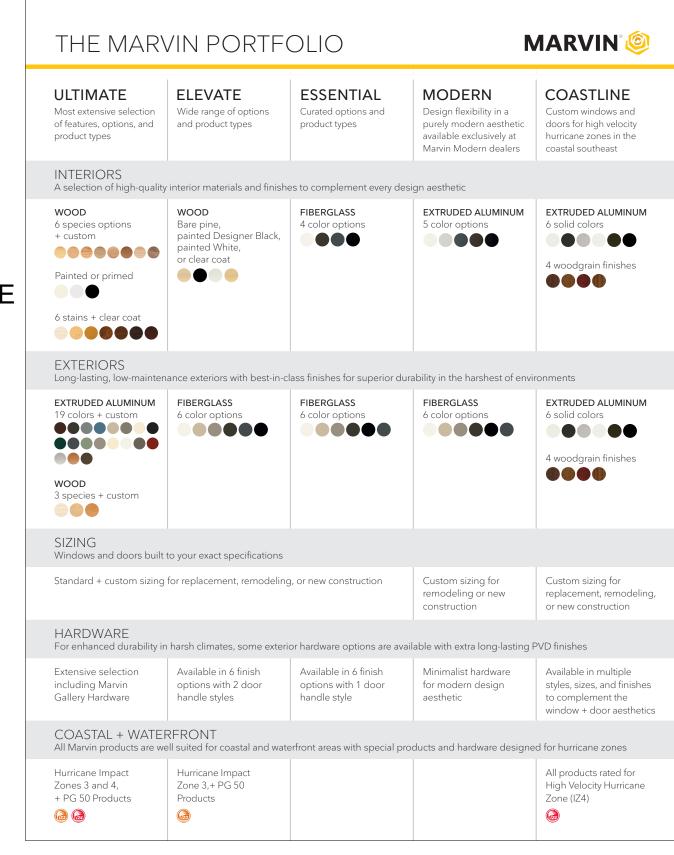

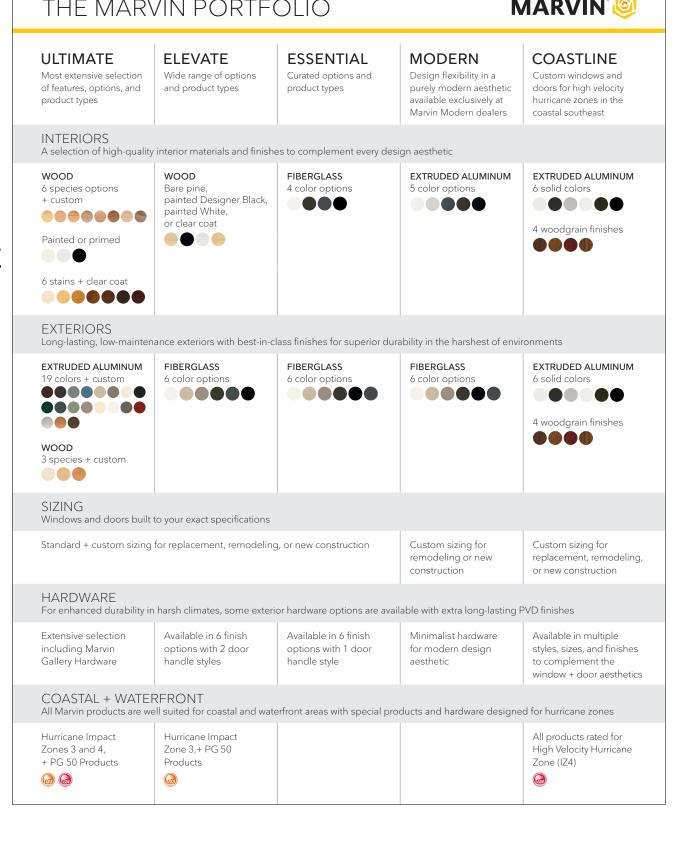



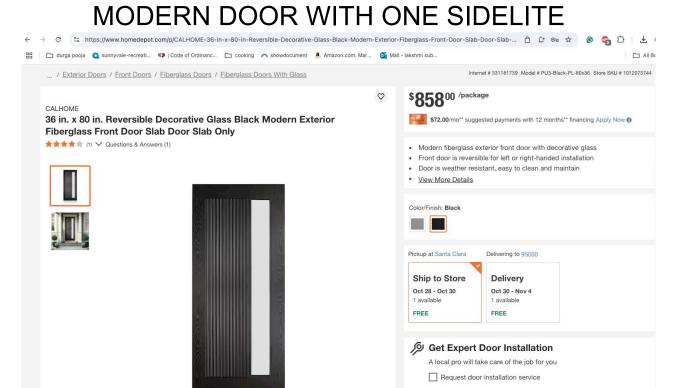


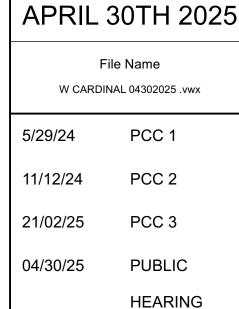

CHING RESIDENC

**COLOR AND** MATERIAL BOARD


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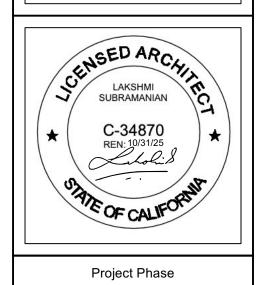
## GARAGE DOOR

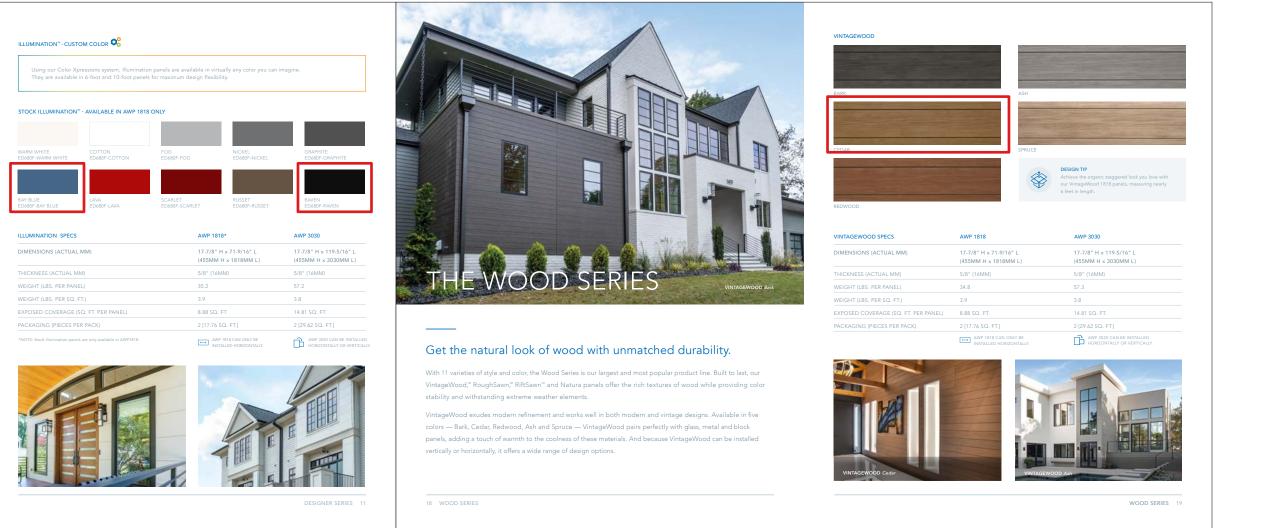CONTEMPORARY GLASS PANEL GARAGE DOOR







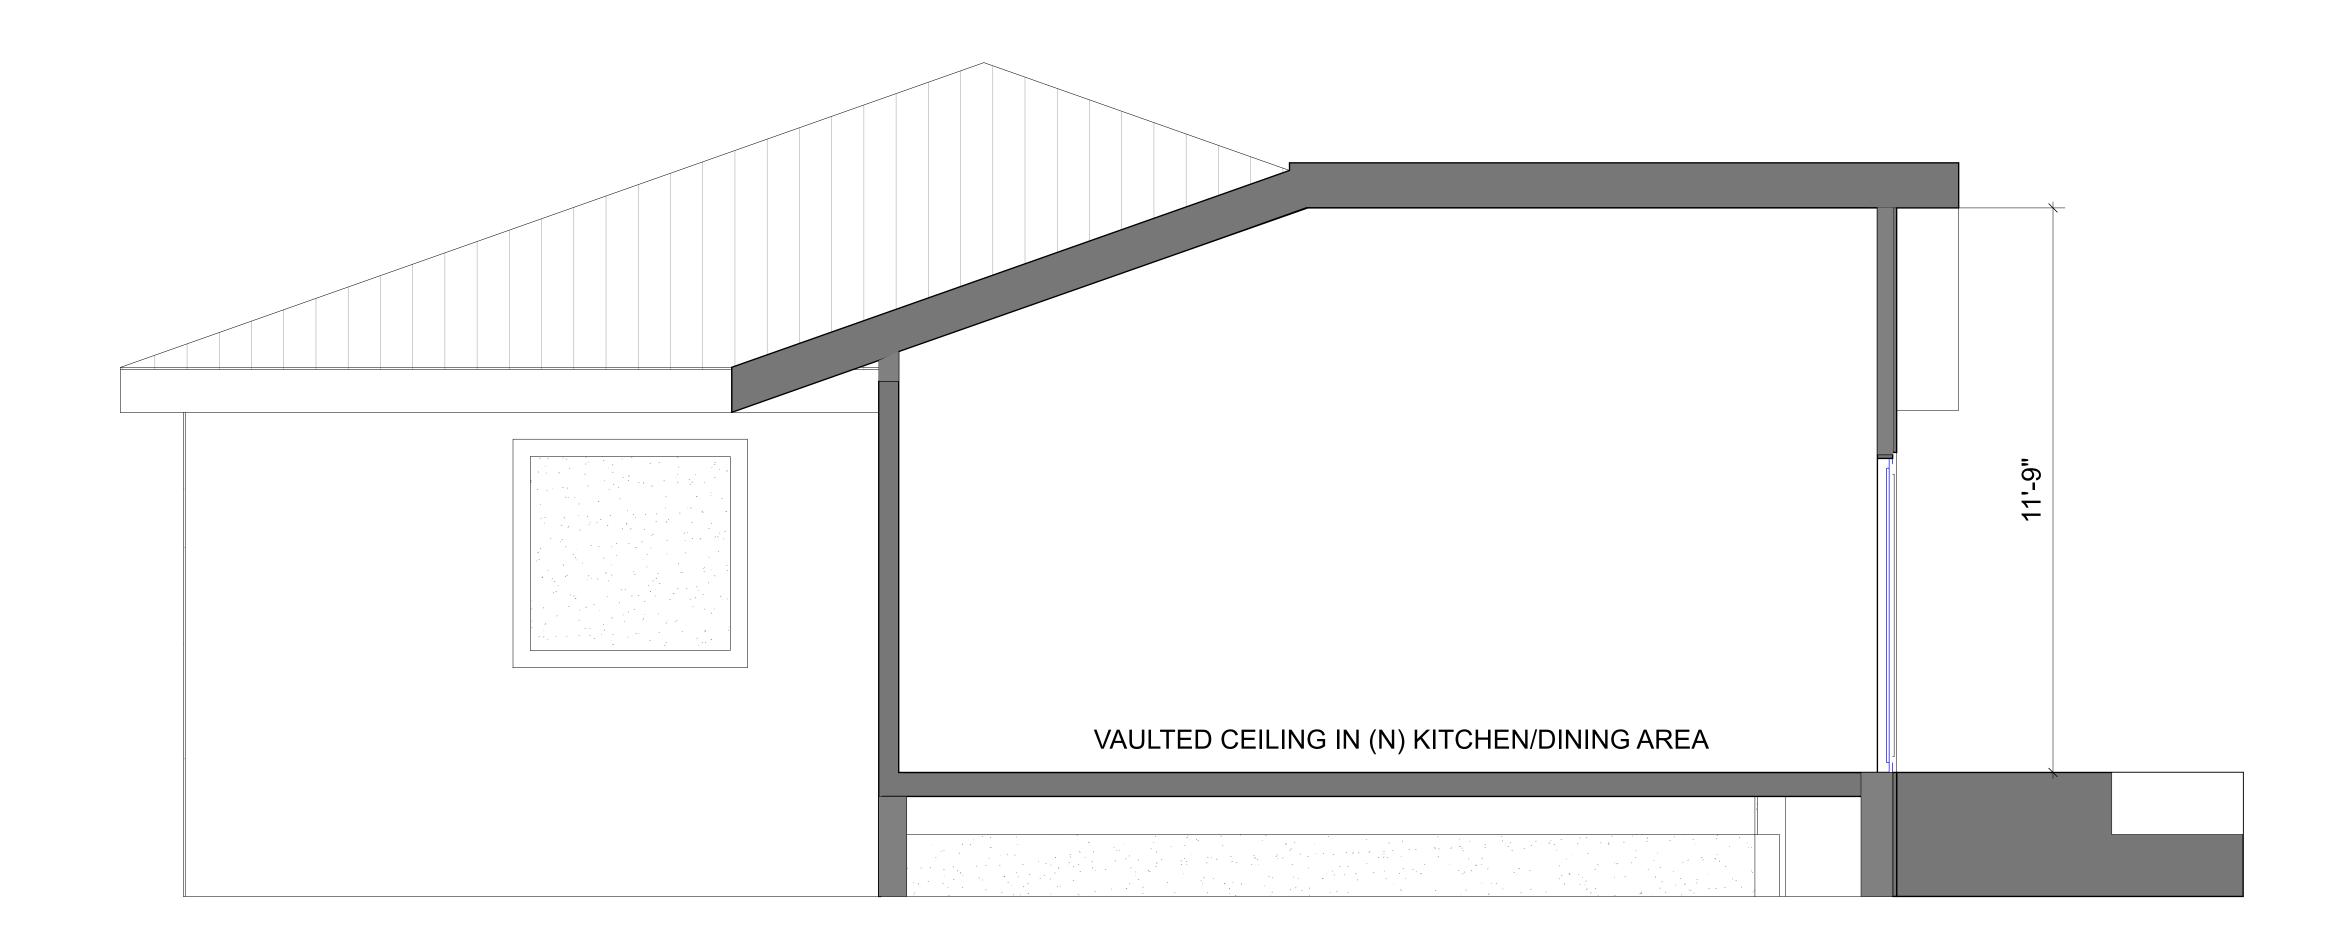

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> File Name W CARDINAL 04302025 .vwx

5/29/24 PCC 1 PCC 2 11/12/24 PCC 3 21/02/25

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SECTION AA

Drawing Number A5.0