# wireless

DISH Wireless SITE ID:

# **SFSFO01057B**

**DISH Wireless SITE ADDRESS:** 

# 333 W EL CAMINO REAL SUNNYVALE, CA 94087

#### CALIFORNIA - CODE COMPLIANCE

ALL WORK SHALL BE PERFORMED AND MATERIALS INSTALLED IN ACCORDANCE WITH THE CURRENT EDITIONS OF THE FOLLOWING CODES AS ADOPTED BY THE LOCAL GOVERNING AUTHORITIES. NOTHING IN THESE PLANS IS TO BE CONSTRUED TO PERMIT WORK NOT CONFORMING TO THESE CODES:

CALIFORNIA BUILDING CODE 2019 (CBC 2019) CALIFORNIA MECHANICAL CODE 2019 CALIFORNIA ELECTRICAL CODE 2019 ELECTRICAL INTERNATIONAL FIRE CODE 2018 (IFC 2018) FIRE CODE

SHEET INDEX			
SHEET NO.	SHEET TITLE		
T-1	TITLE SHEET	-	
A-1	OVER ALL SITE PLAN		
A-2	ROOF PLAN		
A-3	EXSITING ANTENNA PLAN AND SCREEN BOX		
A-3.1	PROPOSED ANTENNA PLAN AND ANTENNA SCHEDULE		
A-4	EXISTING AND PROPOSED ELEVATIONS		
A-5	EXISTING AND PROPOSED ELEVATIONS		
A-6	EXISTING AND PROPOSED ELEVATIONS		
A-7	EXISTING AND PROPOSED ELEVATIONS		
A-8	EQUIPMENT PLAN		
D-1	EQUIPMENT DETAILS		
D-2	EQUIPMENT DETAILS		
D-3	EQUIPMENT DETAILS		
E-1	ELECTRICAL NOTES AND DETAILS		
RF-1	RF CABLE COLOR CODE		

#### SCOPE OF WORK

THIS IS NOT AN ALL INCLUSIVE LIST. CONTRACTOR SHALL UTILIZE SPECIFIED EQUIPMENT PART OR ENGINEER APPROVED EQUIVALENT. CONTRACTOR SHALL VERIFY ALL NEEDED EQUIPMENT TO PROVIDE A FUNCTIONAL SITE. THE PROJECT GENERALLY CONSISTS OF THE FOLLOWING:

SECTOR SCOPE OF WORK:

- PROPOSED ANTENNA LEASE AREA (180 SQ. FT.) PROPOSED ANTENNA LEASE AREA (60 SQ. FT.)
- REMOVE (6) EXISTING ANTENNAS (2 PER SECTOR)
- REMOVE (6) EXISTING RRH (2 PER SECTOR) • REMOVE (1) EXISTING GPS ANTENNA
- REMOVE AND REPLACE (1) EXISTING SCREEN BOX W/ PROPOSED FRP SCREEN BOX
- REMOVE ALL EXISTING CABLES
- RE-USE EXISTING ANTENNA MOUNT AND TRI-POD RE-USE EXISTING FRP SCREEN WALL
- INSTALL (1) PROPOSED FRP SCREEN AT GAMMA SECTOR
- INSTALL (6) PROPOSED PANEL ANTENNAS (2 PER SECTOR) • INSTALL (12) PROPOSED RRH (4 PER SECTOR)
- INSTALL (6) PROPOSED BACK-TO-BACK MOUNT
- INSTALL (6) PROPOSED OVP (2 PER SECTOR)
- INSTALL (1) PROPOSED GPS ANTENNA • INSTALL (6) PROPOSED DC POWER TRUNKS (2 PER SECTOR)
- INSTALL (6) PROPOSED FIBER TRUNKS (2 PER SECTOR) • INSTALL (24) PROPOSED JUMPERS
- GROUND SCOPE OF WORK:
- PROPOSED 13'-0"x16'-0" LEASE AREA (208 SQ. FT.)
- INSTALL (1) PROPOSED EQUIPMENT CABINET
- INSTALL (1) PROPOSED 3'-0"x6'-0" CONCRETE PAD • INSTALL (1) PROPOSED NEMA 3 TELCO-FIBER BOX
- INSTALL (1) PROPOSED CIENA CABINET
- INSTALL (1) PROPOSED DISCONNECT SWITCH
- INSTALL (1) PROPOSED POWER PANEL CABINET
- INSTALL (1) PROPOSED 200A ELECTRICAL METER
- INSTALL (1) PROPOSED GENERATOR PLUG
- INSTALL (1) PROPOSED MANUAL TRANSFER SWITCH
- INSTALL (1) PROPOSED TELCO CONDUIT
- INSTALL (1) PROPOSED POWER CONDUIT

# SITE PHOTO





#### **UNDERGROUND SERVICE ALERT UTILITY NOTIFICATION CENTER OF CALIFORNIA** (800) 642-2444

WWW.CALIFORNIA811.ORG CALL 2-14 WORKING DAYS UTILITY NOTIFICATION PRIOR TO CONSTRUCTION



#### **GENERAL NOTES**

THE FACILITY IS UNMANNED AND NOT FOR HUMAN HABITATION. A TECHNICIAN WILL VISIT THE SITE AS REQUIRED FOR ROUTINE MAINTENANCE. THE PROJECT WILL NOT RESULT IN ANY SIGNIFICANT DISTURBANCE OR EFFECT ON DRAINAGE. NO SANITARY SEWER SERVICE. POTABLE WATER, OR TRASH DISPOSAL IS REQUIRED AND NO COMMERCIAL SIGNAGE IS PROPOSED.

#### 11"x17" PLOT WILL BE HALF SCALE UNLESS OTHERWISE NOTED

CONTRACTOR SHALL VERIFY ALL PLANS, EXISTING DIMENSIONS, AND CONDITIONS ON THE JOB SITE, AND SHALL IMMEDIATELY NOTIFY THE ENGINEER IN WRITING OF ANY DISCREPANCIES BEFORE PROCEEDING WITH THE WORK.

#### SITE INFORMATION PROJECT DIRECTORY SUNNYVALE VILLAGE ASSOCIATE APPLICANT: PROPERTY OWNER: DISH Wireless 333 W EL CAMINO REAL 5701 S. SANTA FE DRIVE SUNNYVALE, CA 94087 LITTLETOWN, CO 80120 TOM BIAGINI CONTACT: GENARO CRUZ (408) 313-2300 SITE DESIGNER: 1875 CORONADO AVE COUNTY: SANTA CLARA SIGNAL HILL, CA 90755 PHONE: 714-443-8407 37.369325° LATITUDE (NAD 83): SITE ACQUISITION: QUALTEK Wireless LONGITUDE (NAD 83): 1200 DEL PASO RD. STE. 150 SACRAMENTO, CA 95843 DEREK TURNER ZONING JURISDICTION: SUNNYVALE (925) 667-8115 Dturner@qualtekwireless.com O - ADMINISTRATIVE -ZONING DISTRICT: PROFESSIONAL OFFICE PARCEL NUMBER: CONSTRUCTION MANAGER: JOSHUA ROBERSON 209-29-068 (949) 505-4225 OCCUPANCY GROUP: O - ADMINISTRATIVE AND Jroberson@qualtekwireless.cor PROFESSIONAL OFFICE CONSTRUCTION TYPE: RF ENGINEER: POOJA SHAH 5701 S. SANTA FE DRIVE LITTLETOWN, CO 80120 POWER COMPANY: PG&E (828) 216-4210 Pooja.shah@dish.com TELEPHONE COMPANY: AT&T

#### **DIRECTIONS**

DIRECTIONS FROM SAN FRANCISCO INTERNATIONAL AIRPORT:

HEAD SOUTH, KEEP LEFT, FOLLOW SIGNS FOR US-101 S/SAN JOSE AND MERGE ONTO US-101 S, TAKE EXIT 396A FOR MATHILDA AVE, USE THE RIGHT 2 LANES TO TURN RIGHT ONTO N MATHILDA AVE, USE THE RIGHT 2 LANES TO TURN RIGHT ONTO N MATHILDA AVE, MAKE A U-TURN, TURN RIGHT, DESTINATION WILL BE ON THE

#### **VICINITY MAP**





5701 SOUTH SANTA FE DRIVE LITTLETON, CO 80120



1200 DEL PASO RD. STE. 150 SACRAMENTO, CA 95843

IT IS A VIOLATION OF LAW FOR ANY PERSON, OF A LICENSED PROFESSIONAL ENGINEER, TO ALTER THIS DOCUMENT.

DRAWN	BY:	CHECKED	BY:	APPROVED	BY:	
GO		МО		GC		
RFDS_REV_#3_ISSUED: 12/08/2021						

### ZONING DOCUMENTS

	SUBMITALS					
REV	DATE	DESCRIPTION				
0	01/18/22	90% CONSTRUCTION DRAWING				
1	03/18/22	JX COMMENTS				
2	07/01/22	100% CONSTRUCTION DRAWING				
	A&E PROJECT NUMBER					

SITE ID\_4739


DISH Wireless PROJECT INFORMATION


SFSF001057B 333 W EL CAMINO REAL SUNNYVALE, CA 94087 ROOFTOP


SHEET TITLE


TITLE SHEET

SHEET NUMBER

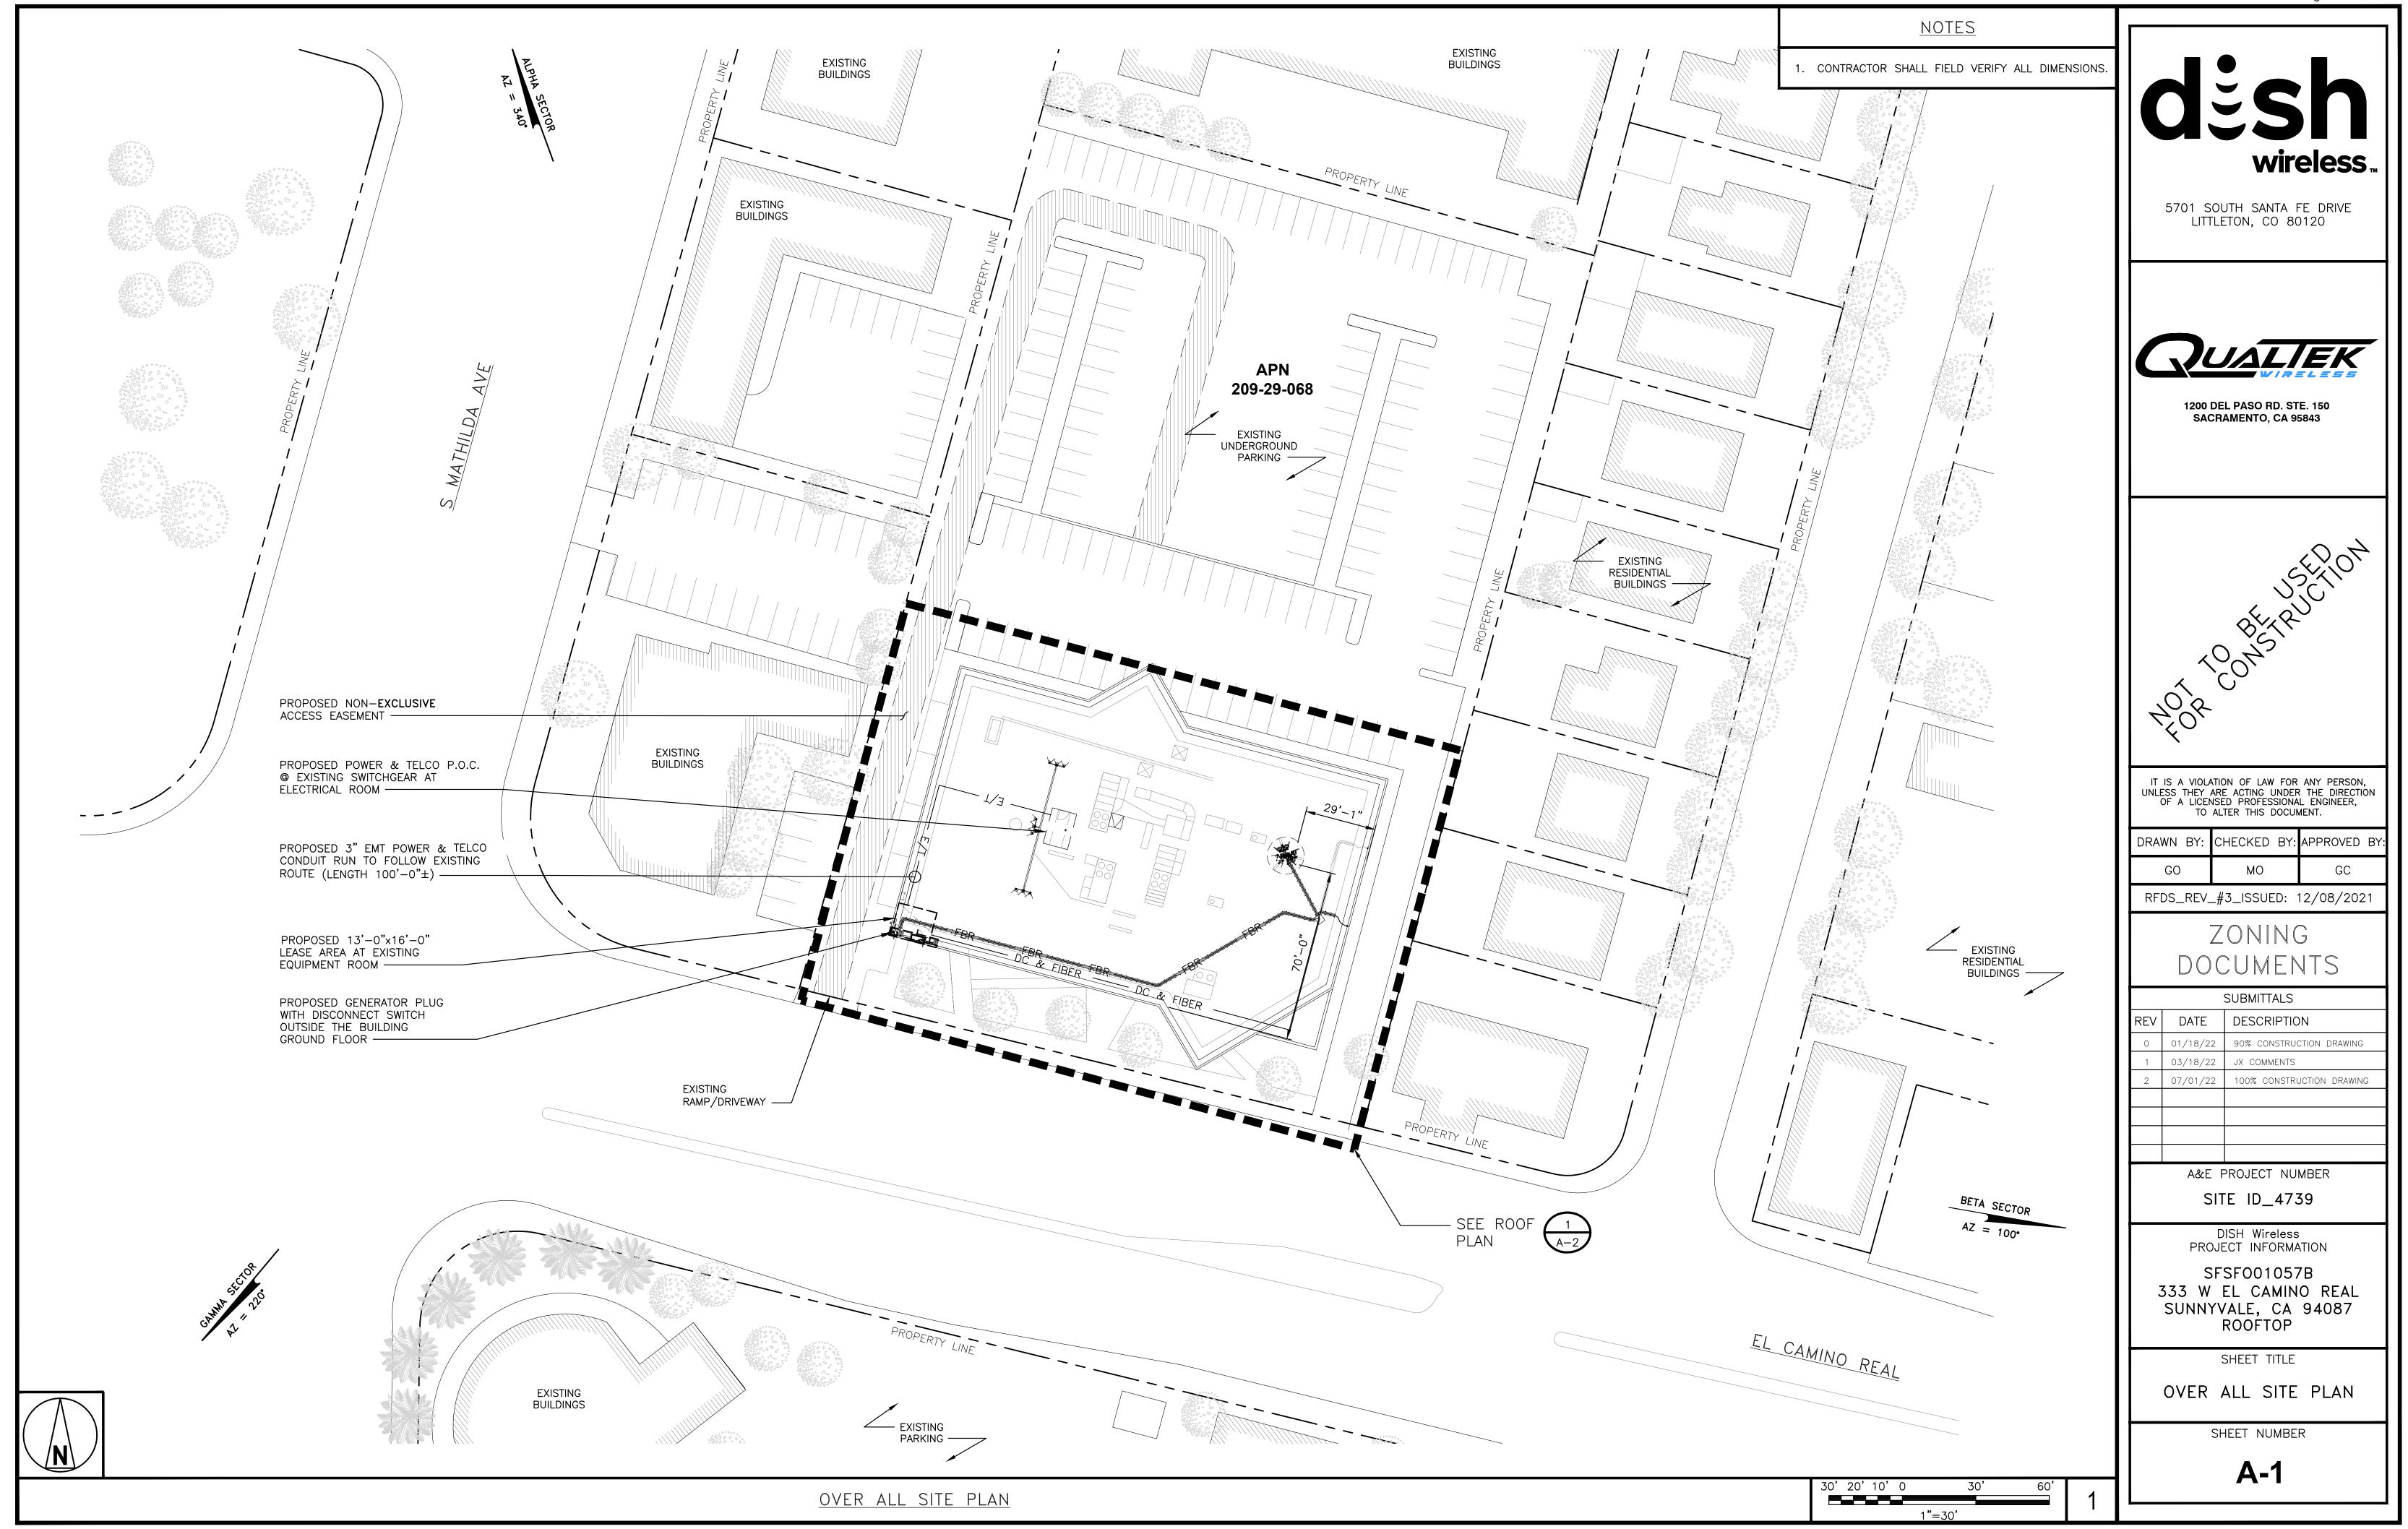

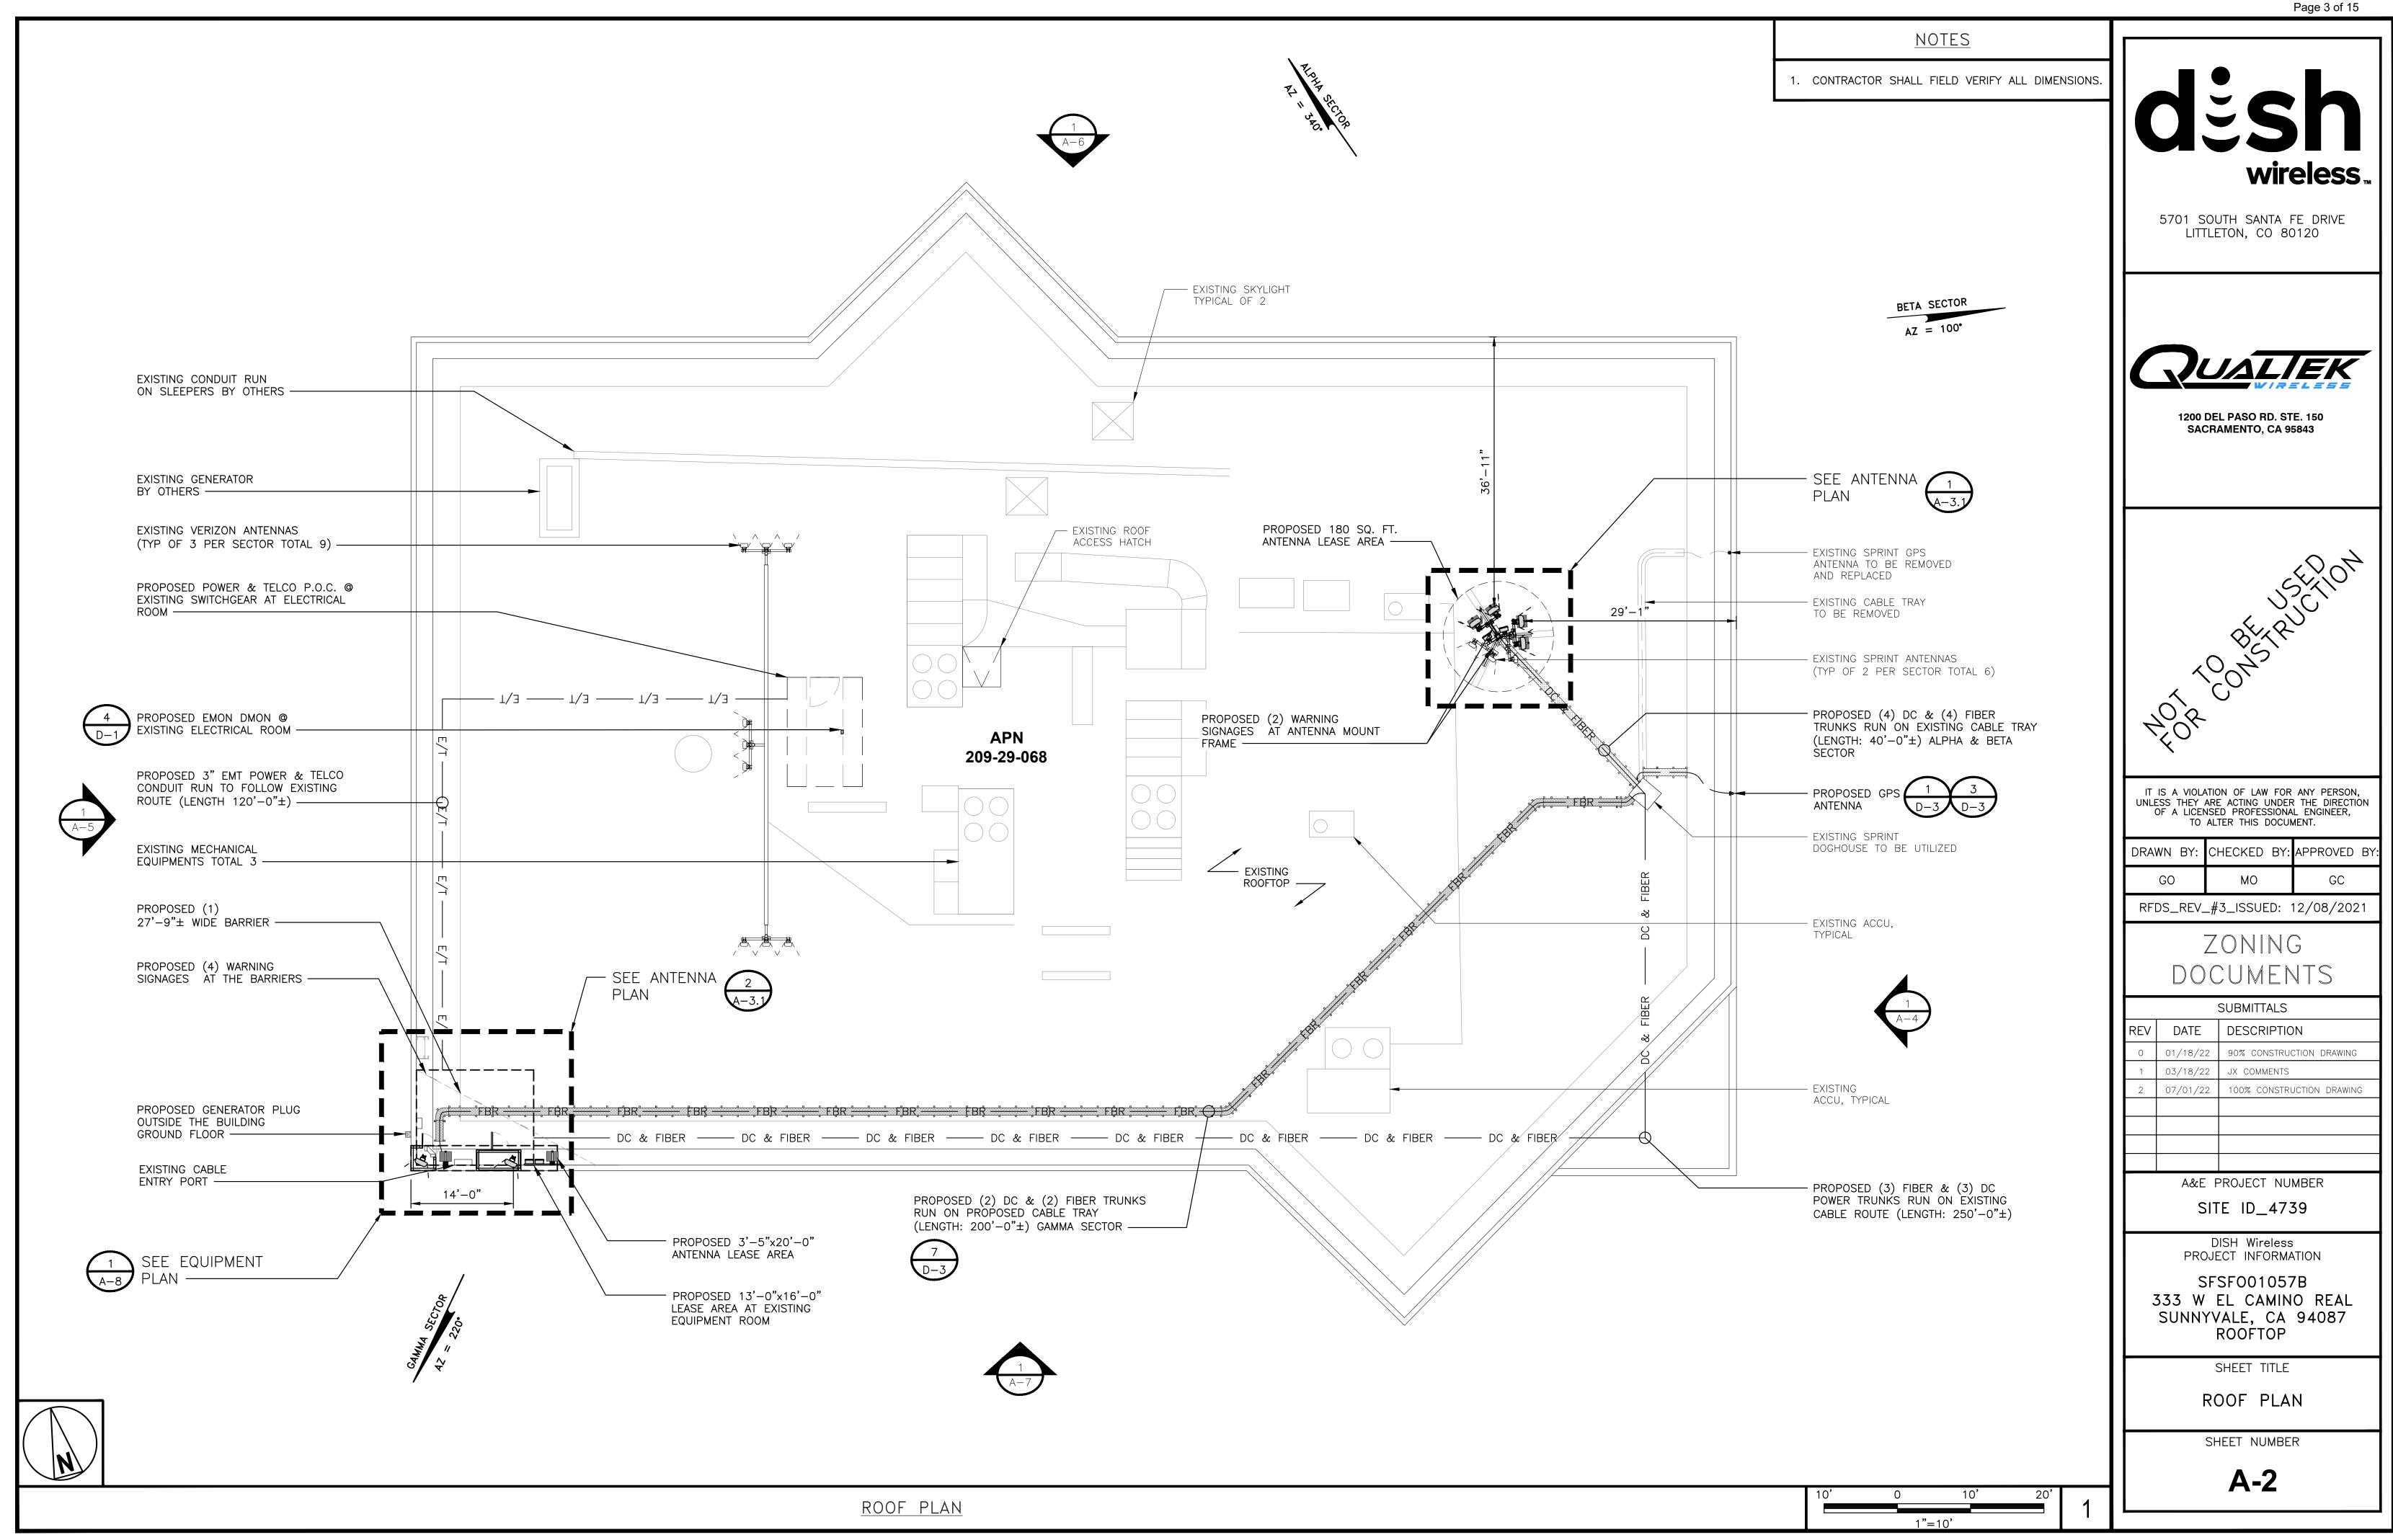

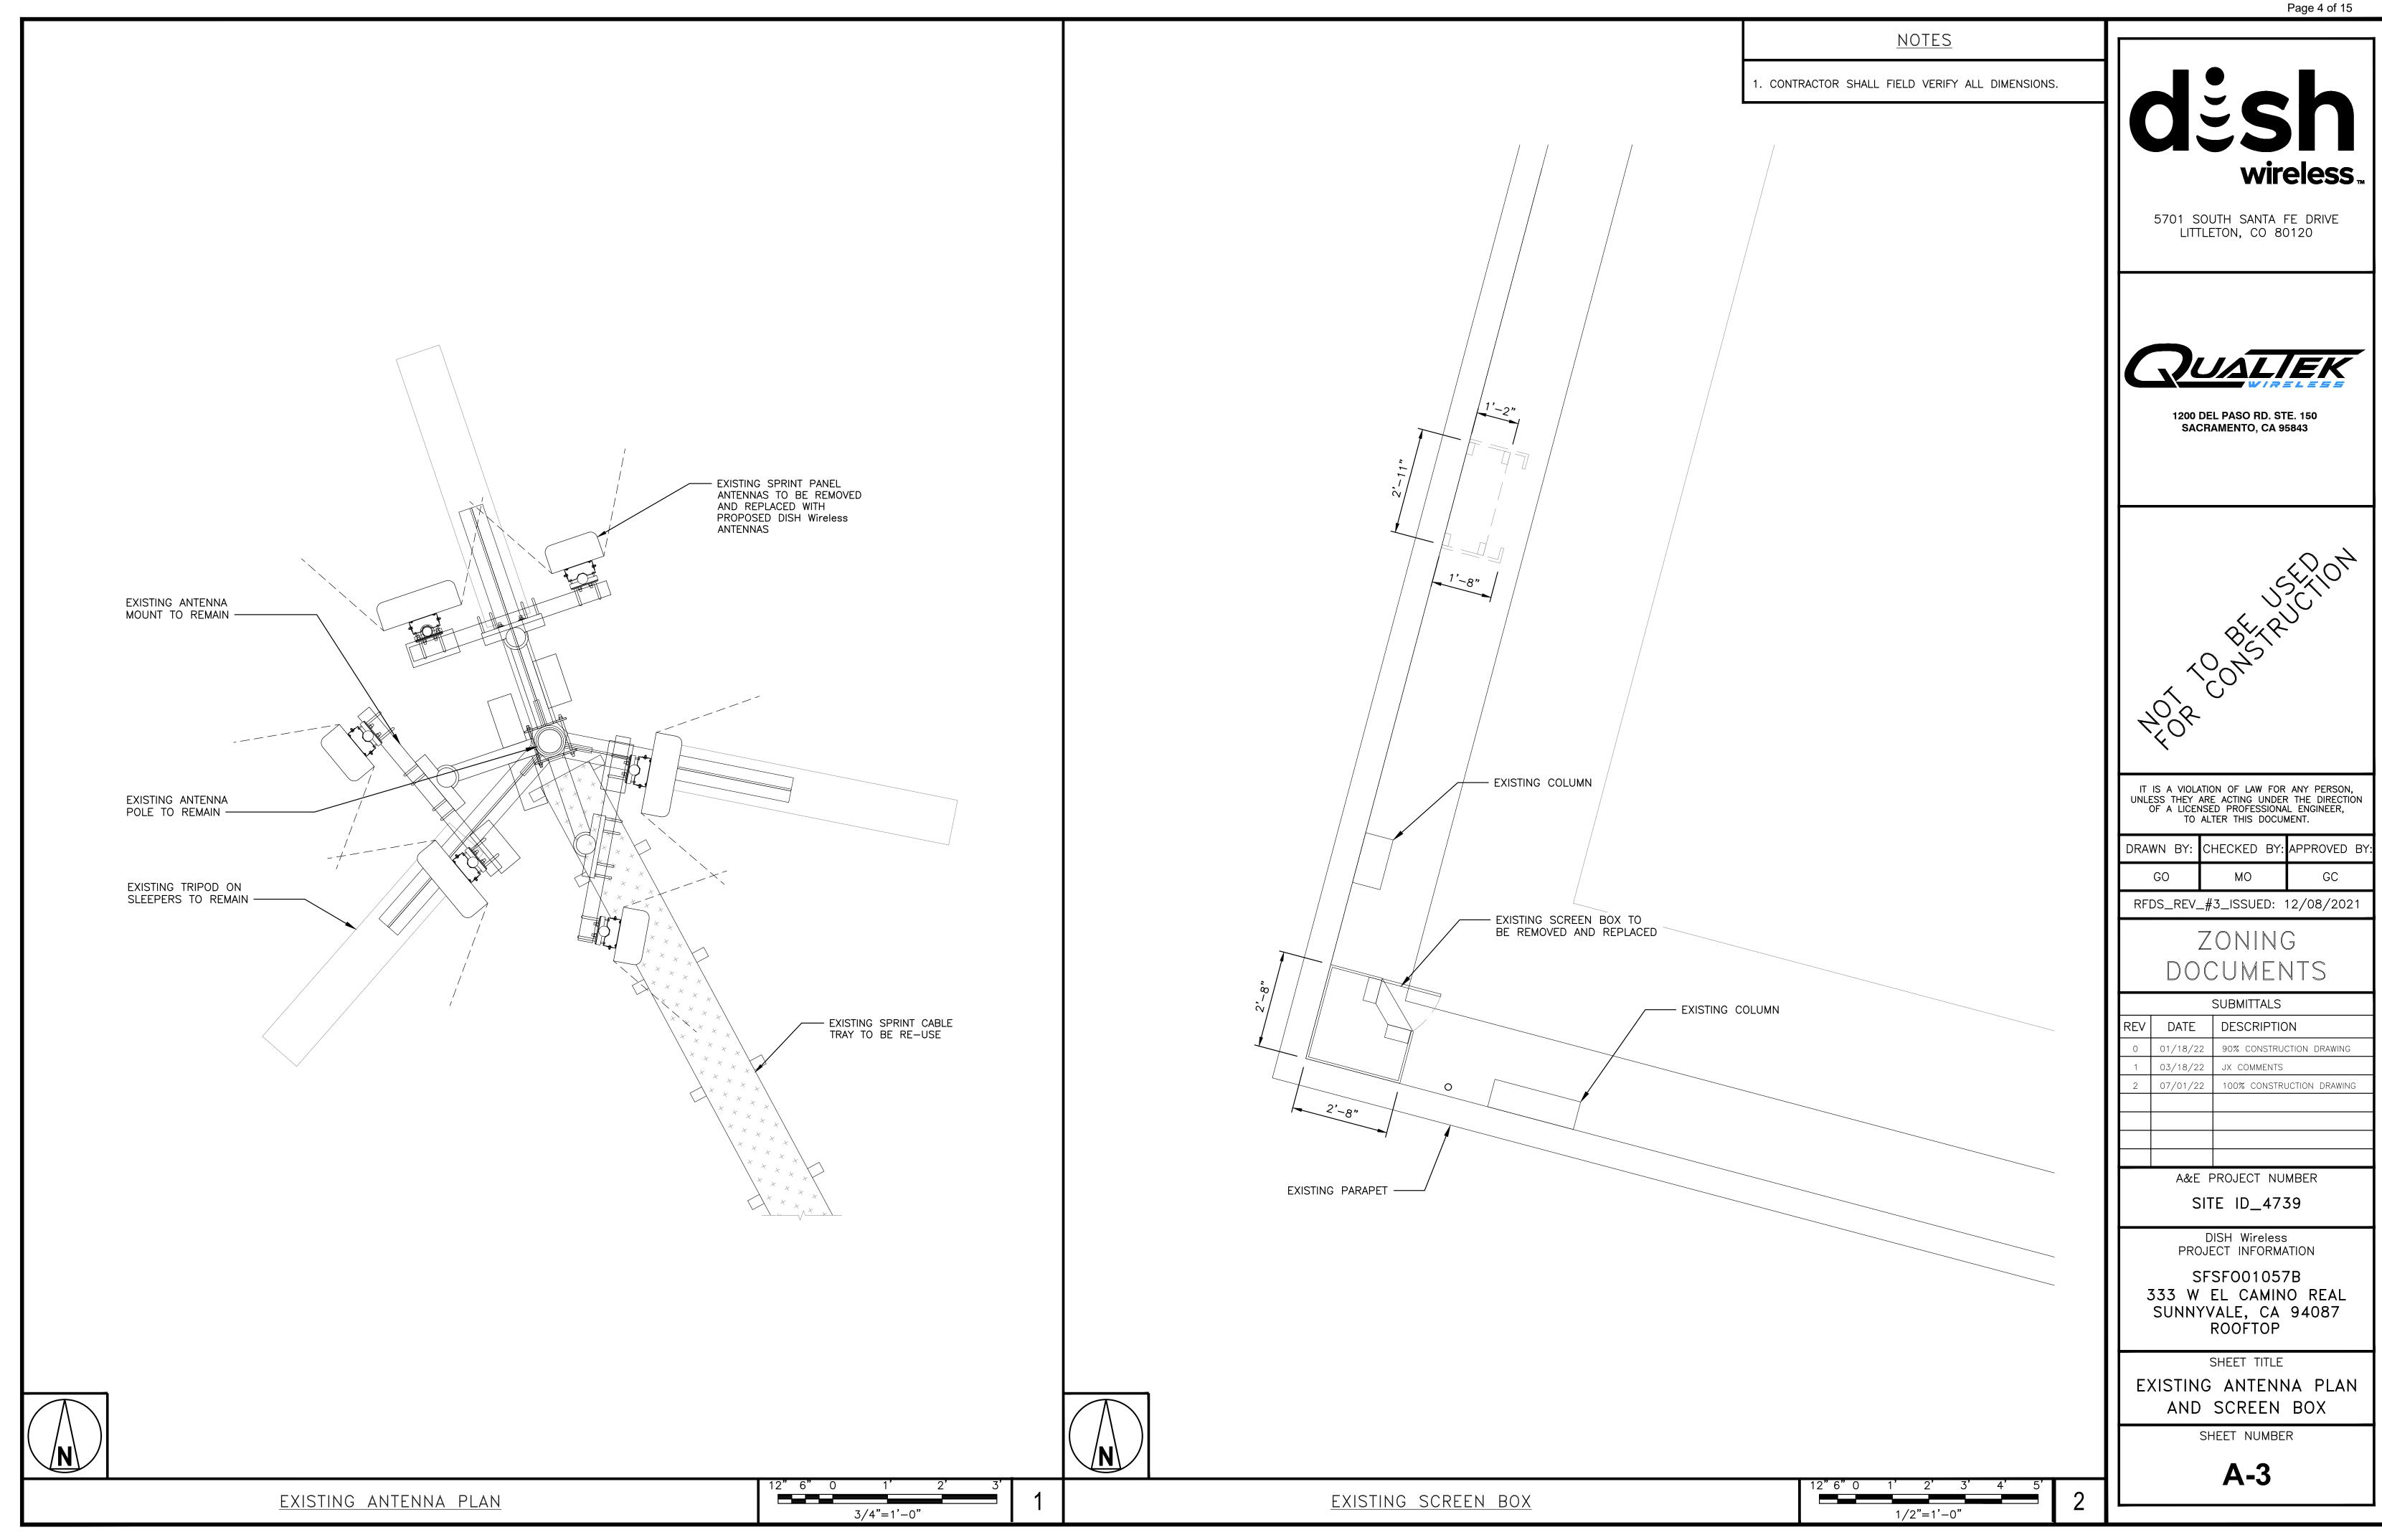

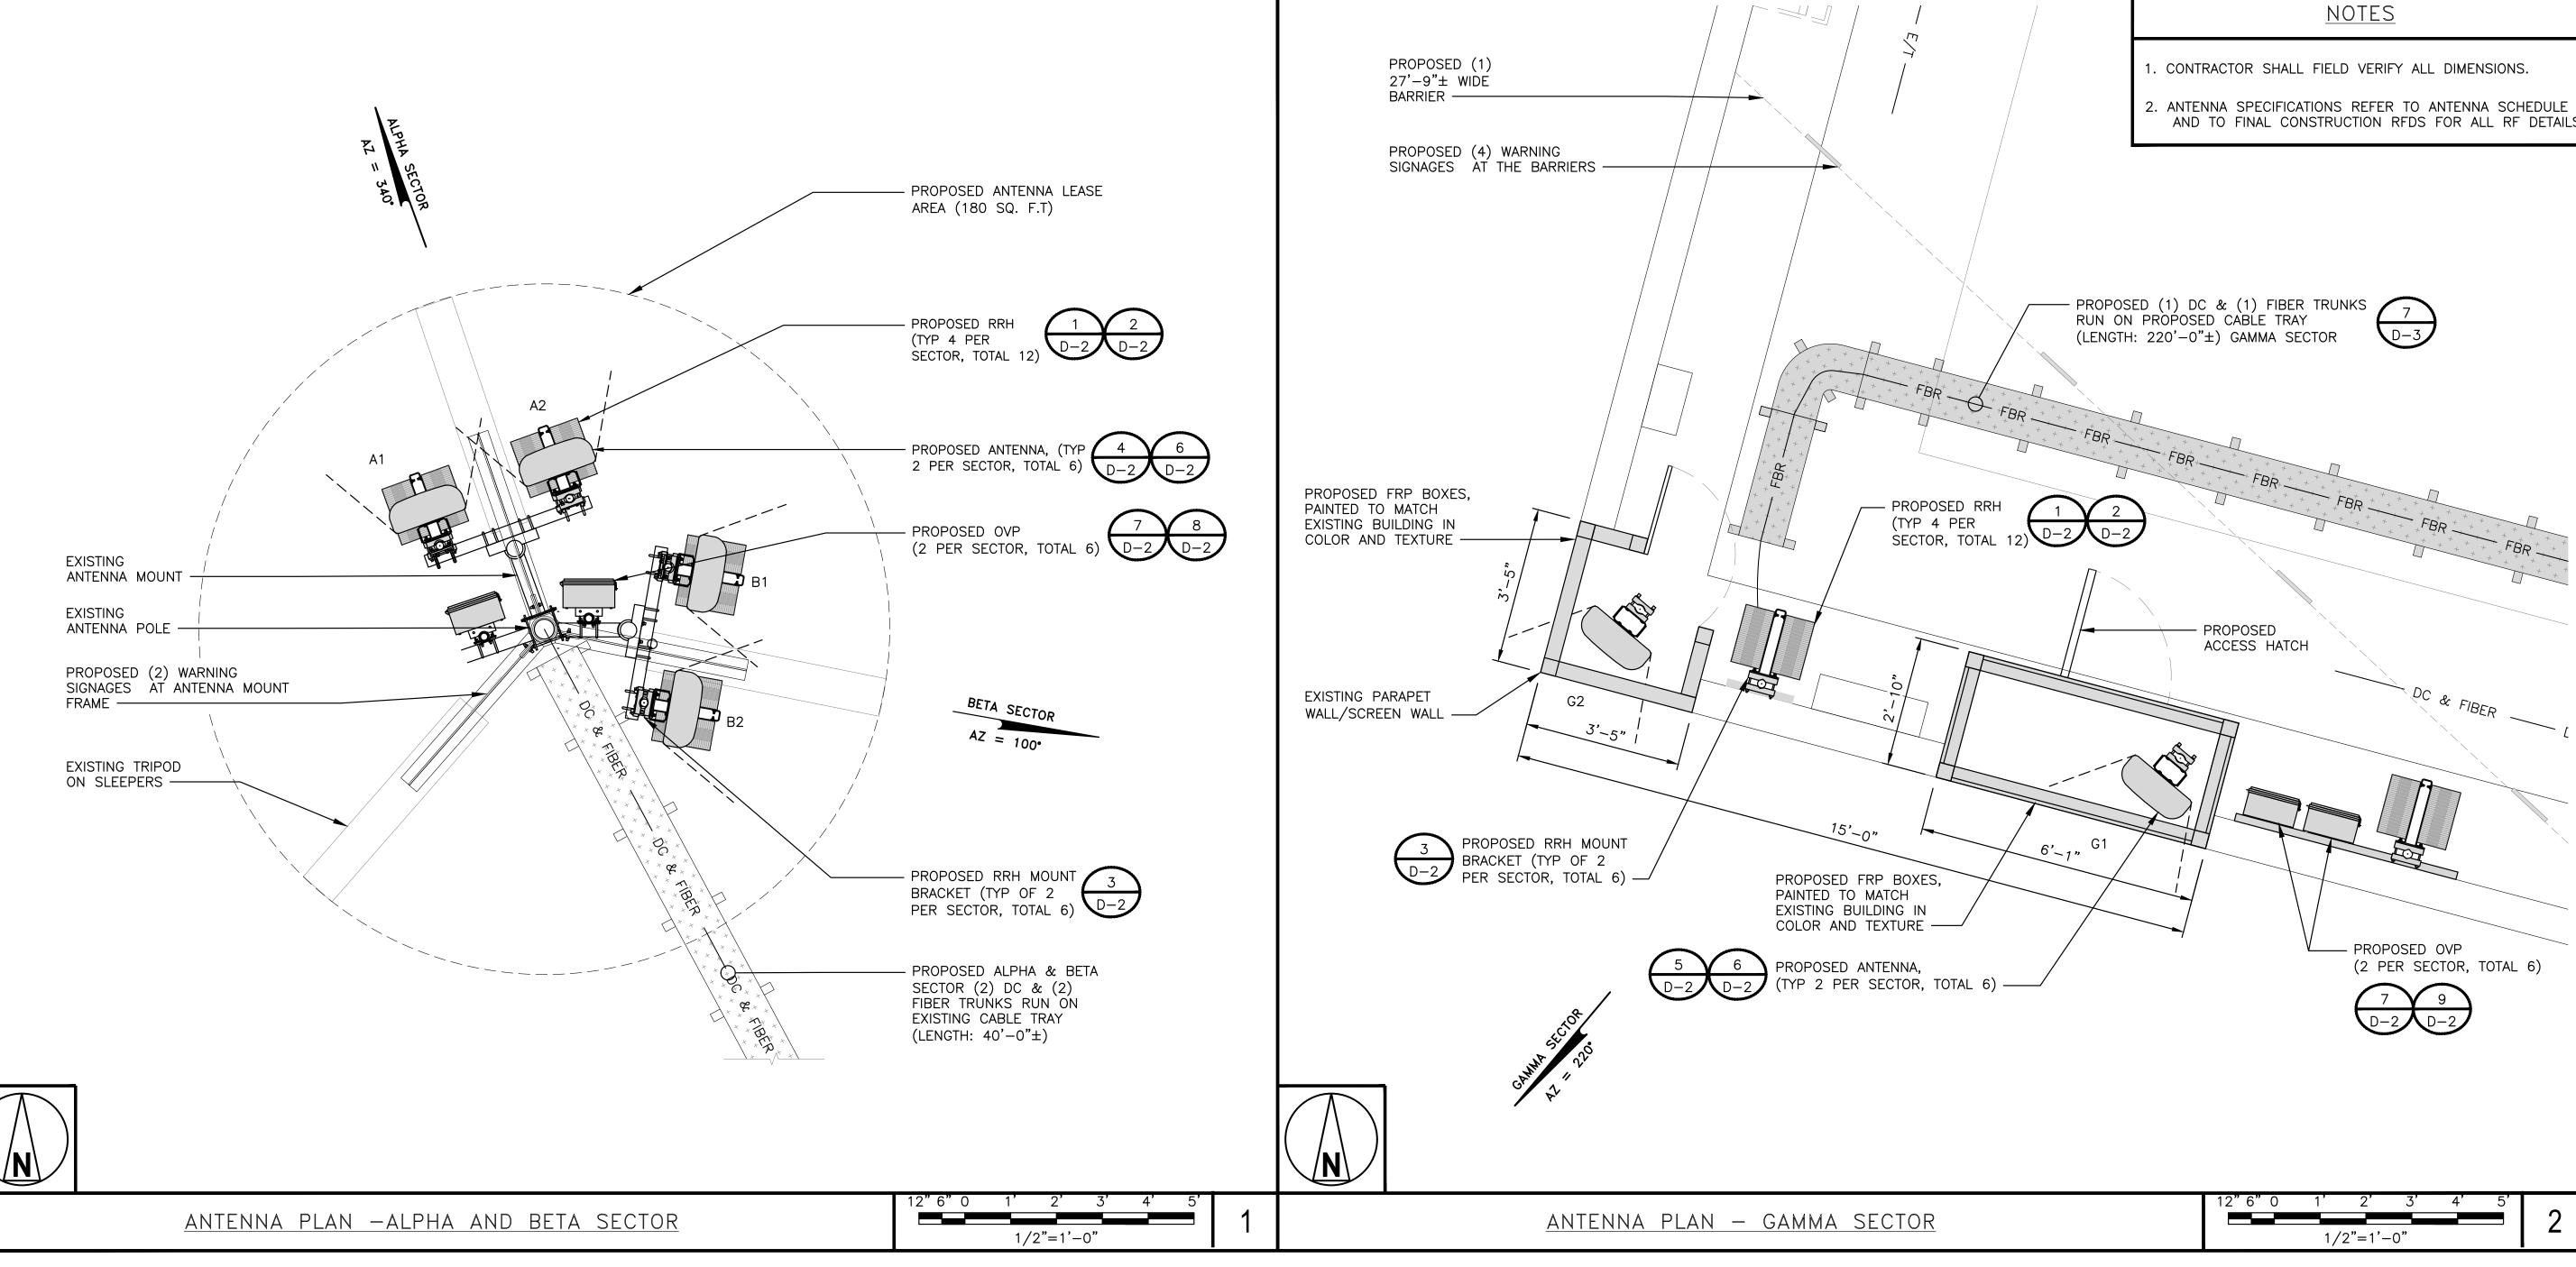

			TRANSMISSION CABLE							
SECTOR	POSITION	EXISTING OR PROPOSED	MANUFACTURER — MODEL NUMBER	TECHNOLOGY	SIZE (HxWxD)	WEIGHT	AZIMUTH	RAD CENTER	FEED LINE TYPE AND LENGTH	
ALPHA	A1	PROPOSED	MX08FR0665-21	5G	72.0"x20.0"x8.0"	64.5 LBS	340°	57'-0"	(1) FIBER & (1) POWER	
ALPHA	A2	PROPOSED	MX08FR0665-21	5G	72.0"x20.0"x8.0"	64.5 LBS	340°	57'-0"	(APPROX: 290')	
BETA	B1	PROPOSED	MX08FR0665-21	5G	72.0"x20.0"x8.0"	64.5 LBS	100°	57'-0"	(1) FIBER & (1) POWER	
BETA	B2	PROPOSED	MX08FR0665-21	5G	72.0"x20.0"x8.0"	64.5 LBS	100°	57'-0"	(APPROX: 290')	
GAMMA	G1	PROPOSED	MX08FR0665-20	5G	72.0"x20.0"x8.0"	51.3 LBS	220°	46'-0"	(1) FIBER & (1) POWER	
GAMMA	G2	PROPOSED	MX08FR0665-20	5G	72.0"x20.0"x8.0"	51.3 LBS	220°	46'-0"	(APPROX: \450')	

		RRH				NOTES .	
SECTOR	POSITION	MANUFACTURER — MODEL NUMBER	TECHNOLOGY	SIZE (HxWxD)	WEIGHT	1. CONTRACTOR TO REFER TO FINAL	
	A1	FUJITSU TAO8025-B605	5G	14.9"X15.7"X9"	74.95 LBS.	CONSTRUCTION RFDS FOR ALL RF DETAILS.	
	A1	FUJITSU TAO8025-B604	5G	14.9"X15.7"X7.8"	63.93 LBS.	<ol> <li>ANTENNA AND RRH MODELS MAY CHANGE DUE TO EQUIPMENT</li> </ol>	
ALPHA	A2	FUJITSU TAO8025-B605	5G	14.9"X15.7"X9"	74.95 LBS.	AVAILABILITY. ALL EQUIPMENT CHANGES MUST BE APPROVED AND	
BETA GAMMA	A2	FUJITSU TAO8025-B604	5G	14.9"X15.7"X7.8"	63.93 LBS.	REMAIN IN COMPLIANCE WITH THE PROPOSED DESIGN AND STRUCTURAL	
	B1	FUJITSU TAO8025-B605	5G	14.9"X15.7"X9"	74.95 LBS.	ANALYSES.	
	B1	FUJITSU TAO8025-B604	5G	14.9"X15.7"X7.8"	63.93 LBS.		
	B2	FUJITSU TAO8025-B605	5G	14.9"X15.7"X9"	74.95 LBS.		
	B2	FUJITSU TAO8025-B604	5G	14.9"X15.7"X7.8"	63.93 LBS.		
	G1	FUJITSU TAO8025-B605	5G	14.9"X15.7"X9"	74.95 LBS.		
	G1	FUJITSU TAO8025-B604	5G	14.9"X15.7"X7.8"	63.93 LBS.		
	G2	FUJITSU TAO8025-B605	5G	14.9"X15.7"X9"	74.95 LBS.		
	G2	FUJITSU TAO8025-B604	5G	14.9"X15.7"X7.8"	63.93 LBS.		

d:Sh wireless

5701 SOUTH SANTA FE DRIVE LITTLETON, CO 80120

QUALIEK

1200 DEL PASO RD. STE. 150 SACRAMENTO, CA 95843

A CONSTRUCTION A CONS

IT IS A VIOLATION OF LAW FOR ANY PERSON, UNLESS THEY ARE ACTING UNDER THE DIRECTION OF A LICENSED PROFESSIONAL ENGINEER, TO ALTER THIS DOCUMENT.

DRAWN	BY:	CHECKED	BY:	APPROVED	BY	
GO		МО		GC		
RFDS_REV_#3_ISSUED: 12/08/2021						

ZONING DOCUMENTS

SUBMITTALS					
REV	DATE	DESCRIPTION			
0	01/18/22	90% CONSTRUCTION DRAWING			
1	03/18/22	JX COMMENTS			
2	07/01/22	100% CONSTRUCTION DRAWING			
A&E PROJECT NUMBER					

SITE ID\_4739

DISH Wireless PROJECT INFORMATION


SFSFO01057B 333 W EL CAMINO REAL SUNNYVALE, CA 94087 ROOFTOP


SHEET TITLE


PROPOSED ANTENNA PLAN AND ANTENNA SCHEDULE


SHEET NUMBER


A-3.1

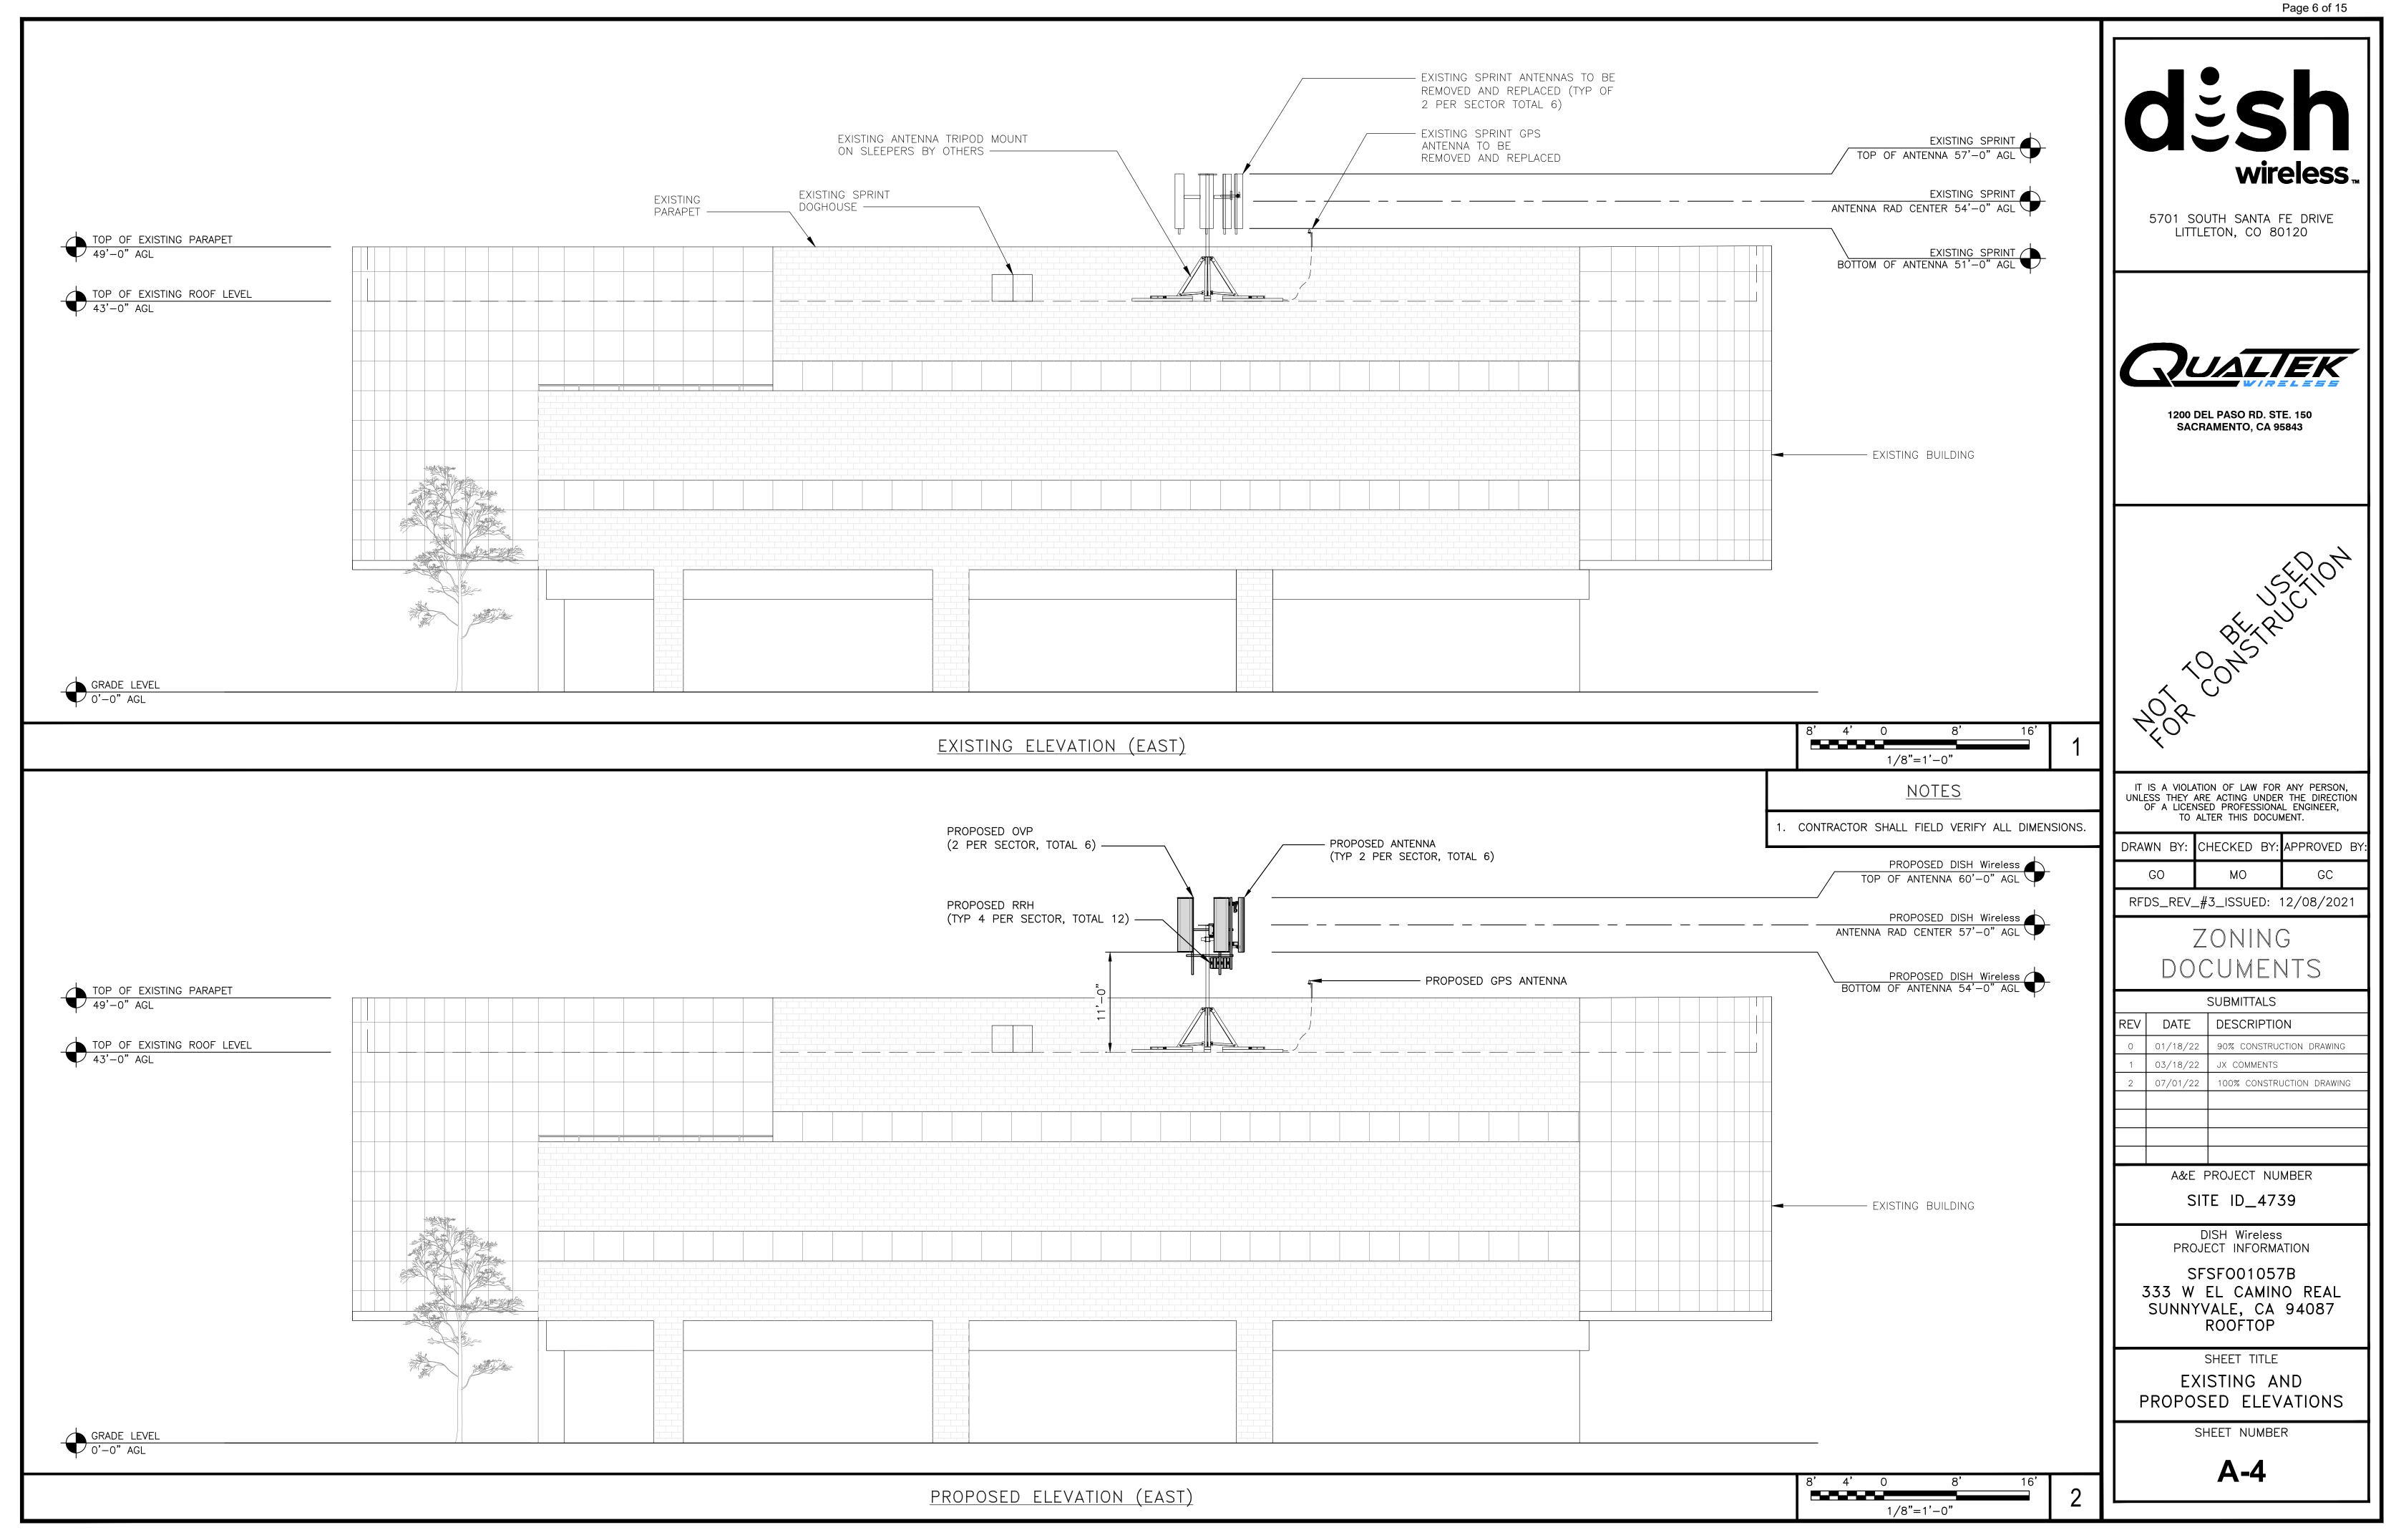

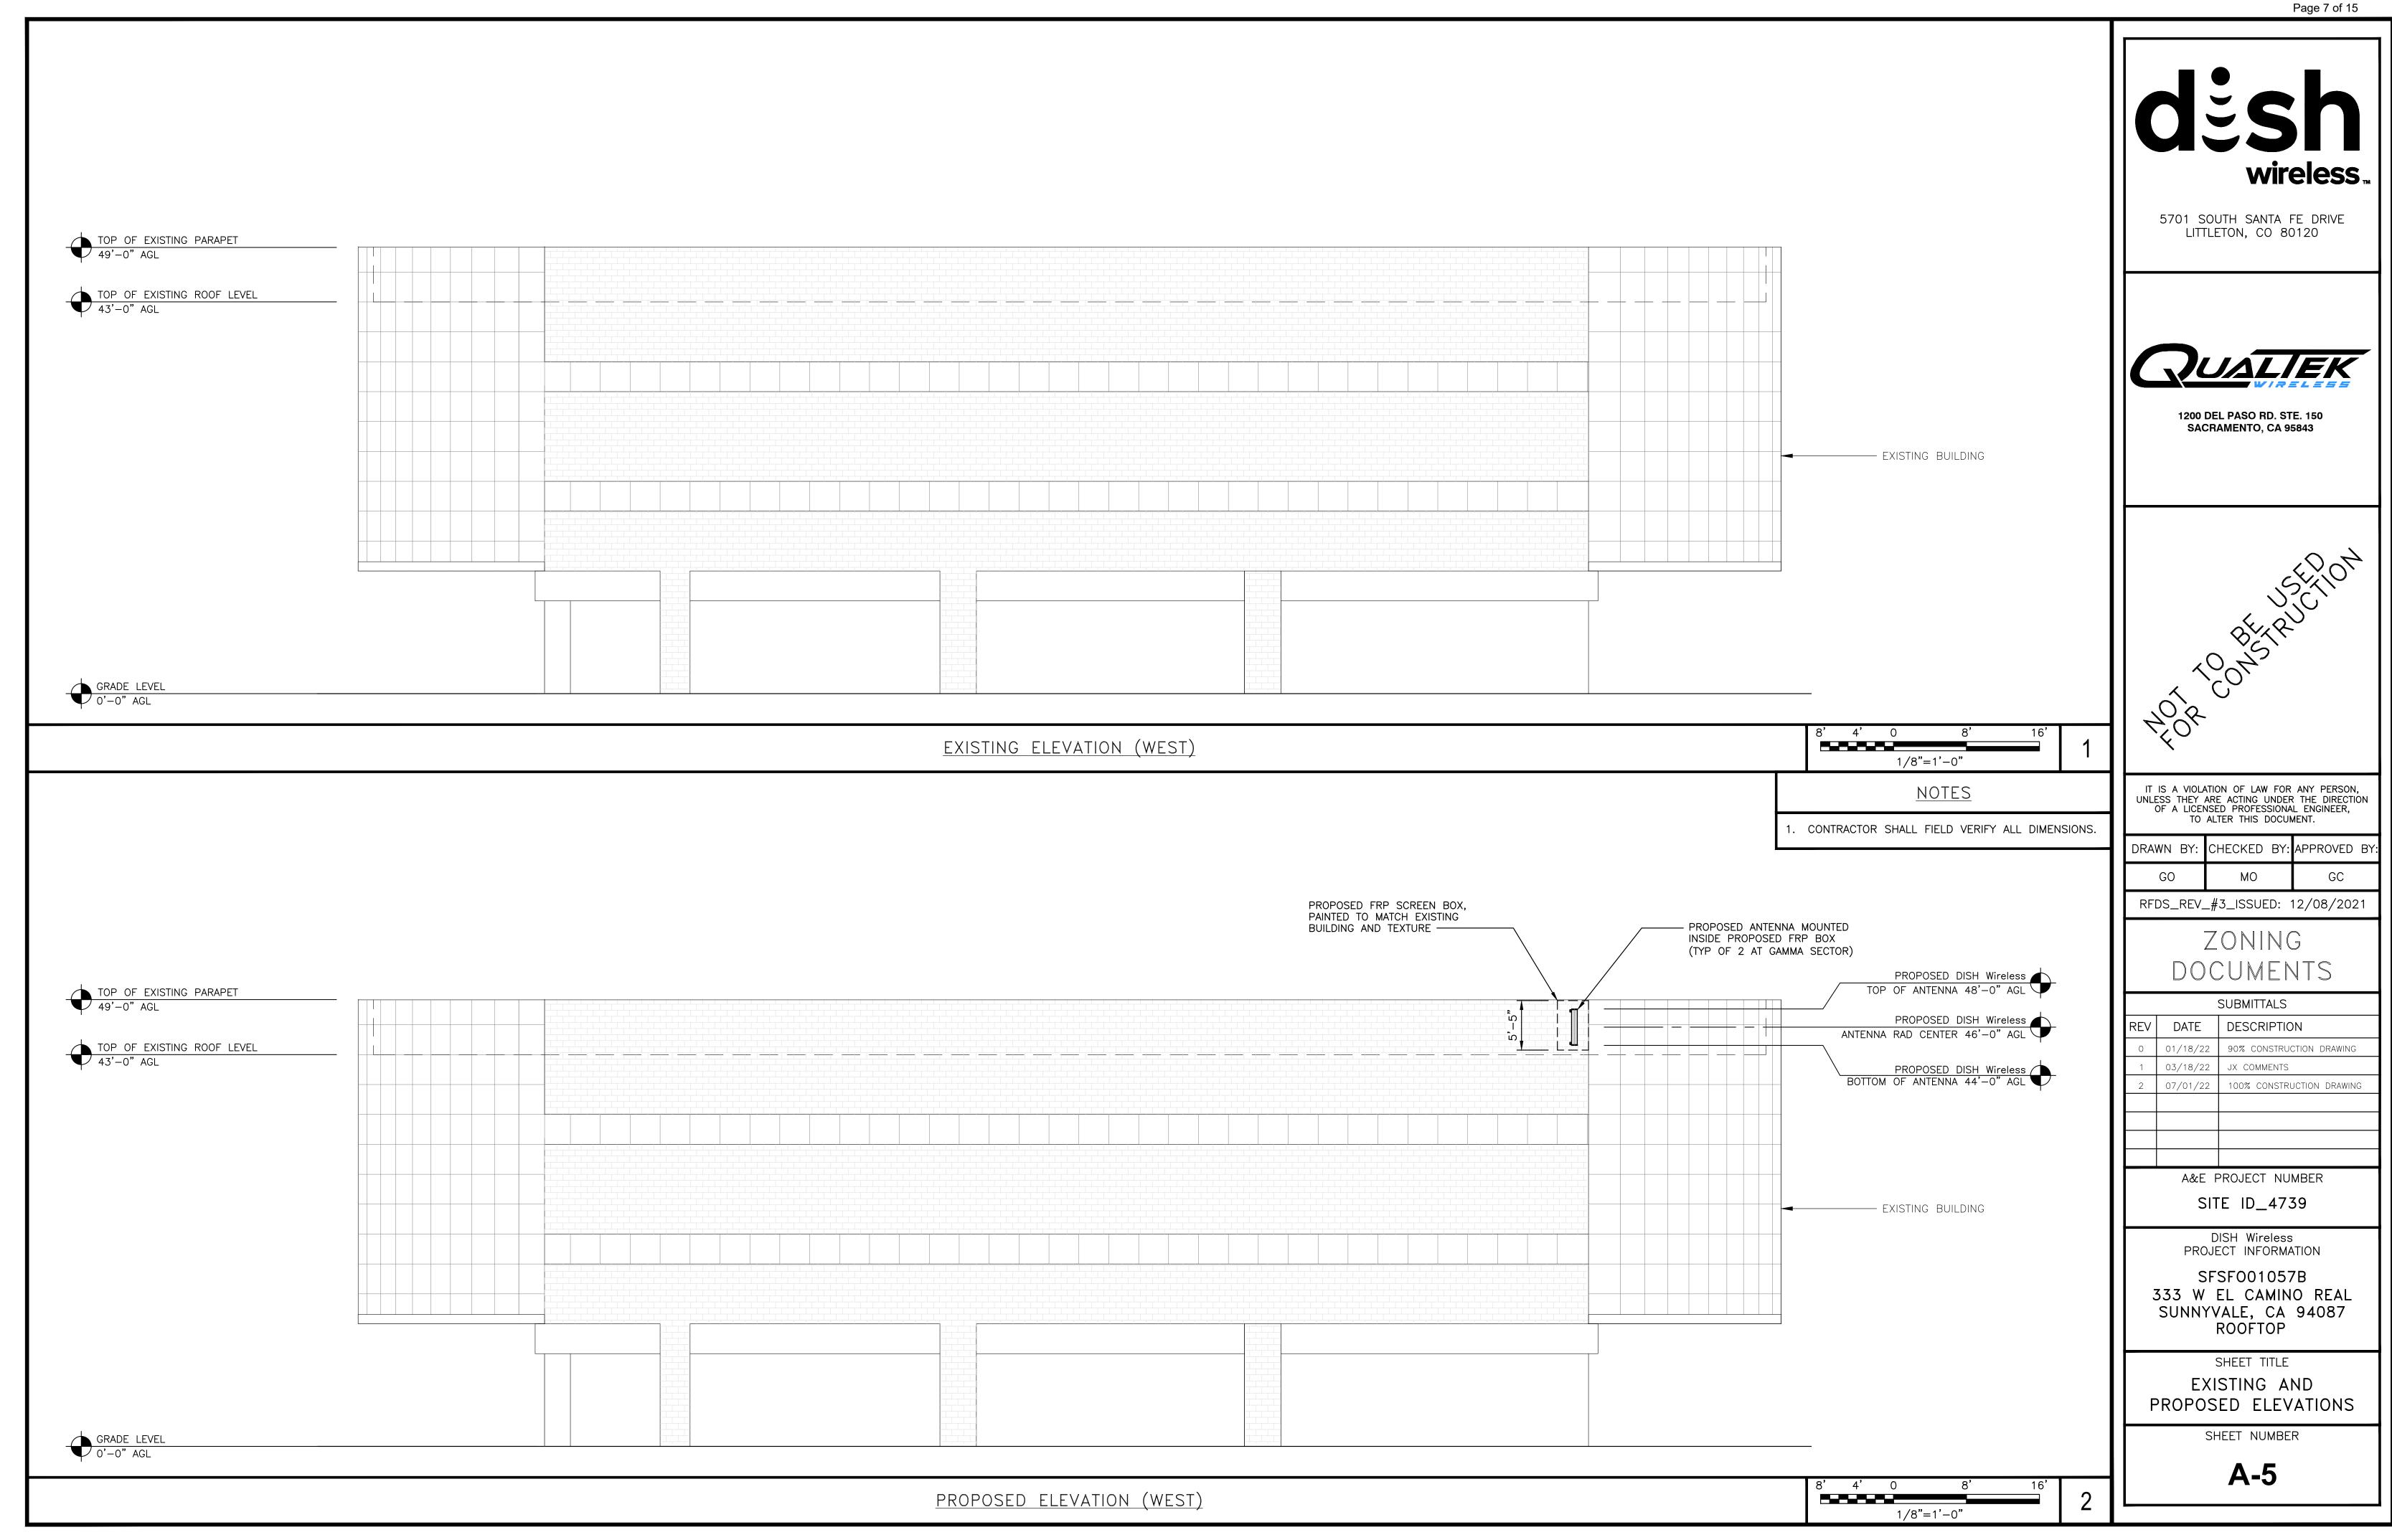

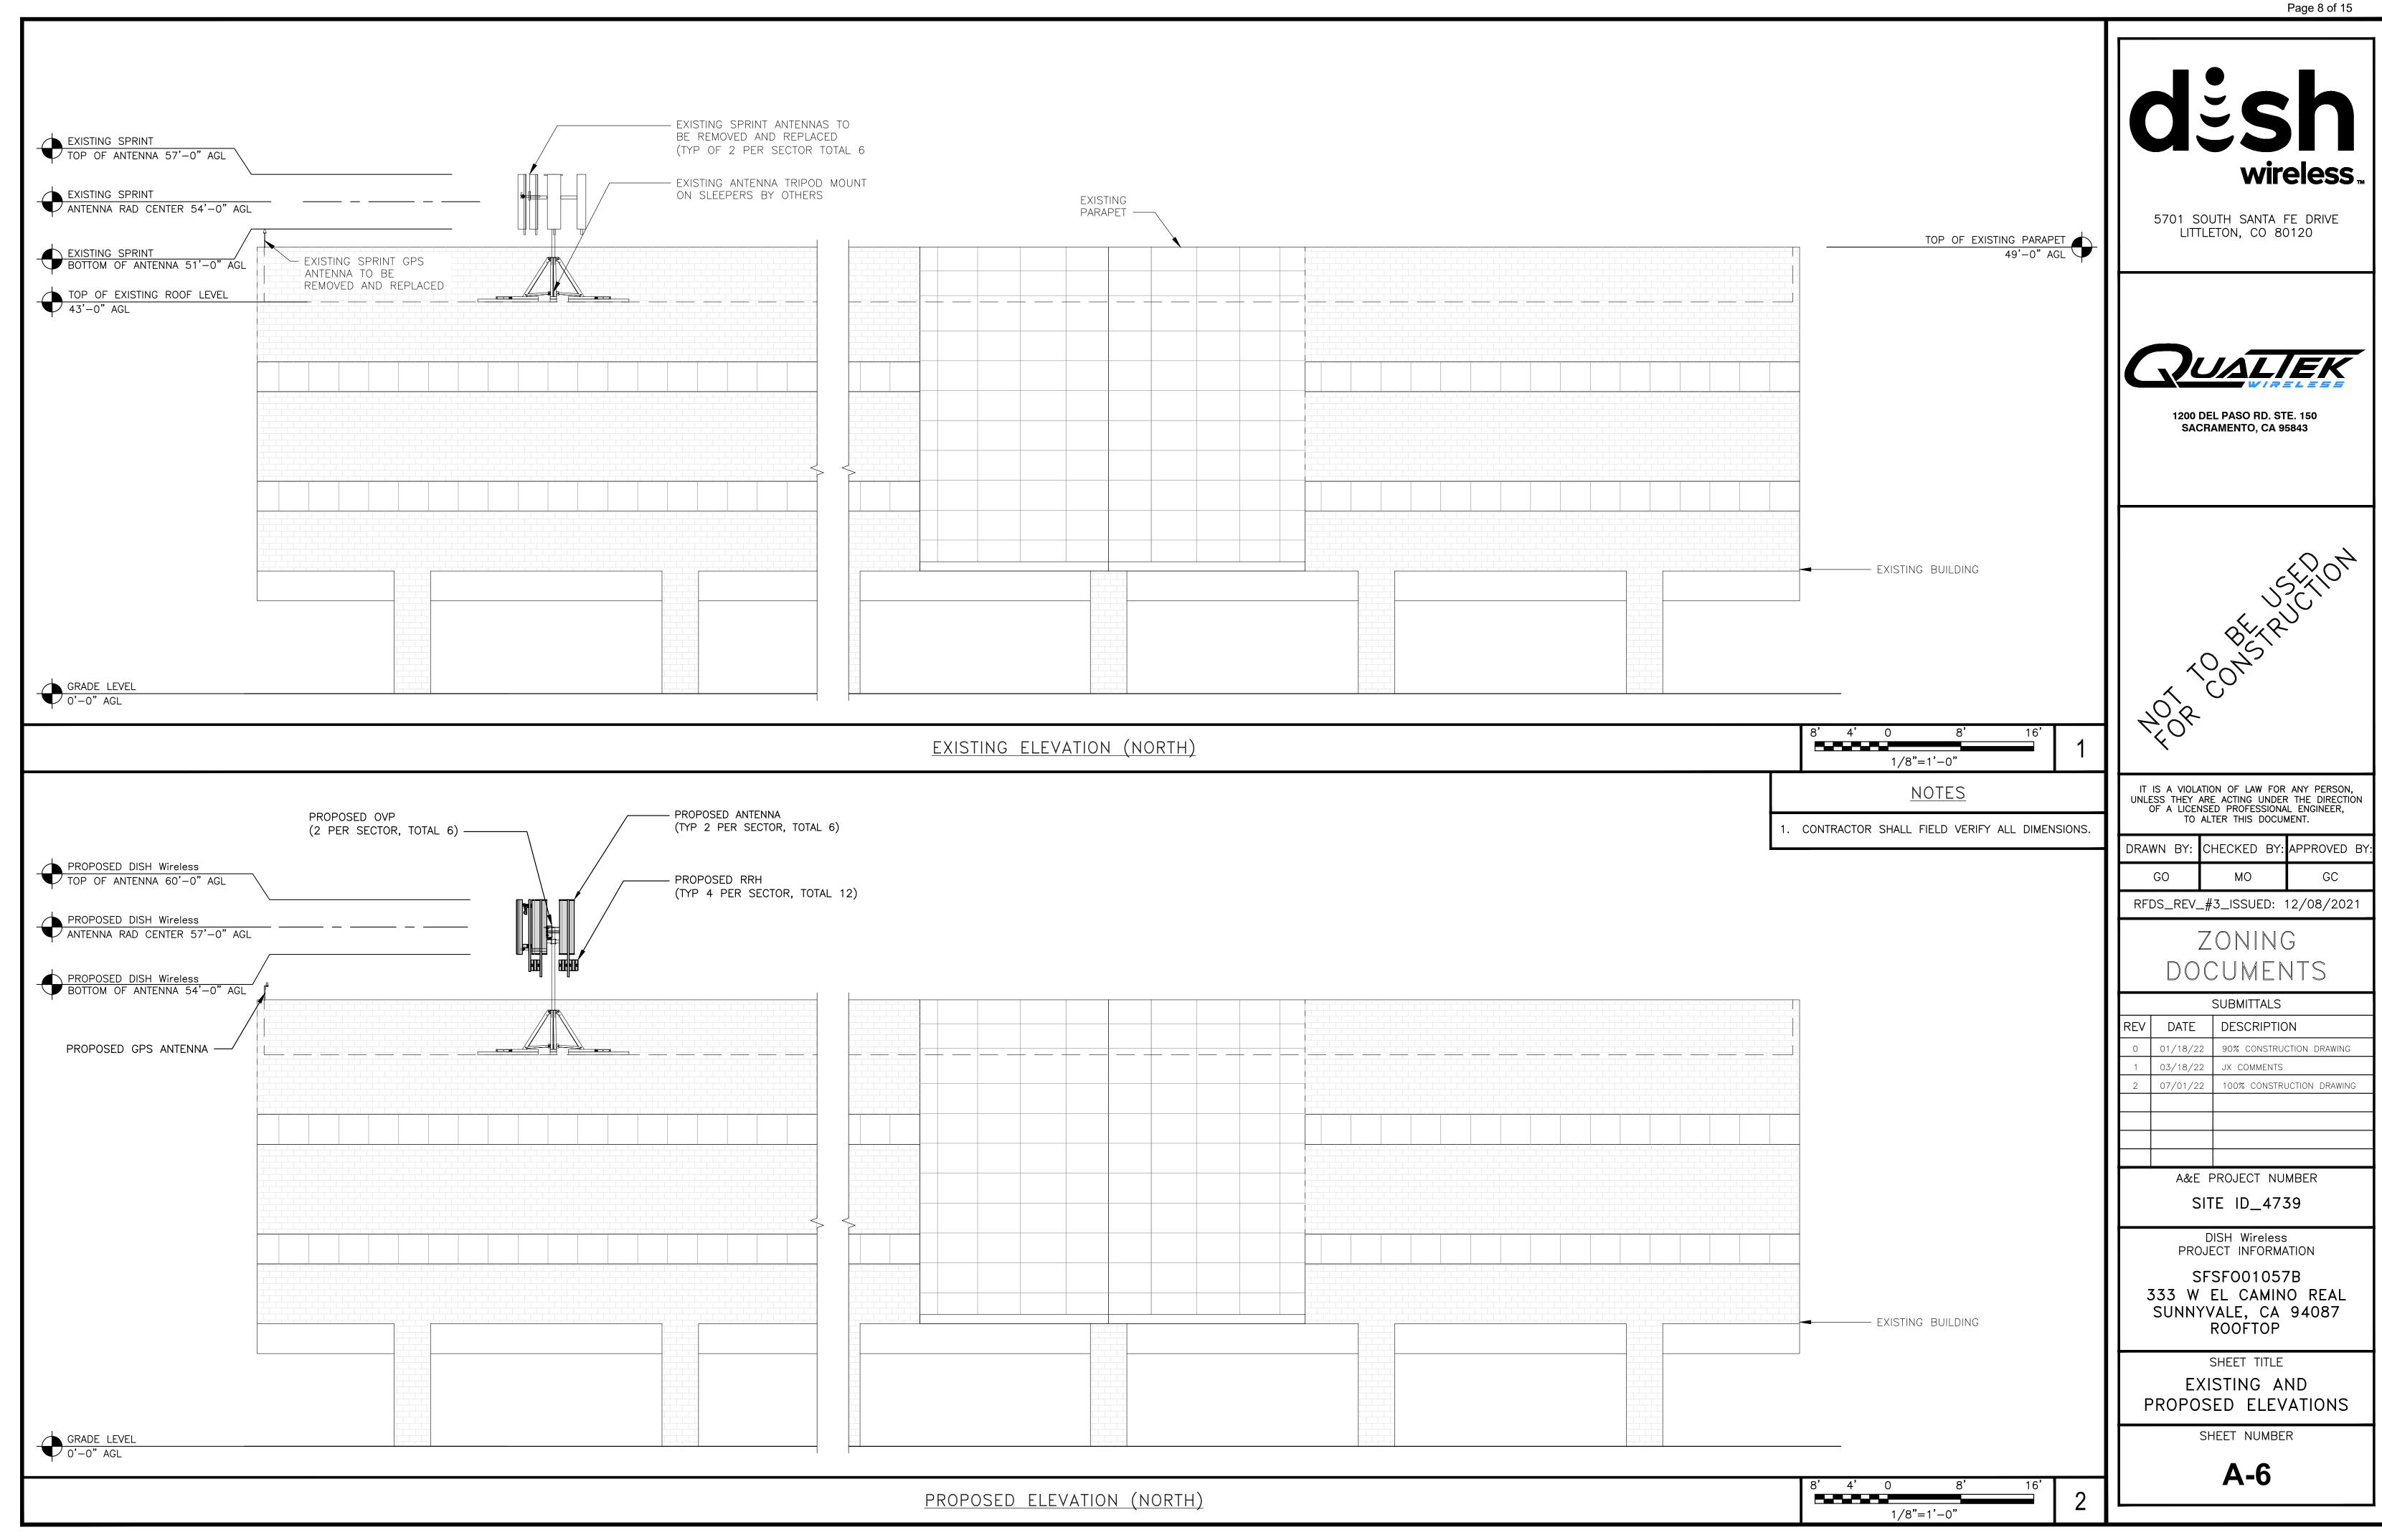

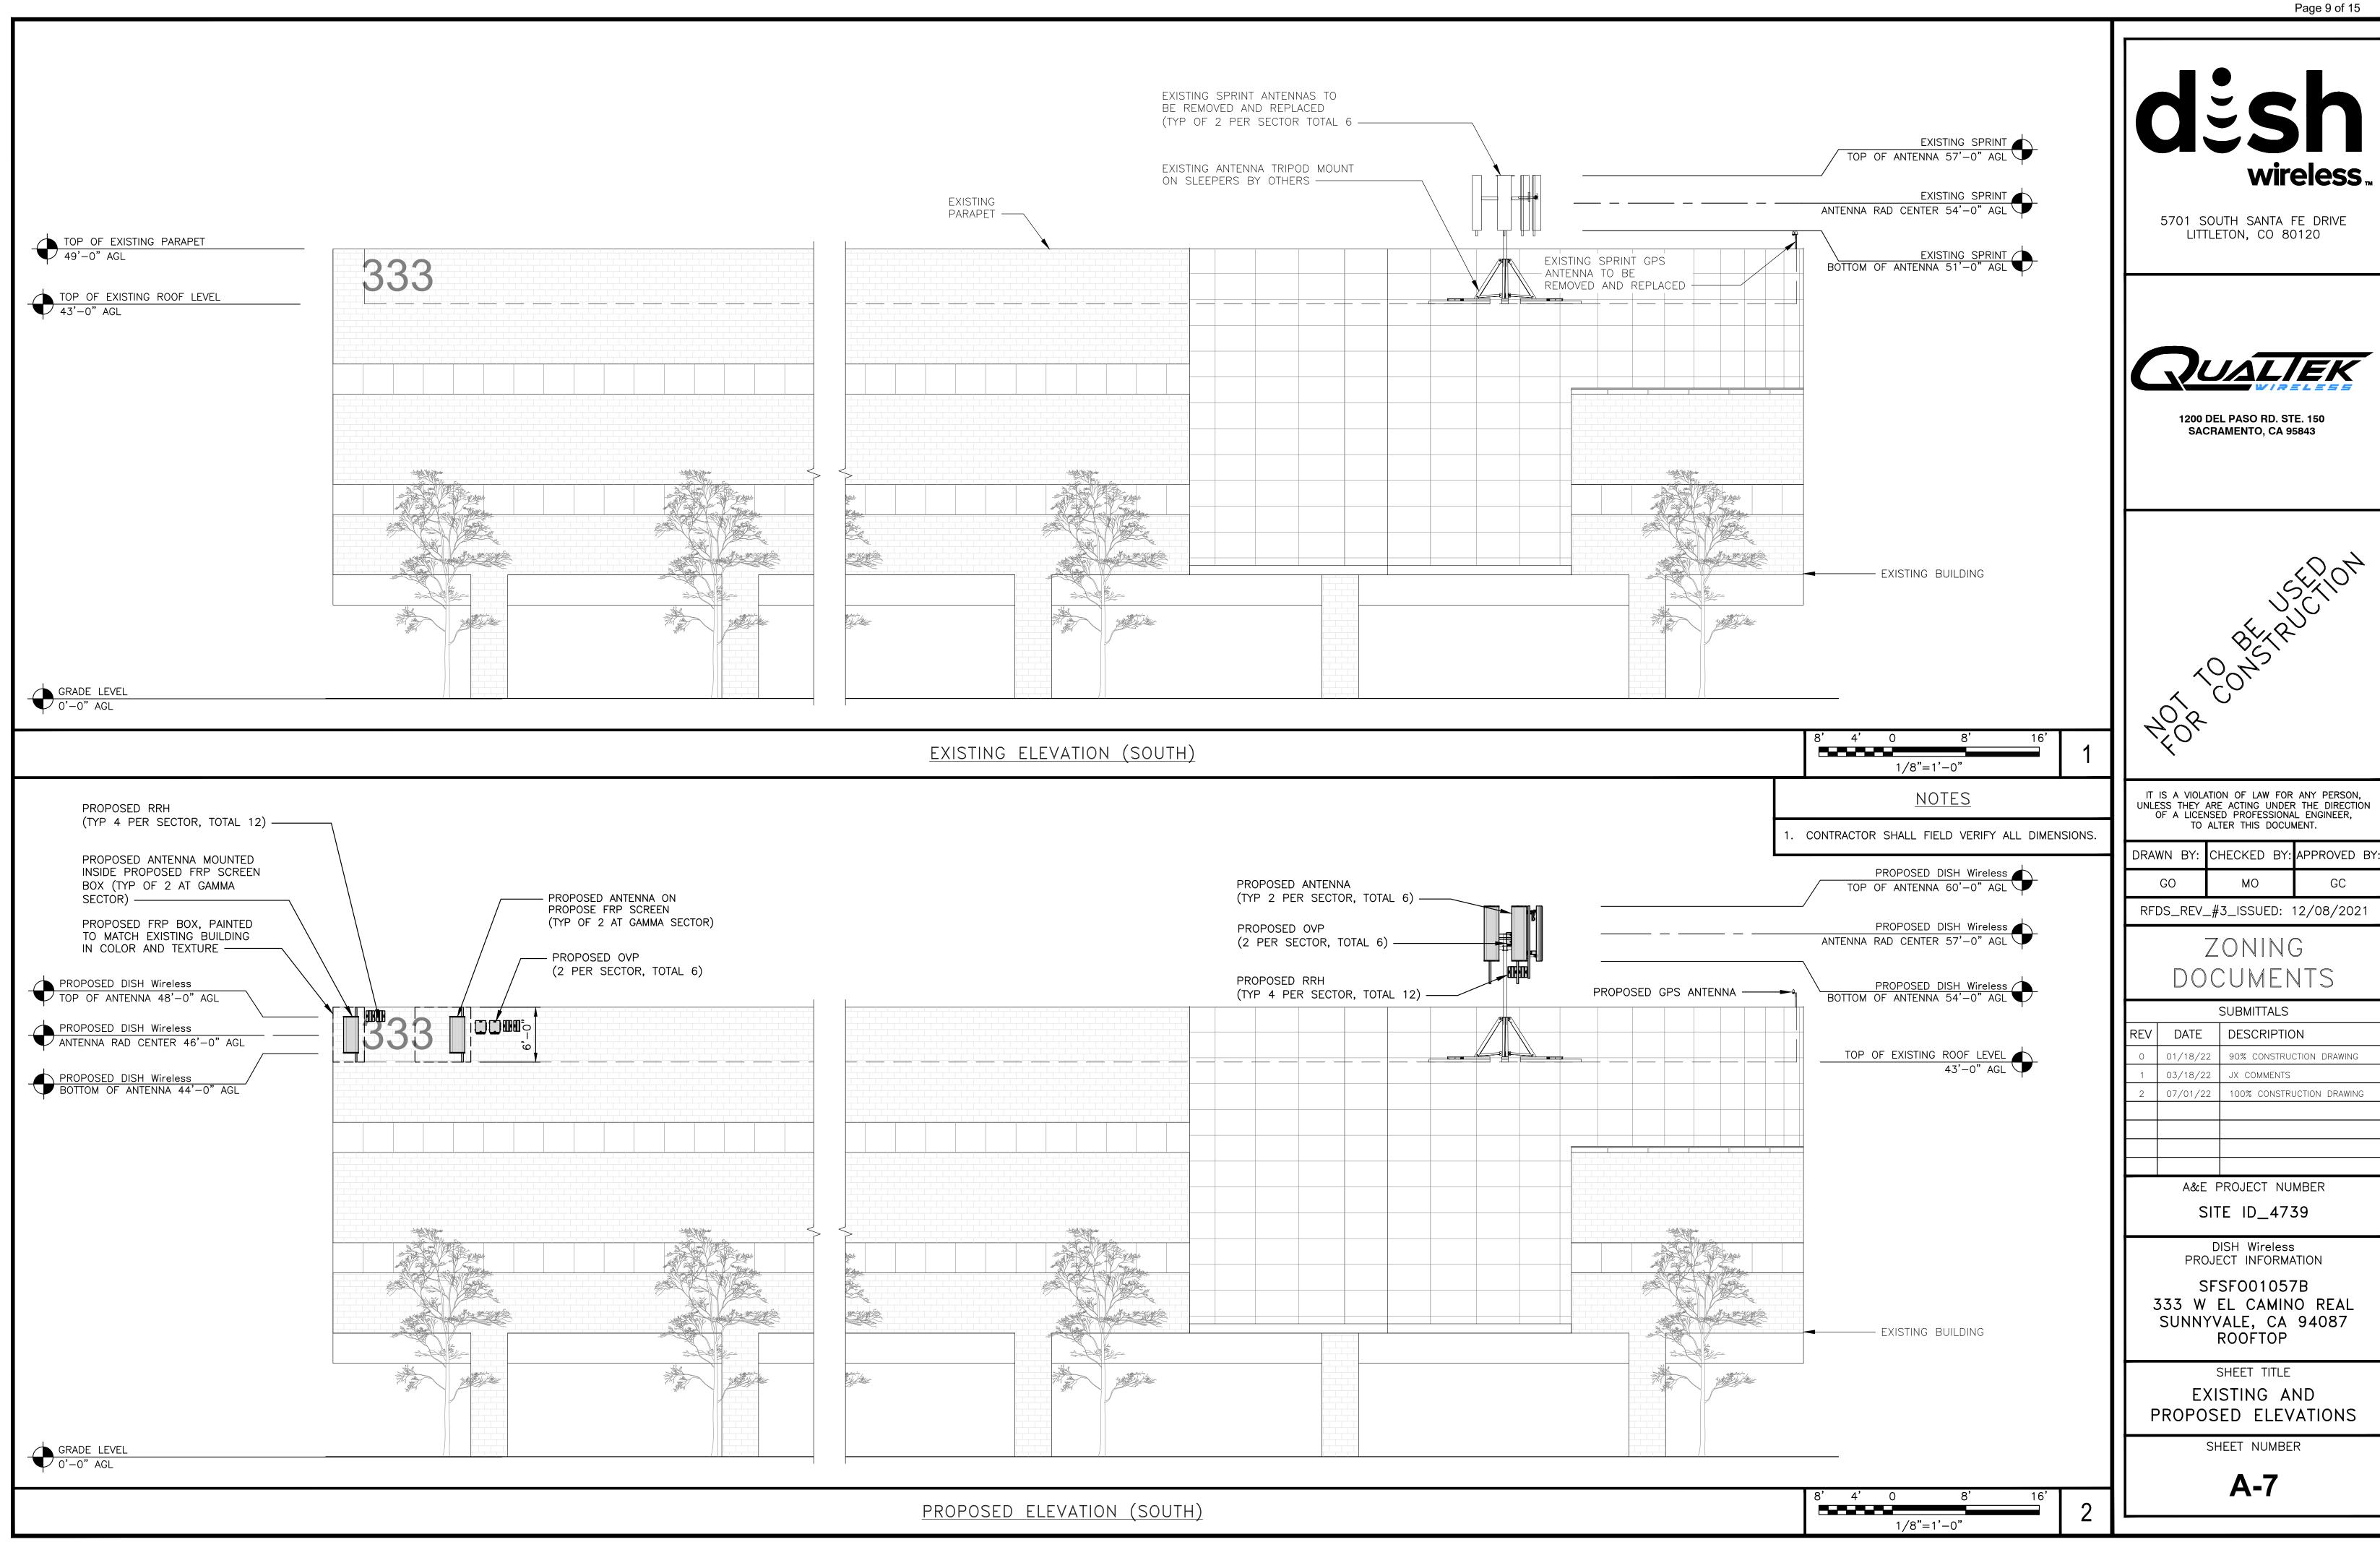

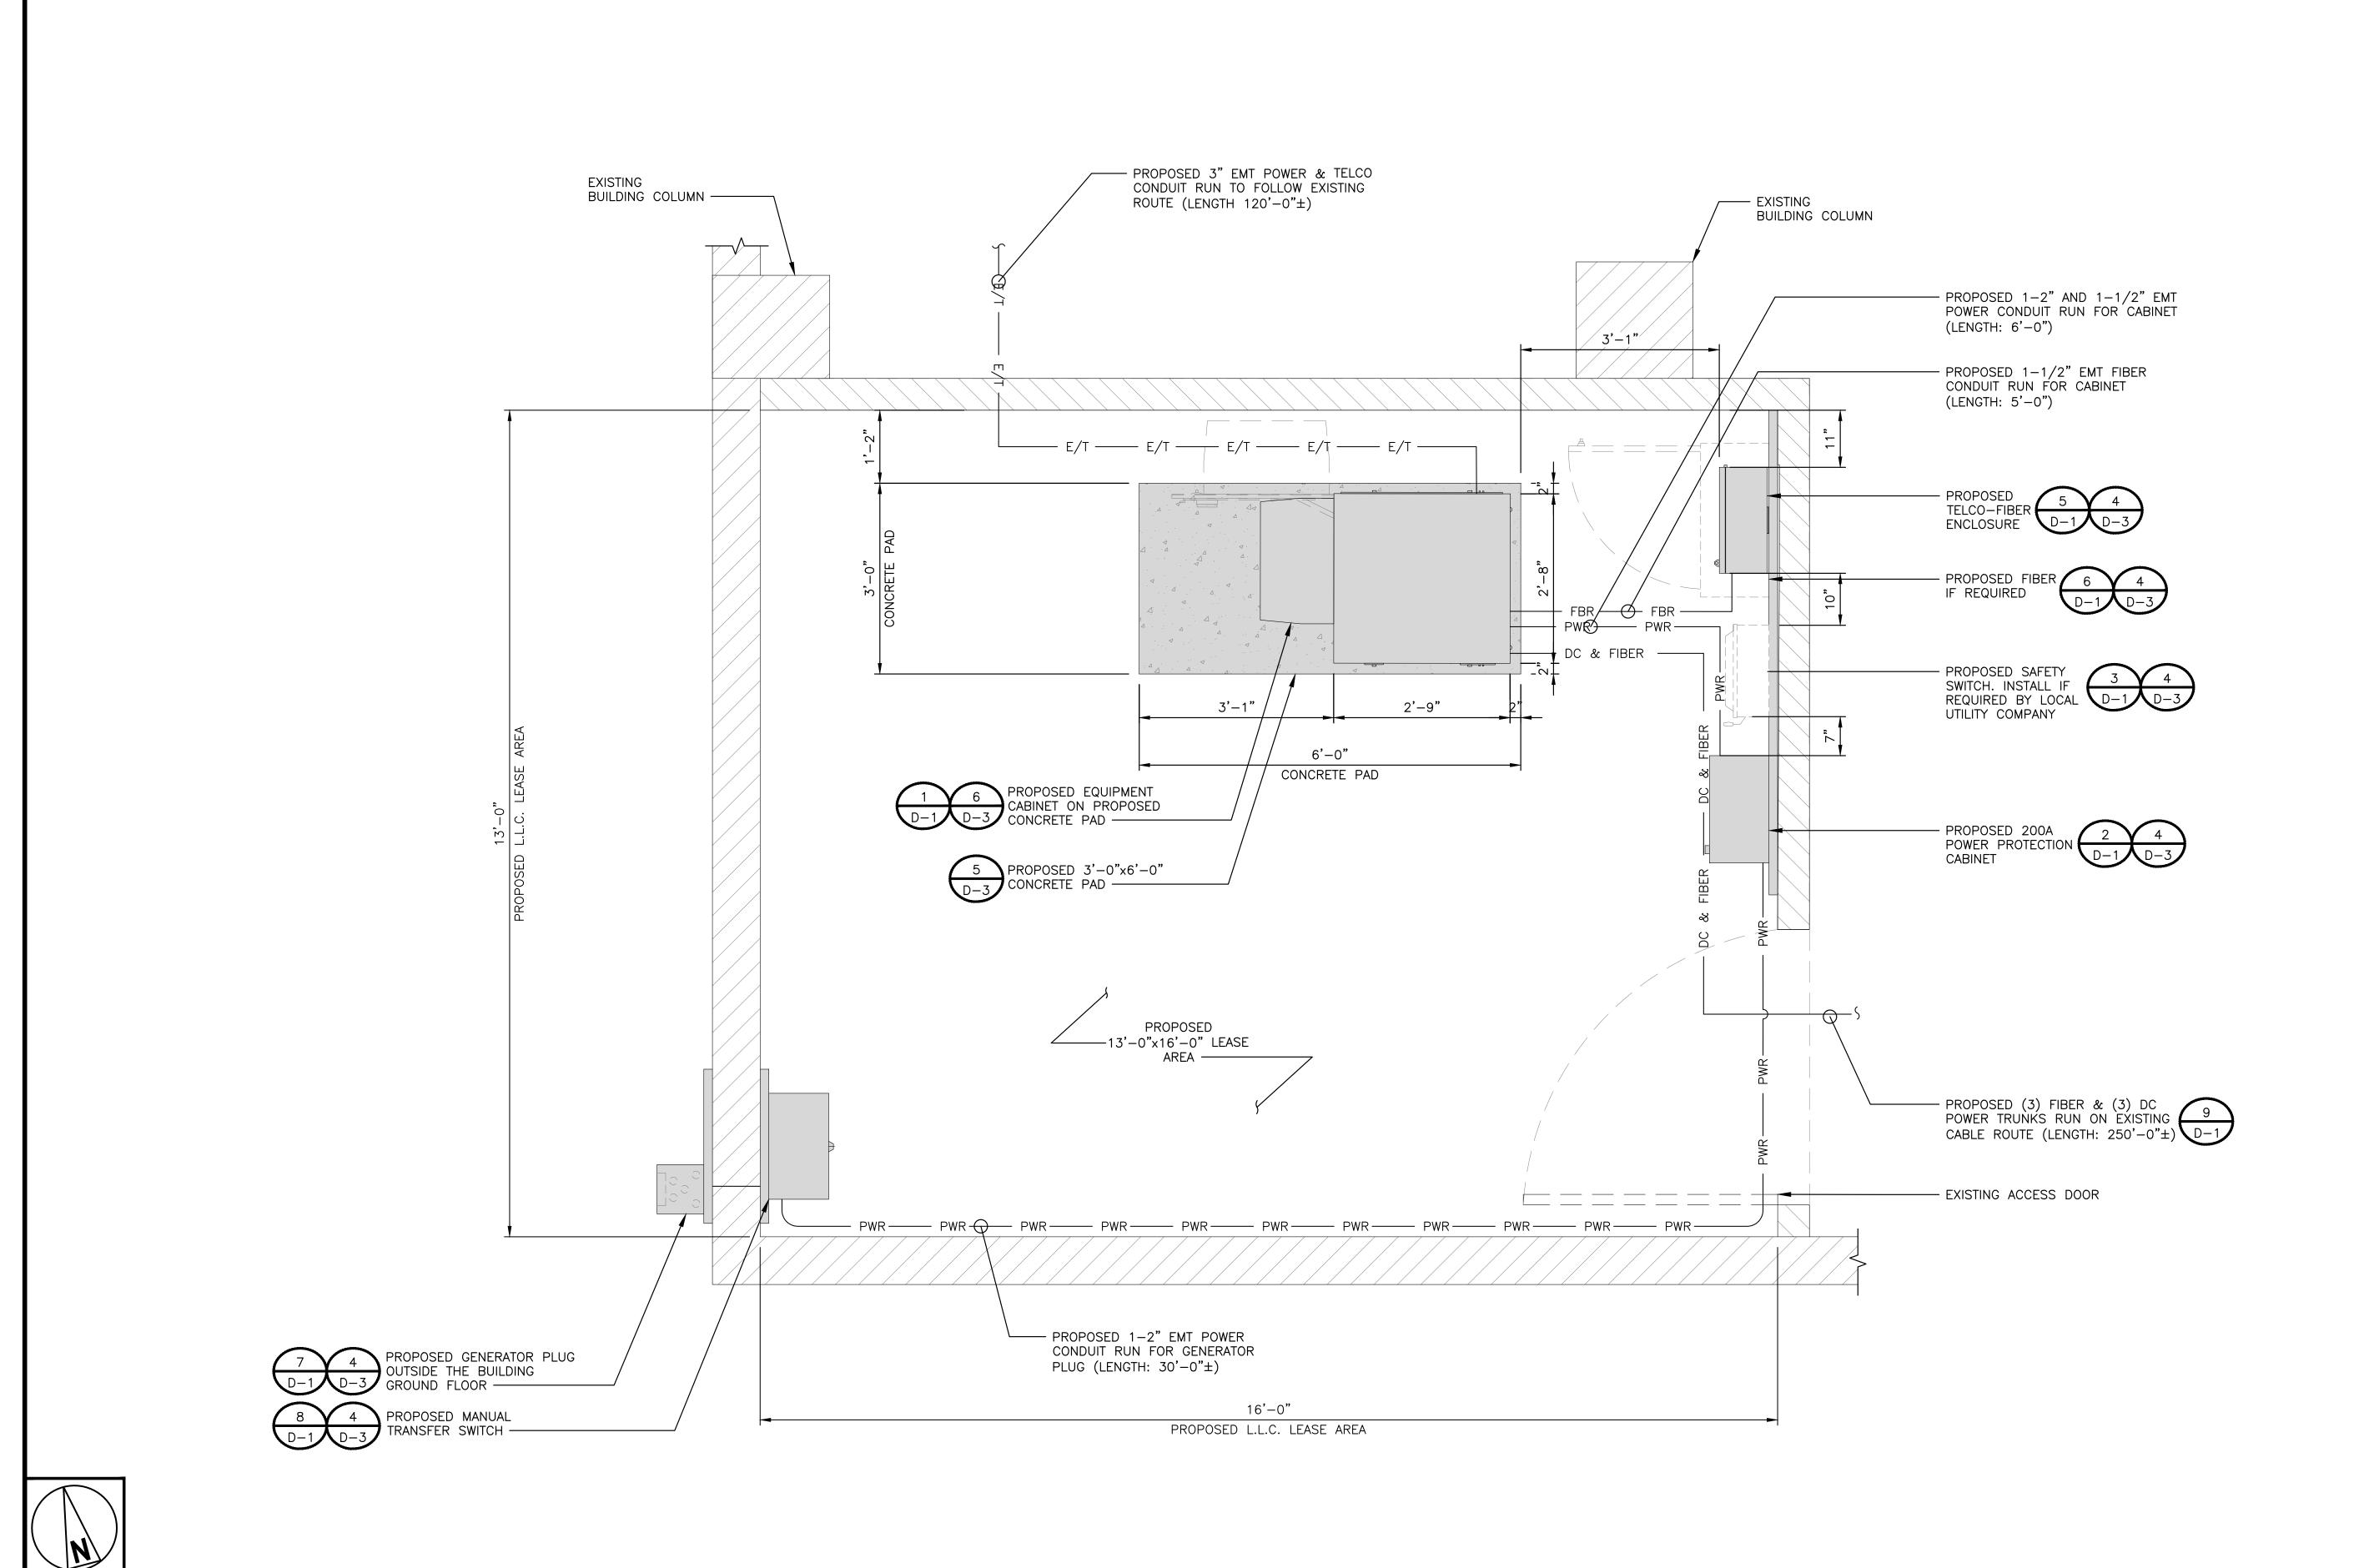



5701 SOUTH SANTA FE DRIVE LITTLETON, CO 80120



1200 DEL PASO RD. STE. 150 SACRAMENTO, CA 95843

HOR SERIES

IT IS A VIOLATION OF LAW FOR ANY PERSON, UNLESS THEY ARE ACTING UNDER THE DIRECTION OF A LICENSED PROFESSIONAL ENGINEER, TO ALTER THIS DOCUMENT.

DRAWN BY:	CHECKED BY:	APPROVED BY
GO	МО	GC

RFDS\_REV\_#3\_ISSUED: 12/08/2021

## ZONING DOCUMENTS

		SUBMITTALS						
ı	REV	DATE	DESCRIPTION					
ı	0	01/18/22	90% CONSTRUCTION DRAWING					
ı	1	03/18/22	JX COMMENTS					
	2	07/01/22	100% CONSTRUCTION DRAWING					
ı								
ı								
ı								

A&E PROJECT NUMBER
SITE ID\_4739

DISH Wireless PROJECT INFORMATION

SFSF001057B 333 W EL CAMINO REAL SUNNYVALE, CA 94087 ROOFTOP

SHEET TITLE

EQUIPMENT PLAN

SHEET NUMBER

3/4"=1'-0"

**A-8** 

EQUIPMENT PLAN @ BASEMENT LEVEL

