

SITE NAME: HWY 101 & 237

PSL NUMBER: 277666

VERIZON WIRELESS REAL-ESTATE:

VERIZON WIRELESS REENGINEER

AGENT - LEASING

AGENT - ZONING

SIGNATURE

787 NORTH MARY AVENUE SITE ADDRESS: **SUNNYVALE, CA 94085**

DATE:

DATE:

SHEET NO

G1

C-2

A2

A3

A4

Α5

Α6

A7

PROJECT INFORMATION & SHEET INDEX

GENERAL NOTES AND ABBREVIATIONS

EOUIPMENT & ANTENNA PLAN

NORTH EAST ELEVATION

SOUTH EAST ELEVATION

SOUTH WEST ELEVATION

NORTH WEST ELEVATON

ANTENNA COLOR CODES

EQUIPMENT & CABLE TRAY LAYOUTS

ANTENNA, RRU & RAYCAP DETAILS

SHEET INDEX

SITE SURVEY

SITE SURVEY

SITE PLAN

ECT INFORMATION SHEET INDEX

PROJE &

Draw/Check B N14027 BLL / EKU

Т1

SITE ADDRESS:

787 NORTH MARY AVE SUNNYVALE, CA 94085

PROPERTY OWNER:

NORTH MARY LLC 3715 HAVEN AVENUE SUITE 210 CONTACT: TJ BIANCHI AND TITO BIANCHI PHONE: (650) 298-0080

PROJECT ARCHITECT:

DIAMOND ENGINEERING SERVICES 4255 PARK ROAD BENICIA, CA 94510 CONTACT: BRUCE LYON, ARCHITECT

PROJECT ENGINEER:

DIAMOND ENGINEERING SERVICES, INC BENICIA, CA 94510 CONTACT: ERIC UHRENHOLT, PE

CONSTRUCTION MANAGER:

NSA WIRELESS, INC SAN RAMON, CA 94583 CONTACT: SCOTT COWAN

ZONING/LEASING AGENT:

NSA WIRELESS, INC. 2010 CROW CANYON PL. STE #355 SAN RAMON, CA 94583 PAMELA NOBEL PHONE: (707) 486-7252

JURISDICTION:

CITY OF SUNNYVALE

COUNTY:

SANTA CLARA COUNTY

APN NUMBER

ELEVATION (NAVD88):

APPLICANT:

wireless

veri on

2785 MITCHELL DRIVE WALNUT CREEK, CA 94598

LATITUDE (NAD83): 37° 23' 56.5" N

LONGITUDE (NAD83): 122° 02' 09.2" W

POWER COMPANY:

PHONE: (800) 743-5000

TELCO COMPANY:

BUILDING CODES

MUNICIPAL CODE

CALIFORNIA FIRE CODE

CAL GREEN CODE

CALIFORNIA BUILDING CODE

CALIFORNIA PLUMBING CODE

CALIFORNIA ELECTRICAL CODE

CALIFORNIA MECHANICAL CODE

STANDARDS CODE AMENDMENTS.

LOCAL BUILDING CODE CITY/COUNTY ORDINANCES



ALL WORK AND MATERIALS SHALL BE PERFORMED AND INSTALLED IN

AS ADOPTED BY THE LOCAL GOVERNING AUTHORITIES. NOTHING IN

TO THE LATEST APPLICABLE VERSION OF THESE CODES.

WORK PERFORMED SHALL COMPLY WITH THE FOLLOWING:

CALIFORNIA ENERGY EFFICIENCY STANDARDS CODE (CEES) 2013

EDITION REVISED JULY 2013, AND ALL APPLICABLE LOCAL & STATE

ORDINANCES CODES AND REGULATIONS AND 2013 CALIFORNIA STATE

EQUIPMENT SHELTER INSPECTED AND APPROVED BY STATE OF

FUEL TANK SUPPORTING GENERATOR SHALL COMPLY THE

REQUIREMENTS OF CHAPTER 57 CFC AND THE SUNNYVALE

CALIFORNIA, NOT SUBJECT FOR LOCAL INSPECTION

COMPLY W/ SUNNYVALE MUNICIPAL CODE.

2013 CALIFORNIA BUILDING CODE (CBC)

ACCORDANCE WITH THE CURRENT EDITIONS OF THE FOLLOWING CODES

THESE PLANS IS TO BE CONSTRUED TO PERMIT WORK NOT CONFORMING

2013 EDITION LIFC

2013 EDITION CBC

2013 EDITION CGC

2013 EDITION IAPMO

2013 EDITION 2008 NEC

VICINITY MAP

FACILITY IS UNMANNED AND NOT FOR HUMAN HABITATION HANDICAPPED ACCESS REQUIREMENTS ARE NOT REQUIRED IN ACCORDANCE WITH THE 2013 CALIFORNIA BUILDING CODE

ADA COMPLIANCE

SIGNATURE DATE: SIGNATURE OF APPROVAL INSTALL NEW VERIZON WIRELESS SHELTER LOCATED IN THE (E) PARKING INSTALL NEW 30kW DIESEL GENERATOR, W/ 132 GALLON, UL. 142 LISTED TANK ON NEW CONCRETE PAD INSIDE FENCED COMPOUND. INSTALL NEW 54'-0" EUCALYPTUS INSIDE NEW FENCED COMPOUND. INSTALL (3) NEW ANTENNAS PER SECTOR TO THE NEW MONO EUCALYPTUS. (3) SECTORS TOTAL, FOR A TOTAL OF (9) ANTENNAS. INSTALL (3) NEW RRUS PER SECTOR TO THE NEW MONOPINE, (3) SECTORS TOTAL, FOR A TOTAL OF (9) RRUS. INSTALL (2) NEW RAYCAPS/SURGE SUPPRESSORS TO THE NEW

DATE

SIGNATURES

VERIZON WIRELESS EQUIPMENT ENGINEER:

VERIZON WIRELESS CONSTRUCTION:

PROPERTY OWNER:

AGENT - CONSTRUCTION

SIGNATURE

PROJECT DESCRIPTION



2785 MITCHELL DRIVE WALNUT CREEK, CA 94598 TEL: (925) 904-3533 FAX: (925) 904-3513

NSA Wireless, Inc. 2010 CROW CANYON PL., STÉ. #355



PROJECT TEAM

SITE INFORMATION

MS-INDUSTRIAL/SERVICE ZONING ZONING CLASSIFICATION: MS-INDUSTRIAL/SERVICE BUILDING TYPE: OCCUPANCY:

FIRE SPRINKLES:

S-2, UNMANNED WIRELESS TELECOMMUNICATIONS FACILITY AN AUTOMATED FIRE SUPPRESSION SYSTEM (FIRE SPRINKLERS) IS NOT REQUIRED.

SITE COMPOUND LEASE AREA: 895± SQ. FT. (21'-10" x 41'-0") 194± SQ. FT. (INCLUDED IN COMPOUND AREA) SHELTER LEASE AREA: TOTAL LEASE AREA

BUILDING DATA

ireles 1. DRIVE

A/C	AIR CONDITIONING	GYP BD	GYPSUM BOARD
AB	ANCHOR BOLT	GII DD	G I I SCIII BONKD
AC	ASPHALTIC CONCRETE	HDR	HEADER
ACI	AMERICAN CONCRETE INSTITUTE	HDG	HOT DIP GALVANIZED
AD	AREA DRAIN	HORIZ	HORIZONTAL
ADDL	ADDITIONAL	HSS	HOLLOW STRUCTURAL SECTION
ADH	ADHESIVE	IDC	INTERNATIONAL DUILDING CODE
ADJ ADJ	ADJACENT ADJUSTABLE	IBC ID	INTERNATIONAL BUILDING CODE INSIDE DIAMETER
AFF	ABOVE FINISHED FLOOR	ISO	INTERNATIONAL STANDARDS
AFG	ABOVE FINISHED GRADE		ORGANIZATION
AFS	ABOVE FINISHED SLAB		
AGL	ABOVE GRADE LEVEL	LBS	POUND
AISC	AMERICAN INSTITUTE OF STEEL	LF	LINEAR FEET (FOOT)
ANIGI	CONSTRUCTION	LONG	LONGITUDINAL
ANSI	AMERICAN NATIONAL STANDARDS	MAY	MAXIMUM
APA	INSTITUTE AMERICAN PLYWOOD ASSOCIATION	MAX MB	MACHINE BOLT
APPROX	APPROXIMATE	MFR	MANUFACTURER
ASSY	ASSEMBLY	MIN	MINIMUM
ASTM	AMERICAN SOCIETY FOR TESTING AND	MISC	MISCELLANEOUS
	MATERIALS	mm	MILLIMETER
AUX	AUXILIARY	MTL	METAL
AVG	AVERAGE	27/1	NOT A PRI TO A PA D
AWS	AMERICAN WELDING SOCIETY	N/A NEC	NOT APPLICABLE NATIONAL ELECTRICAL CODE
B PL	BASE PLATE	NFPA	NATIONAL FIRE PROTECTION
BLDG	BUILDING	MTH	ASSOCIATION
BM	BEAM	NIC	NOT IN CONTRACT
BGL	BELOW GRADE LEVEL	NO	NUMBER
BOS	BOTTOM OF STEEL	NTS	NOT TO SCALE
BOT	BOTTOM		
		OC	ON CENTER
C	CHANNEL	OD	OUTSIDE DIAMETER
CB	CARRIAGE BOLT	OPP	OPPOSITE
CB	CATCH BASIN	OSHA	OCCUPATIONAL SAFETY AND
CIP CJ	CAST-IN-PLACE CONSTRUCTION JOINT		HEALTH ADMINISTRATION
CI	CONTROL JOINT	PERP	PERPENDICULAR
CL	CENTER LINE	PL	PROPERTY LINE
CLG	CEILING	PLYWD	PLYWOOD
CLR	CLEAR	PN	PART NUMBER
CMP	CORRUGATED METAL PIPE	POC	POINT OF CONNECTION
CMU	CONCRETE MASONRY UNIT	PRELIM	PRELIMINARY
CO	CLEANOUT	PREP	PREPARATION
COL	COLUMN	PT	PRESSURE TREATED
CONFIG	CONFIGURATION	OTT /	OLI A NITERITY
CONN CONT	CONNECT CONTINUE	QTY	QUANTITY
CSK	COUNTER SUNK	R	RADIUS
CU	CUBIC	REINF	REINFORCE
CU FT	CUBIC FEET	REOD	REQUIRED
CU IN	CUBIC INCH	REV	REVISION
CU YD	CUBIC YARD	RM	ROOM
DBL	DOUBLE	SCHED	SCHEDULE
DEG DET	DEGREE DETAIL	SF SHT	SQUARE FOOT (FEET) SHEET
DIA	DIAMETER	SIM	SIMILAR
DIAG	DIAGONAL	SPEC	SPECIFICATION
DIM	DIMENSION	SQ	SQUARE
DIR	DIRECTION	SQ IN	SQUARE INCH
DJ	DOUBLE JOIST	SQ YD	SQUARE YARD
DL	DEAD LOAD	SS	STAINLESS STEEL
DP	DIAMOND PLATE	ST	STREET
DS	DOWNSPOUT DRAWING	STA	STATION
DWG	DRAWING	STD	STANDARD
Е	EAST	T&B	TOP AND BOTTOM
EA	EACH	T&G	TONGUE AND GROOVE
EL	ELEVATION	TEMP	TEMPORARY
ELEV	ELEVATION	THK	THICKNESS
EMBED	EMBEDMENT	TOB	TOP OF BEAM
EP	EDGE OF PAVEMENTS	TOC	TOP OF CONCRETE
EQ	EQUAL	TOFF	TOP OF FINISH FLOOR
EQUIP	EQUIPMENT	TOF	TOP OF FOOTING
ETC	ET CETERA	TOPO	TOPOGRAPHY
EW	EACH WAY	TOS	TOP OF STEEL
FDN	FOUNDATION	TOS TOW	TOP OF STEEL TOP OF WALL
FIN	FINISH	TS	TUBE STEEL
FIN. FLR.	FINISH FLOOR	TYP	TYPICAL
FIN GR	FINISH GRADE		
FLR	FLOOR	UON	UNLESS OTHERWISE NOTED
FOC	FACE OF CONCRETE		
FOS	FACE OF SLAB	VIF	VERIFY IN FIELD
FOS	FACE OF STUD		
FOW	FACE OF WALL	W	WATT
FRP	FIBERGLASS REINFORCED PLASTIC	W/	WITH
FSTNR	FASTENER FOOT (FEET)	W/O	WITHOUT
FT	FOOT (FEET) FOOTING	WF	WIDE FLANGE WORKING POINT
FTG	FOOTING	WP WWF	WORKING POINT WELDED WIDE EARDIC
GA	GAGE	WWF	WELDED WIRE FABRIC
GA GALV	GAGE GALVANIZED	ę.	CENTERLINE
GL	GRADE LEVEL / GROUND LEVEL	ų. P	PLATE
GLZ	GLAZING	±	PLUS OR MINUS
GSM	GALVANIZED SHEET METAL	(E)	EXISTING

	R L	

THESE PLANS ARE A BUILDER'S SET. DES BUILDERS WAS CONTRACTED TO PROVIDE A BUILDER'S SET WITH THE AGREEMENT THAT AN EXPERIENCED AND KNOWLEDGEABLE CONTRACTOR SHALL CONSTRUCT THIS PROJECT. THE PLANS CONTAIN INFORMATION FOR GENERAL CONSTRUCTION AND BUILDING PERMIT PURPOSES ONLY AND ARE NOT EXTENSIVELY DETAILED NOR ARE SPECIFICATIONS PROVIDED. FOR ITEMS, METHODS AND/OR MATERIALS NOT SHOWN, THE MINIMUM REQUIREMENT OF THE 2013 CBC SHALL GOVERN. ANY OR PART OF ALL SYSTEMS, MATERIALS, CONNECTIONS, AND DETAILS NOT SPECIFICALLY PROVIDED IN THESE PLANS ARE THE SOLE AND COMPLETE RESPONSIBILITY OF THE CONTRACTOR TO PROPERLY VERIFY AND INSTALL. THE ENGINEER DOES NOT PROVIDE CONTINUOUS CONSTRUCTION OBSERVATION. THE

CONTRACTOR IS SOLELY RESPONSIBLE FOR THE QUALITY AND CONSTRUCTION STANDARDS FOR THIS PROJECT. THE ENGINEER AND ARCHITECT ARE NOT RESPONSIBLE FOR CONSTRUCTION COST DUE TO REVISIONS TO THE DRAWINGS.

JOB SAFETY:

THE ENGINEER IS NOT RESPONSIBLE FOR THE FABRICATION, ERECTION, AND/OR JOB SAFETY. THE CONTRACTOR SHALL COMPLY WITH ALL LOCAL, STATE AND FEDERAL SAFETY REGULATIONS. THE CONTRACTOR SHALL BE SOLELY RESPONSIBLE FOR THE DESIGN AND INSTALLATION OF ALL SHORING, BRACING, FORM WORK, ETC., AS REQUIRED FOR THE PROTECTION OF LIFE AND PROPERTY DURING THE CONSTRUCTION OF THE BUILDING.

SHOP DRAWINGS ARE AN AID FOR FIELD PLACEMENT AND ARE SUPERSEDED BY THE ARCHITECTURAL DRAWINGS. IT SHALL BE THE CONTRACTORS RESPONSIBILITY TO MAKE CERTAIN THAT THE SHOP DRAWINGS AND CONSTRUCTION ARE IN CONFORMANCE WITH THE LATEST ARCHITECTURAL AND STRUCTURAL DRAWINGS. AT LEAST 3 WEEKS BEFORE FABRICATION, THE CONTRACTOR SHALL SUBMIT ALL SHOP DRAWINGS TO THE ENGINEER / ARCHITECT FOR REVIEW TO DETERMINE GENERAL COMPLIANCE WITH THE DRAWINGS. OUR REVIEW DOES NOT GUARANTEE IN ANY WAY THAT THE SHOP DRAWINGS ARE IN COMPLIANCE WITH THE LATEST DRAWINGS.

SITE OBSERVATIONS

THE CONTRACTOR SHALL GIVE ENGINEER 72 HOURS MINIMUM NOTICE AS TO THE TIME OF THE SITE OBSERVATION OR SPECIAL INSPECTION FOR ANY OBSERVATION REQUIRED BY C.B.C. 2013 CHAPTER 17A. ALL WRITTEN SITE OBSERVATIONS / INSPECTIONS REPORTS BY THE REGULATORY AGENCY SHALL BE COPIED TO THE ENGINEER.

FOUNDATION:

DESIGN WAS BASED ON THE MINIMUM REQUIREMENTS OF CHAPTER 18 IN THE CBC.

- DIMENSIONS SHOWN ON THE DRAWINGS TAKE PRECEDENCE OVER SCALED MEASUREMENTS. DO NOT SCALE DRAWINGS.
- PLAN DIMENSIONS ARE TAKEN FROM FACE OF SURFACE TO FACE OF SURFACE OR GRID
- PLAN DIMENSIONS ARE TAKEN FROM FACE OF STRUCTURE, FINISH OR GRID LINE,
- UNLESS OTHERWISE NOTED. TYPICAL FOR FLOOR PLANS AND DETAILS.
 4. DETAILS ARE DIAGRAMMATICAL AND MAY DIFFER IN SCALE FROM PROPOSED
- DETAILED DRAWINGS AND LARGER SCALE DRAWINGS TAKE PRECEDENCE OVER SMALL SCALE DRAWINGS. DETAILS LABELED TYP (TYPICAL) SHALL BE FABRICATED AT ALL LIKE CONDITIONS THROUGHOUT THE PROJECT UNLESS OTHERWISE NOTED. DETAILS LABELED SIM
- (SIMILAR) SHALL BE FABRICATED WITH MINOR DIFFERENCES AS SHOWN IN THE DETAIL. FOR DETAILS NOT SHOWN, USE THE MANUFACTURER'S STANDARD DETAILS OR APPROVED SHOP DRAWINGS/DATA SHEETS IN ACCORDANCE WITH THE PROJECT
- SHOP DRAWINGS ARE SUPERSEDED BY THESE DRAWINGS UNLESS APPROVED BY ENGINEER.
- THE CONTRACTOR SHALL VERIFY AND BE RESPONSIBLE FOR ALL DIMENSIONS AND CONDITIONS ON THE JOB AND SHALL NOTIFY THE ARCHITECT/ENGINEER OF ANY DISCREPANCIES BEFORE COMMENCING ANY WORK.
- CONTRACTOR SHALL BE RESPONSIBLE FOR ALL METHODS OF FABRICATION. SHORING, SCAFFOLDING, FORMWORK, ETC., MAY REQUIRE ADDITIONAL STRUCTURAL DESIGN.
- THE CONTRACTOR SHALL PROVIDE, LOCATE, AND INSTALL ACCESS PANELS AS REQUIRED AFTER INSTALLATION OF MECHANICAL AND ELECTRICAL WORK.
- 12. ALL EQUIPMENT, DEVICES, FIXTURES AND MATERIALS SHALL BE LISTED BY AN

APPROVED TESTING AGENCY.

- 13. ALL MATERIAL SYSTEMS SHALL BE NON-COMBUSTIBLE WITH A FLAME SPREAD RATIO OF 25 OR LESS, SMOKE DEVELOPING RATING OF 50 OR LESS THAN A FUEL CONTRIBUTING OF ZERO.
- CONNECTING HARDWARE SHALL BE RATED FOR OPERATION UNDER AMBIENT CONDITIONS OF -40 TO 140 DEGREES FAHRENHEIT AND IN THE RANGE OF 0 TO 100 PERCENT RELATIVE HUMIDITY.
- 15. THE SITE PLAN IS NOT BASED ON A SURVEY AND SHALL ONLY BE USED FOR THE SCOPE
- OF WORK SHOWN IN THESE DRAWINGS.

 16. FABRICATED STEEL PARTS, PIPE, BOLTS, PLATE WASHERS AND STEEL SECTIONS SHALL BE HOT DIPPED GALVANIZED. SHEET METAL SHALL BE GALVANIZED.

GENERAL NOTES

- 1. ADDITIONAL CONTRACTOR SUBMITTALS: UPON REQUEST, CERTIFICATION THAT THE MATERIALS BEING USED MEET THE REQUIREMENTS SPECIFIED.
- MANUFACTURER'S DATA FOR: GROUTS AND EPOXIES, PREFAB. WOOD TRUSSES, CALCULATIONS AND DRAWINGS.
- OBSERVATION: THE ENGINEER WILL VISIT THE PROJECT SITE AS DICTATED BY CONSTRUCTION PROGRESS TO MAKE GENERAL OBSERVATIONS ON THE WORK FOR GENERAL CONFORMANCE TO THE DESIGN INTENT.
- GENERAL: THE CONTRACTOR SHALL BE RESPONSIBLE FOR THE QUALITY OF ALL MATERIALS USED ON THE PROJECT AND SHALL BEAR THE BURDEN OF PROOF THAT THE MATERIALS USED COMPLY WITH THE PROJECT REQUIREMENTS.

CODE		2013 EDITION.	ING CODE (CBC),
RESOURCE		ASCE/SEI 7-10 (FOR S	SEISMIC)
BUILDING DATA:		TABLE VALUE	
OCCUPANCY GROU	P:	S-2	
CONSTRUCTION TY	PE	N/A	
FIRE SPRINKLERS		FIRE SPRINKLERS A	RE NOT REQUIRED
DESIGN LOADS			
FLOOR LOAD		N/A	
ROOF LOAD		N/A	
GROUND SNOW LOA	AD Pg=	N/A	
BASIC WIND SPEED		110	
WIND EXPOSURE		С	
SEISMIC DESIGN CA	TEGORY	D	
SITE CLASS		D	
FLOOD DESIGN LOA	AD.		
SEISMIC IMPORTAN	CE FACTOR=	I=1.0	
SEISMIC OCCUPANO	CY GROUP	III TABLE 1-1	
N	MAPPED SPECTRAL RES	PONSE ACCELERATION	IS
Ss=1.500 g	Sms=1.500 g	Sds=1.000 g	S1=0.600 g
SM1=0.900 g	Sd1=0.600 g		
	SPECTRAL RESPON	NSE COEFFICIENTS	
·		Fa=1.0	Fv=1.5

	CALIFORNIA BUILD	ING CODE (CBC),		88	277666	787 NORTH MARY AVENUE	4085		GENERAL NOTES AND	ABBREVIATIONS	
	2013 EDITION.			VERIZON WIREI ESS	#	3	6		Ë	\cong	
	ASCE/SEI 7-10 (FOR	SEISMIC)	_	₽	Ğ	A	; O		0	<u>⋖</u>	
	TABLE VALUE S-2		_	}	23.	È	뿌		Z	>	
	N/A		- I] 5	ું જ	Ξ	\$		┧	2	
	FIRE SPRINKLERS A	RE NOT REQUIRED	- I	1 5	5	ĸ	≽		2	窗	
				[įĒ	Z	Ξ		Ш	Ø	
	N/A		⊺ I	1	` {	≿	ร		z	⋖	
	N/A		7 I		Í	2			뽔		
	N/A		⊤ I						U		
	110		7 I								
	С										
	D										
	D										
			」 Ⅰ		(-)	4	4	4	4	15	Г
	I=1.0		_ I	ı	DATE	1-20	1-20	1-20	3-20	9-20	
	III TABLE 1-1		⊣ I		Ď	07-24-2014	08-01-2014	08-04-2014	08-08-2014	02-09-2015	
AL RE	SPONSE ACCELERATION	NS	1 I						-	0 1	H
g	Sds=1.000 g	S1=0.600 g		REVISIONS	z			5	-	PER PLAN COMMENT	
g			⊣	Ιŝ	DESCRIPTION	FOR REVIEW	FOR REVIEW	FOR REVIEW	FOR REVIEW	MM	
	ONSE COEFFICIENTS		- I	I≅	RIP	REV	REV	REV	REV	CC	
KESP	Fa=1.0	Fv=1.5	- I	Ιώ	SC	OR I	OR I	OR I	OR I	LAN	
	Fa=1.0	FV=1.3	」	14	ā	F(F(Ĭ	Ē	RP	
			l							PE	
				1	No.	D	Э	ц			H
									ū	Η	

ob No.:

N14027

Draw/Check B

BLL / EKU

G1

ABBREVIATIONS QUALITY ASSURANCE

DESIGN CRITERIA

OWNER(S): NORTH MARY LLC, A CALIFORNIA LIMITED LIABILITY COMPANY

APN: 165-40-003

THIS DRAWING DOES NOT REPRESENT A BOUNDARY SURVEY OF ANY PARCEL OF LAND, NOR DOES IT IMPLY OR INFER THAT A BOUNDARY SURVEY WAS PERFORMED. THIS IS A SPECIALIZED TOPOGRAPHIC MAP WITH PROPERTY AND EASEMENTS BEING A GRAPHIC DEPICTION BASED ON INFORMATION GATHERED FROM VARIOUS SOURCES OF RECORD AND AVAILABLE MONUMENTATION. PROPERTY LINES AND LINES OF TITLE WERE NEITHER INVESTIGATED NOR SURVEYED AND SHALL BE CONSIDERED APPROXIMATE ONLY NO PROPERTY MONIMENTS WEFE ST. APPROXIMATE ONLY. NO PROPERTY MONUMENTS WERE SET.

THE EASEMENTS (IF ANY) THAT APPEAR ON THIS MAP HAVE BEEN PLOTTED BASED SOLELY ON INFORMATION CONTAINED IN THE PRELIMINARY TITLE REPORT BY: FIDELITY NATIONAL TITLE COMPANY, TITLE NO. 14-5016193, DATED APRIL 14, 2014. WITHIN SAID TITLE REPORT THERE ARE FIFTEEN (15) EXCEPTIONS LISTED, SIX (6) OF WHICH ARE EASEMENTS, AND TWO (2) OF WHICH CANNOT BE PLOTTED.

THE UNDERGROUND UTILITIES (IF ANY) THAT APPEAR ON THIS MAP HAVE BEEN LOCATED BY FIELD OBSERVATION. THE SURVEYOR MAKES NO GUARANTEE THAT THE UNDERGROUND UTILITIES SHOWN COMPRISE ALL SUCH UTILITIES IN THE AREA, EITHER IN SERVICE OR ABANDONED. THE SURVEYOR FURTHER DOES NOT WARRANT THAT THE UNDERGROUND UTILITIES SHOWN ARE IN THE EXACT LOCATION INDICATED ALTHOUGH HE DOES STATE THAT THEY ARE LOCATED AS ACCURATELY AS POSSIBLE FORM THE INFORMATION. AVAILABLE TO POSSIBLE FROM THE INFORMATION AVAILABLE.

The information shown above meets or exceeds the requirements set forth in FAA order 8260.19D for 1-A accuracy (\pm 20' horizontally and \pm 3' vertically). The horizontal datum (coordinates) are expressed as degrees, minutes and seconds, to the nearest hundredth of a second. The vertical datum (heights) are expressed in feet and decimals thereof and are determined to the nearest 0.1 foot.

THE LATITUDE AND LONGITUDE AS SHOWN WAS DETERMINED BY GPS OBSERVATIONS.

LAT. 37° 23' 57.35" N. NAD 83

NOT TO SCALE


LONG. 122' 02' 08.67" W. NAD 83 ELEV. 40.2' NAVD 88 - GROUND (BASIS OF DRAWING)


LESSOR'S PROPERTY LEGAL DESCRIPTION PER TITLE REPORT:

THE LAND REFERRED TO HEREIN BELOW IS SITUATED CITY OF SUNNYVALE, COUNTY OF SANTA CLARA, STATE OF CALIFORNIA, AND IS DESCRIBED AS FOLLOWS:

ALL OF PARCEL A, AS SHOWN UPON THAT CERTAIN MAP ENTITLED, "PARCEL MAP BEING A RESUBDIVISION OF LOTS 6 THRU 9 OF THAT RECORD OF SURVEY RECORDED IN BOOK 306 OF MAPS, AT PAGE 42 SANTA CLARA COUNTY RECORDS", WHICH MAP WAS FILED FOR RECORD IN THE OFFICE OF THE RECORDS OF THE COUNTY OF SANTA CLARA, STATE OF CALIFORNIA, ON MARCH 15, 1974 IN BOOK 337 OF MAPS, AT PAGE 23.

EXCEPTING THEREFROM THAT PORTION THEREOF AS CONVEYED TO THE CITY AND COUNTY OF SAN FRANCISCO, A MUNICIPAL CORPORATION, BY DEED RECORDED AUGUST 6, 1951 IN BOOK 2262, OF OFFICIAL RECORDS, AT PAGE 31. APN: 165-40-003

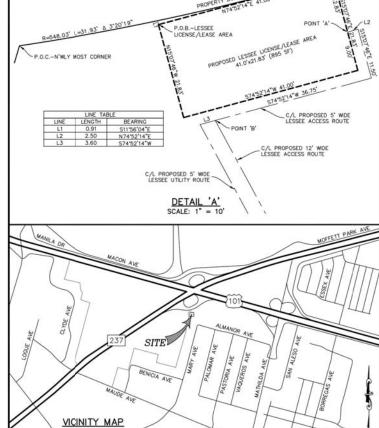

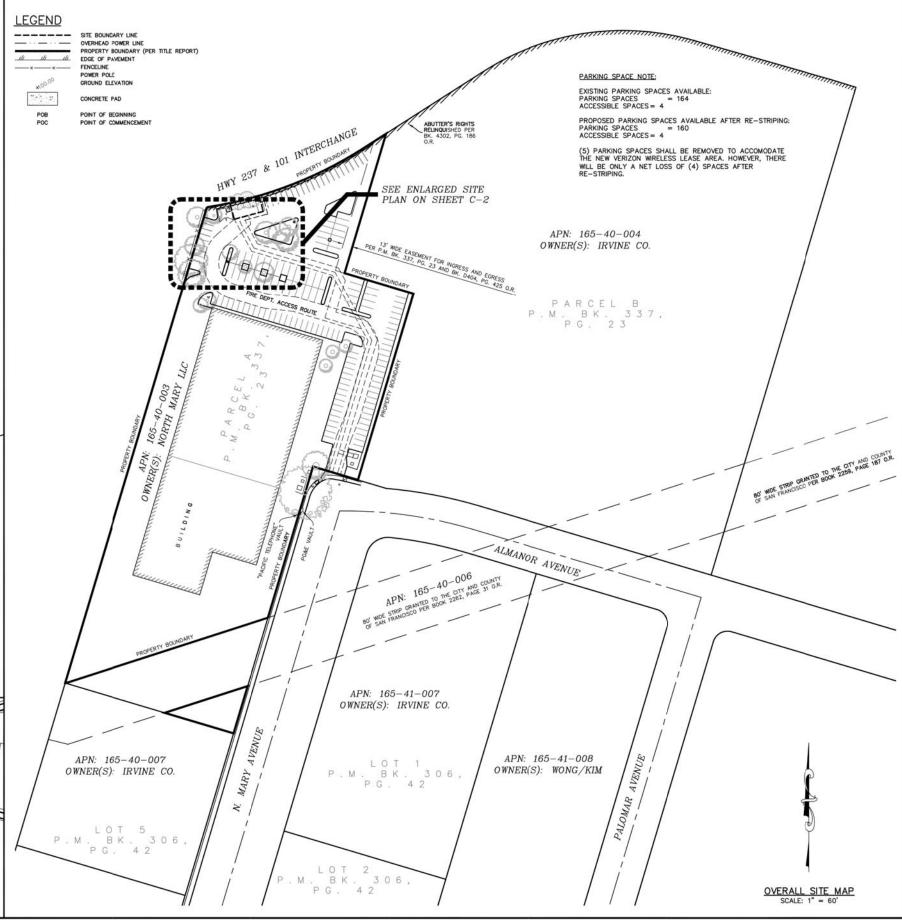

NSA Wireless, Inc.

2010 Crow Canyon Place, Ste. 355 San Ramon, CA 94583 Office: 925-244-1890 Fax: 925-355-0672



P.O. BOX 81626 BAKERSFIELD, CA 93380 PHONE: (661) 393-1217 FAX: (661) 393-1218

SPACE RESERVED FOR PROFESSIONAL SEAL

PRELIMINARY

NOT TO BE CONSIDERED FINAL WITHOUT

SURVEYOR'S SEAL AND SIGNATURE

REVISION

NO. DESCRIPTION PRELIM. ISSUE SL 05/21/14 LEASE/ESMNTS SL 07/23/14 TITLE REVIEW SL 07/31/14 3 LEASE/ESMNTS SL 08/06/14 4 ACCESS/FIRE SL 01/06/15

THIS DRAWING IS COPYRIGHTED AND IS THE SOLE PROPERTY OF THE OWNER. IT IS PRODUCED SOLEY FOR THE USE BY THE OWNER AND TIS AFFILMENT, REPRODUCTION OR USE OF THIS DRAWING AND/OR THE INFORMATION CONTAINED IN IT IS FORBIDDEN WITHOUT THE WRITTEN PERMISSION OF THE OWNER.

CHECKED BY: GJS DATE DRAWN: 05/21/14 SMITHCO JOB #: 88-001

SITE NAME

277666 HWY 101 & 237

SITE ADDRESS


787 NORTH MARY AVENUE SUNNYDALE, CA 94085 SANTA CLARA COUNTY

SHEET TITLE

SITE SURVEY

SHEET

C-1

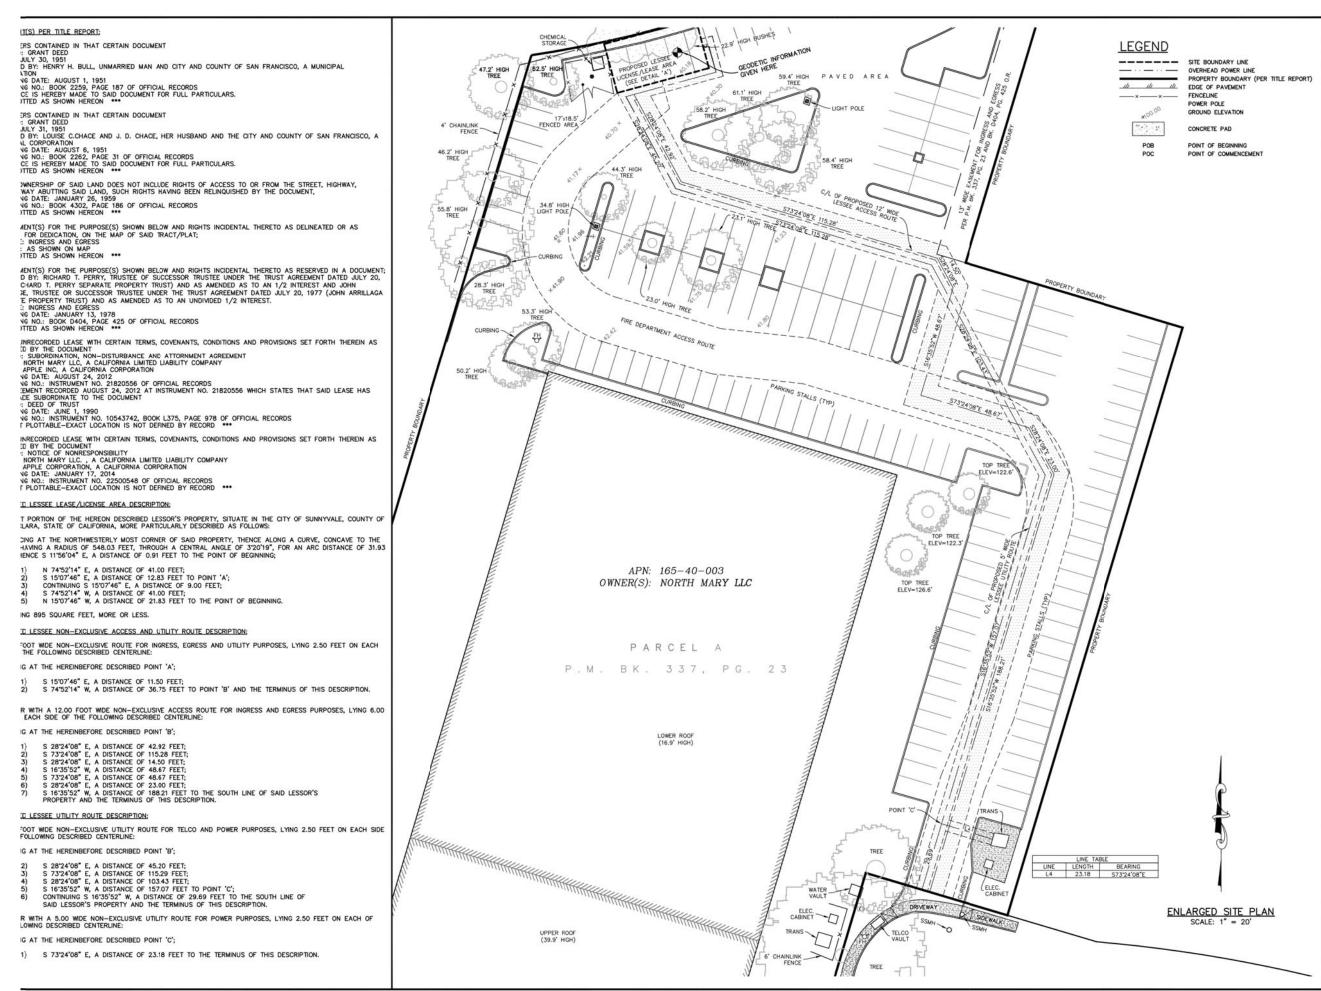

NSA Wireless, Inc.

2010 Crow Canyon Place, Ste. 355 San Ramon, CA 94583 Office: 925-244-1890 Fax: 925-355-0672



ALL DRAWINGS AND WRITTEN MATERIAL CONTAINED HEREIN ARE THE PROPERTY OF TH ARCHITECT/ENGNEER/SURVEYOR AND MAY NO BE DUPLICATED, USED, OR DISCLOSED WITHOL THE WRITTEN CONSENT OF THE ARCHITECT/ENGNEER/SURVEYOR.



REVISION

NO. DESCRIPTION BY DATE

THIS DRAWING IS COPYRIGHTED AND IS THE SOLE PROPERTY OF THE OWNER. IT IS PRODUCED SOLLY FOR THE USE BY THE OWNER AND IT'S AFFILIATES. REPRODUCTION OF USE OF THIS DRAWING AND/OR THE INFORMATION CONTAINED IN IT IS FORBIDDEN WITHOUT THE WRITTEN PERMISSION OF THE OWNER.

DRAWN BY: SL

CHECKED BY: GJS

DATE DRAWN: 05/21/14

SMITHCO JOB #: 88-001

SITE NAME

277666 HWY 101 & 237

SITE ADDRESS


787 NORTH MARY AVENUE SUNNYDALE, CA 94085 SANTA CLARA COUNTY

SHEET TITLE

SITE SURVEY

FOR EXAMINATION ONLY
SHEET


C-2

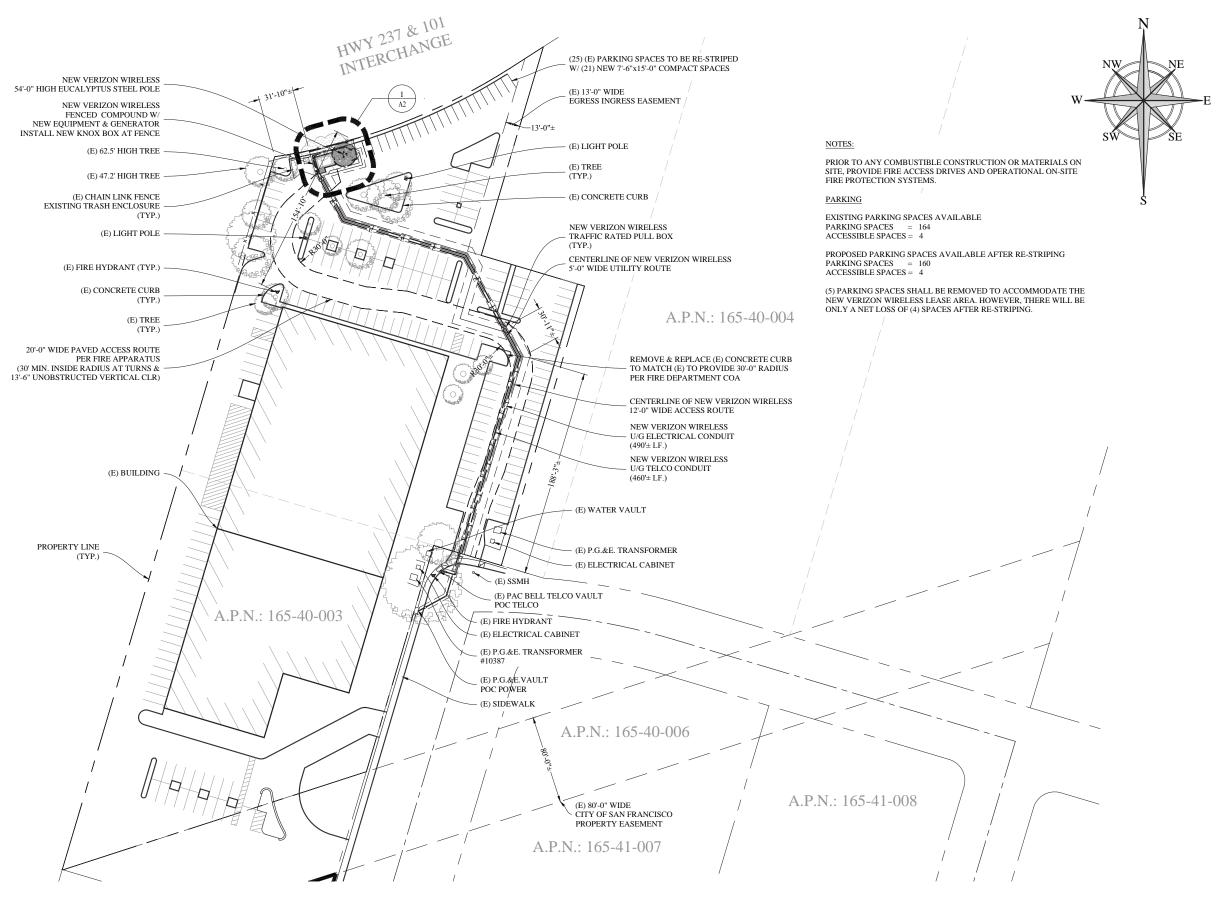


VERIZON WIRELESS HWY 101 & 237 PSL#277666 787 NORTH MARY AVENUE SUNNYVALE, CA 94085 PLAN SITE

Draw/Check B N14027

BLL / EKU

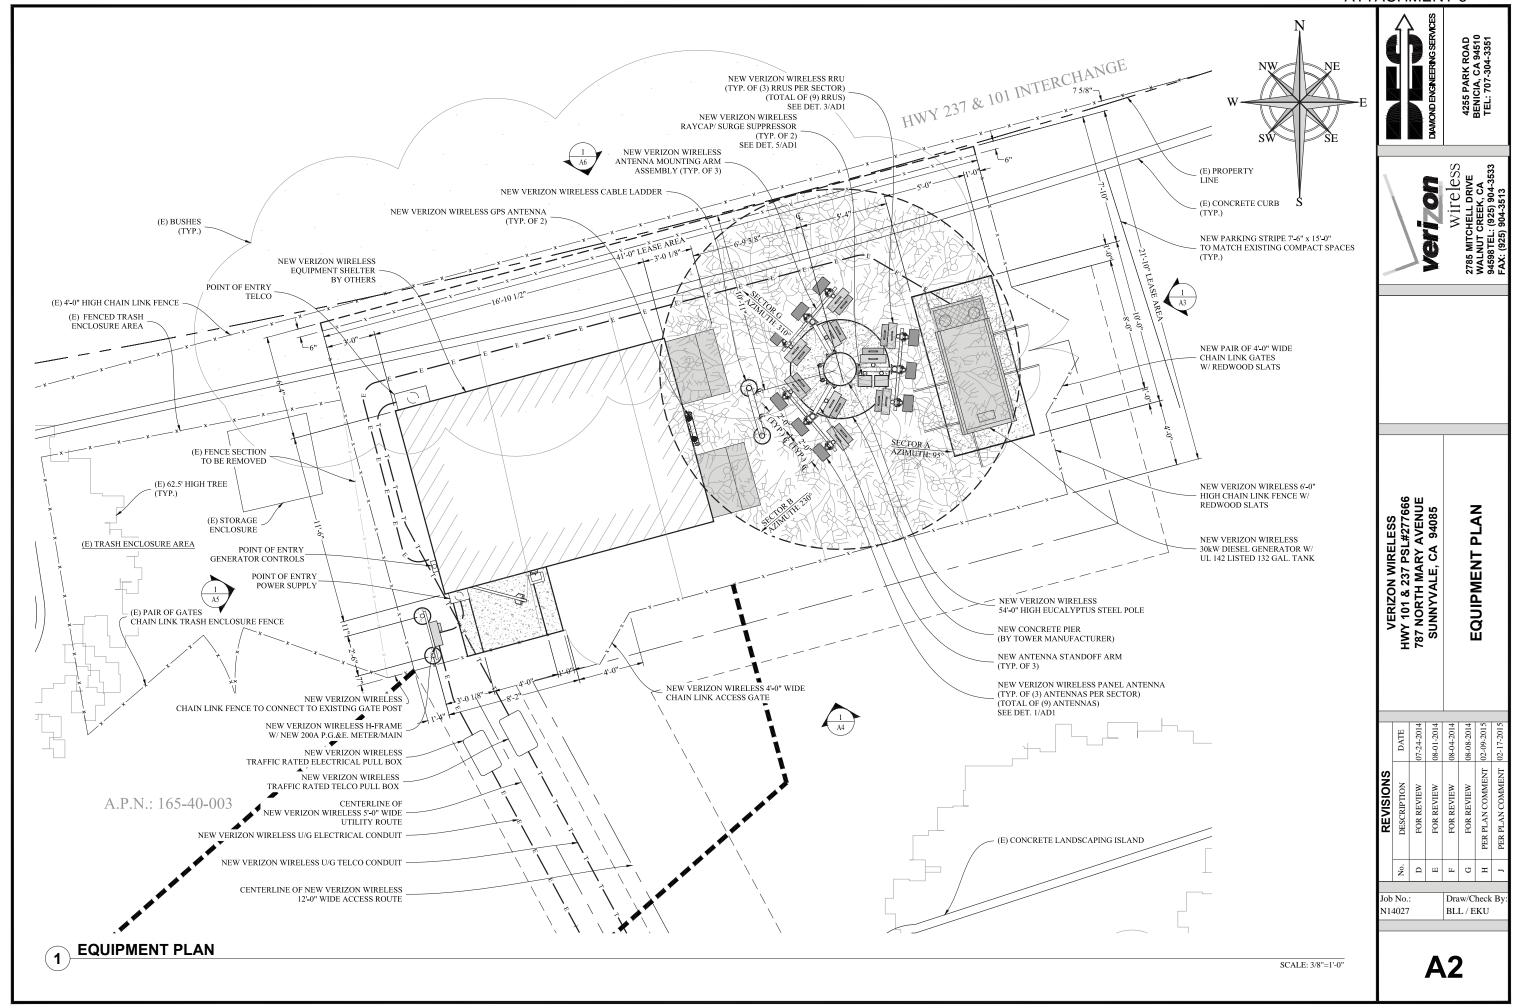


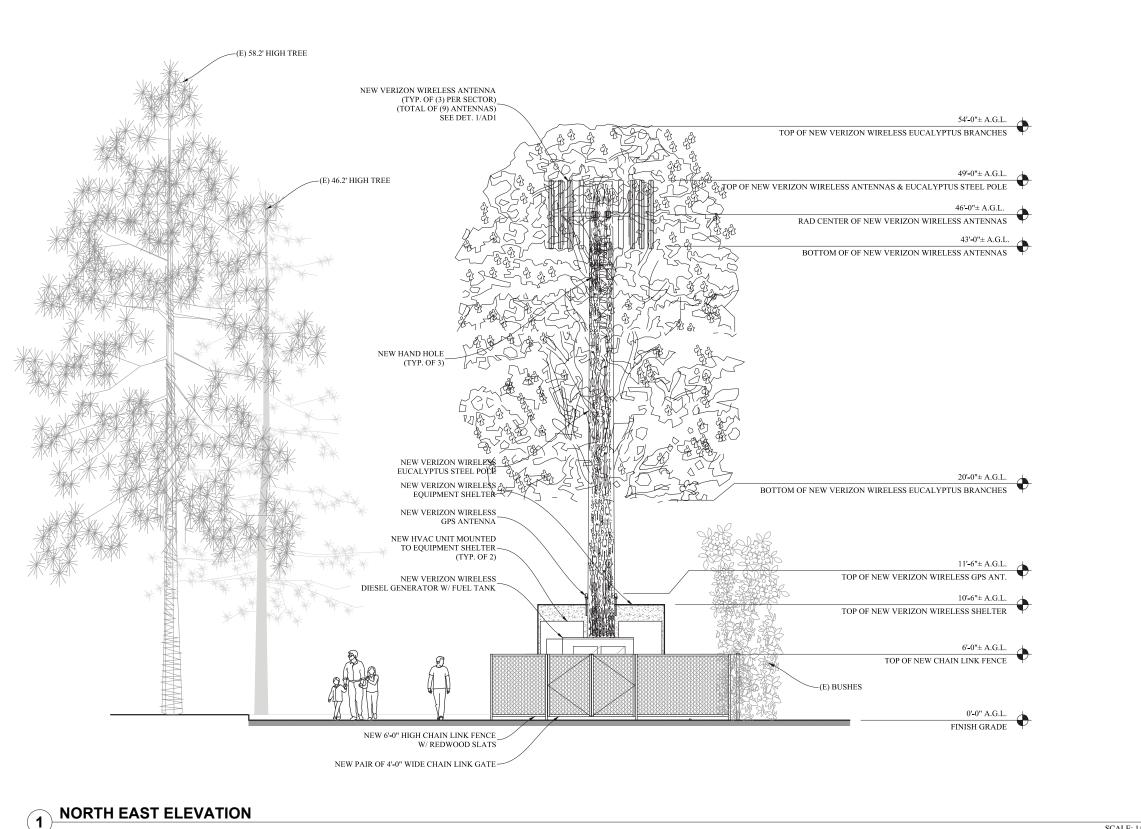


SCALE: 1/4"=1'-0"

Job No.: Draw/Check By N14027 BLL / EKU

A3

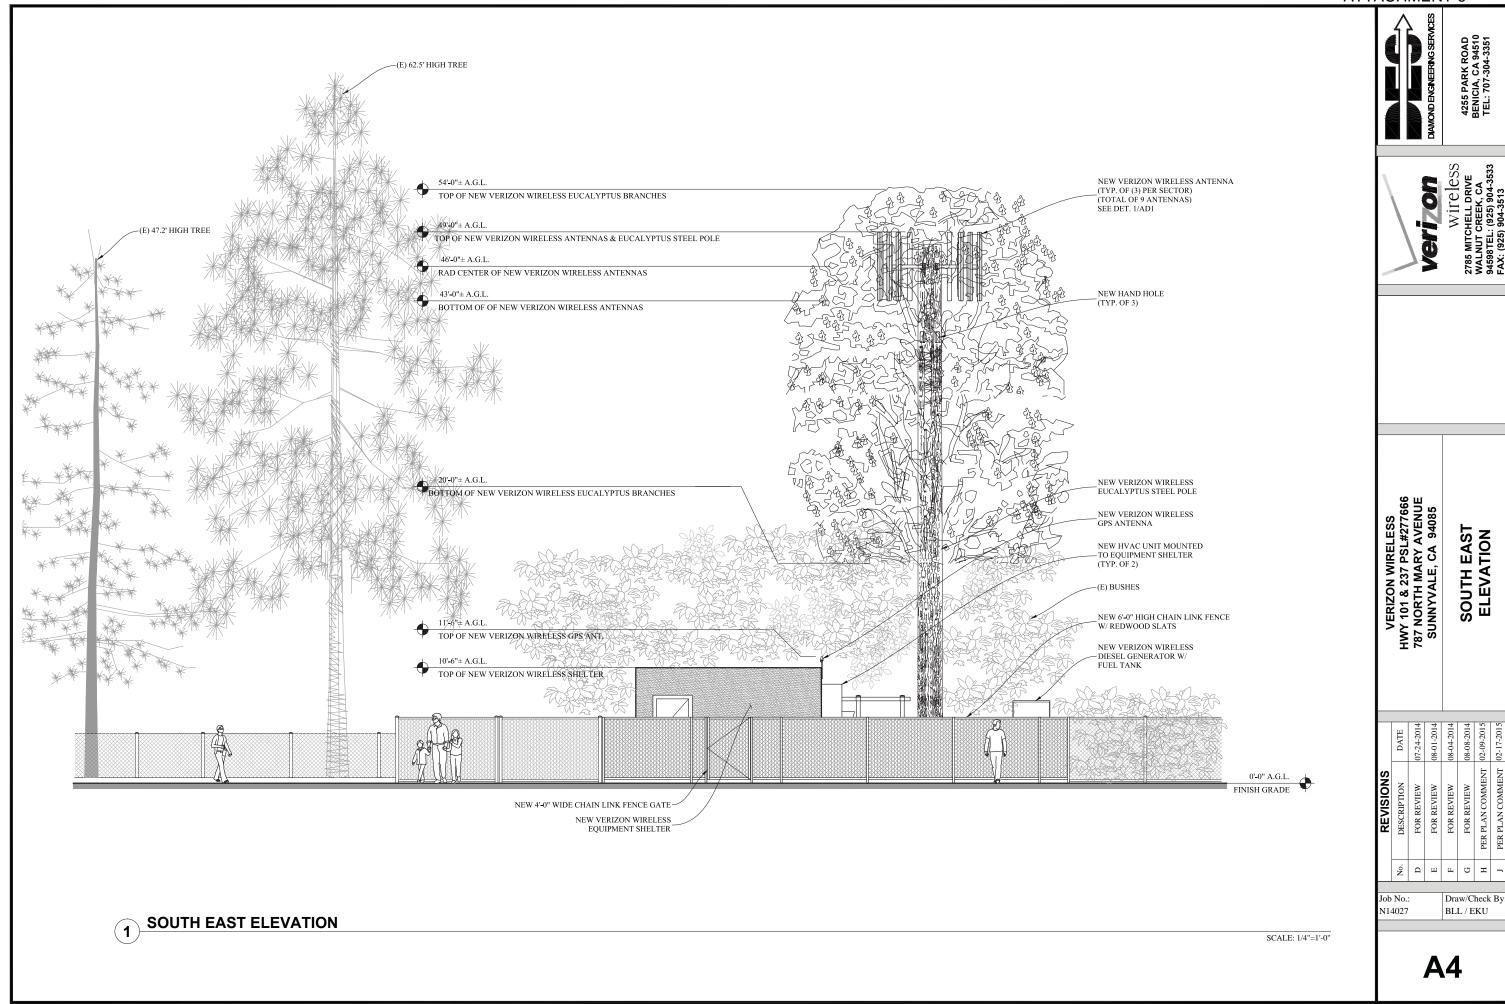

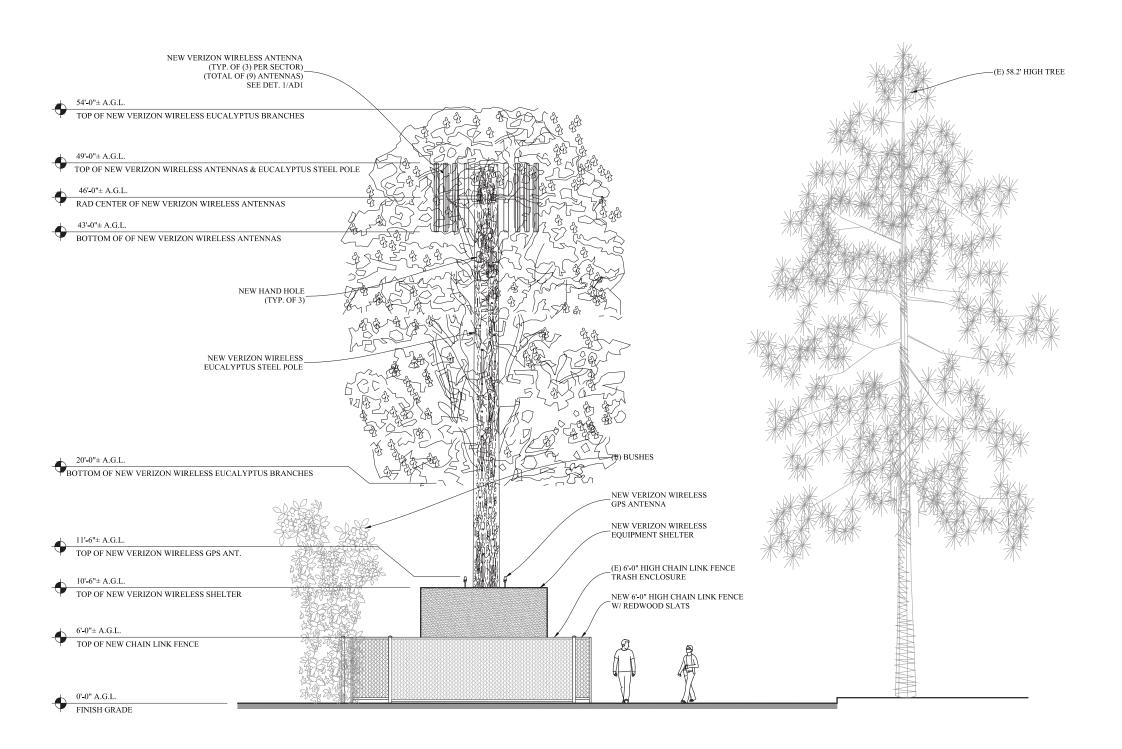



SOUTH WEST ELEVATION Draw/Check By N14027 BLL / EKU


SOUTH WEST ELEVATION

SCALE: 1/4"=1'-0"

A5

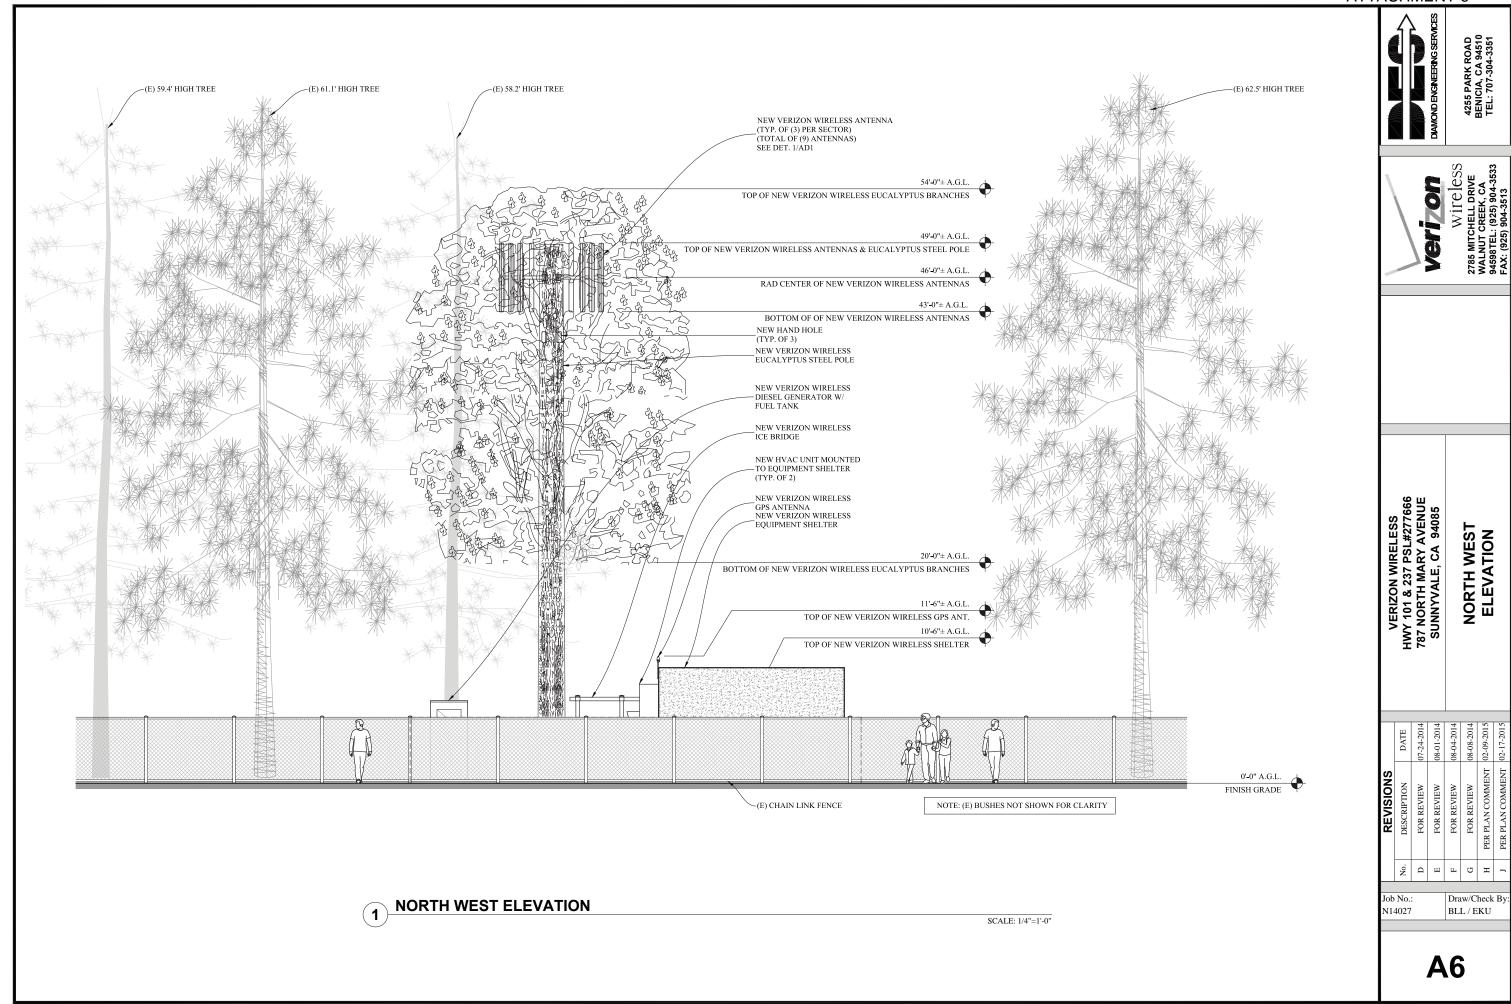


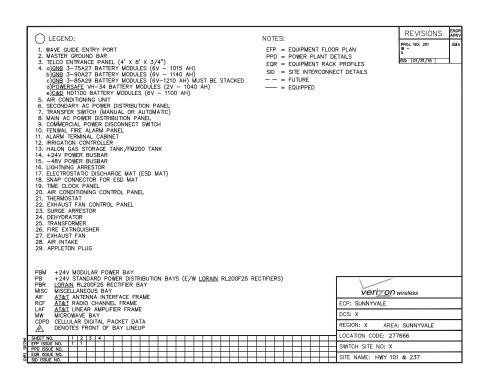

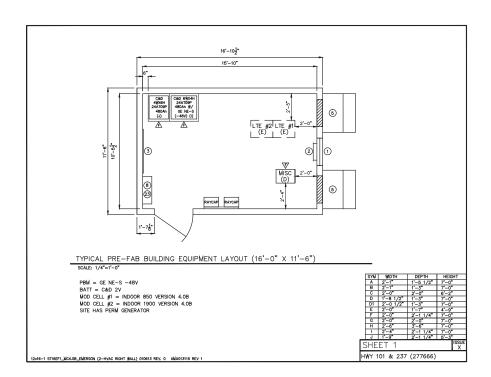

EQUIPMENT LAYOUT

24 x 36 SCALE: 1/4"=1'-0"

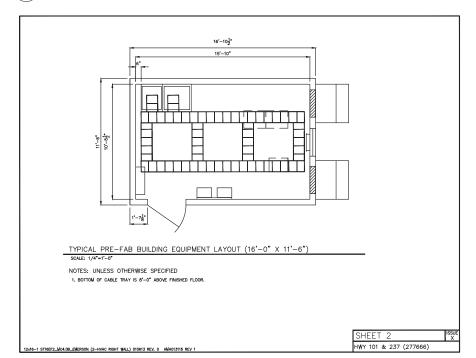

CABLE TRAY LAYOUT $(\mathbf{2})$

24 x 36 SCALE: 1/4"=1'-0"



WITE LESS 2785 MITCHELL DRIVE WALNUT CREEK, CA


TRAY VERIZON WIRELESS HWY 101 & 237 PSL#277666 787 NORTH MARY AVENUE SUNNYVALE, CA 94085 EQUIPMENT & CABLE LAYOUTS

lob No.: Draw/Check B N14027 BLL / EKU

A7

LEGEND & NOTES

24 x 36 SCALE: NONE

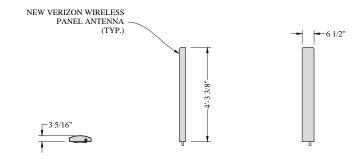

SIDE ELEVATION FRONT ELEVATION

ANTENNA DETAIL

	DIMENS	DIONS	
HBX-6516DS - AIM	Inches	mm	COMMENT
DEPTH	3.3"	83.0	
LENGHT	51.4"	1306.0	
WITDH	6.5"	166.0	
NET WEIGHT	10.4 lbs	4.7 kg	
INCLUDED PARTS:			
DB380-3 PIPE MOUNTI	NG KIT 2.4 - 4.5 in. NO	OMINAL O.D. ROUN	ID MEMBERS


NOTE: SEE ANTENNA MANUFACTURER DATA SHEETS FOR BILL OF MATERIALS FOR ACCESSORY PARTS




PLAN VIEW

SCALE: 1/2"=1'-0"

SCALE: 1/2"=1'-0"

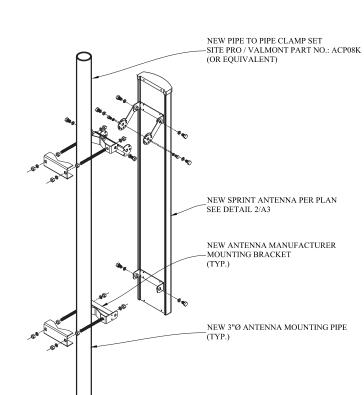

ANTENNA MOUNTING DETAIL

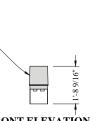

SCALE: 1/2"=1'-0"

RAYCAP DETAIL

	RAYCA	P DATA	
DIMENSIONS:	WIDTH	DEPTH	HEIGHT
	10.15"	8.2'	20.58"
TOTAL WEIGHT		14.0 LBS	

5 RAYCAP DETAIL


|-1'-5"-| 888

PLAN VIEW-TOP

1'-5"

٥٠٠٠<u>..</u>٥٥

RRU DETAIL SCALE: 1/2"=1'-0"

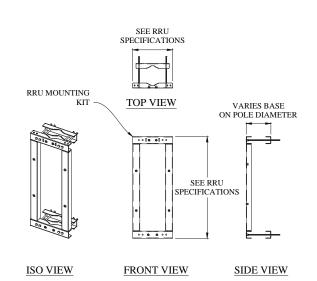

4 RRU MOUNTING FRAME

SCALE: 1/2"=1'-0"


Draw/Check By

N14027


ANTENNA, RRU & RAYCAP DETAILS

AD1

BLL / EKU

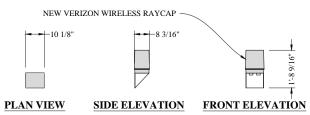

PLAN VIEW-BOT.

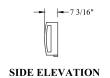


WIDTH

POWER CONSUMPTION:

TOTAL WEIGHT:

TEMPERATURE:

NEW VERIZON WIRELESS POLE MOUNTED RRU

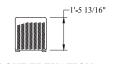


FRONT ELEVATION

ORTHOMETRIC VIEW

DEPTH HEIGHT 200 WATTS 55 LBS -40° TO 55° C

			ANTENNA WAVEGUIDE PORT - INSIDE VIEW
		ALPHA SECTOR 1	1 2 3 4 5 6
		BETA SECTOR 2	7 8 9 10 11 12
		GAMMA SECTOR 3	13 (14) (15) (16) (17) (18)
			19 20 21 22 23 24
ANTENNA	COLOR CODE SCHEME FOR LUCENT	850 / PCS / LTE MODCELL	
	ANTENNA MICROWAVE GU		
PORT NO.	DESCRIPTION	COLOR CODE	
19	MICROWAVE #1 (MW-1)	RED / RED / RED	
20	MICROWAVE #1 (MW-2)	BLUE / BLUE / BLUE	
21	MICROWAVE #1 (MW-3)	GREEN / GREEN / GREEN	
22	MICROWAVE #1 (MW-4)	YELLOW / YELLOW / YELLOW	
X	MICROWAVE #1 (MW-5)	ORANGE / ORANGE / ORANGE	
X	MICROWAVE #1 (MW-6)	PURPLE / PURPLE / PURPLE	
X	MICROWAVE #1 (MW-7)	WHITE / WHITE / WHITE	
X	MICROWAVE #1 (MW-8)	WHITE / RED / RED	
X	MICROWAVE #1 (MW-9)	WHITE / BLUE / BLUE	
X	MICROWAVE #1 (MW-10)	WHITE / GREEN / GREEN	
			SHEET ISSUE X
ANTENNA COLOR	R CODE FOR 850_PCS_LTE MODCELL 041312 REV 5A		-SID

ANTENNA COLOR CODES (CONT.) SCALE: NONE

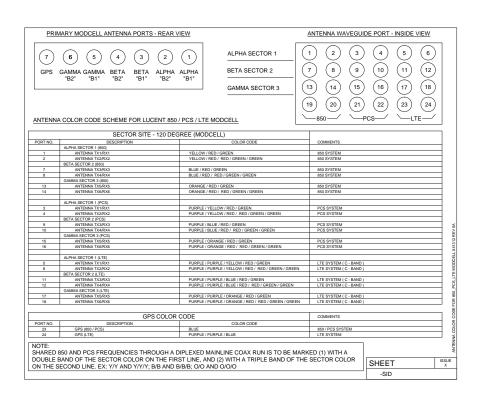

ANTENNA COLOR CODES

SCALE: NONE

	SECTO	R SITE - 120 DEGREE		
PORT NO.	DESCRIPTION	COLOR CODE	COMMENTS	
	ALPHA SECTOR 1 (LTE)			
	ANTENNA TX1/RX1	PURPLE / PURPLE / PURPLE / YELLOW / RED / GREEN	LTE SYSTEM (A - BAND)	
	ANTENNA TX2/RX2	PURPLE / PURPLE / PURPLE / YELLOW / RED / RED / GREEN / GREEN	LTE SYSTEM (A - BAND)	
	BETA SECTOR 2 (LTE)			
	ANTENNA TX3/RX3	PURPLE / PURPLE / PURPLE / BLUE / RED / GREEN	LTE SYSTEM (A - BAND)	
	ANTENNA TX4/RX4	PURPLE / PURPLE / PURPLE / BLUE / RED / RED / GREEN / GREEN	LTE SYSTEM (A - BAND)	
	GAMMA SECTOR 3 (LTE)			
	ANTENNA TX5/RX5	PURPLE / PURPLE / PURPLE / ORANGE / RED / GREEN	LTE SYSTEM (A - BAND)	
	ANTENNA TX6/RX6	PURPLE / PURPLE / PURPLE / ORANGE / RED / RED / GREEN / GREEN	LTE SYSTEM (A - BAND)	
	ALPHA SECTOR 1 (AWS)			
	ANTENNA TX1/RX1	PURPLE / YELLOW / RED / GREEN / PURPLE	AWS SYSTEM	
	ANTENNA TX2/RX2	PURPLE / YELLOW / RED / RED / GREEN / GREEN / PURPLE	AWS SYSTEM	
	BETA SECTOR 2 (AWS)			
	ANTENNA TX3/RX3	PURPLE / BLUE / RED / GREEN / PURPLE	AWS SYSTEM	
	ANTENNA TX4/RX4	PURPLE / BLUE / RED / RED / GREEN / GREEN / PURPLE	AWS SYSTEM	
	GAMMA SECTOR 3 (AWS)			
	ANTENNA TX5/RX5	PURPLE / ORANGE / RED / GREEN / PURPLE	AWS SYSTEM	
	ANTENNA TX6/RX6	PURPLE / ORANGE / RED / RED / GREEN / GREEN / PURPLE	AWS SYSTEM	

WITE ESS
2785 MITCHELL DRIVE
WALNUT CREEK, CA
94598TEL: (925) 904-3533 VERIZON WIRELESS HWY 101 & 237 PSL#277666 787 NORTH MARY AVENUE SUNNYVALE, CA 94085 COD COLOR ANTENNA

N O E D W.

AD2

Job No.: N14027 Draw/Check By

BLL / EKU

ANTENNA COLOR CODES (CONT.)

SCALE: NONE