### ATTACHMENT 6

THIS PAGE IS INTENTIONALLY LEFT BLANK FOR PRINTING 2-SIDED DOCUMENTS



#### **CUSTOM HOME BEDI RESIDENCE**

1094 LILY AVE SUNNYVALE CA APN NUMBER 132-90-59 RE3SUBMITTAL FOR

PLANNING COMMISSION

6JUL16



# PERSPECTIVES Architecture Planning Interior

ATTACHMENT 6

PAGE 1 OF 20

#### AREA CALCULATIONS

LOT AREA = 11,470

FIRST FLOOR LIVING AREA = 2757 GARAGE = 597 TOTAL FIRST FLOOR BUILT UP AREA = 3354

SEC FLOOR LIVING AREA = 1763 SF

ATRIUM = 239 SF

SEC FLOOR LIVING AREA = 1763 SF REAR COVERED PORCH - 341 SF

TOTAL FAR = 5117+239+341 = 5697 /11470 = 49.6%

FRONT PORCH = 115 SF TOTAL LIVING AREA = 2757+1763+239+115 = 4874 SF TOTAL PORCHES = 115+341=456 SF

LOT COVERAGE = 2757+597+341+115=3810/11470=33.2% BASEMENT = 1219 SE

PROPOSED IS A NEW 5,812 SQUARE FOOT, TWO-STORY SINGLE-FAMILY HOME (4,874SQ. FT. LIVING AREA; 597 SQ. ST. CARACE; 456 SQ. FT. OF FRONT & REAR YARD PORCHES)
AT 49.6% FAR. THE PROPOSAL ALSO INCLUDES A 1,219
SQUARE FOOT BASEMENT. THE EXISTING HOUSE WILL BE
DEMOLISHED.

## VICINITY MAP



#### DRAWING INDEX

ARCHITECTURAL/CIVIL/LANDSCAPE GENERAL INFORMATION
& MISC CONSTRUCTION NOTES
TOPOGRAPHIC SURVEY C-1 ARCHITECTURAL SITE PLAN A1.1 A1.2 STREETSCAPE A2.0 BASEMENT PLAN FIRST FLOOR PLAN A2.1 A2.2 ROOF PLAN A5.1 EXTERIOR ELEVATIONS A5.2 EXTERIOR FLEVATIONS A5.3 BUILDING SECTIONS A6.1 SOLAR STUDY L-1 LAYOUT PLAN LANDSCAPE PLAN L-2 IRRIGATION LAYOUT PLAN & WATERSHED CALCULATIONS IR-1 IRRIGATION NOTES & SCHEDULE IR-2

#### PROJECT TEAM

#### **STRUCTURAL** OWNER

SURJIT AND BHAVNISH BEDI 1094 LILIY AVE SUNNYVALE CA PH: 408 550 5686

#### **ARCHITECTS**

PERSPECTIVES DESIGN, INC 21949 LINDY LANE CUPERTING CA 95014 PH 408 334 0827 FAX 408 564 0803 EMAIL - seemam@comcast.net

#### SURVEY / CIVIL

JLK ASSOCIATES 73 CEDAR LANE SAN JOSE CA 95127 PH: 408 729 3734

RAHMANI AND ASSOCIATES, INC 1870 HAMILTON AVE SAN JOSE CA 95125

#### SOILS REPORT

WAYNE TING AND ASSOCIATES 42329 OSGOOD ROAD, UNIT A PH: 510 623 7861

#### L.ANDSCAPE

YU-WEN HUANG LANDSCAPE ARCHITECTURE 3357 SAINT MICHAEL CT PALO ALTO CA 94306 (415) 695-0800

**GENERAL** CONTRACTOR

#### PROJECT DATA

ADDRESS SUNNYVALE CA EXISTING HOME TO BE DEMOLISHED BUILT IN 1949 APPLICABLE CODES: 2013 CALIFORNIA BUILDING CODE

> 2013 CALIFORNIA MECHANICAL CODE 2013 CALIFORNIA ELECTRICAL CODE 2013 CALIFORNIA RESIDENTIAL CODE 2013 CALIFORNIA GREEN BUILDING CODE

CONSTRUCTION TYPE: OCCUPANCY CLASSIFICATION: NUMBER OF FLOORS:

FIRE PROTECTION:

R-3/U

FULLY SPRINKLERED

TWO PLUS PARTIAL BASEMENT

#### PROJECT SUMMARY

THE EXISTING STRUCTURES CONSISTING OF A 1572 SQ FT SINGLE STORY HOME WITH PARTIAL BASEMENT BULT IN 1949, A DETACHED GARAGE OF 649 SQ FT AND SHED OF 95 SQ FT WILL BE DEMOLISHED. THE HOUSE HAS A MEDITTERANEAN CHARACTER WITH RED TILL ROOF.

THE PROJECT COMPRISES OF A BRAND NEW TWO STORY HOME WITH ATTACHED 2 CAR GARAGE PLUS PARTIAL BASEMENT. IT WILL HAVE 5 BEDROOMS PLUS 5 AND \$ BATH. IT WILL INCLUDE A NEW FRONT ENTRY, LIVING ROOM, A DINING ROOM, KITCHEN/FAMILY RM/NOOK, GAME ROOM, LAUNDRY AND MEDIA ROOM.

THE NEIGHBORHOOD IS BLENDED WITH OLD AND NEW HOMES. IT CONSISTS O MANY OLDER RANCH HOMES BOTH SINGLE STORY AND TWO STORY. THE NEIGHBORING PROPERTIES ON THE EAST HAVE FOUR TWO STORY MEDITERRANCH HOMES. THE PROPERTY ON THE RICH IS A SINGLE STORY RANCH STYLE HOME AS ARE THOSE ACROSS THE STREET.

THE PROPOSED HOME WILL BE A MEDITTERANEAN STYLE HOME WITH PANTILE ROOF, RECESSED WINDOWS WITH WITH MOLDED TRIMS. THERE WILL BE A CENTRAL PORCH ENTRY IN FRONT OF A CIRCULAR ATRIUM WITH UPPER WINDOWS. THE GARAGE TO THE LEFT WILL HAVE A LOW EAVE LINE. THE ROOF PITCH WILL BE 4 IN 12. THE TWO STORY PORTION OF THE HOUSE WILL BE AT THE REAR. THE HOUSE WILL BE SETBACK ABOUT 26 FROM THE FRONT SETBACKS. AND MOST SETBACKS WILL EXCEED THE MINIMUM REQUIRED.

26MAY16	PLANNING REV
DATE	DESCRIPTION
PROJECT NAME	

#### **BEDI RESIDENCE**

1094 HIY AVE SUNNYVALE, CA

#### GENERAL INFORMATION & MISC CONSTRUCTION NOTES

SCALE AS NOTED

DATE 23MAR16

PROJECT NO

SHEET NO

A1.0

#### GENERAL CONSTRUCTION NOTES

- 1. ANY CONFLICTS BETWEEN ACTUAL ON SITE CONDITIONS AND THE DRAWINGS SHALL BE THE RESPONSIBILITY OF THE GENERAL CONTRACTOR TO RESOLVE WITH THE ARCHITECT IMMEDIATELY, PRIOR TO PROCEEDING WITH THE WORK IN QUESTION OR ANY PORTION OF THE WORK, EITHER AT THE START OF CONSTRUCTION OR OR AT ANY TIME THROUGHOUT THE COURSE OF THE CONSTRUCTION TO COMPLETION.
- 2. ANY ERRORS, OMISSIONS OR CONFLICTS BETWEEN TRADES SHOULD BE BROUGHT TO THE ATTENTION OF THE ARCHITECT/ENGINEERS.
- 3. ALL WORK IS TO BE PERFORMED IN COMPLIANCE WITH CURRENT CODES.
- 4. DO NOT SCALE DRAWINGS. WRITTEN DIMENSIONS PREVAIL.
- ALL DIMENSIONS ARE TO FOF UON.
   ALL EXTERIOR AND INTERIOR MATERIALS AND COLORS TO BE APPROVED BY THE OWNER BEFORE ORDERING AND INSTALLATION.
- 7. ALL PLUMBING, MECHANICAL, ELECTRICAL, LIGHTING FIXTURES AND APPLIANCES TO BE APPROVED BY THE OWNER.
- ALL FOUNDATION AND ATTIC VENTS TO BE COVERED WITH 1/4" CORROSION RESISTANT WIRE MESH. 9. ENERGY FORM CF-6R. THE INSTALLATION AND INSULATION
- CERTIFICATES SHALL BE POSTED ON THE JOB SITE DURING CONSTRUCTION OF THE PROJECT. 10. THE CONTRACTOR SHALL ENSURE THAT THE CONSTRUCTION IS IN COMPLIANCE WITH THE LATEST SET OF DOCUMENTS.
- 11. HEATING SYSTEM TO BE DESIGN BUILD BY SUBCONTRACTOR AND TO CONFIRM COMPLIANCE WITH TITLE 24 REQUIREMENTS.

- 12. FLOORS SHALL BE LEVEL TO WITHIN 1/4 INCH PER 10'-0" SPAN. PROVIDE FLOOR LEVELING WHERE REQUIRED.
- 13 INCLUDE FINAL CLEANING TO INCLUDE BUT NOT LIMITED TO: GLASS GLOSSY 13. INCLODE FINAL CLEANING, TO INCLODE BUT NOT LIMITED TO: GLASS, GLOSST SUPFACES, FLOORS, WALLS, DOORSAND FRAMES, TOLET FIXTURES AND WALL BASE.

  14. TAPE AND SAND ALL PARTITIONS. PARTITIONS SHALL BE LEFT IN A SMOOTH CONDITION READY TO PAINT, U.O.N.
- 15. ALL FINISHES SHALL BE PROVIDED BY CONTRACTOR. (UNLESS NOTED NIC ) 16. DO NOT SCALE DRAWINGS FOR DIMENSIONS.
- 17. WHERE FLOORING BREAKS AT DOOR OR CASED OPENING, THE SEAM IS TO ALIGN WITH THE INTERIOR FACE OF THE CASE OPENING OR INTERIOR FACE OF THE DOOR IN ITS CLOSED POSITION
- 18. FOR WINDOW SCHEDULE SEE A5.2
- 19. SEE STRUCTURAL DRAWINGS FOR STRUCTURAL INFORMATION
- 20. FOR ELECTRICAL PLANS, SEE A7.1
- 22. LIGHTING IN BATHROOMS AND KITCHEN TO COMPLY WITH STATE ENERGY REGULATIONS.
- 23. ALL EXISTING INFORMATION SHOWN ON THE DRAWINGS IS FOR REFERENCE ONLY AND DOES NOT REFLECT AS-BUILT CONDITIONS. CONTRACTOR TO FIELD VERIFY ALL CONDITIONS THAT REQUIRE ACCURACY AND CRITICAL DIMENSIONS
- 24. CONTRACTOR TO LAYOUT BUILGING OUTLINE TO VERIFY ALL REQUIRED SETBACKS, PRIOR TO TO POURING THE FOUNDATION
- 25. THE AIA DOCUMENT A201, GENERAL CONDITIONS FOR THE PERFORMANCE OF A CONTRACT (LATEST EDITION) IS HEREBY INCORPORATED INTO THE CONTRACT DOCUMENTS AND SHALL BE CONSIDERED AS PART OF THE REQUIREMENTS FOR THE COMPLETION OF THE WORK







Examples of new homes in the neighborhood on Tamarack Lane












Examples of New Homes in the Neighborhood: On Timberpine Lane





Proposed Residence: 1094 Lily Ave, Sunnyvale

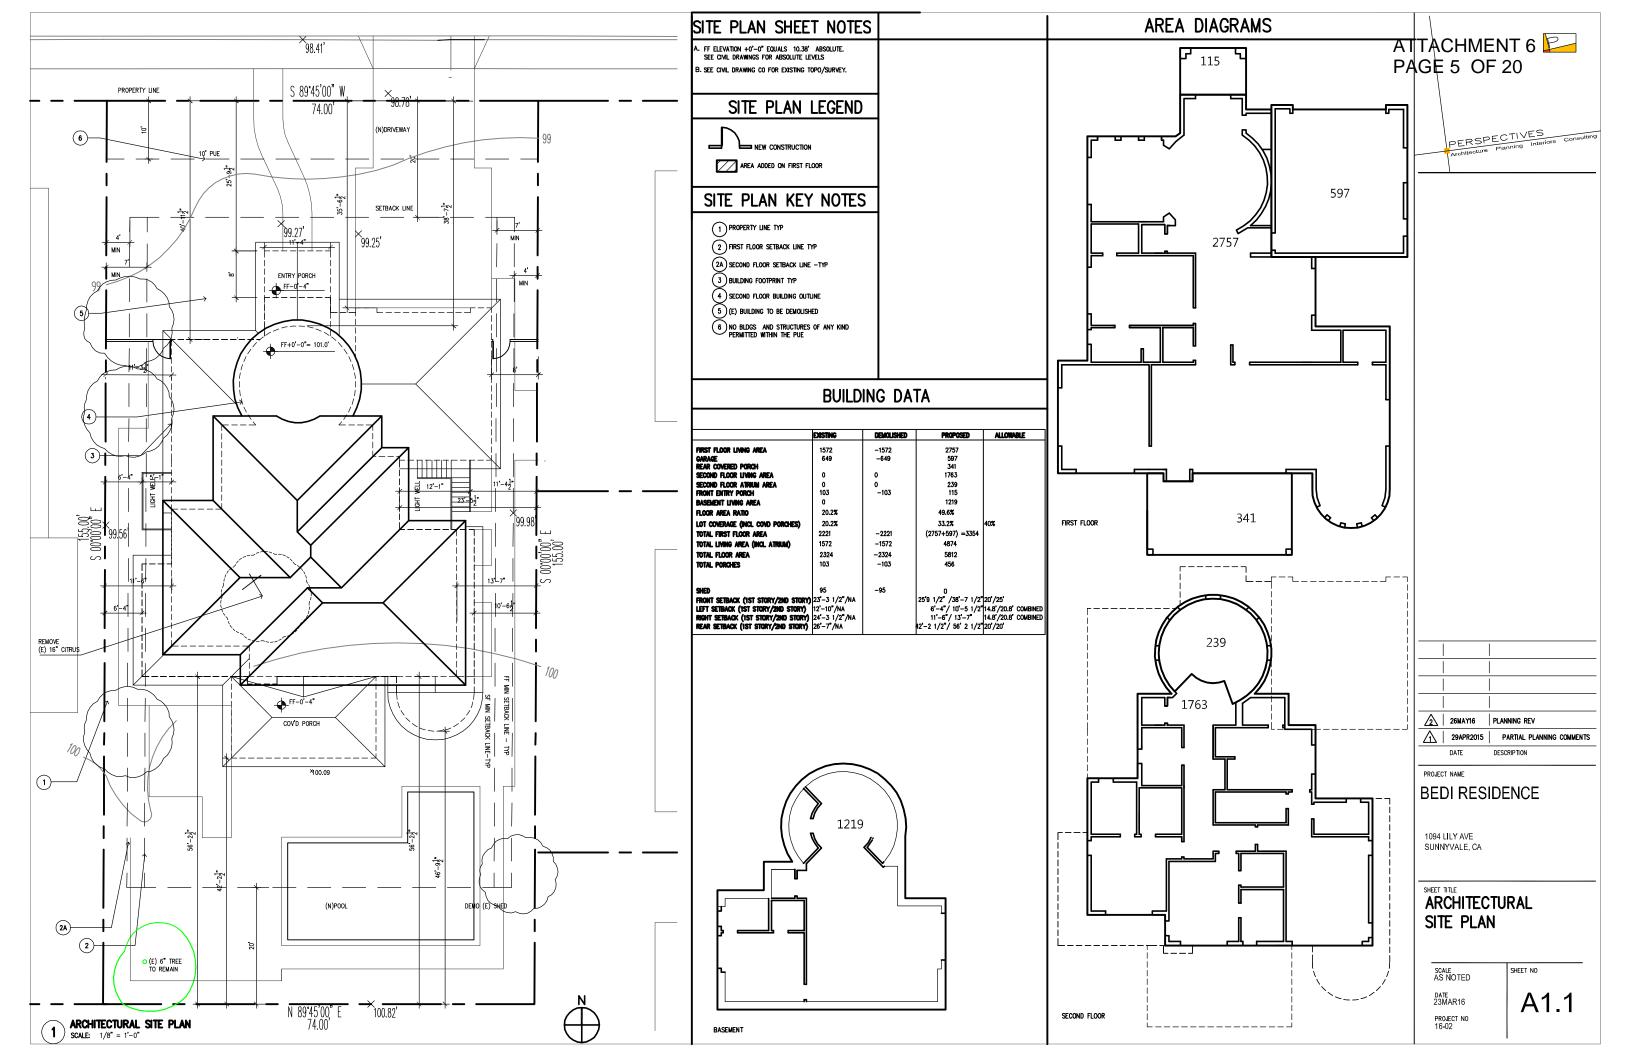


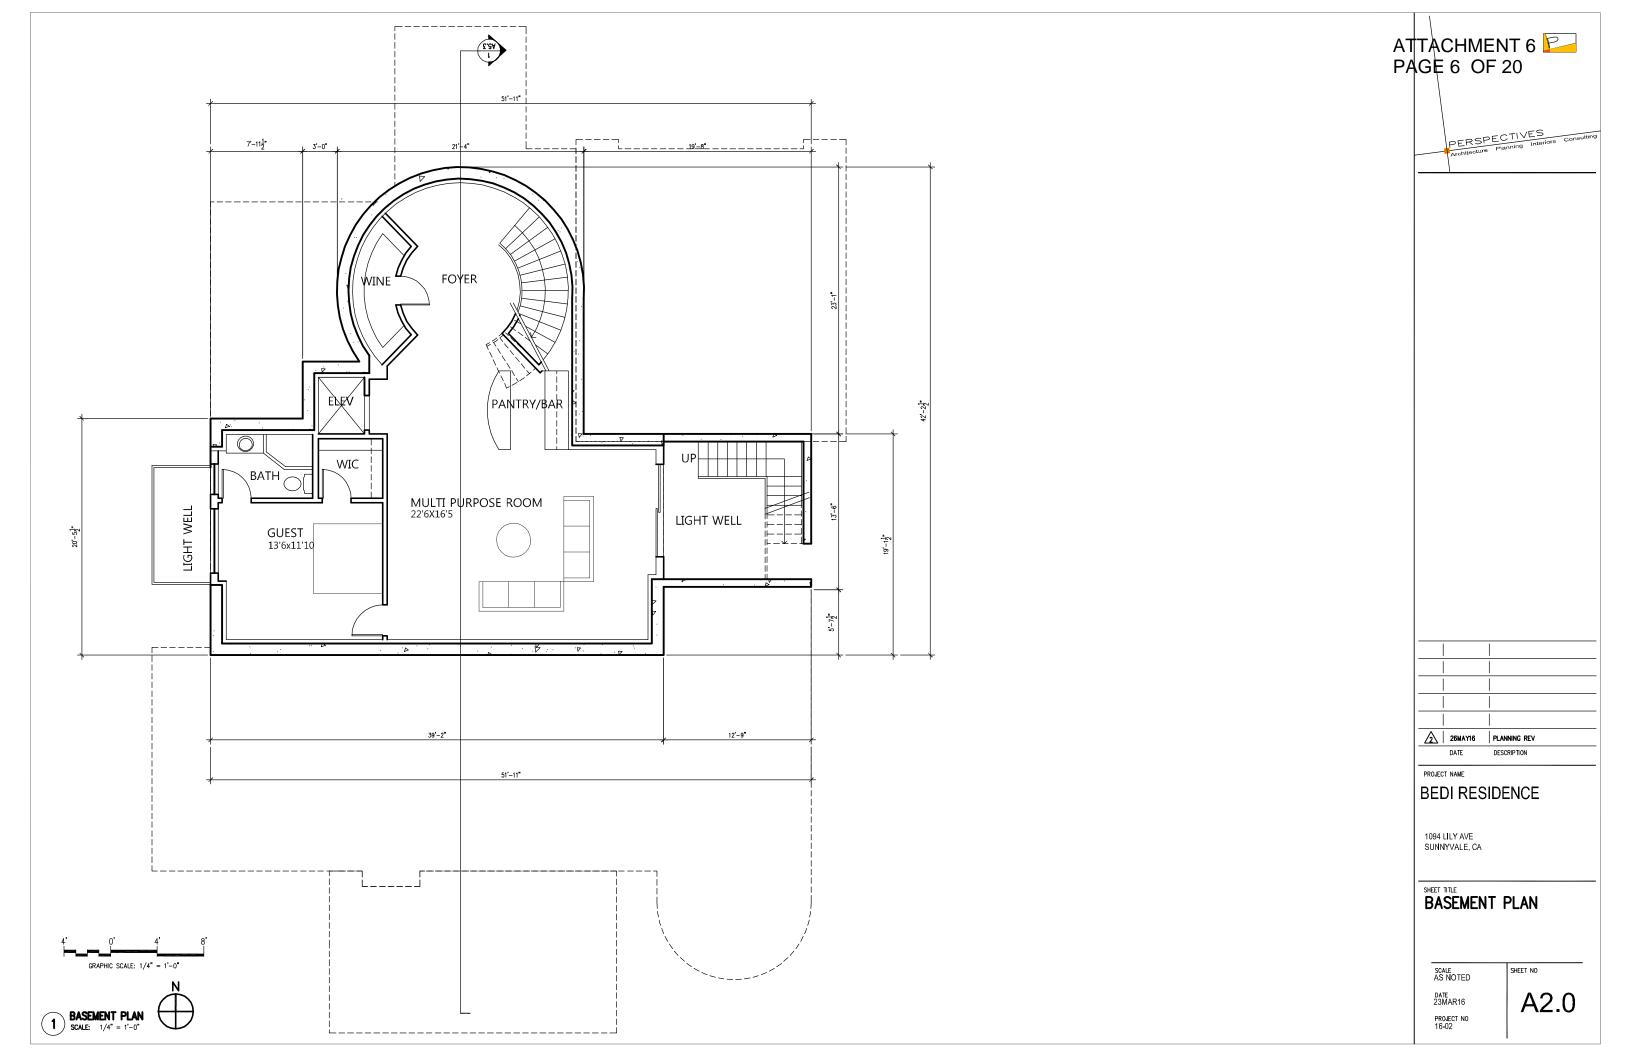

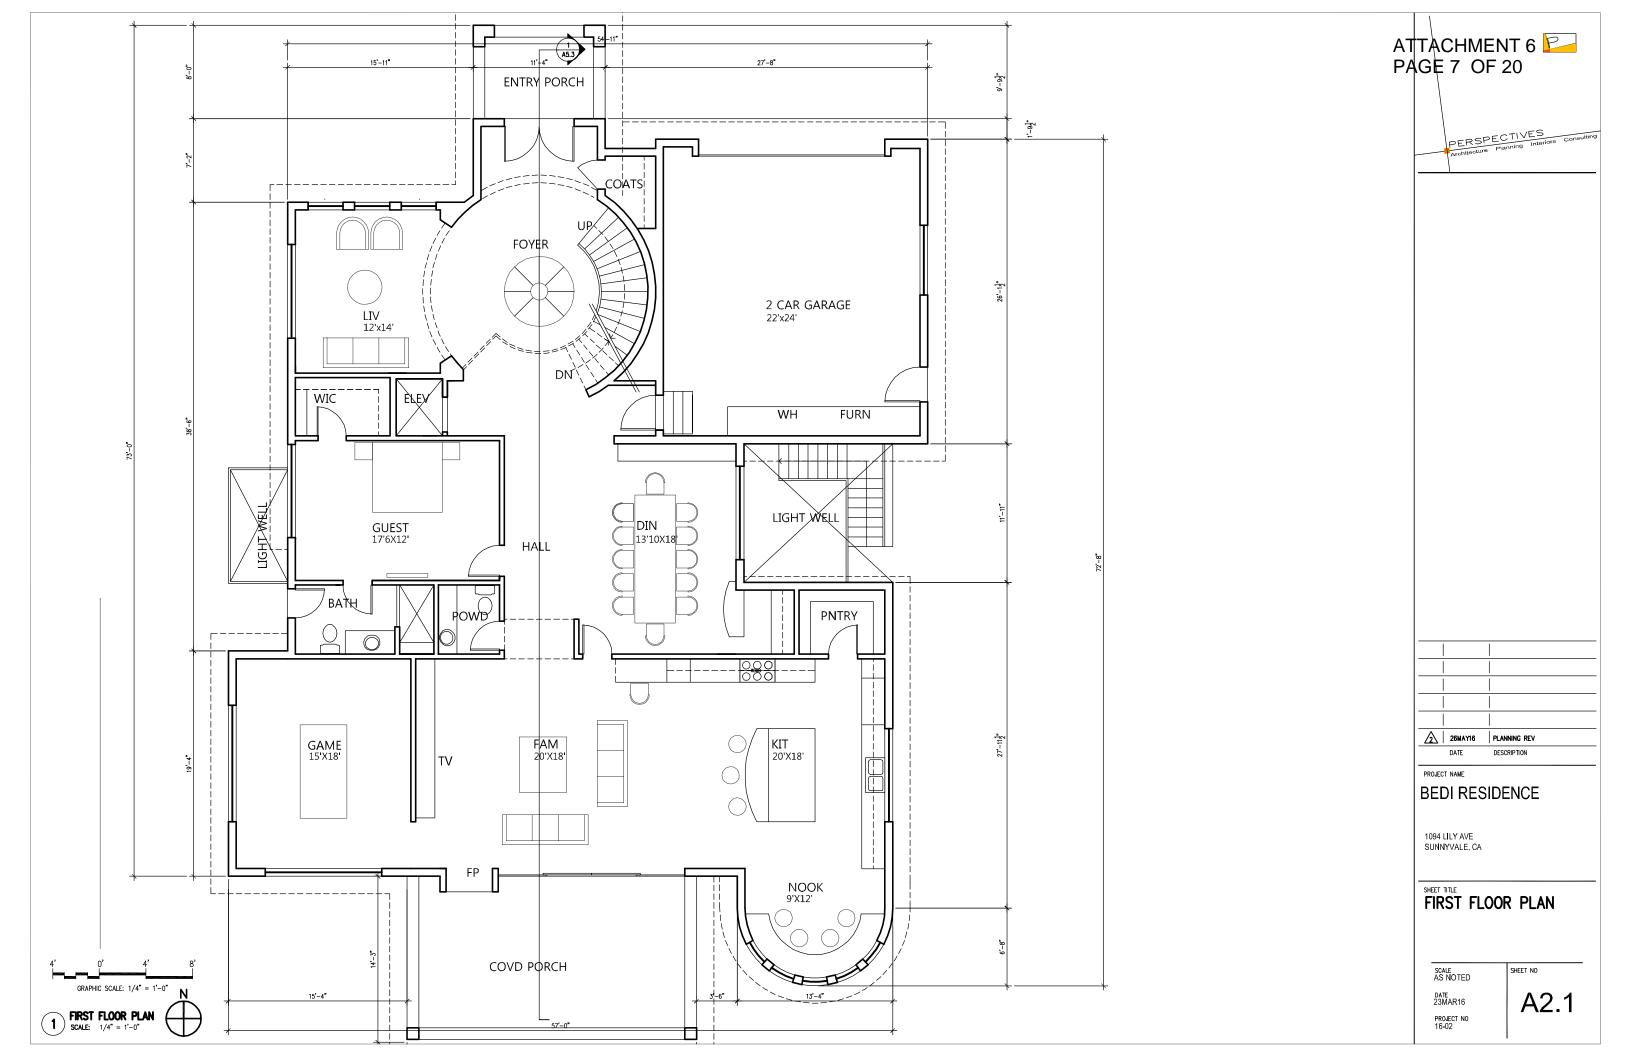

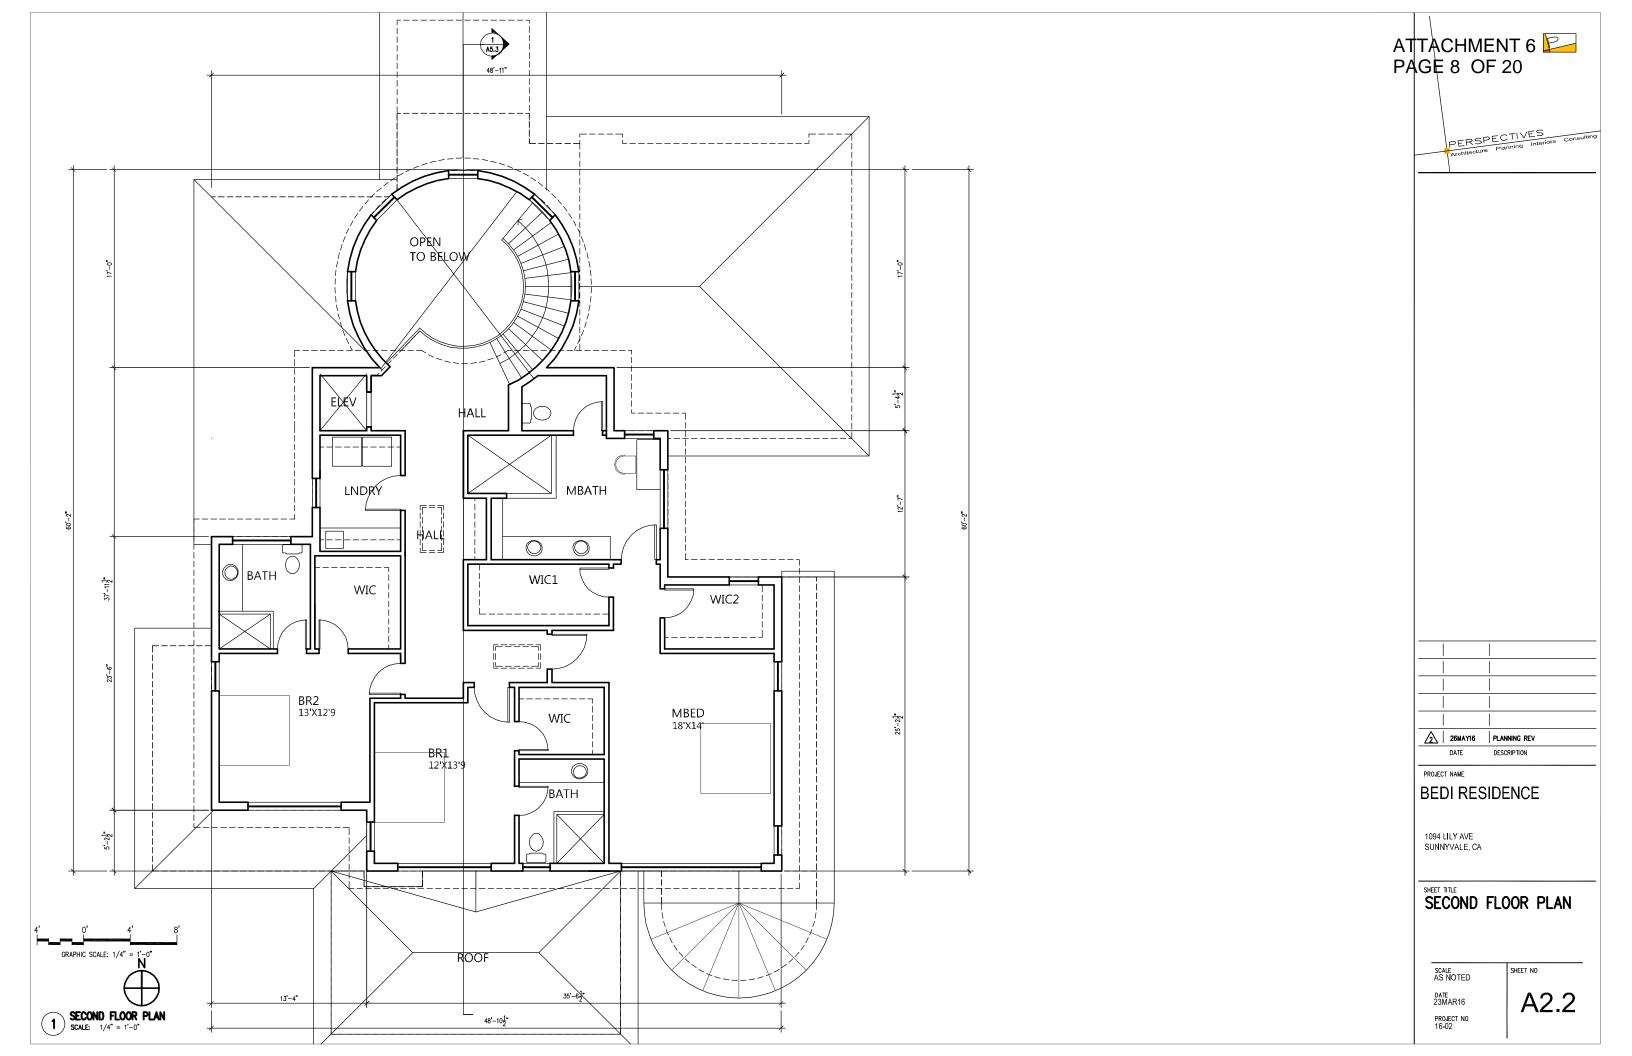

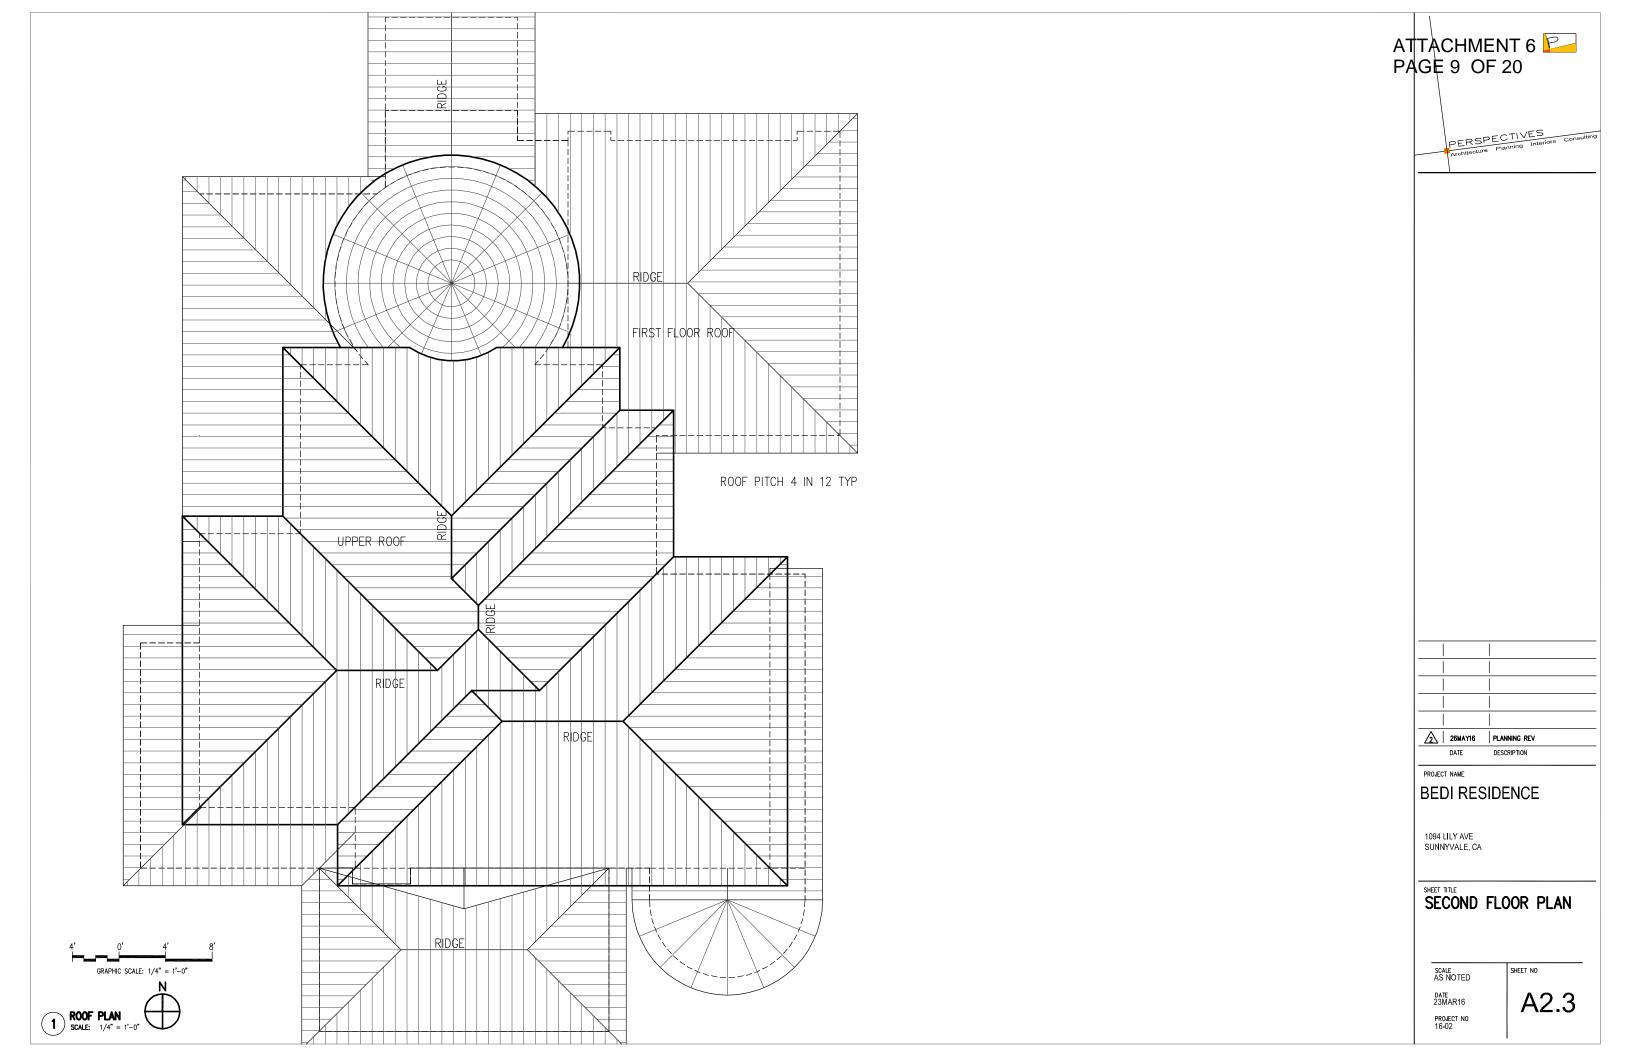

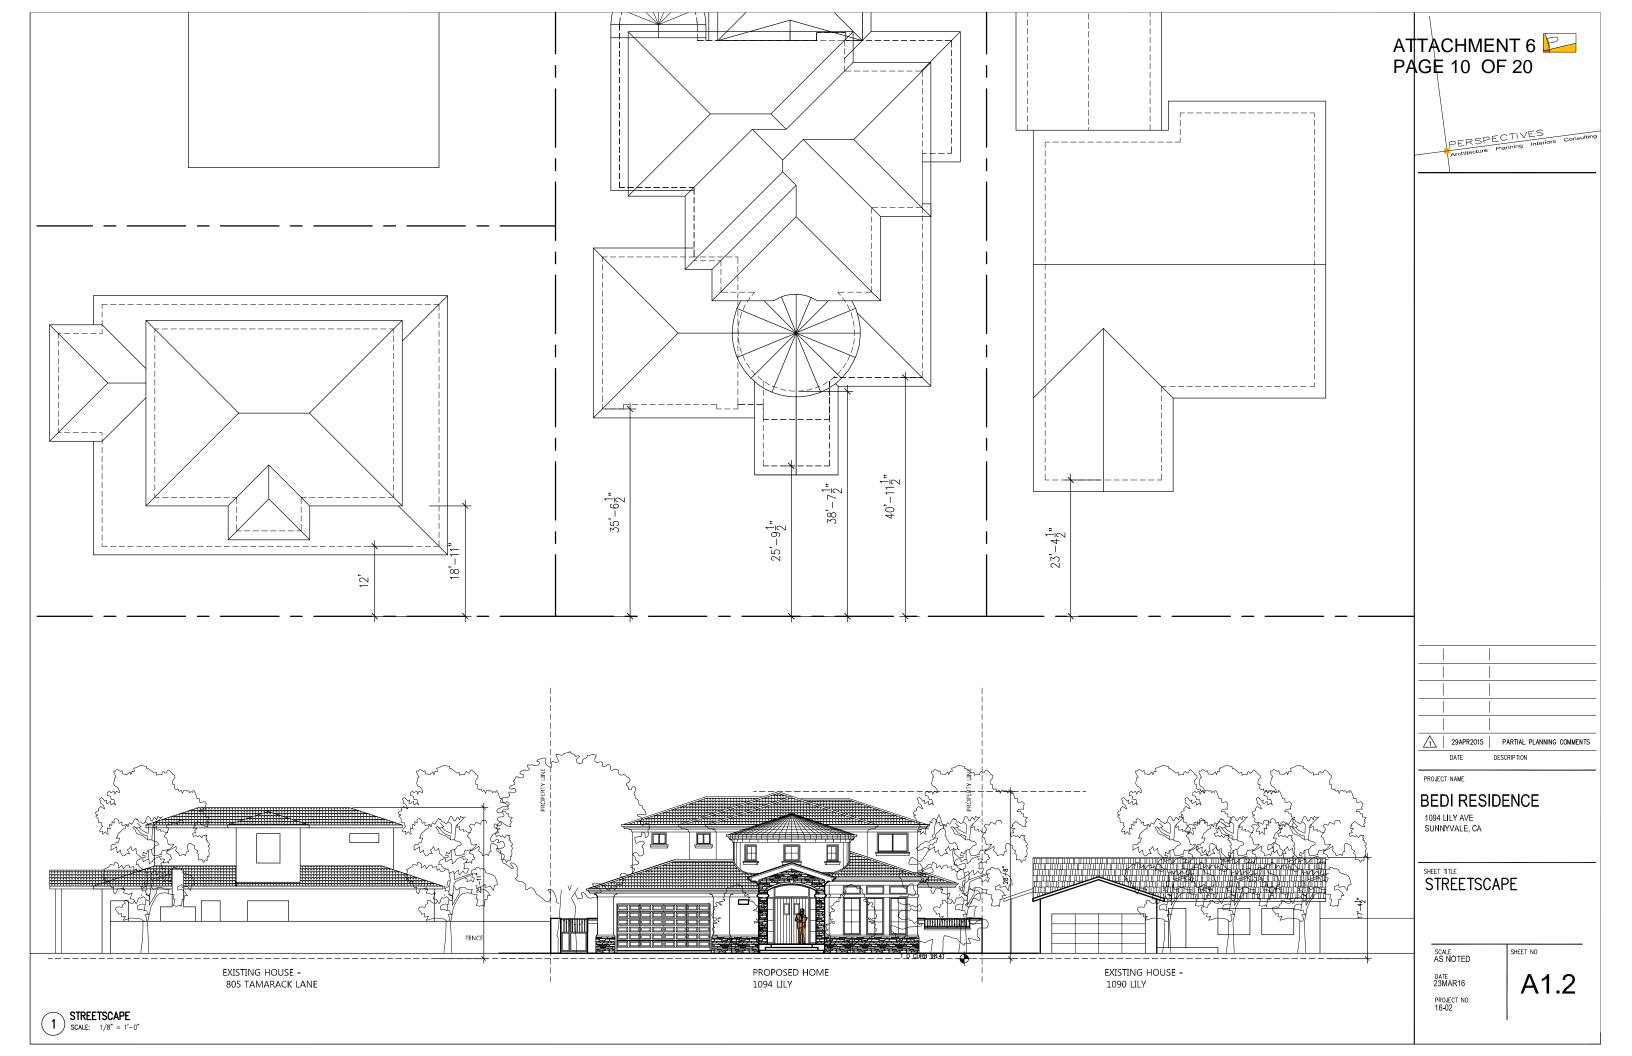







ONC PAN ROOF TILE, ON 1/2" CDX
PLYWD SOLID SHEATHING WITH 30 LB WATERPROOF MEMBRANET TACHMENT 6
INSTALL PER MANUFACTURER'S INSTRUCTIONS
ROOF SLOPE: 4 IN 12

PAGE 12 OF 20

BUILDING NUMBER PLAINLY VISIBLE FROM STREET. CRC SECTION R319

2) 5" OGEE GUTTER OVER PAINTED 1X10 WOOD FACIA. COLOR TO BE SELECTED BY OWNER PROVIDE DOWNSPOUT TO SPLASHBLOCK. ROUTE STORM WATER TO LANDSCAPING

3 STUCCO SOFFIT W/ CONTINUOUS VENT AND DRIP SCREED. PROVIDE LOW VOLTAGE SOFFIT LIGHTS AT FRONT FACADE.

4 CUSTOM ENTRANCE DOOR SYSTEM

5 STUCCO FACADE WITH SMOOTH FINISH - TYP

6 (N) DOUBLE-PANE, LOW "E" WINDOWS TYP. BRAND TO BE SELECTED BY OWNER

7 CUSTOM CARRIAGE STAINED WD GARAGE DOOR

8 2" RECESS TYP AROUND WINDOWS. 4" AT WINDOW SILLS WHERE SHOWN

9 PRESCAST STONE TRIM

(10) 6' HIGH FENCE

\_\_ \_ <u>TOP\_PL+18'-0"</u> \_\_\_

\_ <u>FF +0'-0"= 101' \_ \_ \_</u>\_\_\_

ENTRY PORCH

11) PRECAST STONE BASE TRIM

12) DECORATIVE WROUGHT IRON RAIL

13) PRECAST STONE TRIM

(14) LEDGERSTONE STYLE MANUFACTURED STONE CLADDING

EXTERIOR ELEVATIONS

SHEET NO

A5.1

SCALE AS NOTED


DATE 13MAR16 PROJECT NO 16-02


1094 LILY AVE SUNNYVALE, CA


SIDE (EAST) ELEVATION

SCALE: 1/4" = 1'-0"



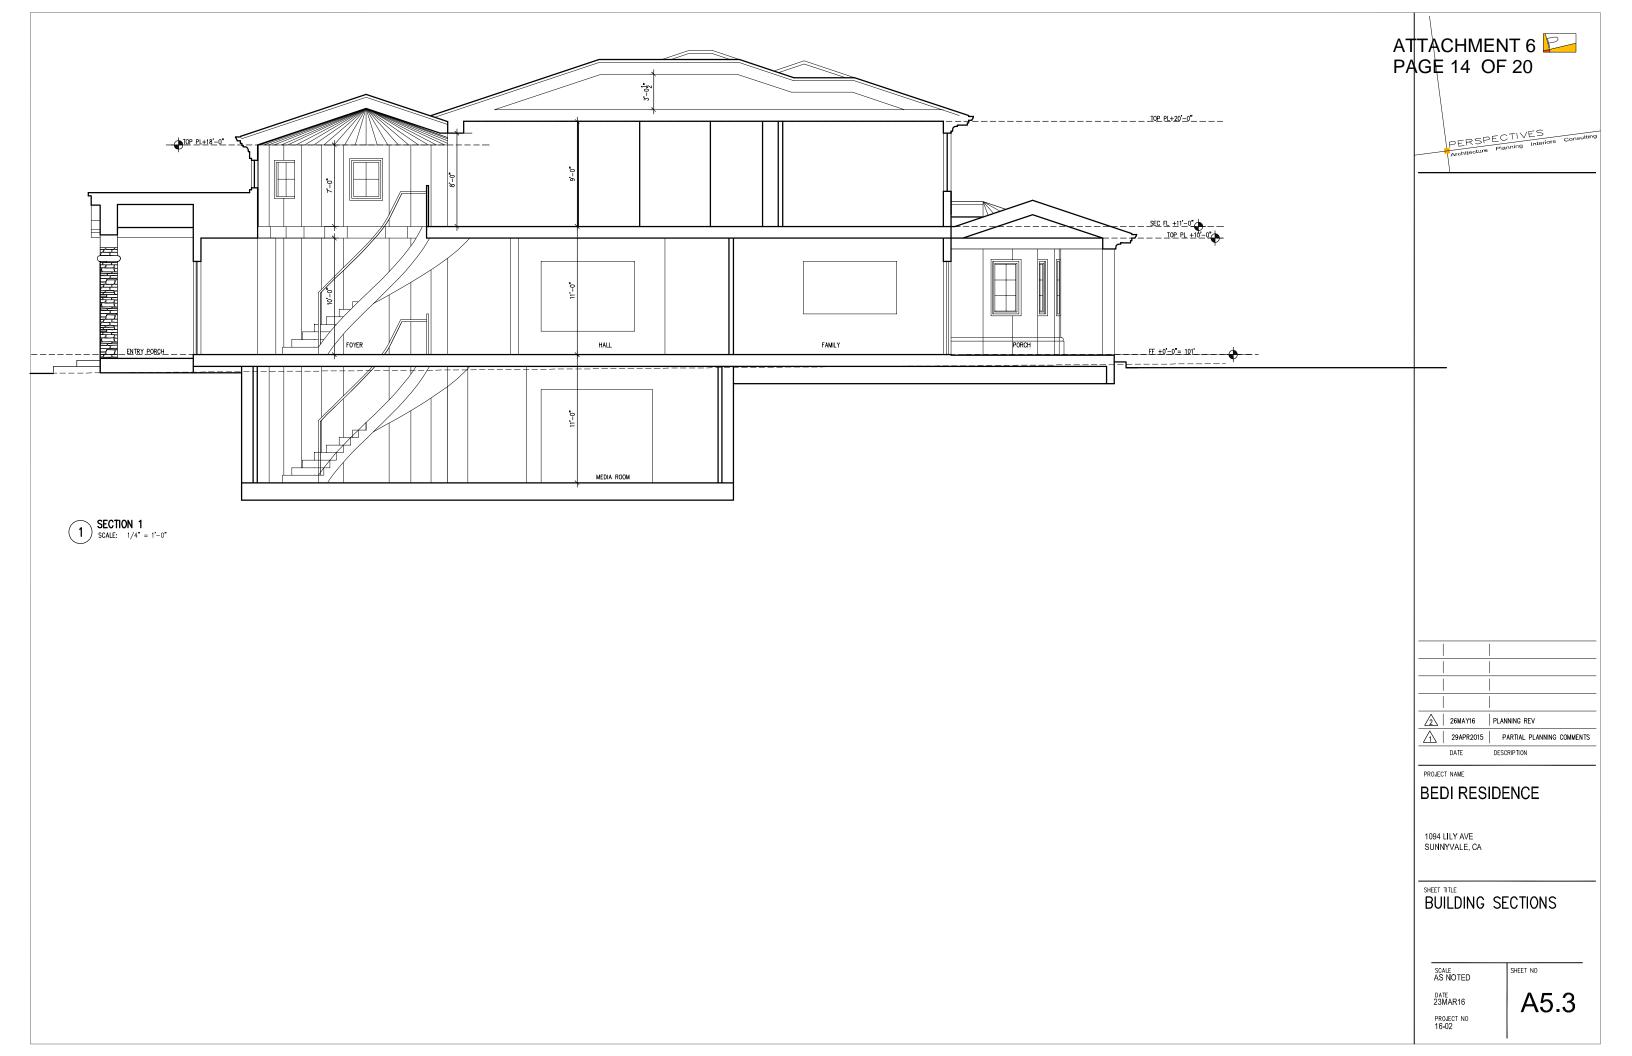

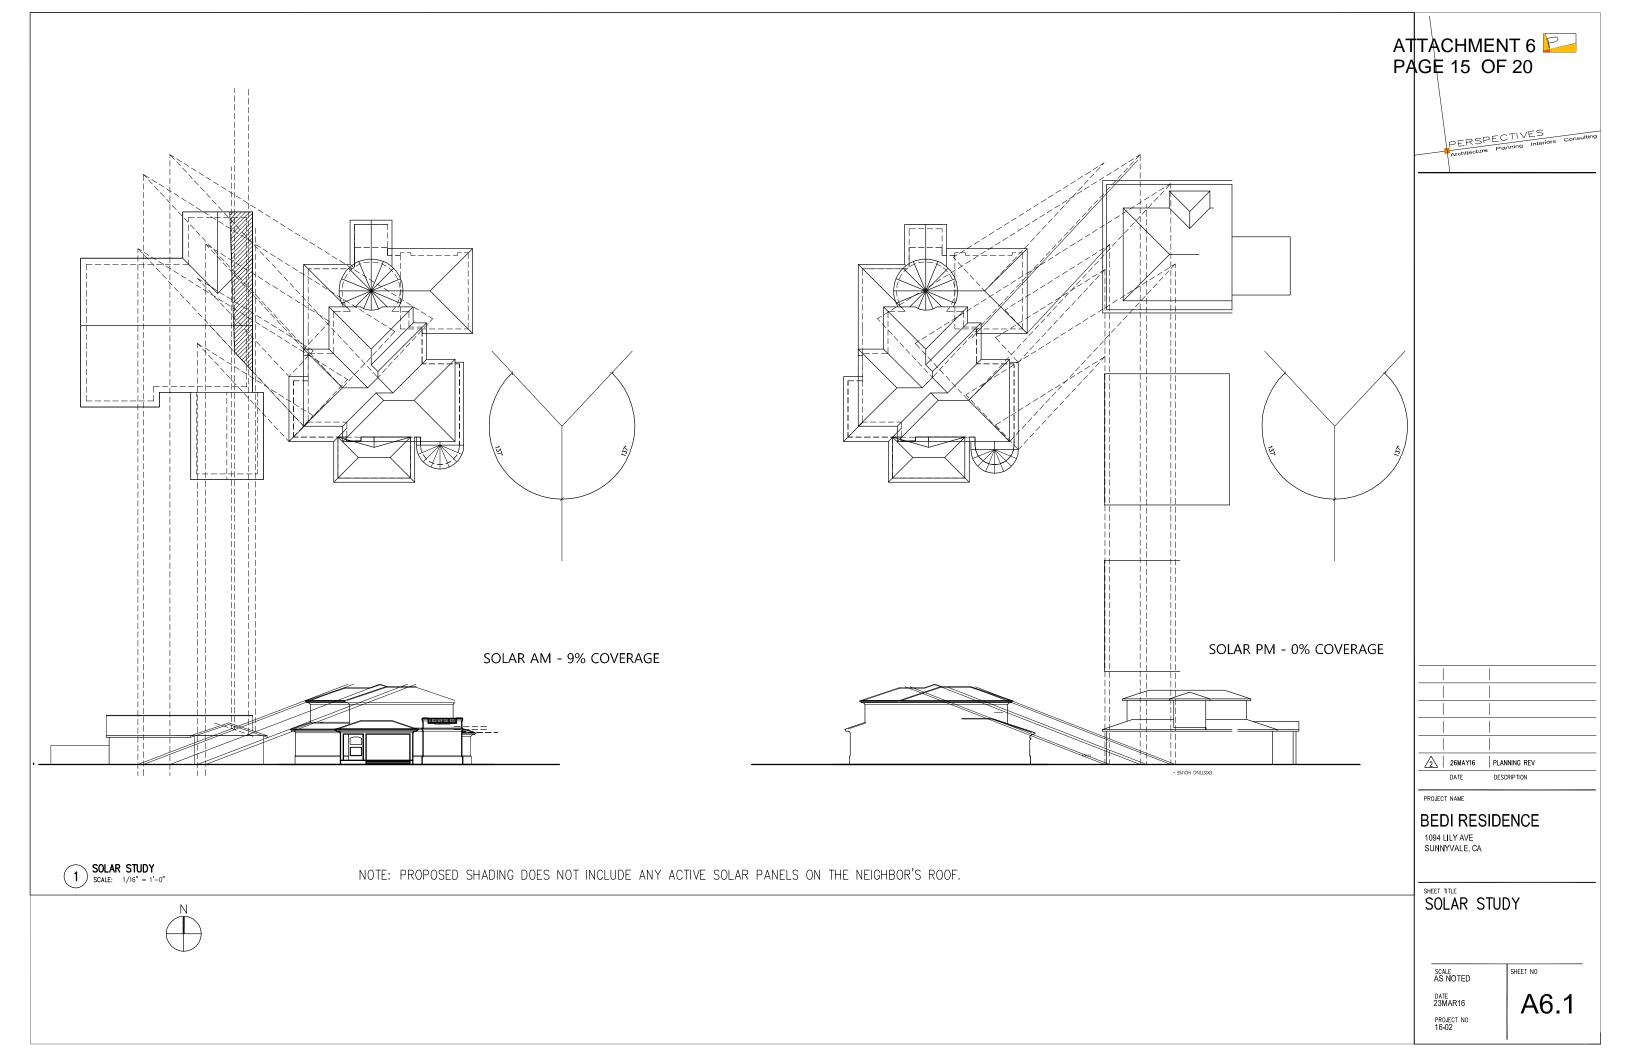


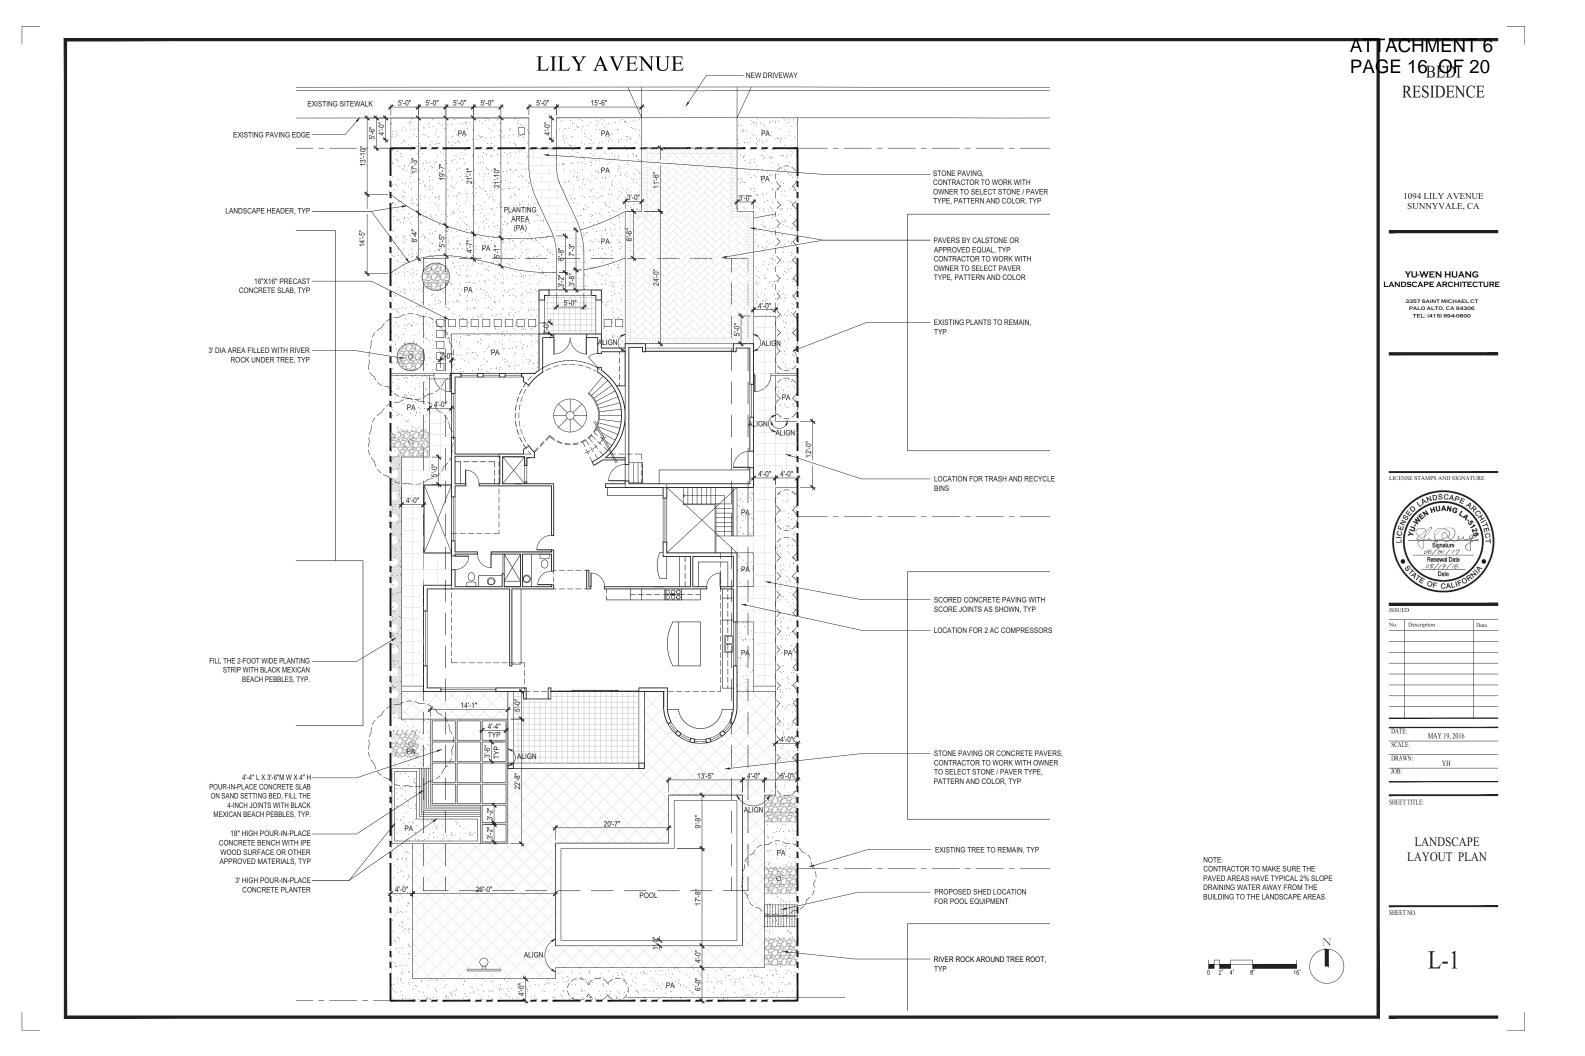

LILY AVENUE

PAGE 17<sub>B</sub>OF 20

RESIDENCE

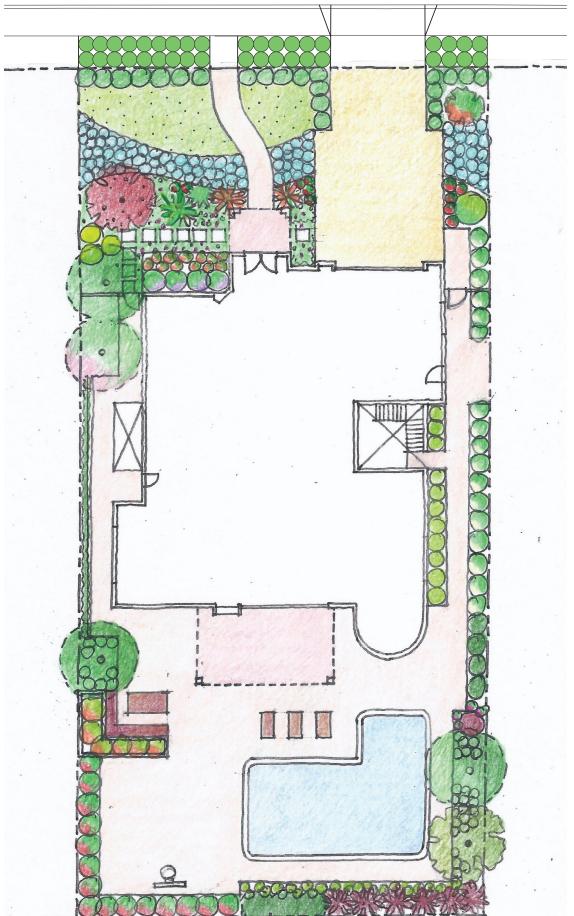

1094 LILY AVENUE SUNNYVALE, CA

#### YU-WEN HUANG LANDSCAPE ARCHITECTURE

3357 SAINT MICHAEL CT PALO ALTO, CA 94306 TEL: (415) 694-0800

LICENSE STAMPS AND SIGNATURE



ISSUED						
No.	Description	Date				
DAT	E: MAY 19, 2016					
SCA						

SHEET TITLE:


CONCEPTUAL LANDSCAPE PLAN


SHEET NO

L-2

#### LANDSCAPE DESIGN NOTE:

DESIGN INTENT - TO CREATE A LOW MAINTENANCE AND HIGH WATER EFFICIENT GARDEN BY CHOOSING NATIVE OR LOW WATER USAGE PLANTS.

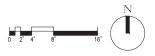

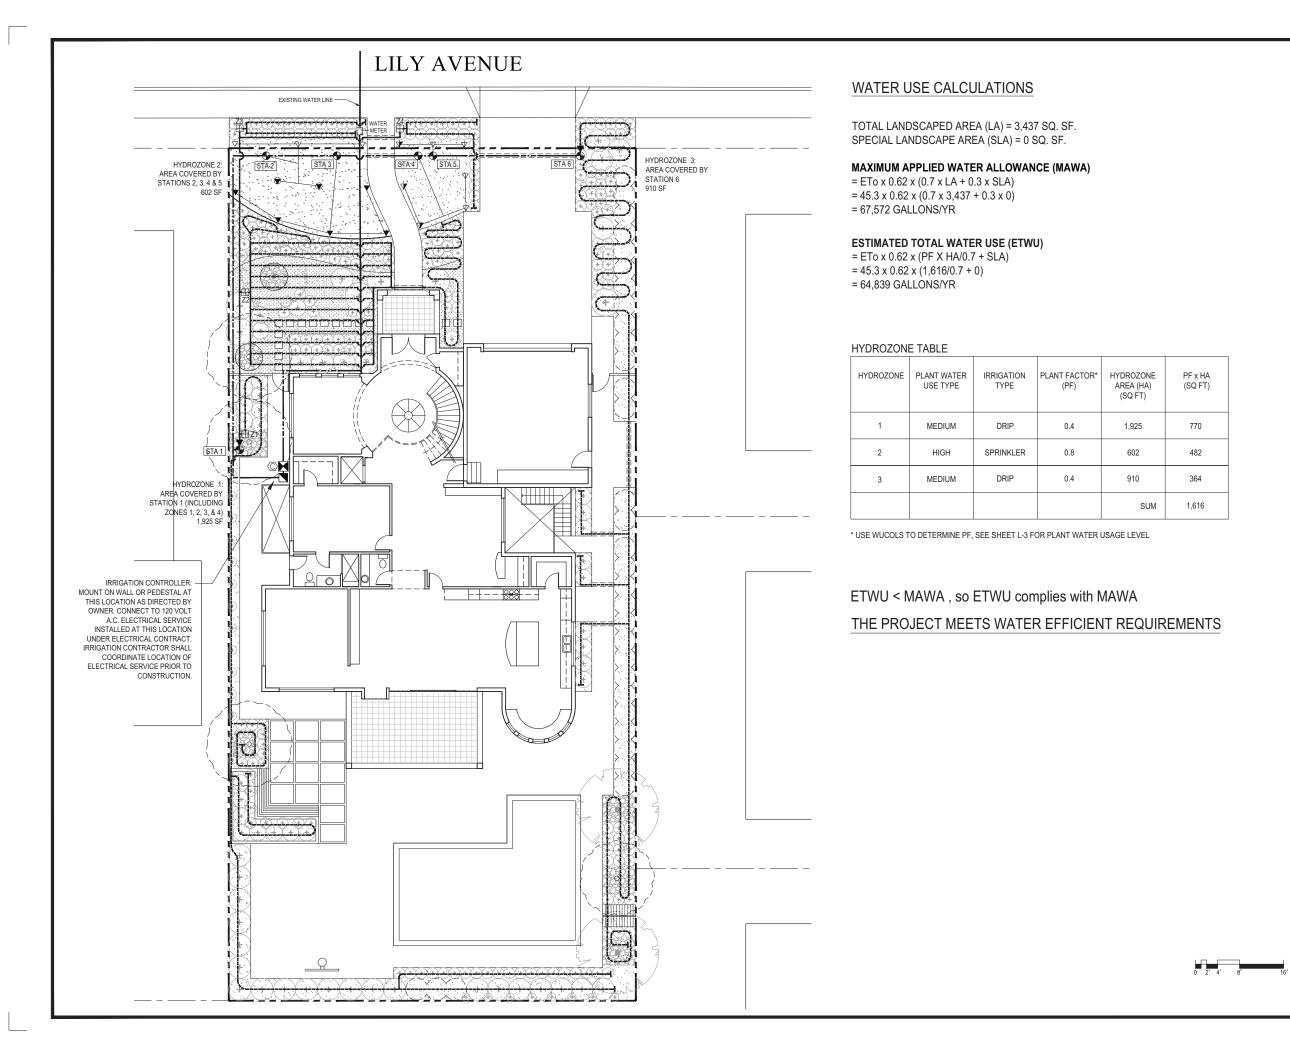

ATTACHMENT 6
PAGE 18<sub>B</sub>OF 20
RESIDENCE

1094 LILY AVENUE SUNNYVALE, CA

YU-WEN HUANG LANDSCAPE ARCHITECTURE

> 3357 SAINT MICHAEL CT PALO ALTO, CA 94306 TEL: (415) 694-0800

LICENSE STAMPS AND SIGNATURE



No.	Description	Dat

DATE: MAY 19, 2016
SCALE:
DRAWN: YH

SHEET TITLE:

IRRIGATION LAYOUT PLAN & WATER USE CALCULATIONS

SHEET NO

IR-1

#### ATTACHMENT 6 PAGE 19<sub>R</sub> OF 20

OPERATING

RADIUS

(FEET)

12-15

10-12

8-10

6-8

4-5

OPERATING

PSI

30

30

30

30

30

N077I F

GPM

3.7,1.9,1

2.6.1.3.0.7

1.6.0.8.0.4

0.5,0.25

0.2,0.1

REMOTE CONTROL VALVE WITH PRESSURE REGULATOR AND

PVC RISER PIPE FOR BRINGING UNDERGROUND PIPE TO THE

DESCRIPTION

6" POP-UP SPRAY SPRINKLER

FILTER FOR DRIP LATERALS

AIR RELIEF VALVE ASSEMBLY

SURFACE AND RAISED PLANTERS

FLUSH VALVE

TIE-DOWN STAKES

MAIN LINE:

LATERAL

MANIFOLD:

SUPPLY AND

LINES:

INLINE

EMITTER:

SLEEVING:

\* WHEN RADIUS OF SPRINKLER HEADS, REQUIRED FOR PROPER COVERAGE, IS LESS THAN RADIUS SHOWN ON LEGEND, THE CONTRACTOR

SHALL EQUIP HEAD WITH A RAIN BIRD "PCS" PRESSURE COMPENSATING SCREEN FOR FLOW AND RADIUS CONTROL. SELECT SCREEN ON PCS NOZZLE SCREEN SELECTION CHART FOR APPROPRIATE RADIUS.

ZONE CONTROL VALVE ASSEMBLY

TEES & ELBOWS FOR ASSEMBLING PIPES

REDUCED PRESSURE BACKFLOW ASSEMBLY

FLOW WENSOR / MASTER VALVE, NORMALLY OPEN.

IRRIGATION CONTROLLER WITH SOLAR SYNC ET SENSOR

2" AND SMALLER:

3/4" AND LARGER:

CLASS 315 PVC PLASTIC PIPE WITH SCHEDULE 40 PVC SOLVENT WELD FITTINGS, 18" COVER

1120-SCHEDULE 40 PVC PLASTIC PIPE WITH

SCHEDULE 40 PVC SOLVENT WELD FITTINGS.

CLASS 315 PVC PLASTIC PIPE WITH SCHEDULE

CLASS 315 PVC PLASTIC PIPE WITH SCHEDULE 40 PVC SOLVENT WELD FITTINGS. 12" COVER.

RAIN BIRD **XFD** DRIPLINE FOR ON-SURFACE

INSTALL PER MANUFACTURER'S

COVER.

APPLICATION, WATER DELIVERY RATE OF 0.4

GALLON PER HOUR, WITH EMITTER SPACING 24"

APART. DRIPLINE LATERAL SPACING 18" TO 24".

1120-CL. 200 PVC PLASTIC PIPE. COVER TO BE

AS INDICATED ABOVE FOR PIPE DEPTH OF

40 PVC SOLVENT WELD FITTINGS, 18" COVER.

#### RESIDENCE

1094 LILY AVENUE SUNNYVALE, CA

YU-WEN HUANG ANDSCAPE ARCHITECTURE

> 3357 SAINT MICHAEL CT PALO ALTO, CA 94306 TEL: (415) 694-0800

I ICENSE STAMPS AND SIGNATURE



No.	Description	Т
		4
_		+
_		
DAT	E: MAY 19, 2016	-
SCA	LE:	_
DRA	WN: YH	-

IRRIGATION NOTES & SCHEDULE

SHEET NO


SHEET TITLE:

IR-2

#### **IRRIGATION PLAN NOTES**

- THE INTENT OF THIS IRRIGATION PLAN IS TO PROVIDE THE MINIMUM AMOUNT OF WATER REQUIRED TO SUSTAIN GOOD PLANT HEALTH.
- THESE IRRIGATION DRAWINGS ARE DIAGRAMMATIC AND INDICATIVE OF THE WORK TO BE INSTALLED. ALL PIPING, VALVES, AND OTHER IRRIGATION COMPONENTS MAY BE SHOWN WITHIN PAVED AREAS FOR GRAPHIC CLARITY ONLY AND ARE TO BE INSTALLED WITHIN PLANTING AREAS. DUE TO THE SCALE OF THE DRAWINGS, IT IS NOT POSSIBLE TO INDICATE ALL OFFSETS. FITTINGS. SLEEVES. CONDUIT. AND OTHER ITEMS WHICH MAY BE REQUIRED. INVESTIGATE THE STRUCTURAL AND FINISHED CONDITION AFFECTING THE CONTRACT WORK INCLUDING OBSTRUCTIONS, GRADE DIFFERENCES OR AREA DIMENSIONAL DIFFERENCES. IN THE EVENT OF FIELD DISCREPANCY WITH CONTRACT DOCUMENTS. PLAN THE INSTALLATION WORK ACCORDINGLY BY NOTIFICATION AND APPROVAL OF OWNER OR THE OWNER'S AUTHORIZED REPRESENTATIVE AND ACCORDING TO THE CONTRACT SPECIFICATIONS, NOTIFY AND COORDINATE IRRIGATION CONTRACT WORK WITH APPLICABLE CONTRACTORS FOR THE LOCATION AND INSTALLATION OF PIPE, CONDUIT OR SLEEVES THROUGH OR UNDER WALLS, ROADWAYS, PAVING AND STRUCTURES BEFORE CONSTRUCTION. IN THE EVENT THESE NOTIFICATIONS ARE NOT PERFORMED. THE CONTRACTOR ASSUMES FULL RESPONSIBILITY FOR REQUIRED
- FOR COMPLETE PERFORMANCE AND TECHNICAL SPECIFICATIONS, IRRIGATION CONTRACTOR TO VISIT SPECIFIED LANDSCAPE PRODUCTS CATALOG VISIT THE PRODUCTS WEBSITE OR CONTACT THE REPRESENTATIVES OF THE IRRIGATION PRODUCTS\ MANUFACTURERS.
- IRRIGATION PIPE AND WIRE CROSSING BENEATH HARDSCAPE SURFACES SHALL BE CONTAINED WITHIN SLEEVING OR SCHEDULE 40 PVC CONDUIT. SLEEVING SIZE SHALL BE A MINIMUM OF TWO TIMES THE AGGREGATE DIAMETER OF ALL PIPES CONTAINED WITHIN SLEEVE. PROVIDE VERTICAL SWEEP FOR ALL ELECTRICAL CONDUIT ON EACH SIDE OF HARDSCAPE AND TERMINATE ENDS AT 12" MINIMUM DEPTH AND 12" FROM HARDSCAPE SURFACE.
- IT IS THE RESPONSIBILITY OF THE MAINTENANCE CONTRACTOR AND/OR OWNER TO PROGRAM THE IRRIGATION CONTROLLER(S) TO PROVIDE THE MINIMUM AMOUNT OF WATER NEEDED TO SUSTAIN GOOD PLANT HEALTH. THIS INCLUDES MAKING ADJUSTMENTS TO THE PROGRAM FOR SEASONAL WEATHER CHANGES, PLANT MATERIAL, WATER REQUIREMENTS, MOUNDS, SLOPES, SUN, SHADE AND WIND EXPOSURE.
- INSTALL REMOTE CONTROL VALVE BOXES 12" FROM WALK, CURB, HEADER BOARD, BUILDING, OR LANDSCAPE FEATURE, AT MULTIPLE VALVE BOX GROUPS, INSTALL EACH BOX 12" FROM THE WALK, CURB, HEADER BOARD. BUILDING, OR LANDSCAPE FEATURE AND INSTALL EACH BOX 12" APART.
- INSTALL A GATE VALVE TO ISOLATE EACH REMOTE CONTROL VALVE OR GROUP OF RCV'S LOCATED TOGETHER. GATE VALVE SIZE SHALL BE SAME AS THE LARGEST REMOTE CONTROL VALVE IN MANIFOLD.
- 8. IT IS THE RESPONSIBILTY OF A LICENSED ELECTRICAL CONTRACTOR TO PROVIDE 120 VOLT A.C. (2.5 AMP DEMAND PER CONTROLLER) ELECTRICAL SERVICE TO THE CONTROLLER LOCATION(S). IT IS THE RESPOSIBILITY OF THE IRRIGATION CONTRACTOR TO COORDINATE THE ELECTRICAL SERVICE STUB-OUT TO THE CONTROLLER(S). PROVIDE PROPER GROUNDING PER CONTROLLER MANUFACTURER'S INSTRUCTIONS AND NACCORDANCE WITH LOCAL CODES.

- PROVIDE EACH CONTROLLER WITH ITS OWN GROUND ROD. SEPARATE THE GROUND RODS BY A MINIMUM OF EIGHT FEET. THE GROUND ROD SHALL BE AN EIGHT FOOT LONG BY 5/8" DIAMETER U.L. APPROVED COPPER CLAD ROD. INSTALL NO MORE THAN 6" OF THE GROUND ROD ABOVE FINISH GRADE. CONNECT #6 GAUGE WIRE WITH A U.L. APPROVED GROUND ROD CLAMP TO ROD AND BACK TO GROUND SCREW AT BASE OF CONTROLLER WITH APPROPRIATE CONNECTOR. MAKE THIS WIRE AS SHORT AS POSSIBLE, AVOIDING KINKS OR BENDING.
- 10. PROVIDE EACH IRRIGATION CONTROLLER WITH ITS OWN IDEPENDENT LOW VOLTAGE COMMON GROUND WIRE.
- INSTALL NEW BATTERIES IN THE IRRIGAITON CONTROLLER(S) TO RETAIN PROGRAM IN MEMORY DURING TEMPORARY POWER FAILURES. ISE QUANTITY, TYPE AND SIZE REQUIRED AS PER CONTROLLER MANUFACTURER'S INSTRUCTIONS
- THE IRRIGATION CONTRACTOR SHALL BE RESPONSIBLE FOR MINOR CHANGES IN THE IRRIGATION LAYOUT DUE TO OBSTRUCTIONS NOT SHOWN ON THE IRRIGATION DRAWINGS SUCH AS LIGHTS, UTILITY BOXES, ELECTRICAL
- 13. NOTIFY LOCAL JURISDICTIONS FOR INSPECTION AND TESTING OF INSTALLED BACKFLOW PREVENTION DEVICE.
- 14. PIPE THREAD SEALANT COMPOUND SHALL BE RECTOR SEAL #5.
- NSTALL GREEN PLASTIC VALVE BOXES WITH BOLT DOWN, NON HINGED COVER MARKED "IRRIGATION". BOX BODY SHALL HAVE KNOCK OUTS. ACCEPTABLE VALVE BOX MANUFACTURER'S INCLUDE NDS, CARSON OR
- 16. INSTALL A GATE VALVE TO ISOLATE EACH REMOTE CONTROL VALVE OR GROUP OF RCV'S LOCATED TOGETHER. GATE VALVE SIZE SHALL BE SAME AS THE LARGEST REMOTE CONTROL VALVE IN MANIFOLD.
- IRRIGATION CONTROL WIRES: SOLID COPPER WITH U.L. APPROVAL FOR DIRECT BURIAL IN GROUND. CONTROL WIRE SERVICING REMOTE CONTROL VALVES: SIZE #14-1 WIRE WITH A UNIQUE COLOR INSULATING JACKET FOR EACH CONTROLLER. COMMON GROUND WIRE: SIZE #12-1 WIRE WITH A WHITE I INSULATING JACKET AND A STRIPE OF COLOR WHICH MATCH'S THE CONTROL WIRE COLOR CHOICE FOR SPECIFIC CONTROLLER. SPARE WIRE: #14-1 WIRE WITH BLACK INSULATION JACKET. SPLICES SHALL BE MADE WITH 3M-DBY SEAL PACKS OR
- 18. INSTALL TWO SPARE CONTROL WIRES OF A DIFFERENT COLOR ALONG THE ENTIRE MAIN LINE. LOOP 36" EXCESS WIRE INTO EACH SINGLE VALVE BOX AND INTO ONE VALVE BOX IN EACH GROUP OF VALVES.
- 19. SPLICING OF LOW VOLTAGE WIRES IS PERMITTED IN VALVE BOXES ONLY. LEAVE A 36" LONG, 1" DIAMETER COIL OF EXCESS WIRE AT EACH SPLICE AND A 36" LONG EXPANSION LOOP EVERY 100 FEET ALONG WIRE RUN. TAPE WIRES TOGETHER EVERY TEN FEET. DO NOT TAPE WIRES TOGETHER WHERE CONTAINED WITHIN SLEEVING OR
- 20. SCHEDULE A MEETING WHICH INCLUDES REPRESENTATIVES OF THE IRRIGATION CONTROLLER MANUFACTURER, THE OWNER AND THE IRRIGATION CONTRACTOR AT THE SITE FOR INSTRUCTION ON THE PROPER PROGRAMMING AND OPERATION OF THE IRRIGATION CONTROLLER

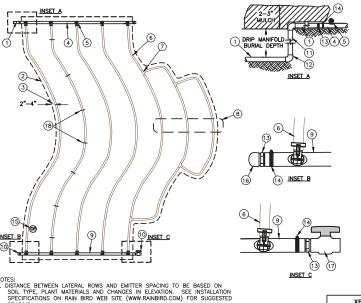

PVC SUPPLY PIPE FROM RAIN BIRD CONTROL ZONE KIT (SIZED TO MEET LATERAL FLOW DEMAND)
 PERIMETER OF AREA

**IRRIGATION LEGEND** 

MANUFACTURER

RAIN BIRD

WILKINS

DATA INDUSTRIAL

HUNTER

**BAIN BIRD** 

\_\_\_\_\_\_

\_\_\_\_\_\_

MODEL NO

1806-SAM-PRS-15

1806-SAM-PRS-12

1806-SAM-PRS-10

1806-SAM-PRS-8 H.Q

1806-SAM-PRS-5 H,Q

MANUFACTURER'S

RECOMMENDATION

975XLSEU-1

SATELLITE MODEL

XFD- 06 - 24 - 500

REFER TO

NUMBER

PRO-C

F.H.Q

F,H,Q

F.H.Q

SYMBOL

 $\bigcirc$   $\lor$   $\lor$ 

O V 🕏

● ▼ 、

**A A** 

 $\Delta$   $\Delta$ 

 $\blacksquare$ 

T

 $\langle \mathbb{C} \rangle$ 

- (3) PERIMETER DRIPLINE PIPE TO BE INSTALLED 2"-4" FROM PERIMETER OF AREA (4) QF-SUPPLY HEADER
- 5 PRE-INSTALLED BARB FITTING
- (6) RAIN BIRD XFD SERIES DRIPLINE (TYPICAL)
- (7) BARB X BARB INSERT TEE:
  RAIN BIRD XFF-TEE (TYPICAL)
  (8) TOTAL LENGTH OF SELECTED DRIPLINE SHOULD
  NOT EXCEED LENGTH SHOWN IN TABLE
  (9) QF-FLUSH HEADER
- (1) FLUSH POINT WITH PVC CAP OR OPTIONAL PVC BALL VALVE (1) PVC RISER PIPE
- (12) PVC SCH 40 ELL (TYPICAL)
- (13) MALE ADAPTER INSERT
- (14) STAINLESS STEEL, OFTIKER OR MURRAY CLAMP
- (15) OPERATION INDICATOR
  RAIN BIRD MODEL: OPERIND
  (16) PVC SCH 40 CAP
- (17) PVC SCH 40 BALL VALVE
- (B) XF SERIES TIE-DOWN STAKES (TDS-050)
  REFER TO RAIN BIRD DRIPLINE DESIGN GUIDE
  FOR PROPER SPACING

XFD Dripline Maximum Lateral Lengths (Feet)									
	12" Spacing		18" Spacing		24" Spacing				
Inlet Pressure psi	Nominal Flow (gph)		Nominal Flow (gph)		Nominal Flow (gph)				
	0.6	0.9	0.6	0.9	0.6	0.9			
15	273	155	314	250	424	322			
20	318	169	353	294	508	368			
30	360	230	413	350	586	414			
40	395	255	465	402	652	474			
50	417	285	528	420	720	488			
60	460	290	596	455	780	514			

# IRRIGATION LEGEND

- 1 CLEAN BACKFILL MATERIAL
- ② FINISH GRADE (3) LATERAL LINE
- (4) MAIN LINE
- (5) LOW VOLTAGE CONTROL WIRE
  - TRENC'H UNDER HARDSCAPE
- XFD ON-SURFACE DRIPLINE END FEED LAYOUT OF HEADER

SPACING.

S. PACING.

S. LENGTH OF LONGEST DRIPLINE LATERAL SHOULD NOT EXCEED THE MAXIMUM SPACING SHOWN IN THE ACCOMPANYING TABLE.

3. PLACE ITED DOWN STAKES EVERY THREE FEET IN SAND, FOUR FEET IN LOAM, AND FIVE FEET IN CLAY.

AND FIVE FEET IN CLAY.

AND FIVE EET IN CLAY.

4. AT FITTINGS WHERE THERE IS A CHANGE OF DIRECTION SUCH AS TEES OR ELBOWS, USE THE-DOWN STAKES ON EACH LEG OF THE CHANGE OF DIRECTION S. SEE MANUFACTURER'S DETAILS FOR CENTER FEED LAYOUT OF HEADER.