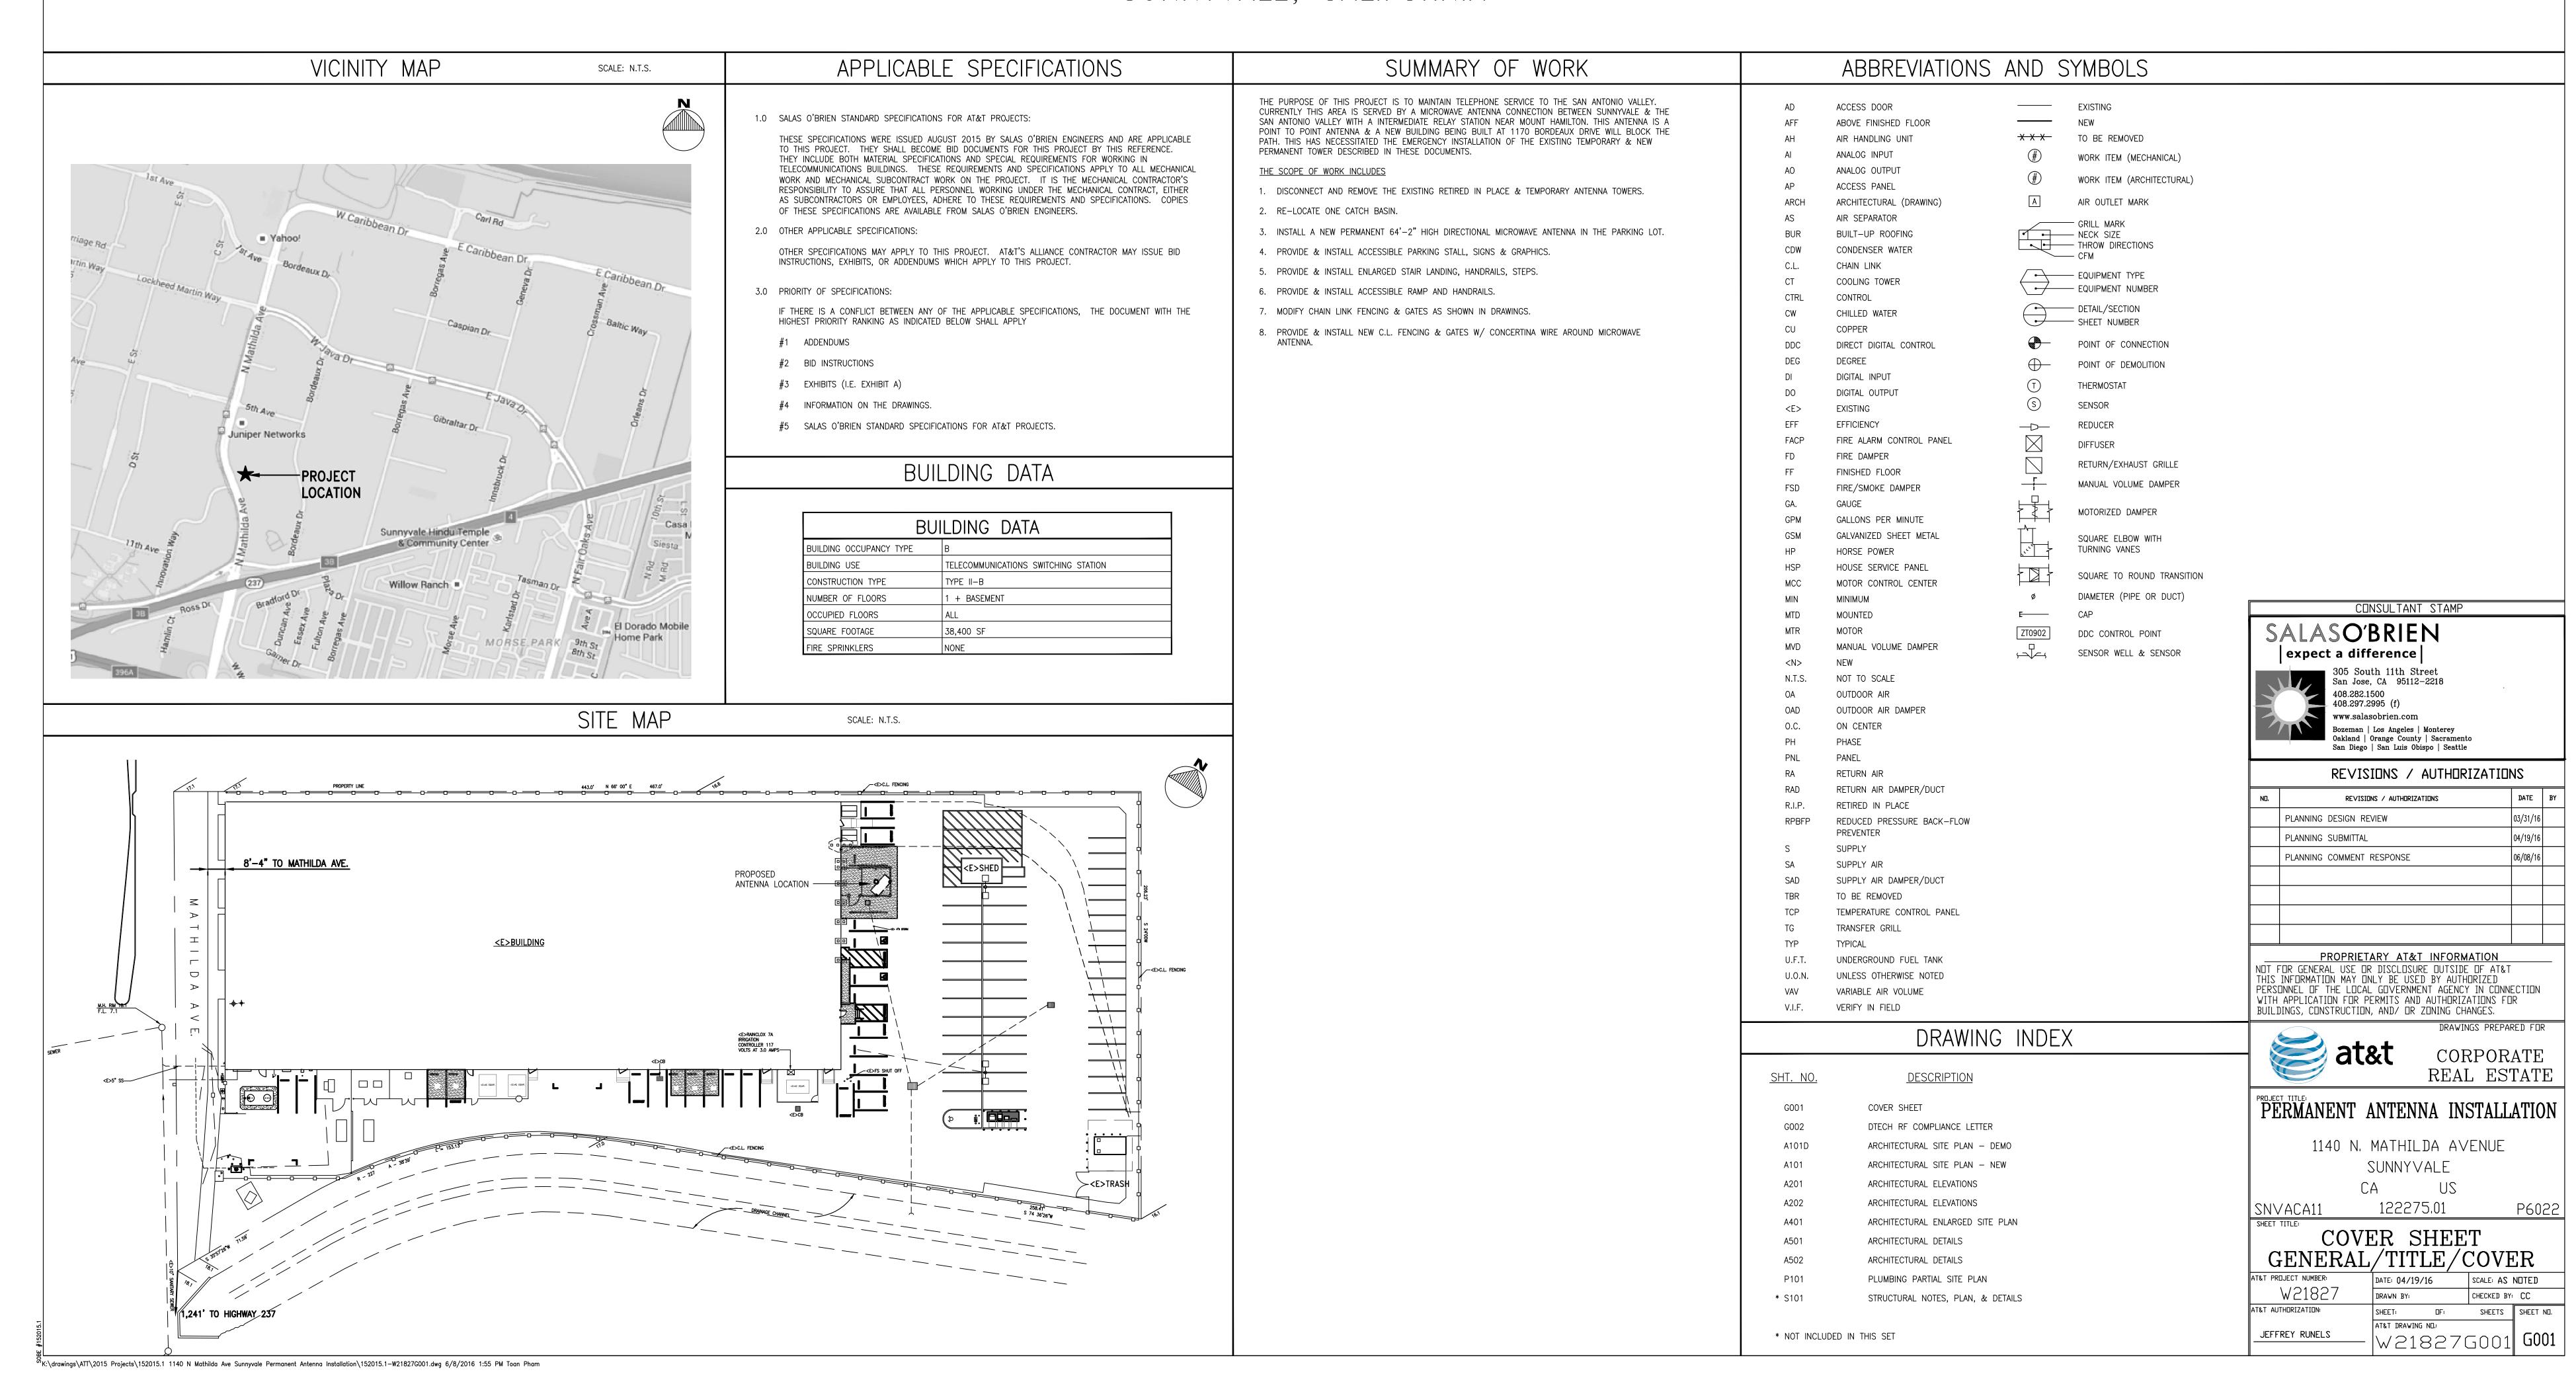


PERMANENT ANTENNA INSTALLATION

1140 N. MATHILDA AVENUE SUNNYVALE, CALIFORNIA



DTECH RF COMPLIANCE LETTER

2 Dtech communications

YOUR RESAFETY PARTNER

February 23, 2016

SUBJECT: RF safety compliance of AT&T's microwave dish site located at 1140 N. Mathilda, Sunnyvale, CA 94089.

To Whom It May Concern:

Dtech Communications, LLC ("Dtech") has been retained by Salas O'Brien, contractors to AT&T, to determine whether its above referenced wireless communications facility complies with the Federal Communications Commission ("FCC") Radio Frequency ("RF") Safety Guidelines. The following summarizes our findings with regard to compliance with the FCC rules and regulations.

BACKGROUND

The FCC states in 47 CFR § 1.1310 that the Maximum Permissible Exposure ("MPE") level from RF emission for the general population is between 0.2 and 1 milliWatts per centimeter squared (mW/cm²) depending upon the frequency (.03 – 100Ghz) of the transmitter. This is a measure of the RF power density at or below which there are no harmful effects for continuous exposure.

ANALYSIS

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Dtech engineers performed a computer-simulated analysis on February 23, 2016. The proposed, site consists of one (1), ten-foot, dish antenna (Commscope/ UHX10-59K RF) mounted on a lattice tower at a centerline elevation of 55-feet above the ground level. The dish will operate at 6226.89 megahertz frequency band with input powers of 3.15 watts (35.0

Microwave systems have very narrow beam patterns and are designed to operate in a line-of-site environment. Therefore, exposure levels observed for a person standing on the ground below the dish antenna are virtually zero.

At antenna elevation (in the air, directly in front of the antenna), the worse-case exposure level is predicted to be 0.173 mW/cm² which is equivalent to 17.3% of the FCC's General Population MPE Limits.

11526 Sorrento Valley Road, Ste. F ▲ San Diego, CA 92121 ▲ 858.792.0066 ▲ www.dtecbcom.com

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CONCLUSION

Based on our findings, it is the undersigned's professional opinion that A'I&'I's site will be compliant with the FCC's RF Safety Guidelines. The worse-case exposure level is predicted to be well below the FCC's General Population MPE Limits for continuous exposure. It is important to note that the FCC's MPE Limits are set at 50 times below the adverse-health-effect threshold according to scientific knowledge.

Please contact me should you require additional information.

Darang Tech, P.E. CEO, Dtech Communications



Dtech

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FOR PLANNING DEPARTMENT REFERENCE ONLY



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NO.	REVISIONS / AUTHORIZATIONS	DATE	BY
	PLANNING DESIGN REVIEW	03/31/16	
	PLANNING SUBMITTAL	04/19/16	
	PLANNING COMMENT RESPONSE	06/08/16	

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DRAWINGS PREPARED FOR CORPORATE

SCALE: AS NOTED

PERMANENT ANTENNA INSTALLATION

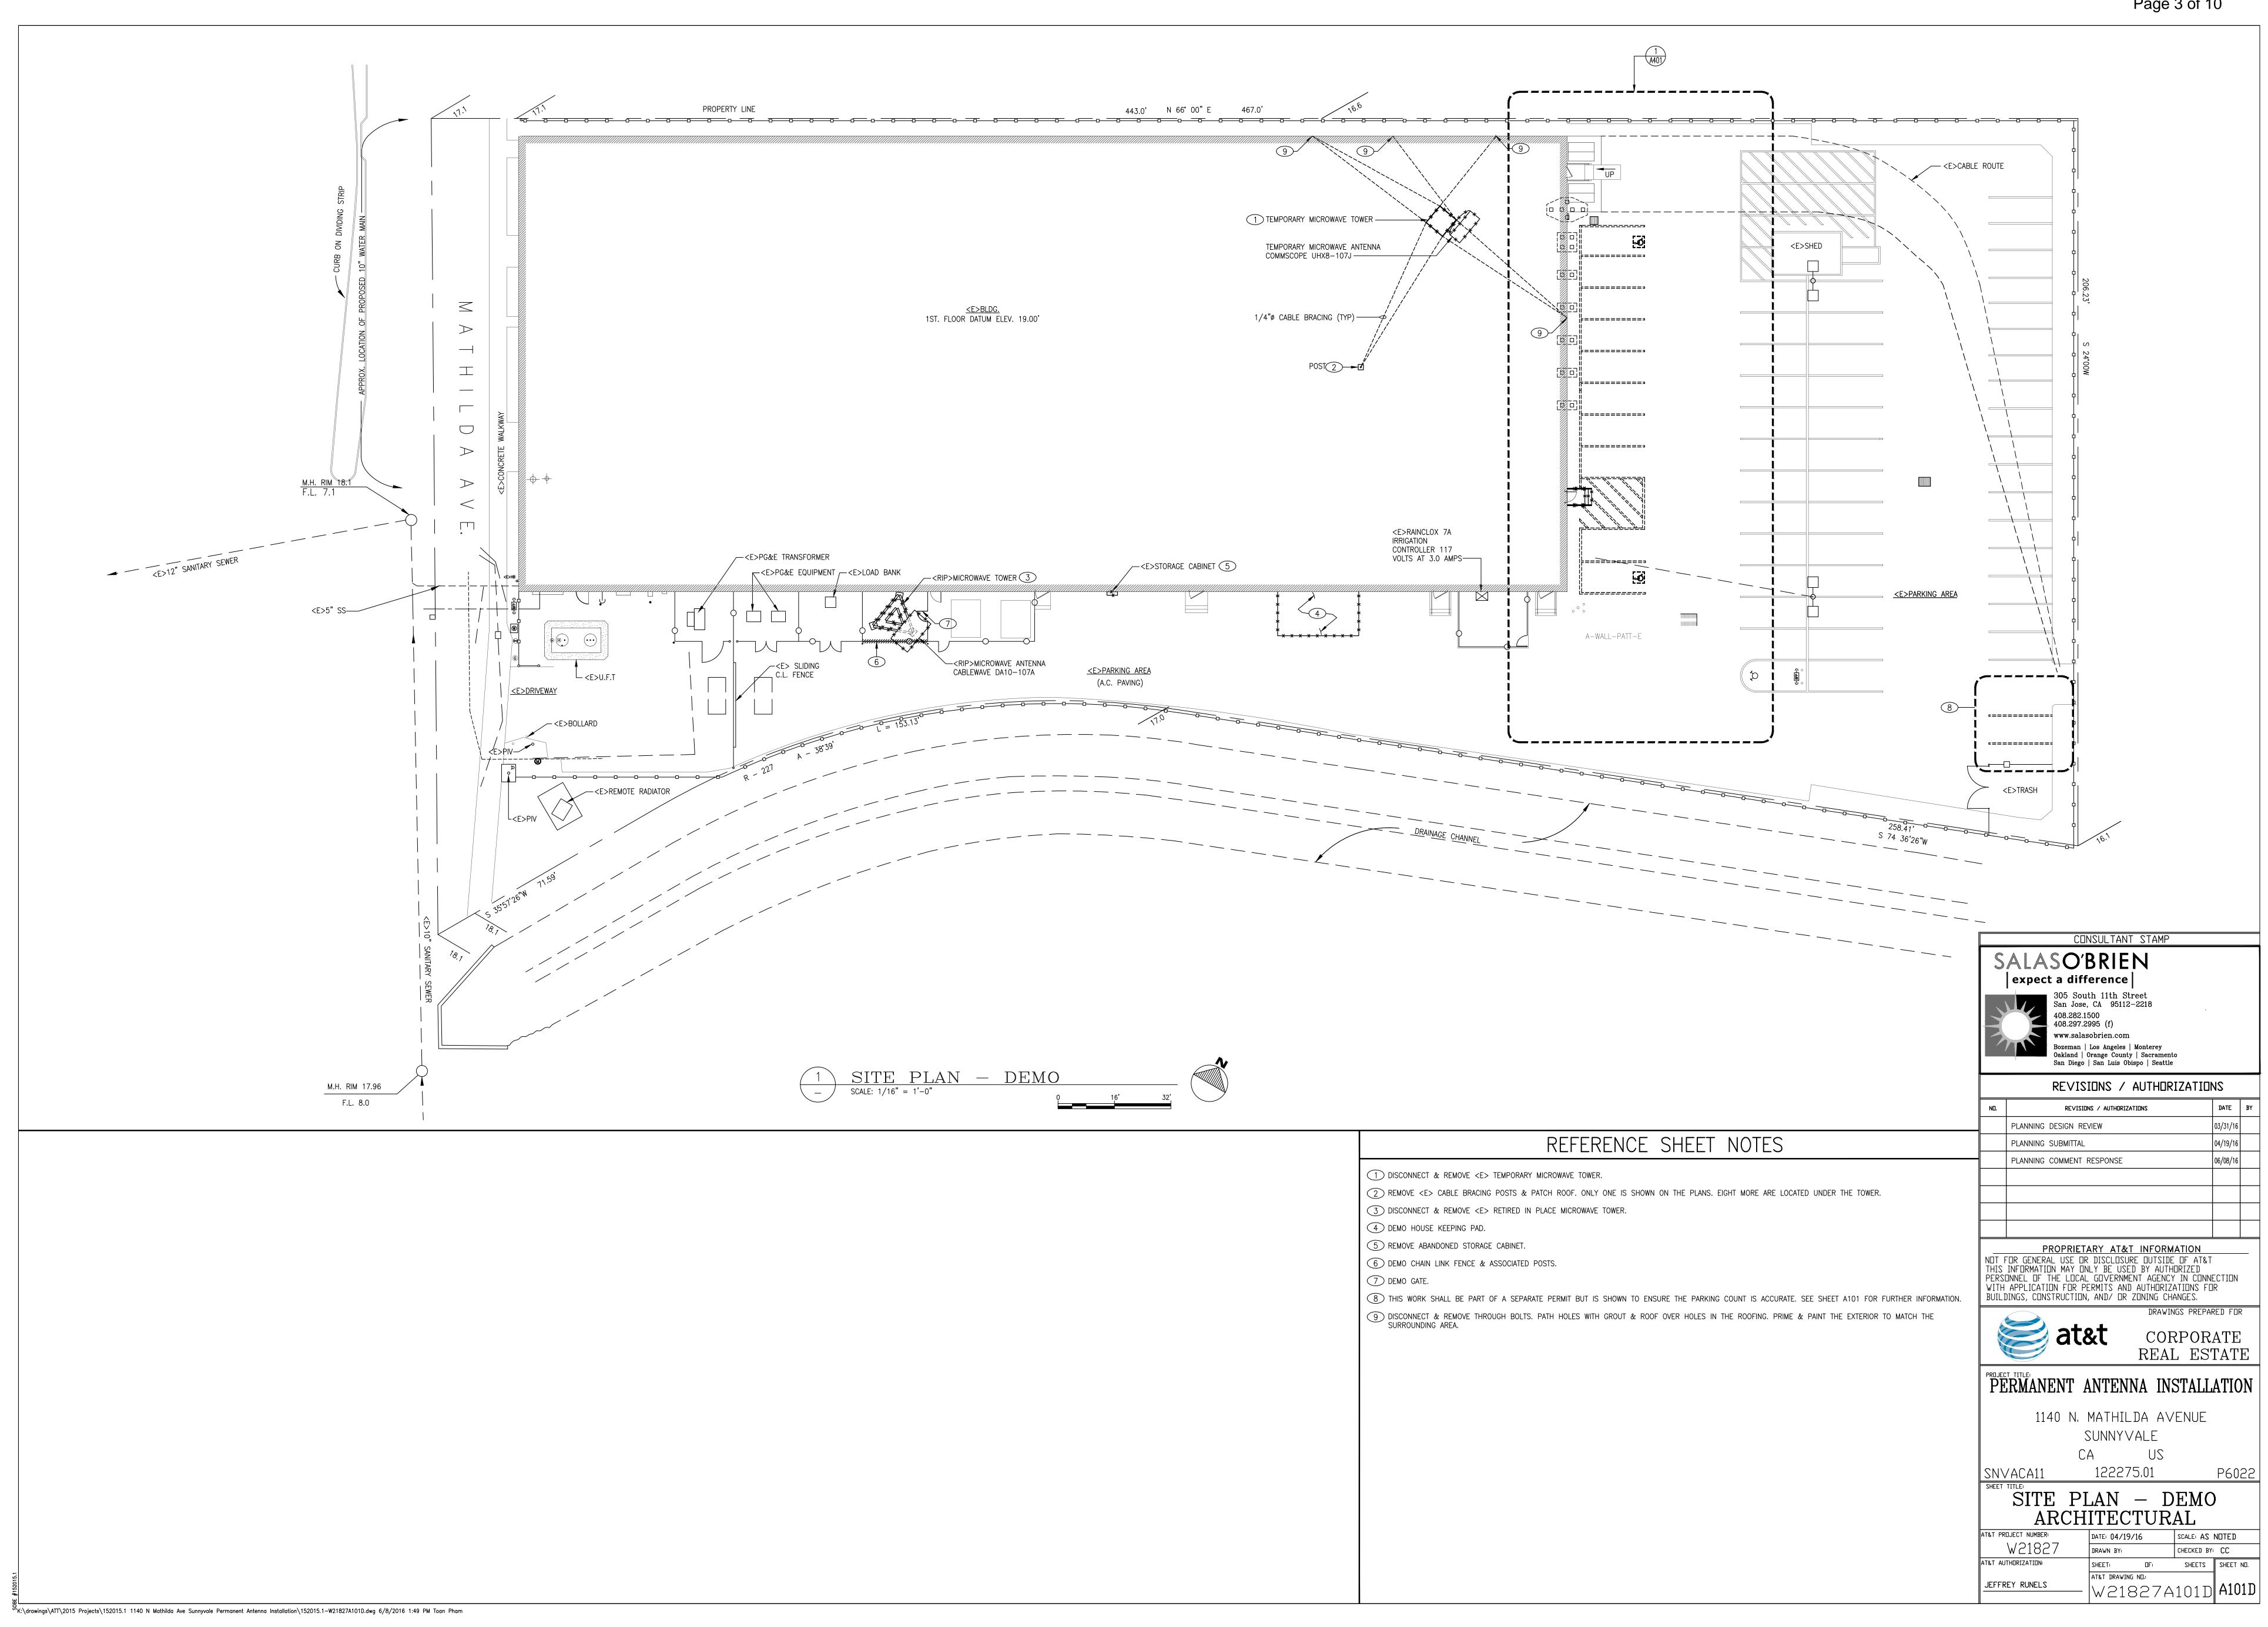
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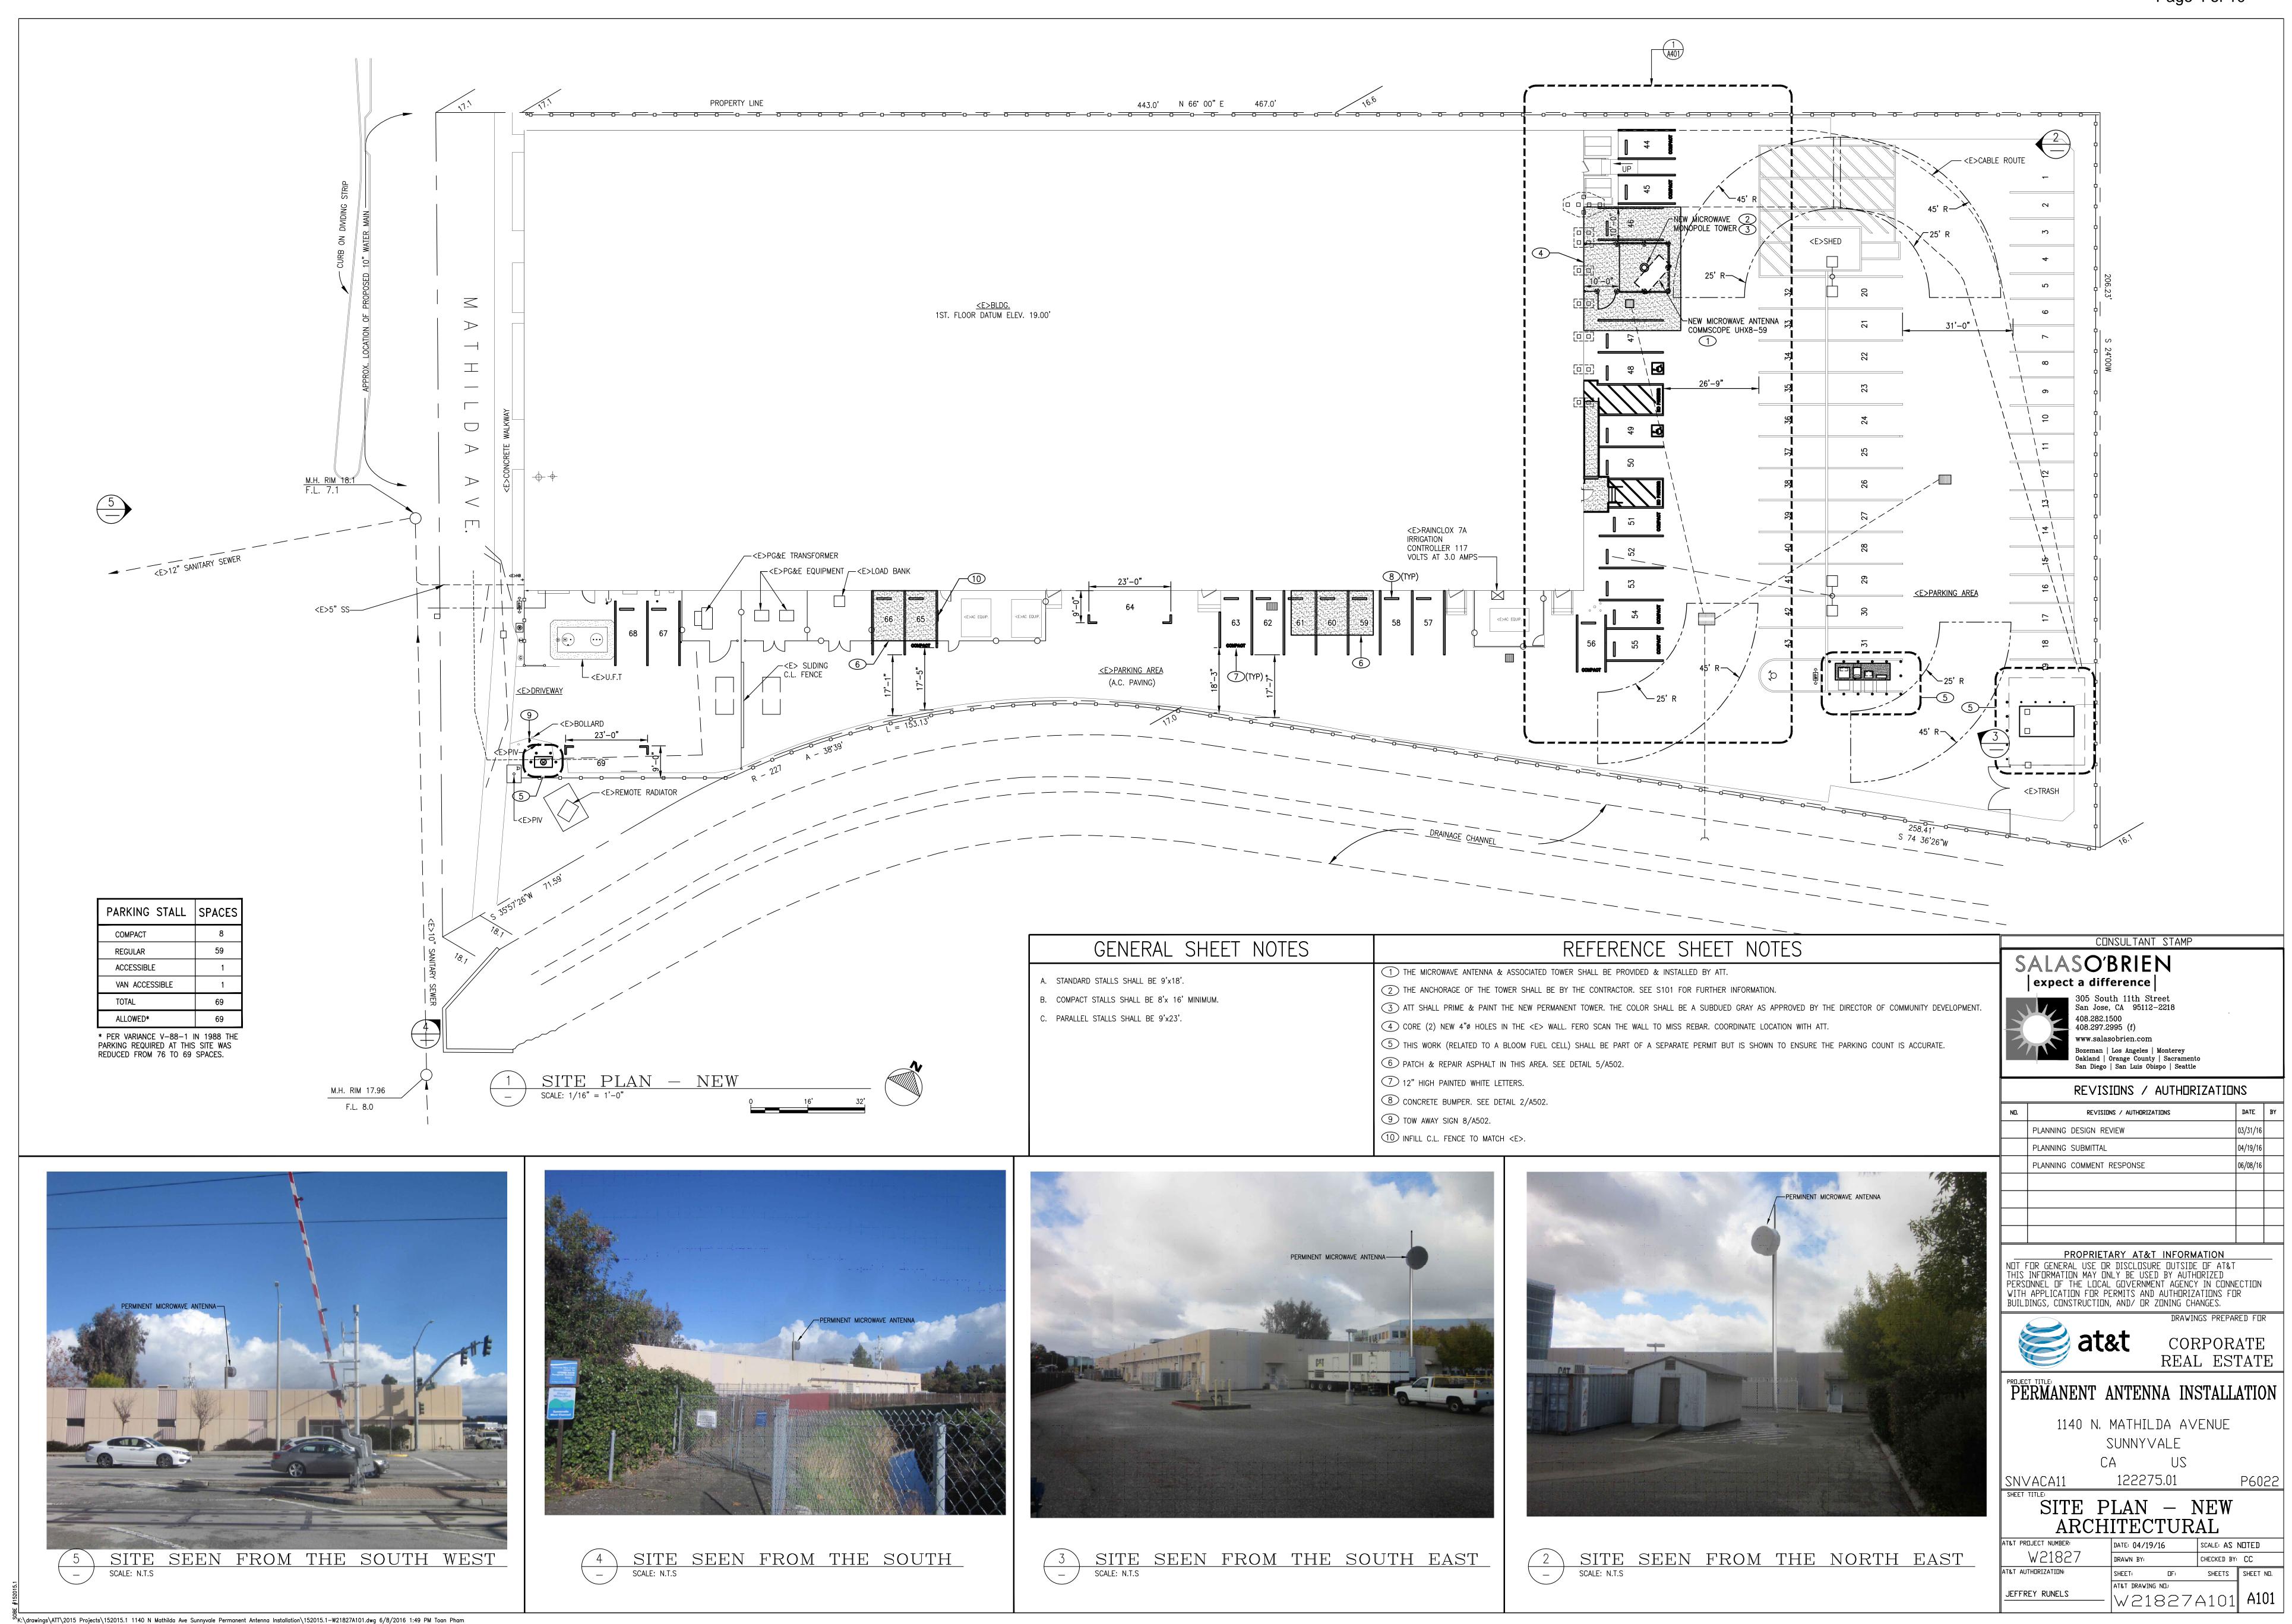
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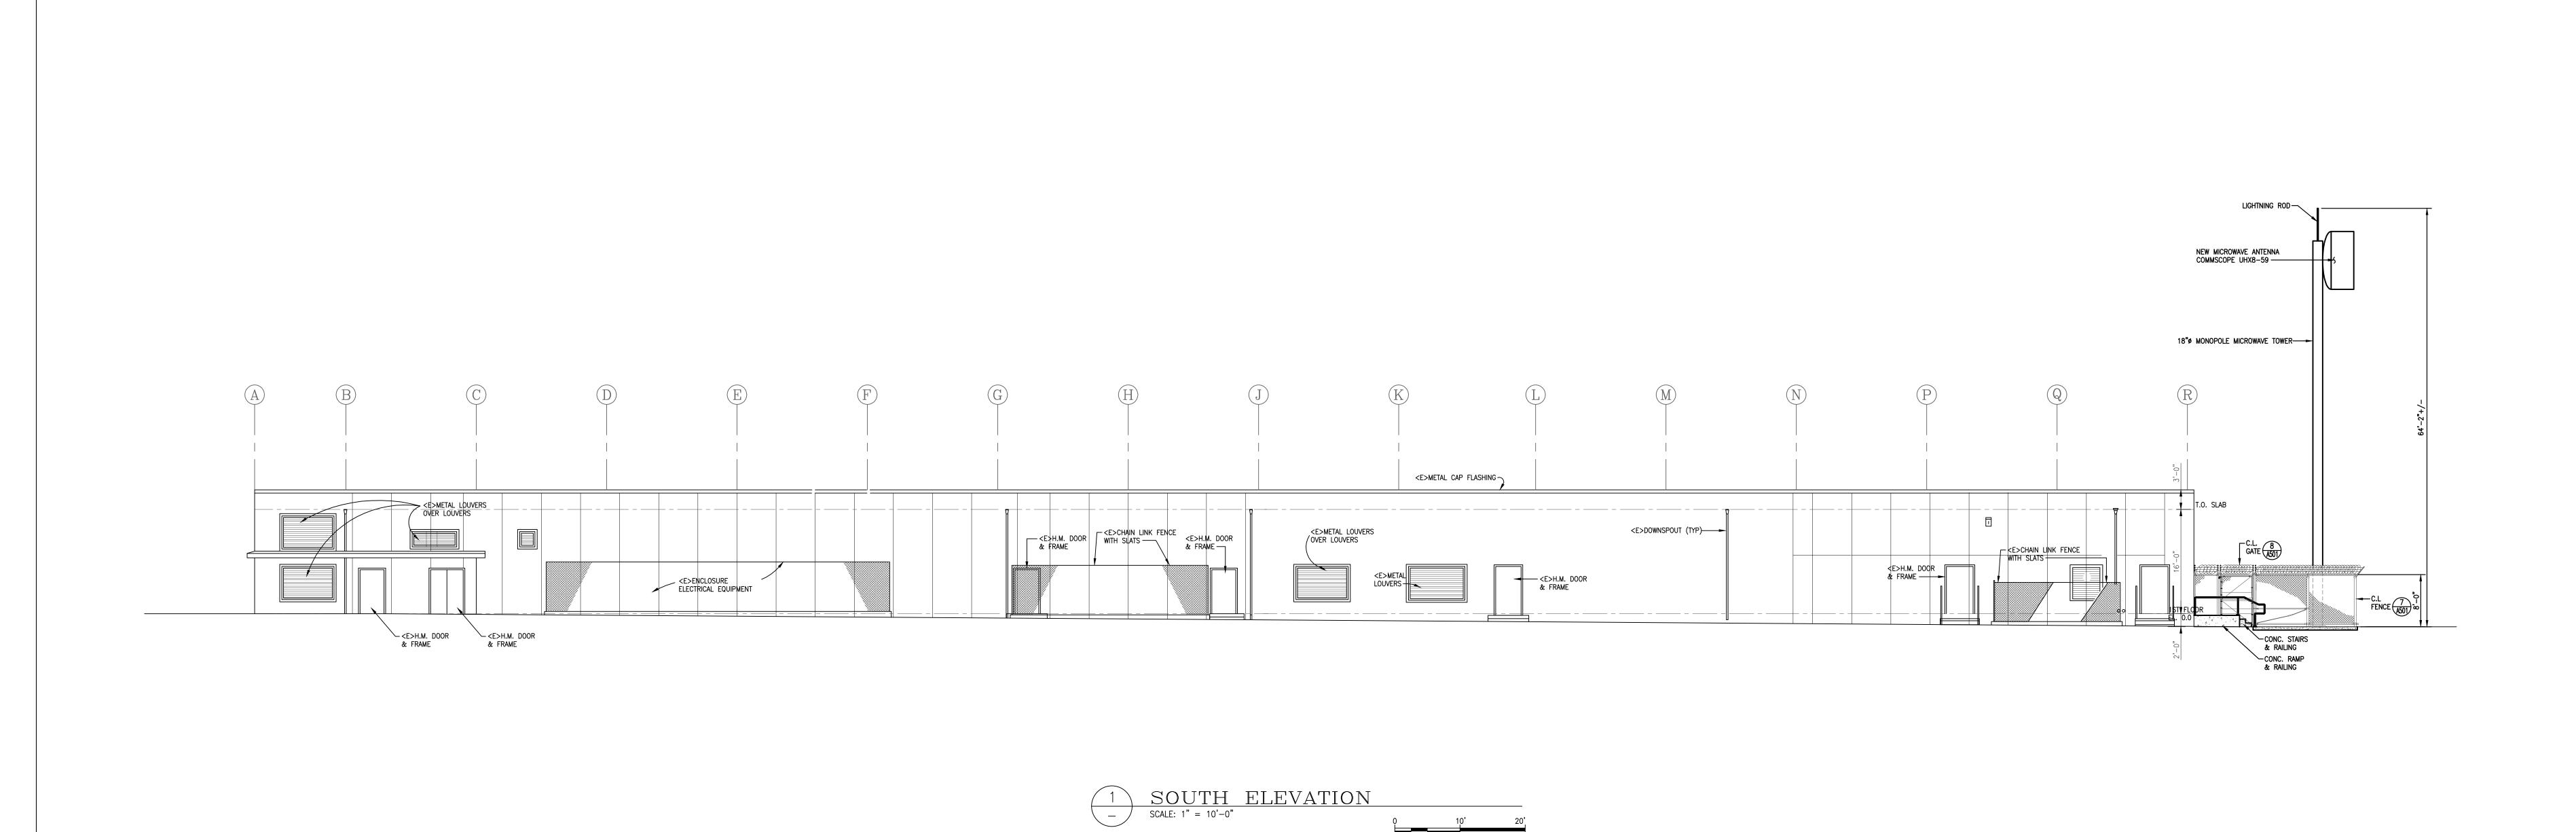
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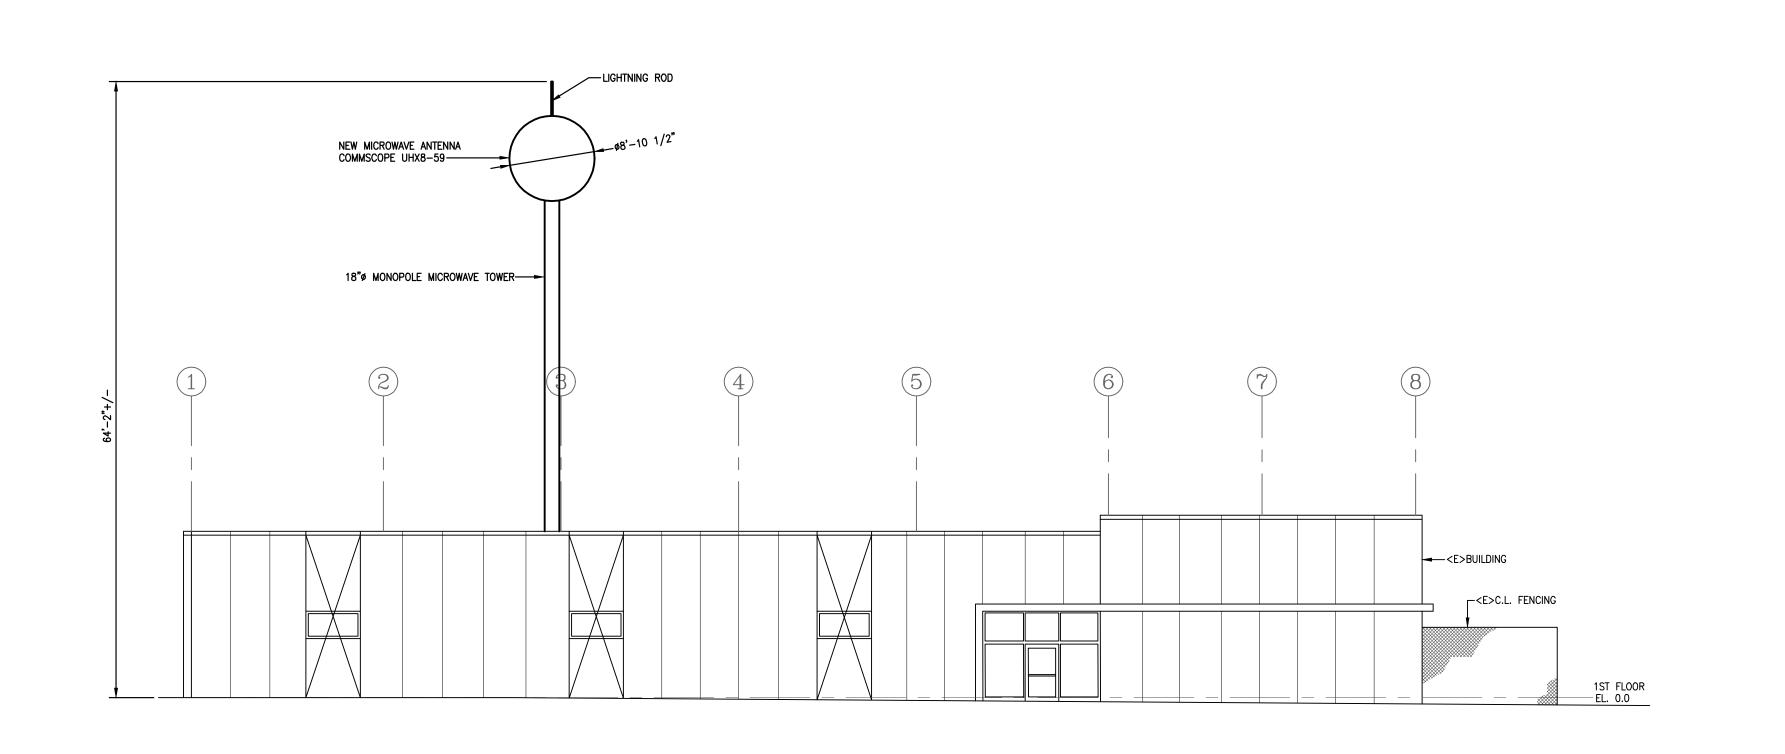
DTECH RF COMPLIANCE LETTER GENERAL

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AT&T PROJECT NUMBER:

AT&T AUTHORIZATION:

JEFFREY RUNELS

CONSULTANT STAMP

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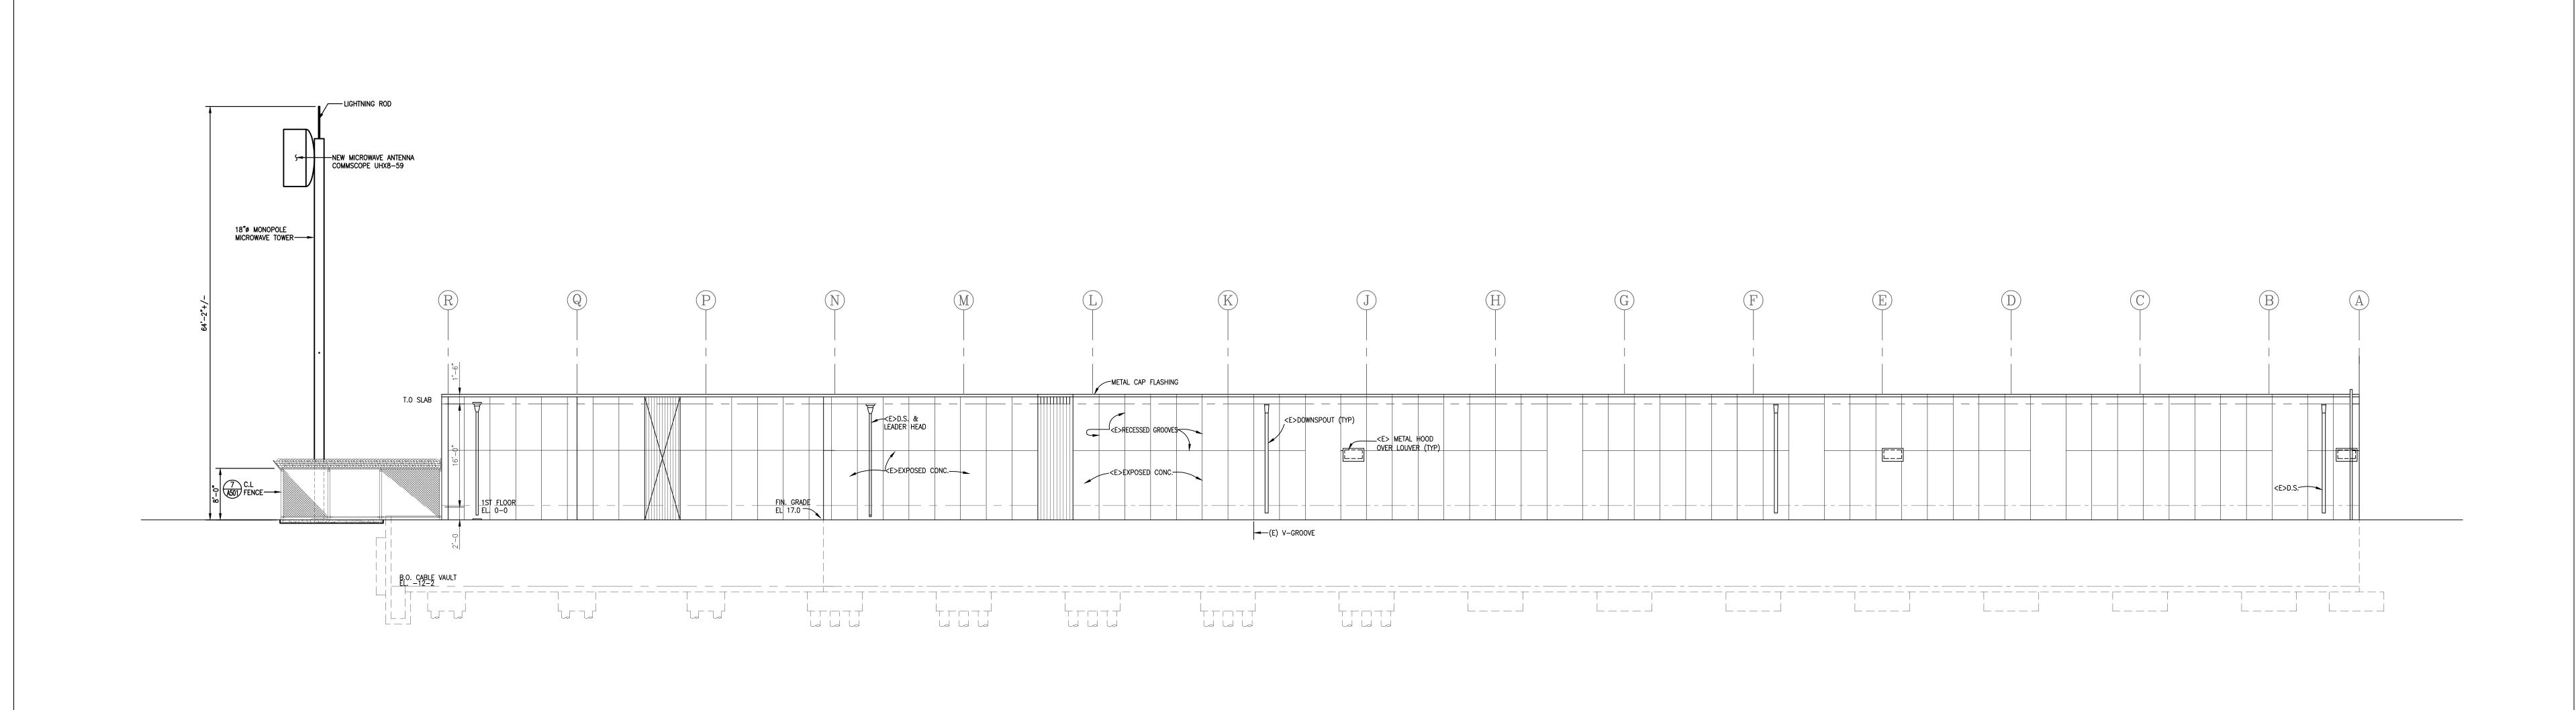
expect a difference

305 South 11th Street San Jose, CA 95112-2218 408.282.1500 408.297.2995 (f) www.salasobrien.com

WEST ELEVATION

SCALE: 1/8" = 1'-0"

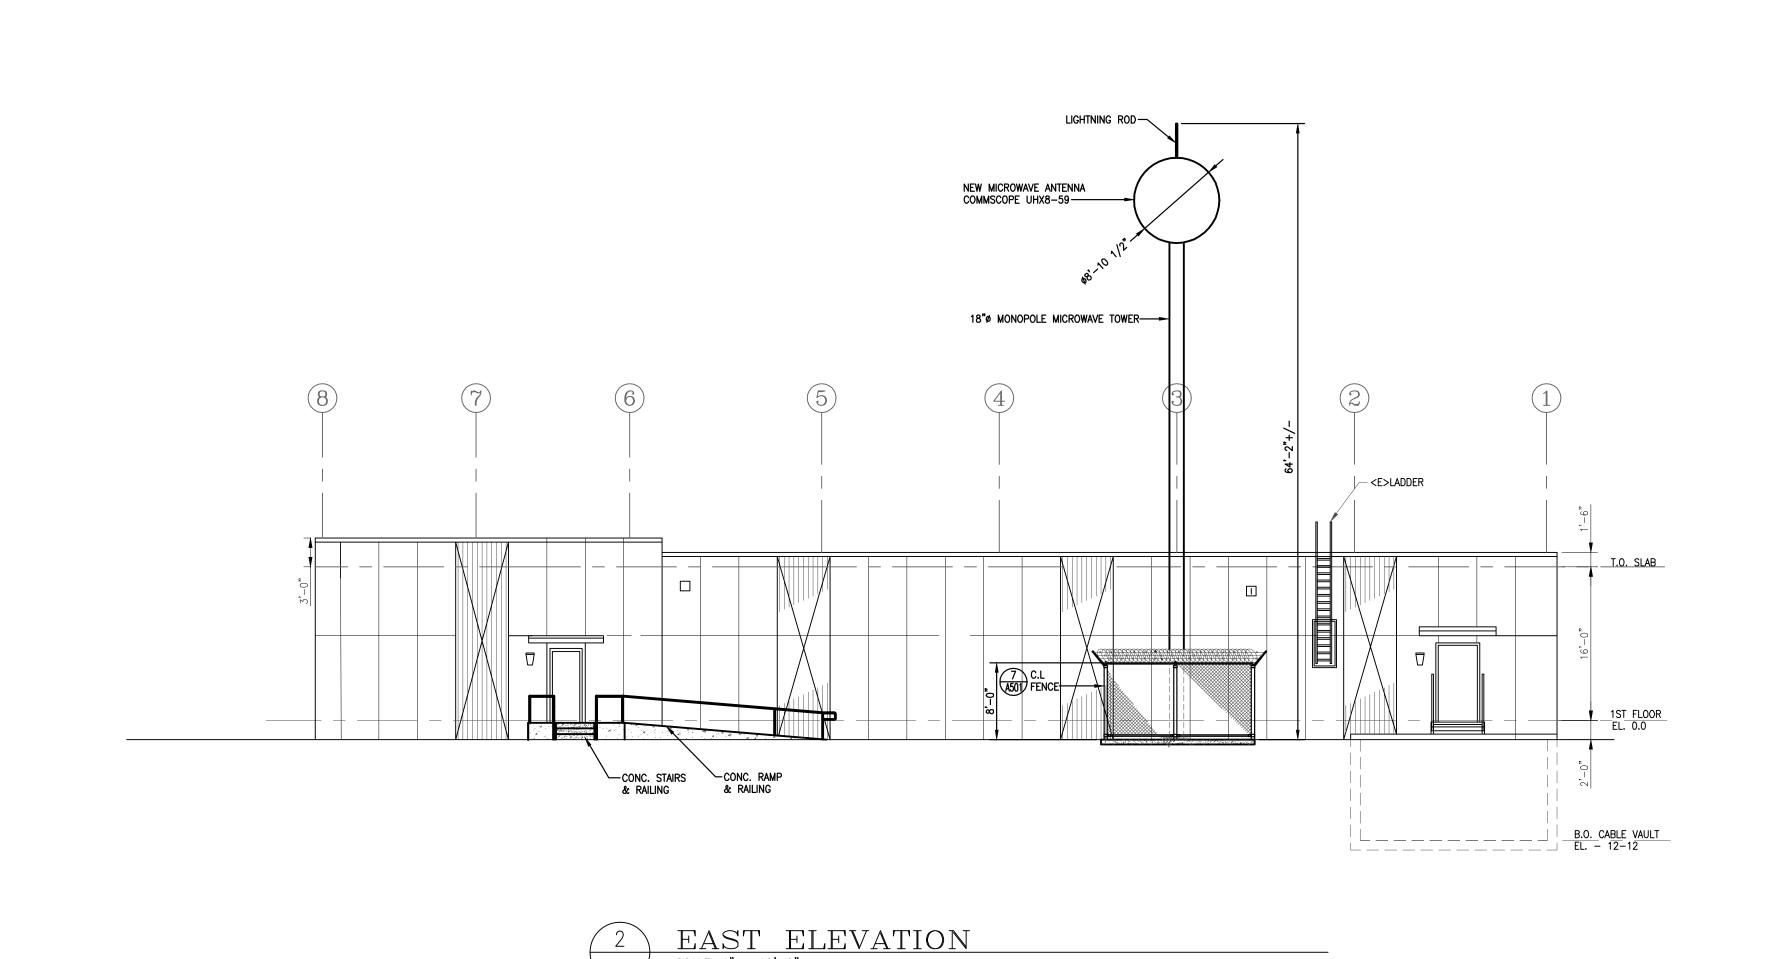
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NORTH ELEVATION

SCALE: 1" = 10'-0"

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PLANNING DESIGN REVIEW	03/31/16	
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PERMANENT ANTENNA INSTALLATION

1140 N. MATHILDA AVENUE SUNNYVALE

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ELEVATIONS ARCHITECTURAL

AT&T PROJECT NUMBER: DATE: 04/19/16 SCALE: AS NOTED

W21827

AT&T AUTHORIZATION:

JEFFREY RUNELS

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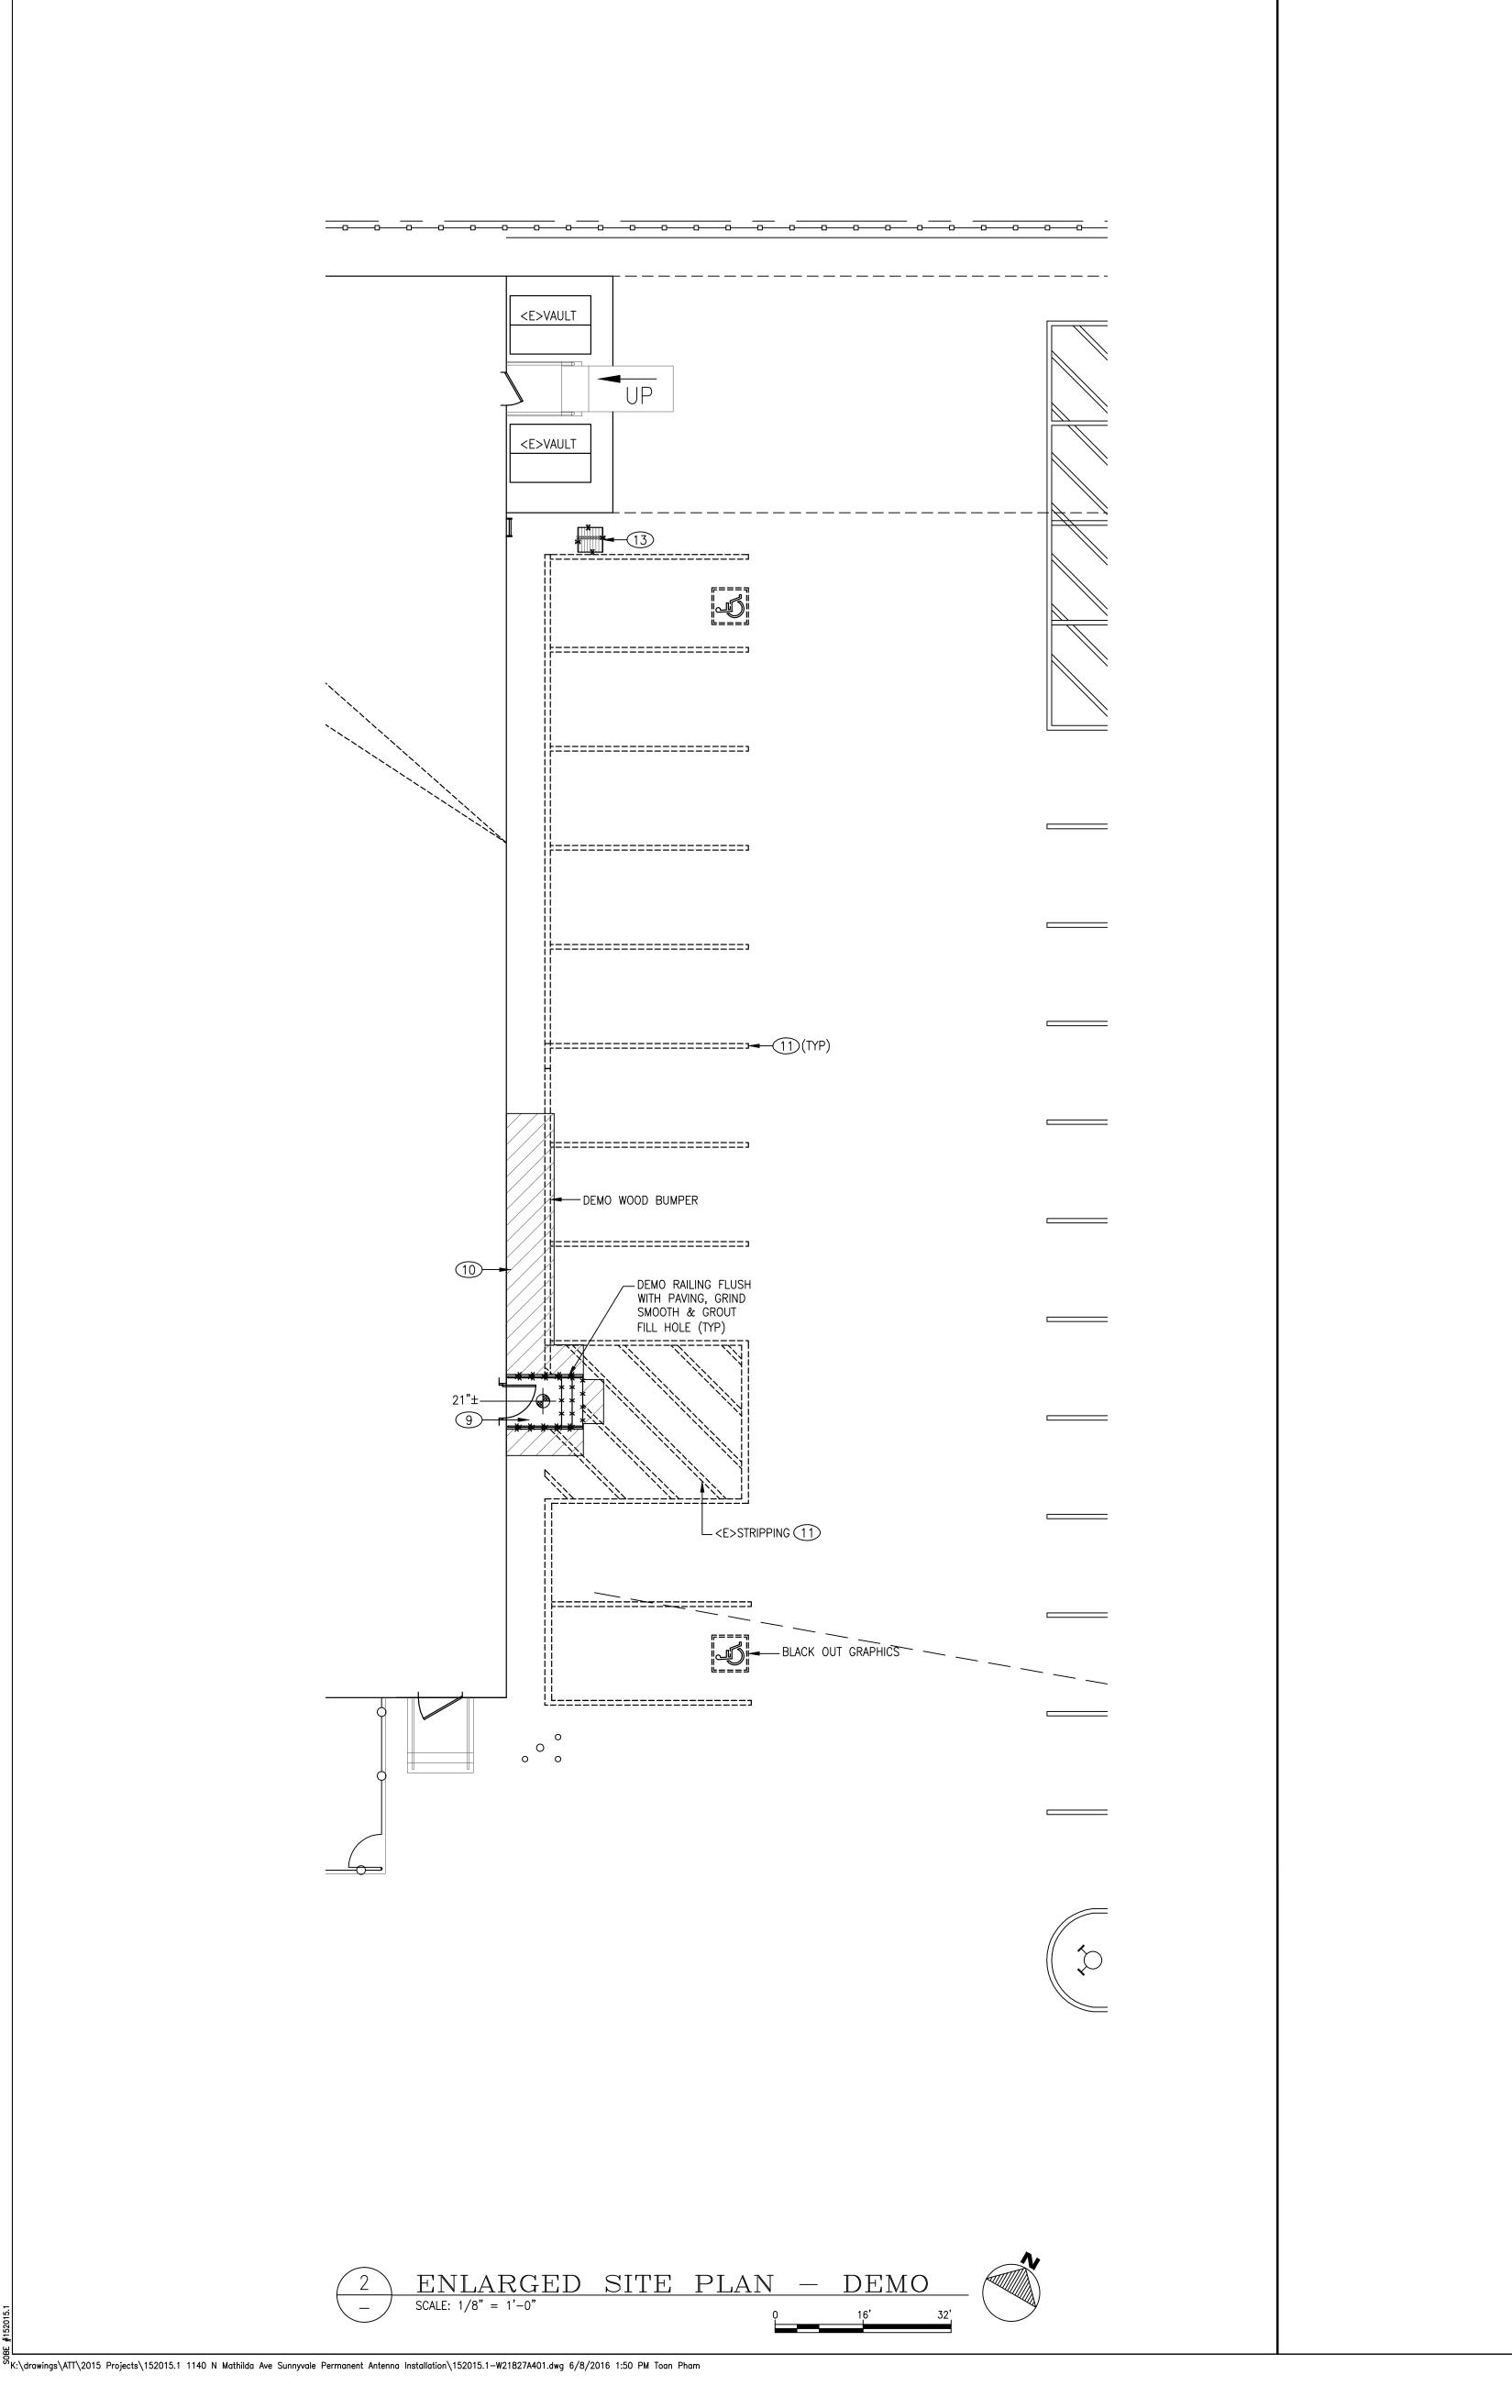
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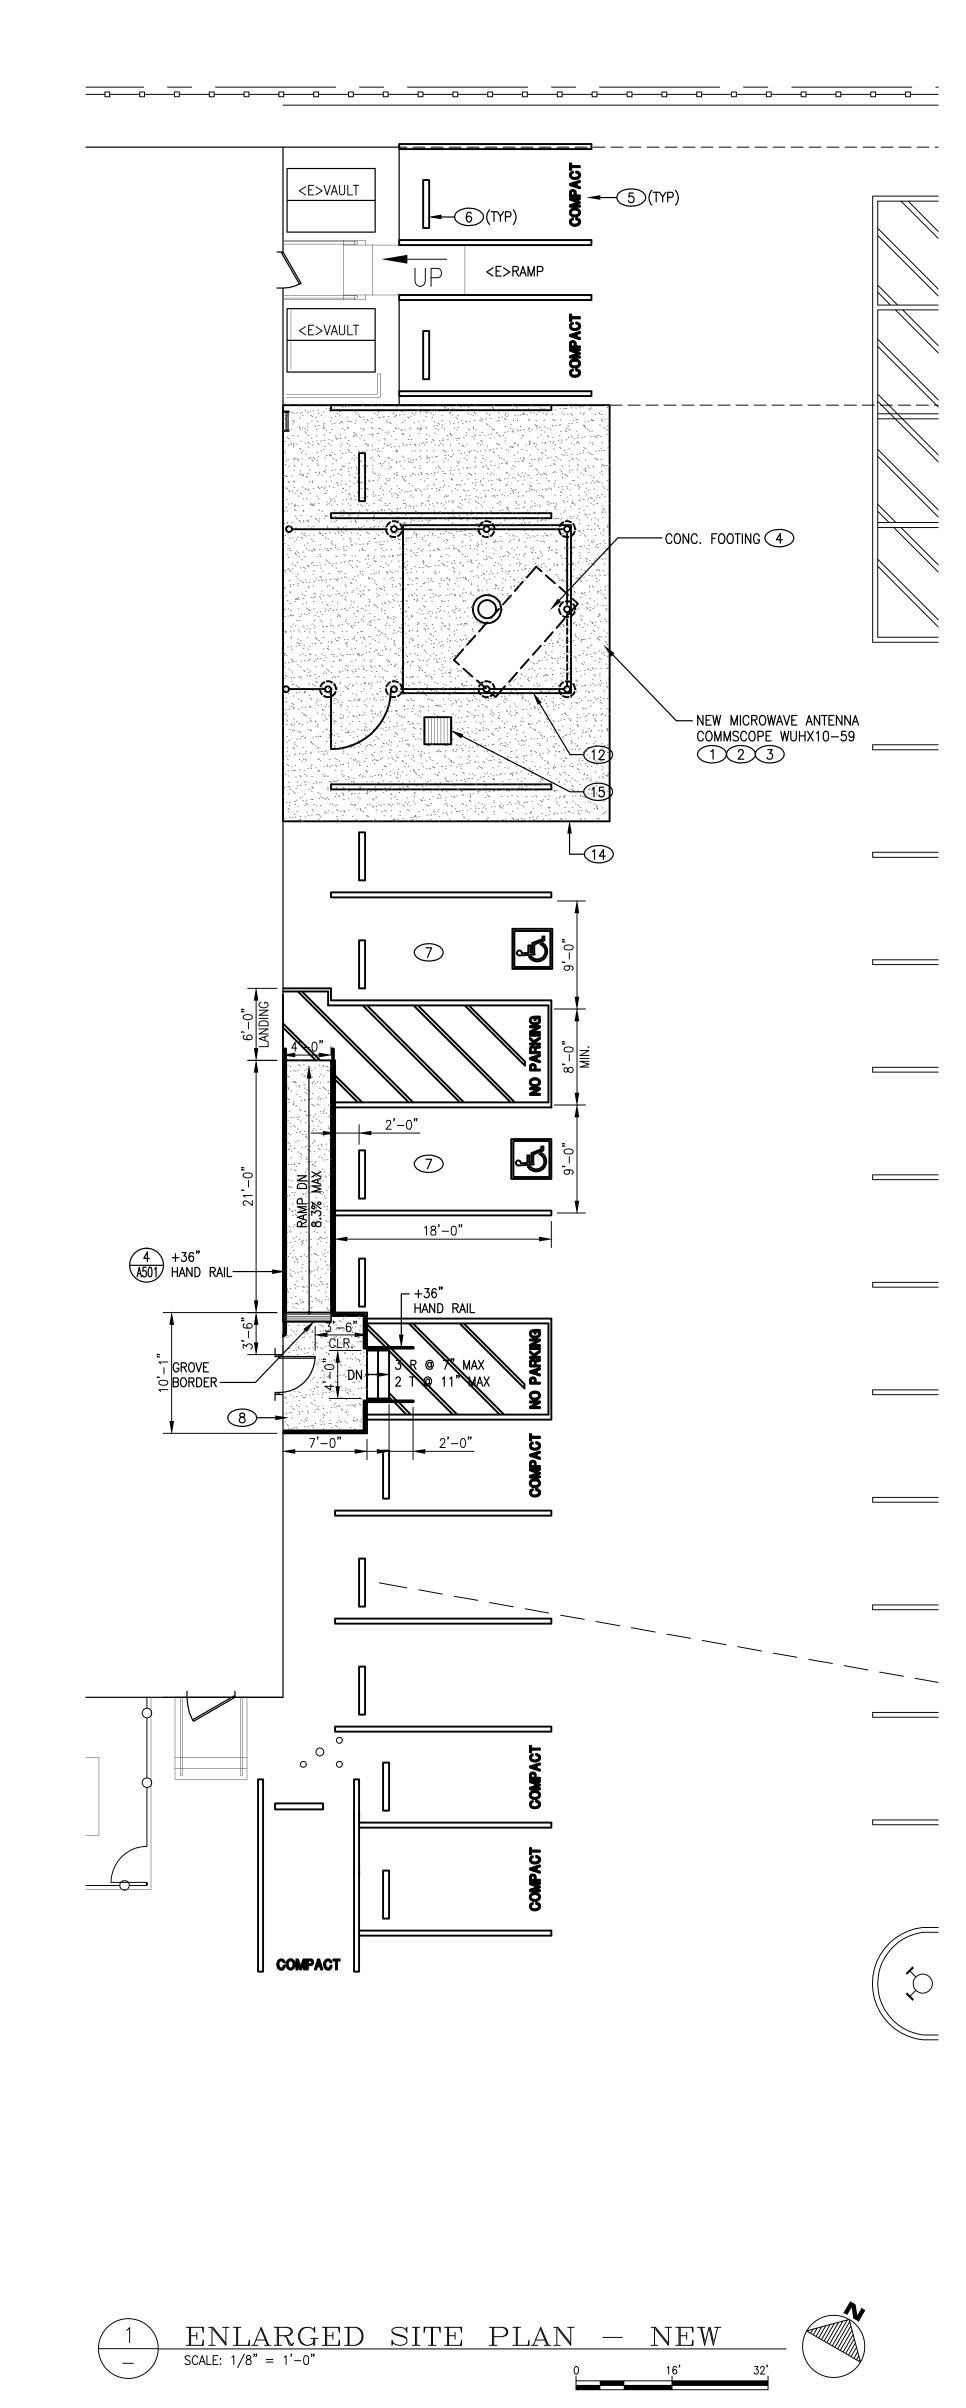
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AT&T DRAWING NO.:

W21827A202

A202





GENERAL SHEET NOTES

- A. STANDARD STALLS SHALL BE 9'x18'.
- B. COMPACT STALLS SHALL BE 8'x 16' MINIMUM.
- C. PARALLEL STALLS SHALL BE 9'x23'.
- D. IN AREAS WHERE NEW STRIPING IS TO BE PAINTED REMOVE ALL OLD STRIPING PRIOR TO BEGINNING THE NEW STRIPING.

REFERENCE SHEET NOTES

- 1 THE MICROWAVE ANTENNA & ASSOCIATED TOWER SHALL BE PROVIDED & INSTALLED BY ATT.
- 2 THE ANCHORAGE OF THE TOWER SHALL BE BY THE CONTRACTOR. SEE THE STRUCTURAL SHEETS FOR FURTHER INFORMATION.
- THE NEW PERMANENT TOWER SHALL BE PRIMED & PAINTED. USE SHERMAN-WILLIAMS PRO-CRYL PRIMER WITH A DIRECT TO METAL TOP COAT. COLOR SHALL BE A SUBDUED GRAY AS APPROVED BY SUNNYVALE DIRECTOR OF COMMUNITY DEVELOPMENT.
- 4 THE FOOTING SHALL BE BY ATT. SEE THE STRUCTURAL SHEETS FOR FURTHER INFORMATION.
- 5 12" HIGH PAINTED LETTERS.
- 6 CONCRETE BUMPER. SEE DETAIL 2/A502.
- 7 ACCESSIBLE PARKING SEE DETAIL 3/A502.
- (8) CONC. STEPS, RAMP & LANDING. SEE DRAWING A501.
- 9 DEMO <E> LANDING & STAIRS.
- 10 DEMO AC PAVING.
- (11) REMOVE <E> STRIPING.
- 12) FENCING & GATES. SEE DETAIL 7/A501 & 8/A501.
- 13) CATCH BASIN TO BE REMOVED.
- 14 PATCH & REPAIR ASPHALT IN THIS AREA. SEE DETAIL 5/A502. RESLOPE THE AREA TO ENSURE IT DRAINS.
- 15) CATCH BASIN TO BE REINSTALLED. SEE THE PLUMBING SHEETS FOR FURTHER INFORMATION.



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PERMANENT ANTENNA INSTALLATION

1140 N. MATHILDA AVENUE SUNNYVALE

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EET TIITLE:
ENLARGED SITE PLAN

ARCHITECTURAL

AT&T PROJECT NUMBER:

W21827

DATE: 04/19/16

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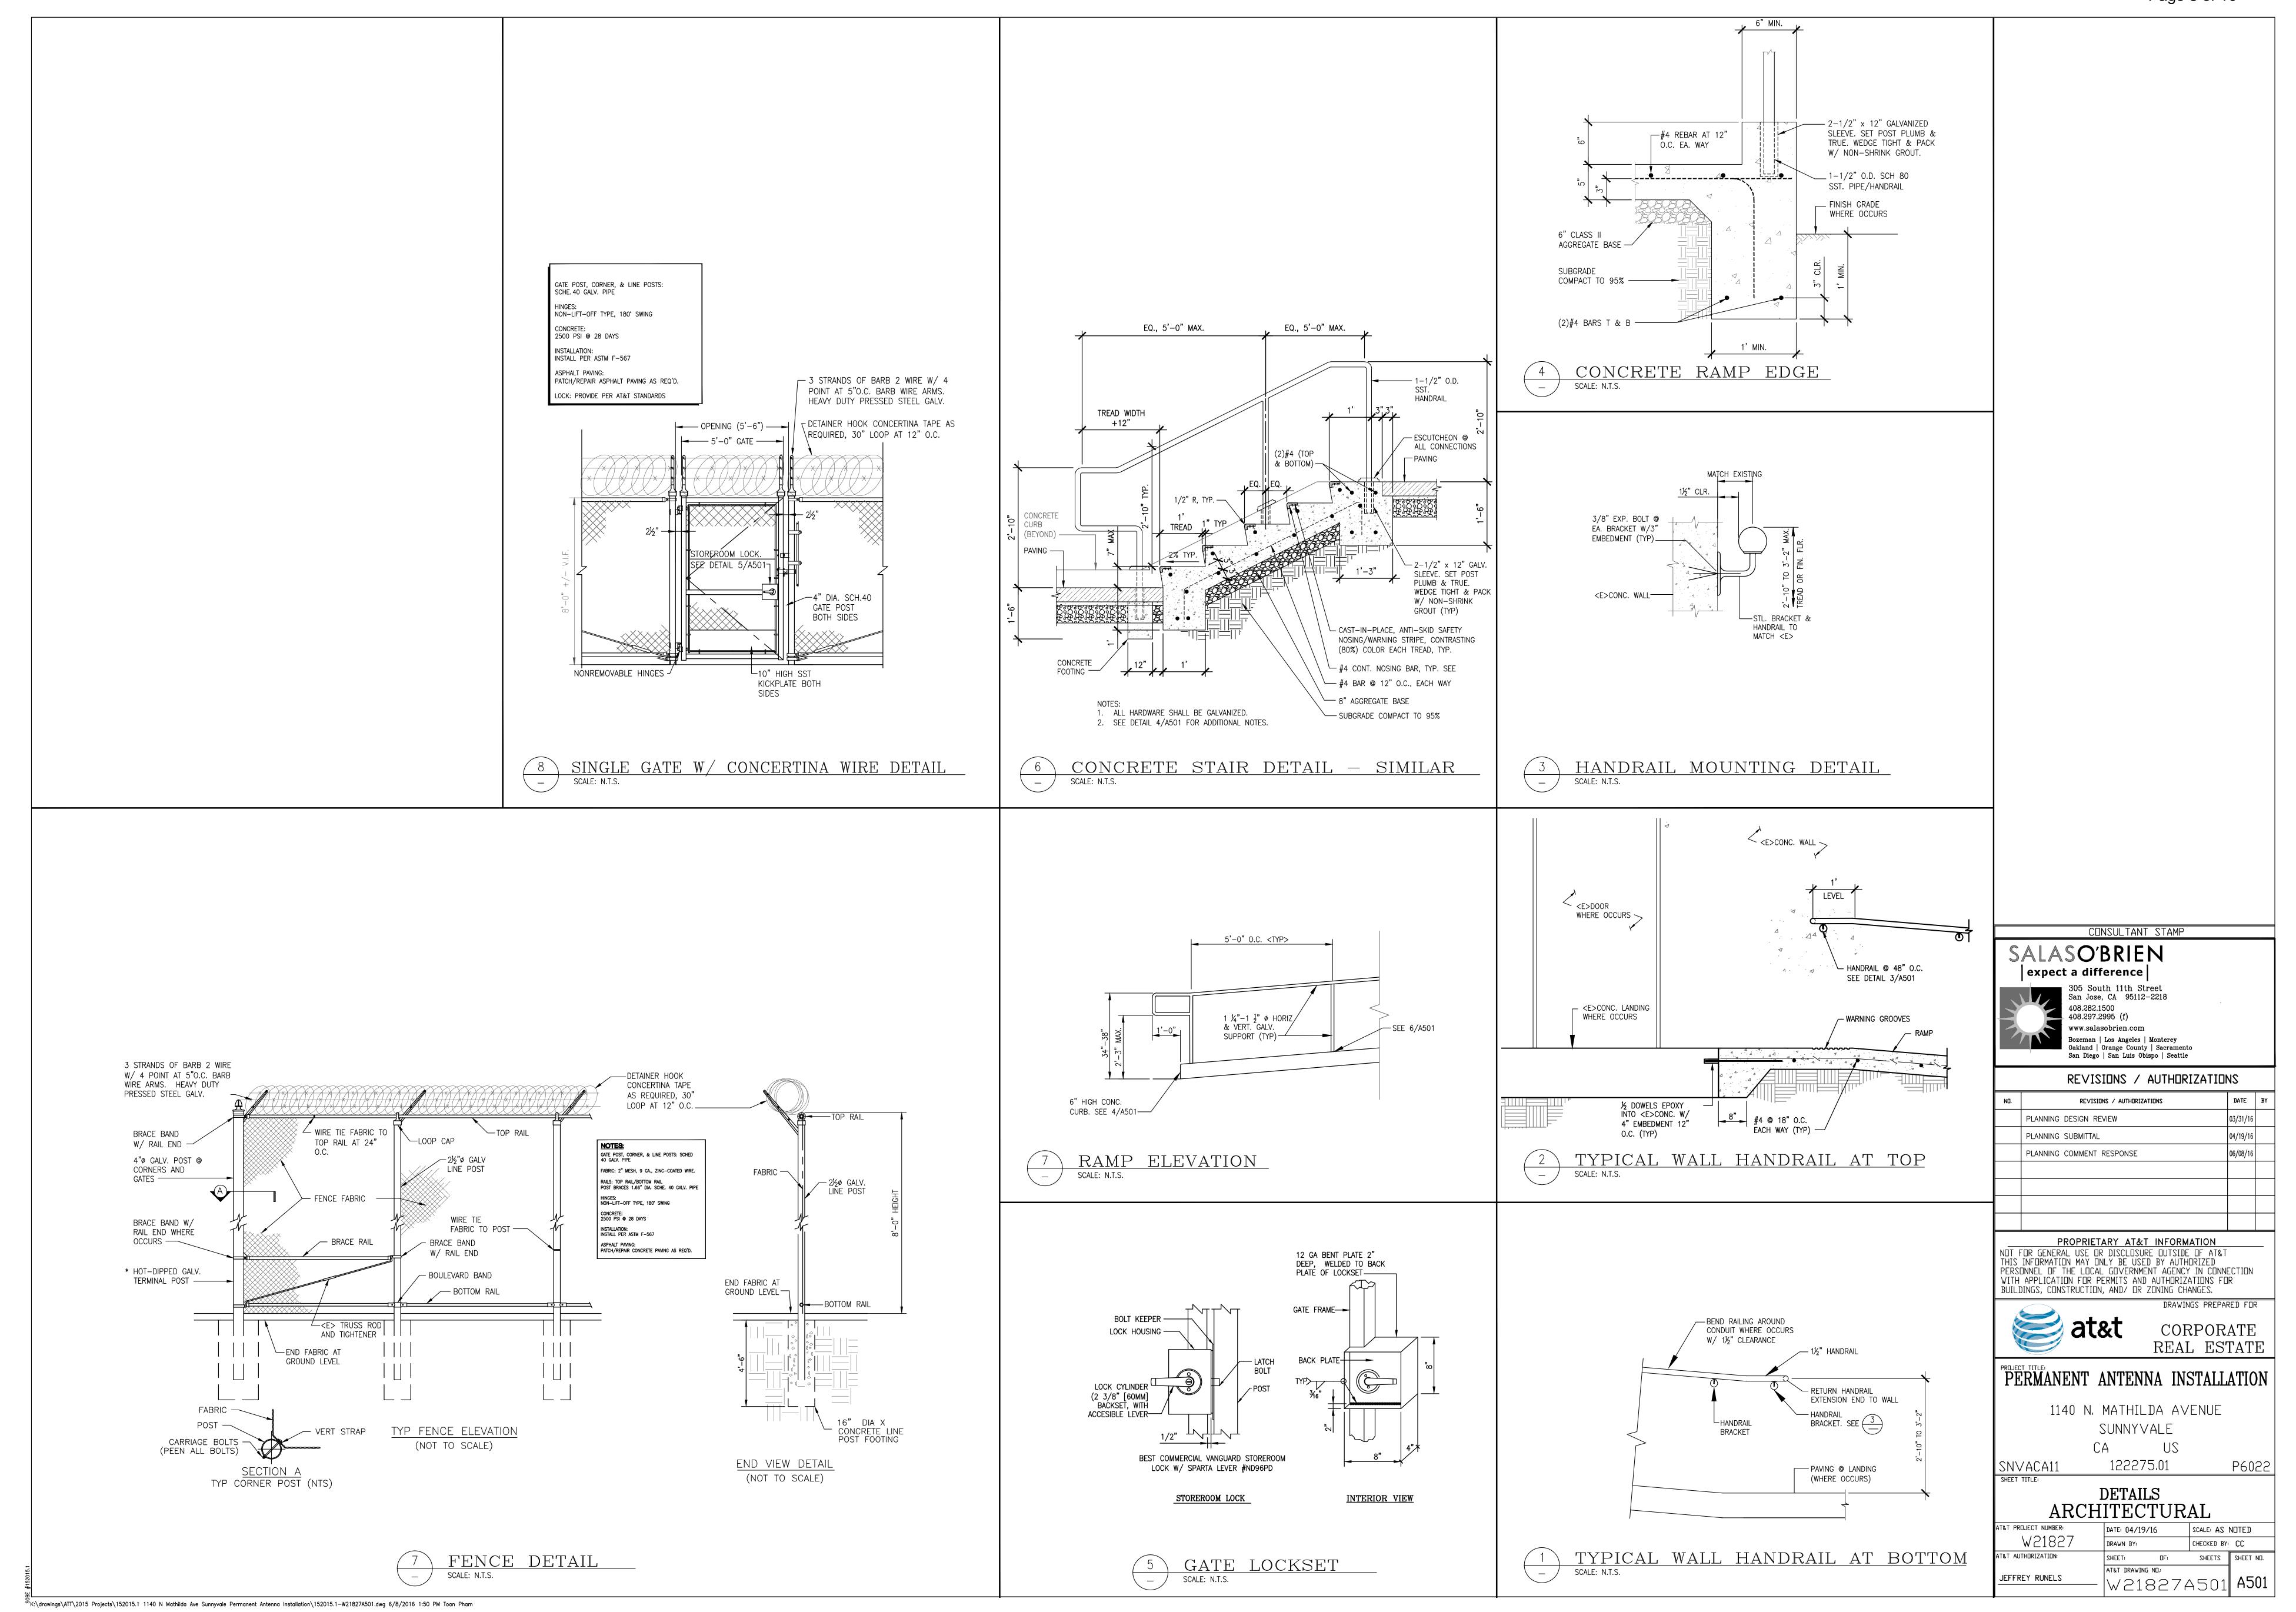
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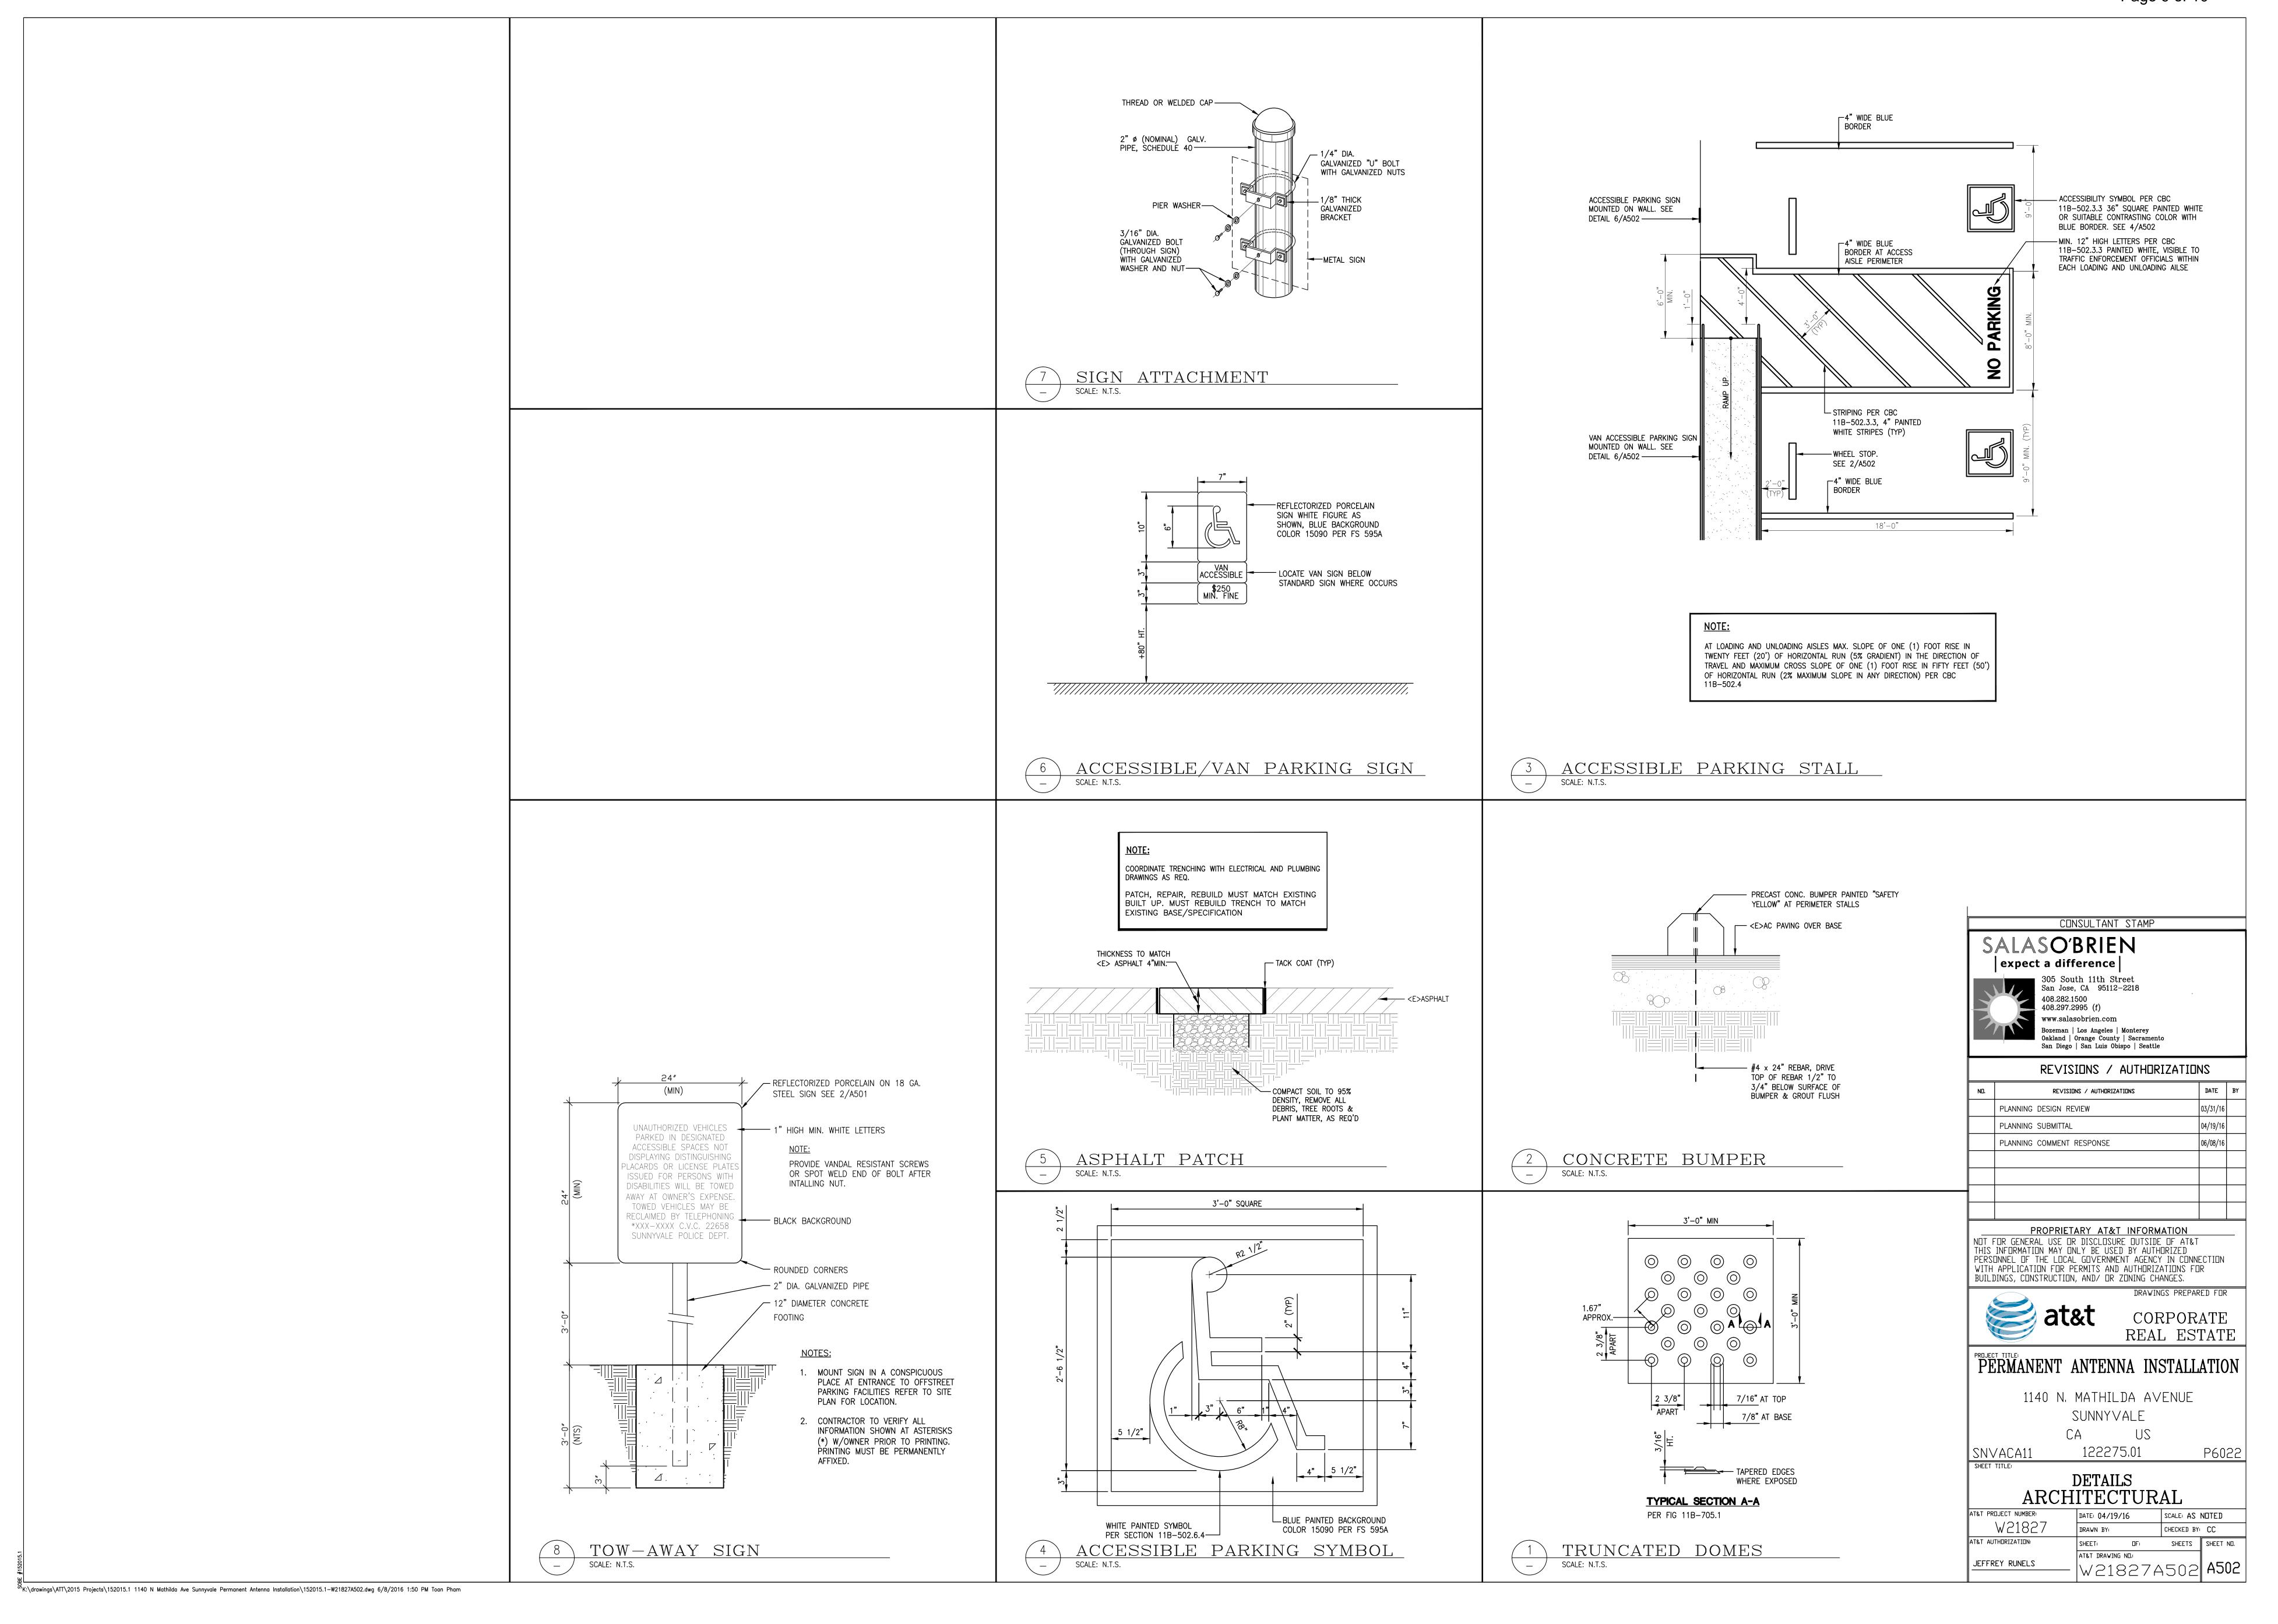
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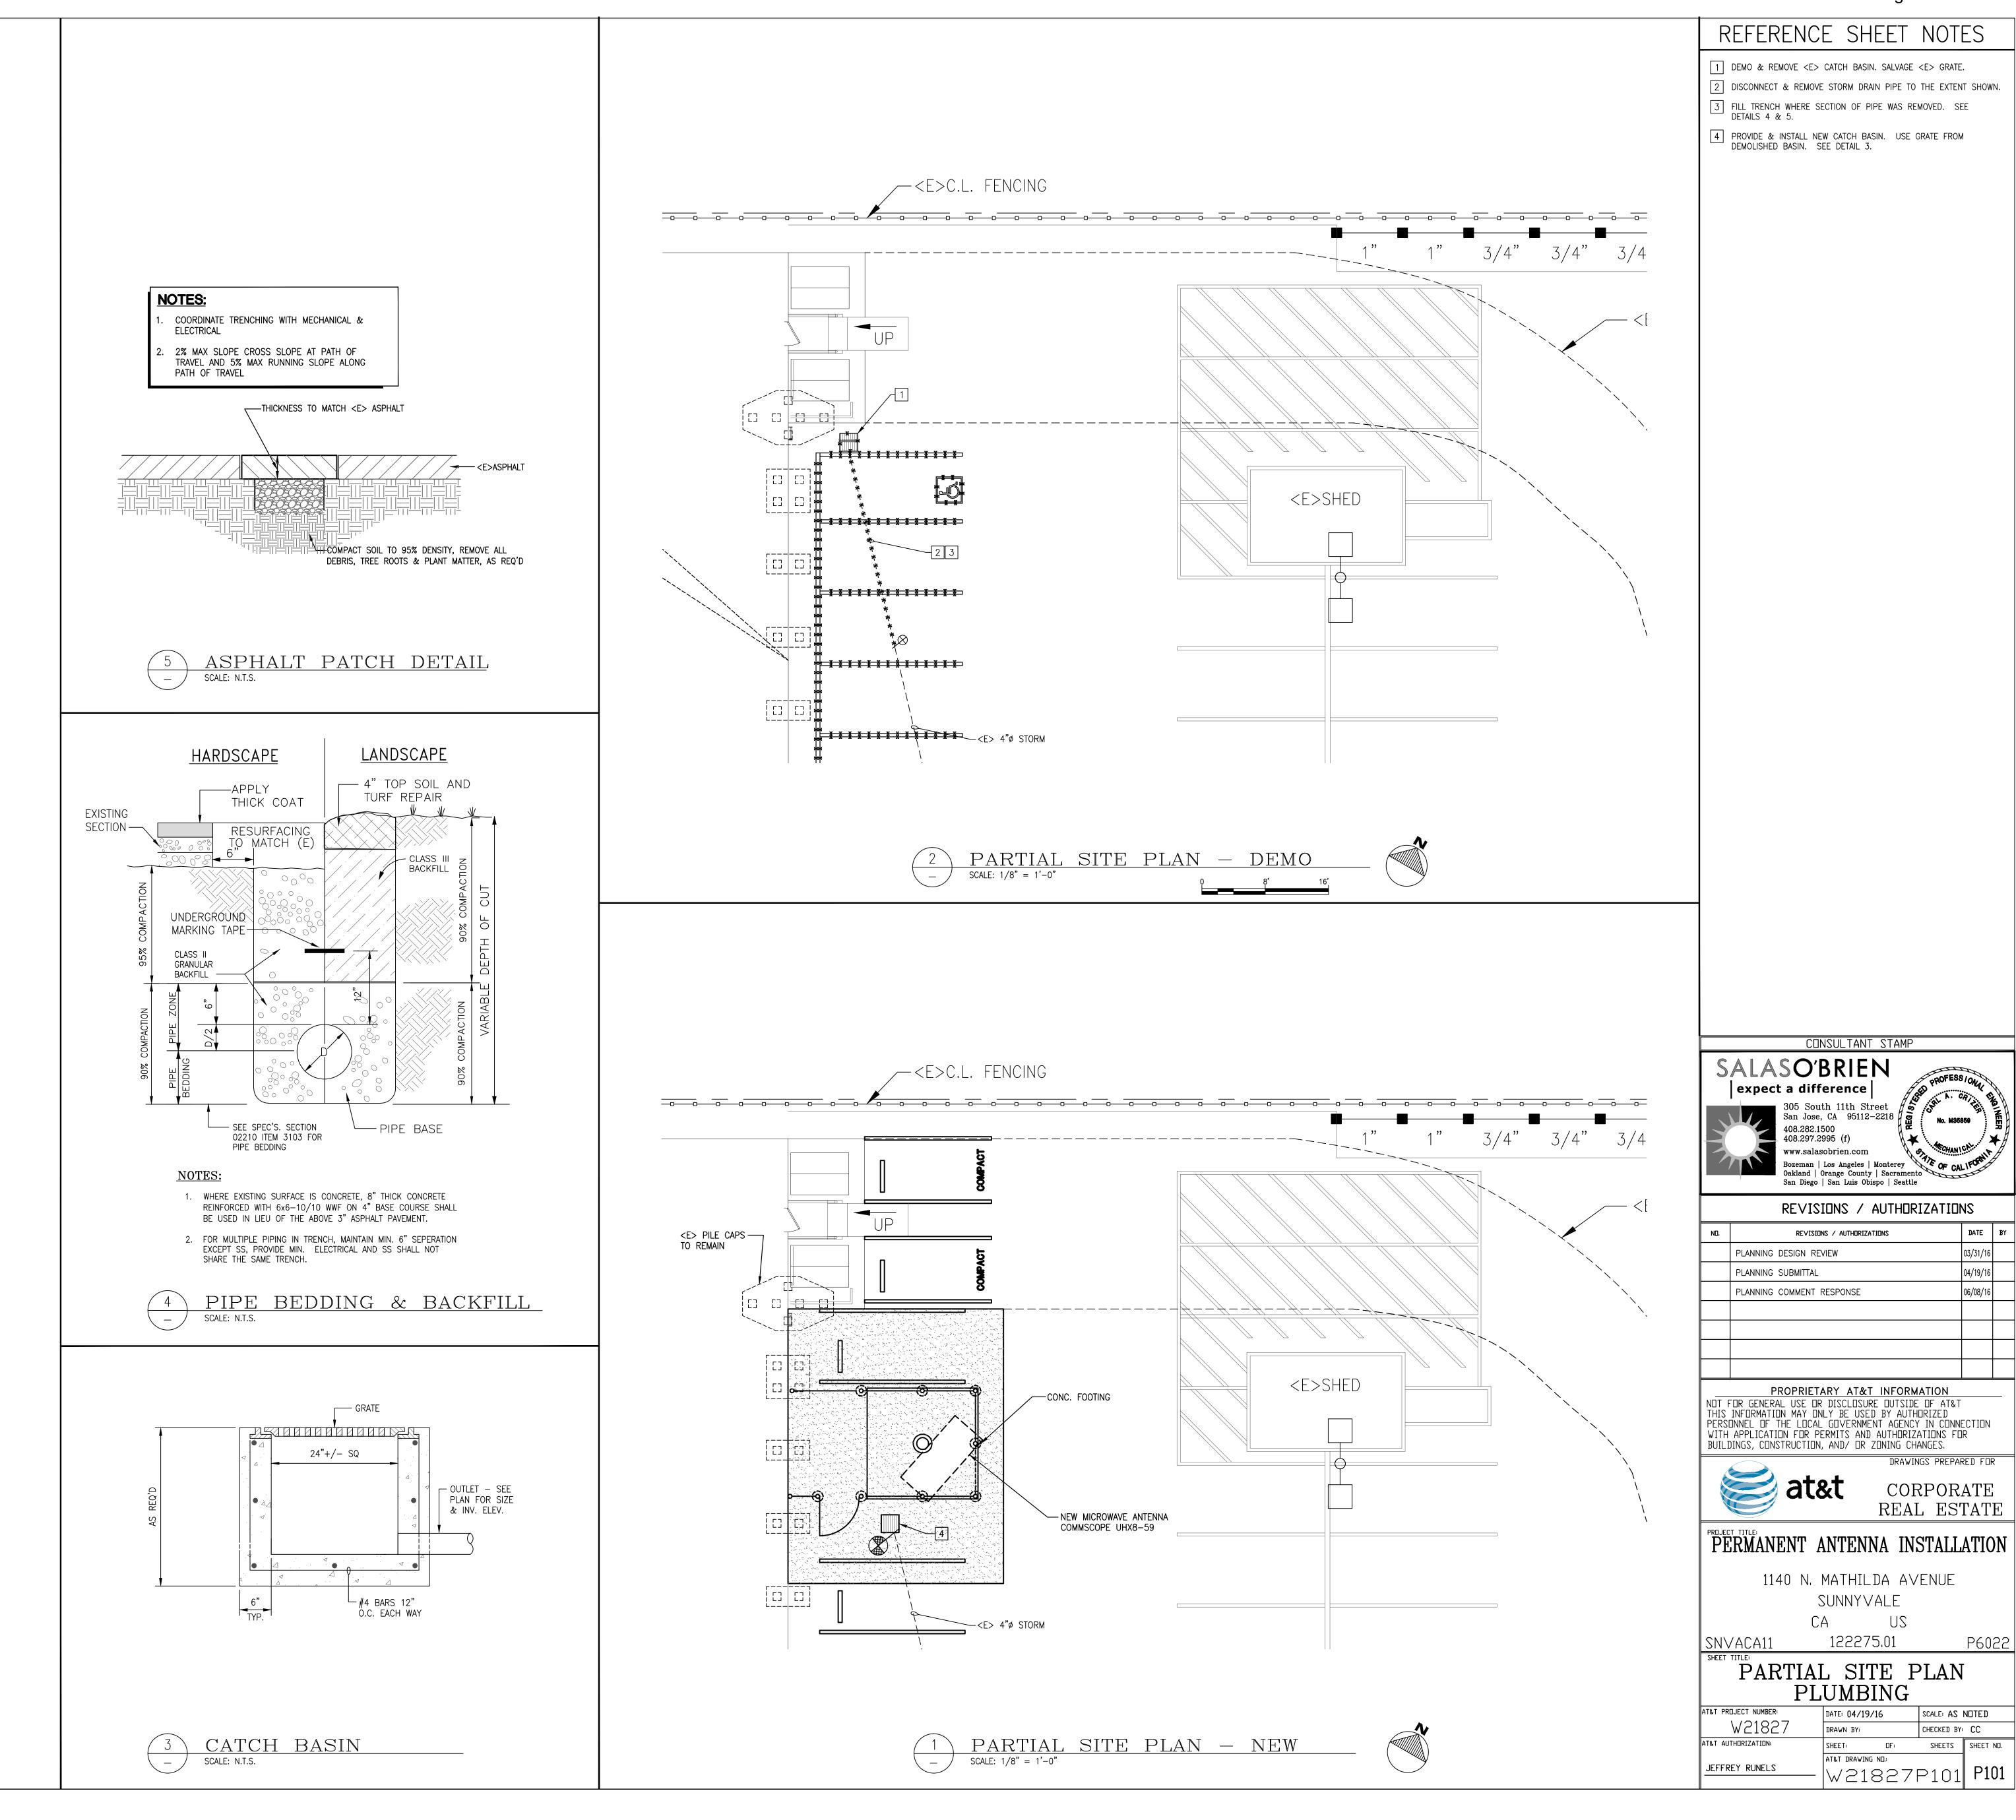
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