

# 311 S Mathilda Avenue, Sunnyvale, CA


APRIL 2018









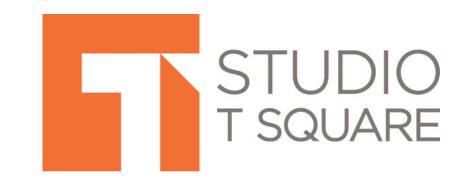

(510) 451 - 2850

Architecture

Oakland, California 94607


Bay
2nd Floo

Partners
ners: 644 Menlo Ave

Drawn By:

Sheet No:

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#### **PROPERTY INFORMATION:**

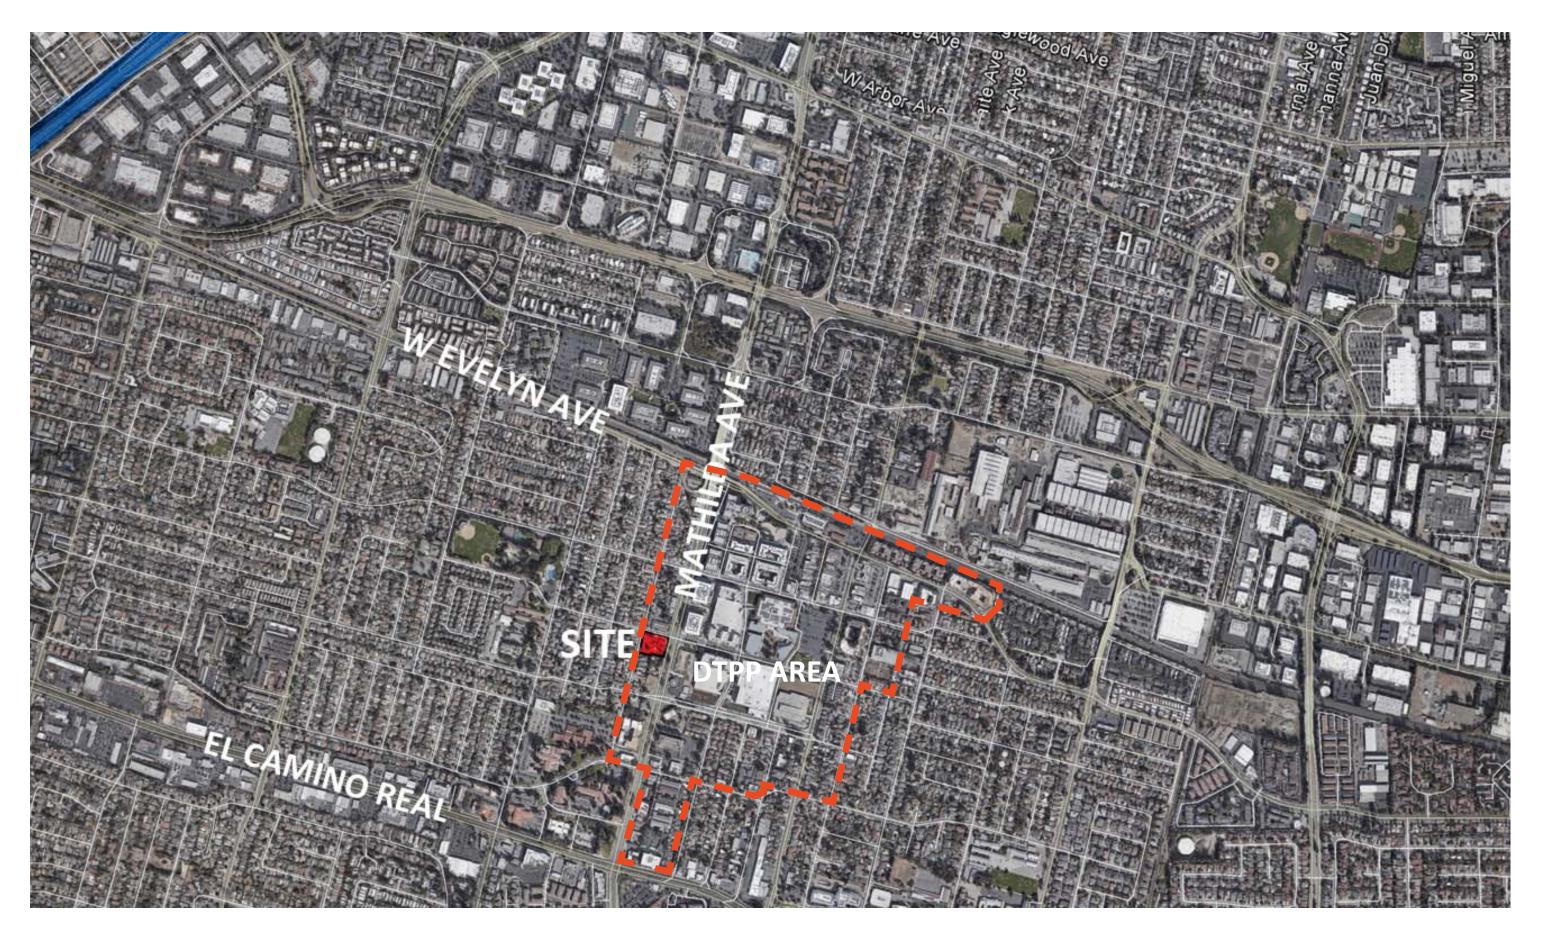Site Address: 311 S Mathilda Avenue, Sunnyvale, CA 94086

APN: 165-13-050 1.01 Site Area:

Existing Use: Commercial Commercial, Multi-family Residential Proposed Use:

Density: 54 du/acre Proposed Density:

75 du/acre

(54 x 0.05 Green Building Bonus = +2 units)  $(2+54 \times 1.35 \text{ SDB} = 75 \text{ units allowed})$ 

## PROJECT DESCRIPTION:

311 Mathilda is a mixed-use project located on the corner of McKinley and S Mathilda in Sunnyvale. The project comprises of 5,000 square Denny's restaurant. The residential component will be made up of 75 the single family neighborhood. A central podium courtyard provides open space for the residents. This layout provides a small-scale appearance along Charles Street.

#### PROJECT TEAM:

APPLICANT: LANE PARTNERS 644 Menlo Avenue 2nd Floor Menlo Park, CA 94025 Contact: MARCUS GILMOUR Phone: 650.838.0100

APPLICANT: BAY WEST DEVELOPMENT 1725 S. Bascom Ave, Suite 1050 Campbell, CA 95008 Contact: PETE BERITZHOFF Phone: 408.680.4938

ARCHITECT/PLANNER: STUDIO T-SQ, INC. 304 12th Street, Suite 2A Oakland, CA 94607 Contact: DOUGLAS OLIVER Phone: 510.451.2850

**CIVIL ENGINEER: BKF ENGINEERS** 4670 Willow Rd, Suite 250 Pleasanton, CA 94588 Contact: ALEXIS MATUSEK Phone: 925.396.7700

LANDSCAPE: SAW // SPIEGEL AIHARA WORKSHOP 2325 3rd ST, Suite 216 San Francisco, CA 94107 Contact: MEGUMI AIHARA Phone: 415.890.4729

TRASH MANAGEMENT AMERICAN TRASH MANAGEMENT 1900 Powell Street, STE 890 Emeryville, CA 94608 ContacT: Scott Brown Phone: 415.292.5401

**UTILITY ENGINEER:** GIACALONE DESIGN SERVICES, INC. 5820 Stoneridge Mall Rd Ste 345, Pleasanton, CA 94588 Contact: ANDREW CUMMINS Phone: 925.467.1740

MEP ENGINEERS: **ALFA TECH** 1321 Ridder Park Drive, No. 50 San Jose, CA 95131 Contact: Saied Nazeri Phone: 408.487.1200

STRUCTURAL ENGINEER HOHBACH-LEWIN, INC 260 Sheridan Ave, Suite 150 Palo Alto, CA 94306 Contact: Dan Lewin Phone: 650.617.5930

foot of commercial frontage along Mathilda that will replace the existing units with some allotted for below market rate. On Charles Street side, four townhouse type units line the frontage to reduce the scale towards

UNITS	Quan.	N.S.F.	Mix	Rentable S.F.	Parking Provided		
Studios Total	8	596	10.7%	4,765	8		
BR Units Total 41 764 54.7% 31,338		41					
2BR Units Total	26	1376	376 34.7% 35,777		34.7% 35,777		26
		•		•			
ALL UNITS -TOTAL	75	958	100.0%	71.880	75		

Residential Parking Required (.5 per bedroom)	51
Guest Parking Provided	7
Total Residential Parking Provided (3 Accessible)	82
Residential Bike Parking Required (1 per 4 units)	19
Residential Bike Parking Provided	54

COMMERCIAL		
	Existing Commercial	4,057 SF
	Proposed Commercial	4860
	Commercial Parking Required (1 per 110 SF)	44
	Commercial Parking Provided (2 Accessible Stalls)	47

STORAGE REQUIRED (200 cuft per S/1 BD, 300 cuft per 2+	BD)	17,600
# of storage per level	200 cu ft	300 cu ft
Level B1	44	14
Level 1	0	C
Level 2	0	3
Level 3	0	3
Level 4	0	3
Level 5	6	3
Total	50	26
STORAGE PROVIDED (Partially on decks / remainder in gar	rage)	17,800

COMMON OPEN SPACE REQUIRED- (50 square feet required per unit)	3,750
COMMON OPEN SPACE PROVIDED- (roof deck and courtyard)	5,035

OPEN AREA	Site Area SF	44111
	Building Coverage SF	31910
	Courtyard SF	4285
	Roof Deck	750
	Private Balcony	3465
OPEN AREA PROVIDED		850

G1.0	Project Summary	L1.0	Landscape Concept Plan
		L4.0	Landscape Planting Plan
SP1.0 SP1.1	Vicinity Map and Existing Site Photos Illustrative Site Plan	L5.0	Landscape Hydrozone Plan
SP1.2	Circulation Diagram	C0.0	Civil Cover Sheet
SP1.3	Fire Access Plan	C1.0	Existing Conditions Plan
SP1.4	Open Space Calculation	C2.0	Proposed Civil Site Plan
SP1.5	Shadow Study	C3.0	Preliminary Grading Plan
		C4.0	Preliminary Utility Plan
42.0	Basement Level Plan	C5.0	Preliminary Stormwater Control F
<b>A2.1</b>	Street Level Plan		
<b>A2.2</b>	Podium Level Plan	INT1	Joint Trench Intent Title Sheet
A2.3	Third Level Plan	INT2	Joint Trench Intent Plan
<b>A2.4</b>	Fourth Level Plan		
<b>A2.5</b>	Fifth Level Plan	T0.1	Residential Trash Collection Plan
<b>A</b> 2.6	Roof Level Plan	T0.2	Restaurant Trash Collection Plan
		T0.3	Remote Trash Collection Room
43.0	Building Elevation and Perspective	T0.4	Trash Staging Area
<b>4</b> 3.1	Building Elevation and Perspective	T1.1	Restaurant Bin Movement Plan
43.2	Building Elevation and Perspective	T1.2	Path of Travel Plan
43.3	Building Elevation and Perspective	T1.3	Path of Travel Plan
<b>4</b> 3.4	Color and Material Board	T1.4	Path of Travel Plan
		T2.0	Chute Details

## GreenPoint Rated Check List **BUILDING PROGRAM:**

**Unit Plans** 

**Unit Plans** 

**Unit Plans** 

**Building Sections** 

**Building Sections** 

**Schematic Detail** 

Schematic Detail

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- Planning
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311.8

Sheet Title: VICINITY MAP AND **EXISTING SITE** PHOTOS

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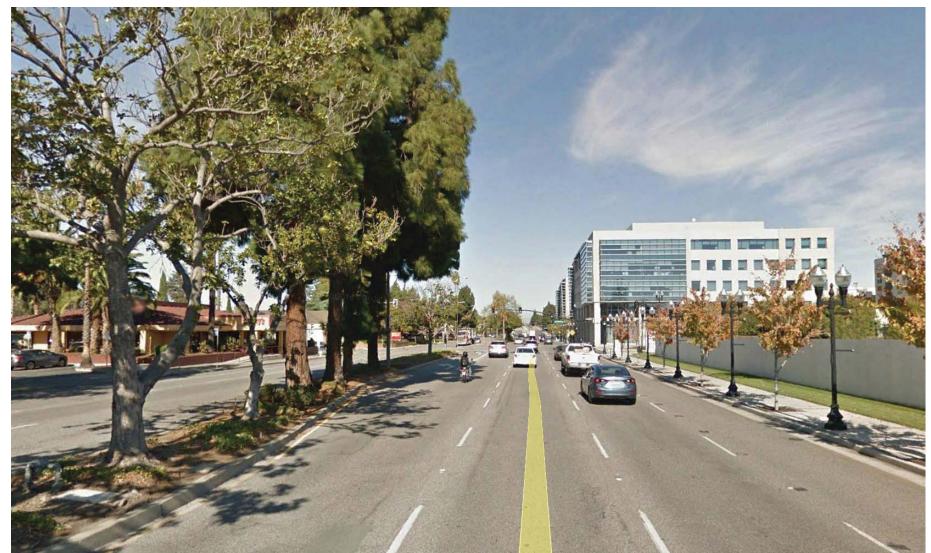


2. W MCKINLEY AVE LOOKING SOUTH



6. S MATHILDA AVE LOOKING NORTH








4. S MATHILDA AVE LOOKING NORTH EAST



5. S MATHILDA AVE LOOKING WEST

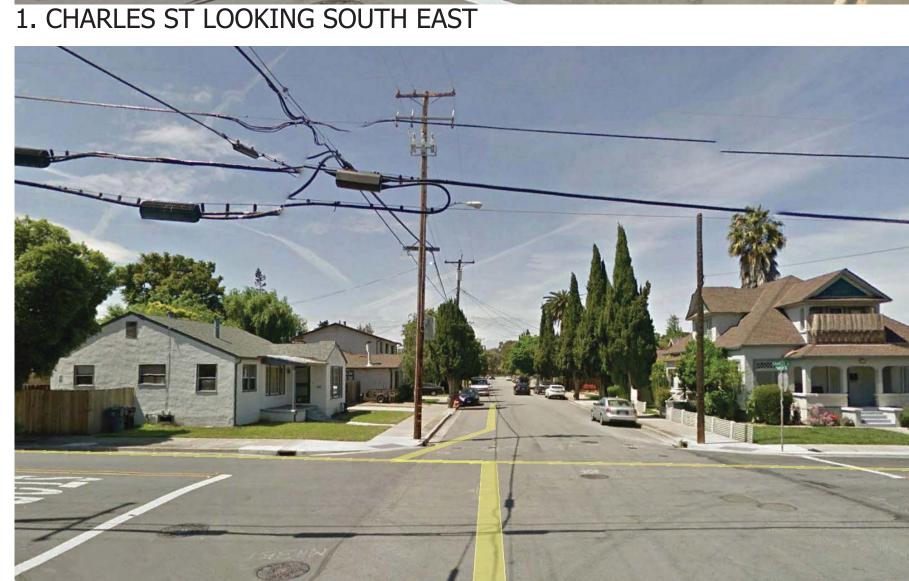

8. W MCKINLEY AVE LOOKING WEST



7. CHARLES ST LOOKING NORTH





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Sheet Title: ILLUSTRATIVE SITE PLAN

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311 S Mathilda Ave, Sunnyvale

PUBLIC PEDESTRIAN CIRCULATION

PRIVATE PEDESTRIAN CIRCULATION

RESIDENTIAL PEDESTRIAN ACCESS

VISITOR PEDESTRIAN ACCESS

COMMERCIAL PEDESTRIAN ACCESS

VEHICULAR CIRCULATION

MOVE IN / TRASH PICK-UP

TRASH STAGING AREA

VEHICULAR ACCESS

**EMERGENCY EXIT ONLY** 

Sheet Title:
CIRCULATION
DIAGRAM

Job No. 16044


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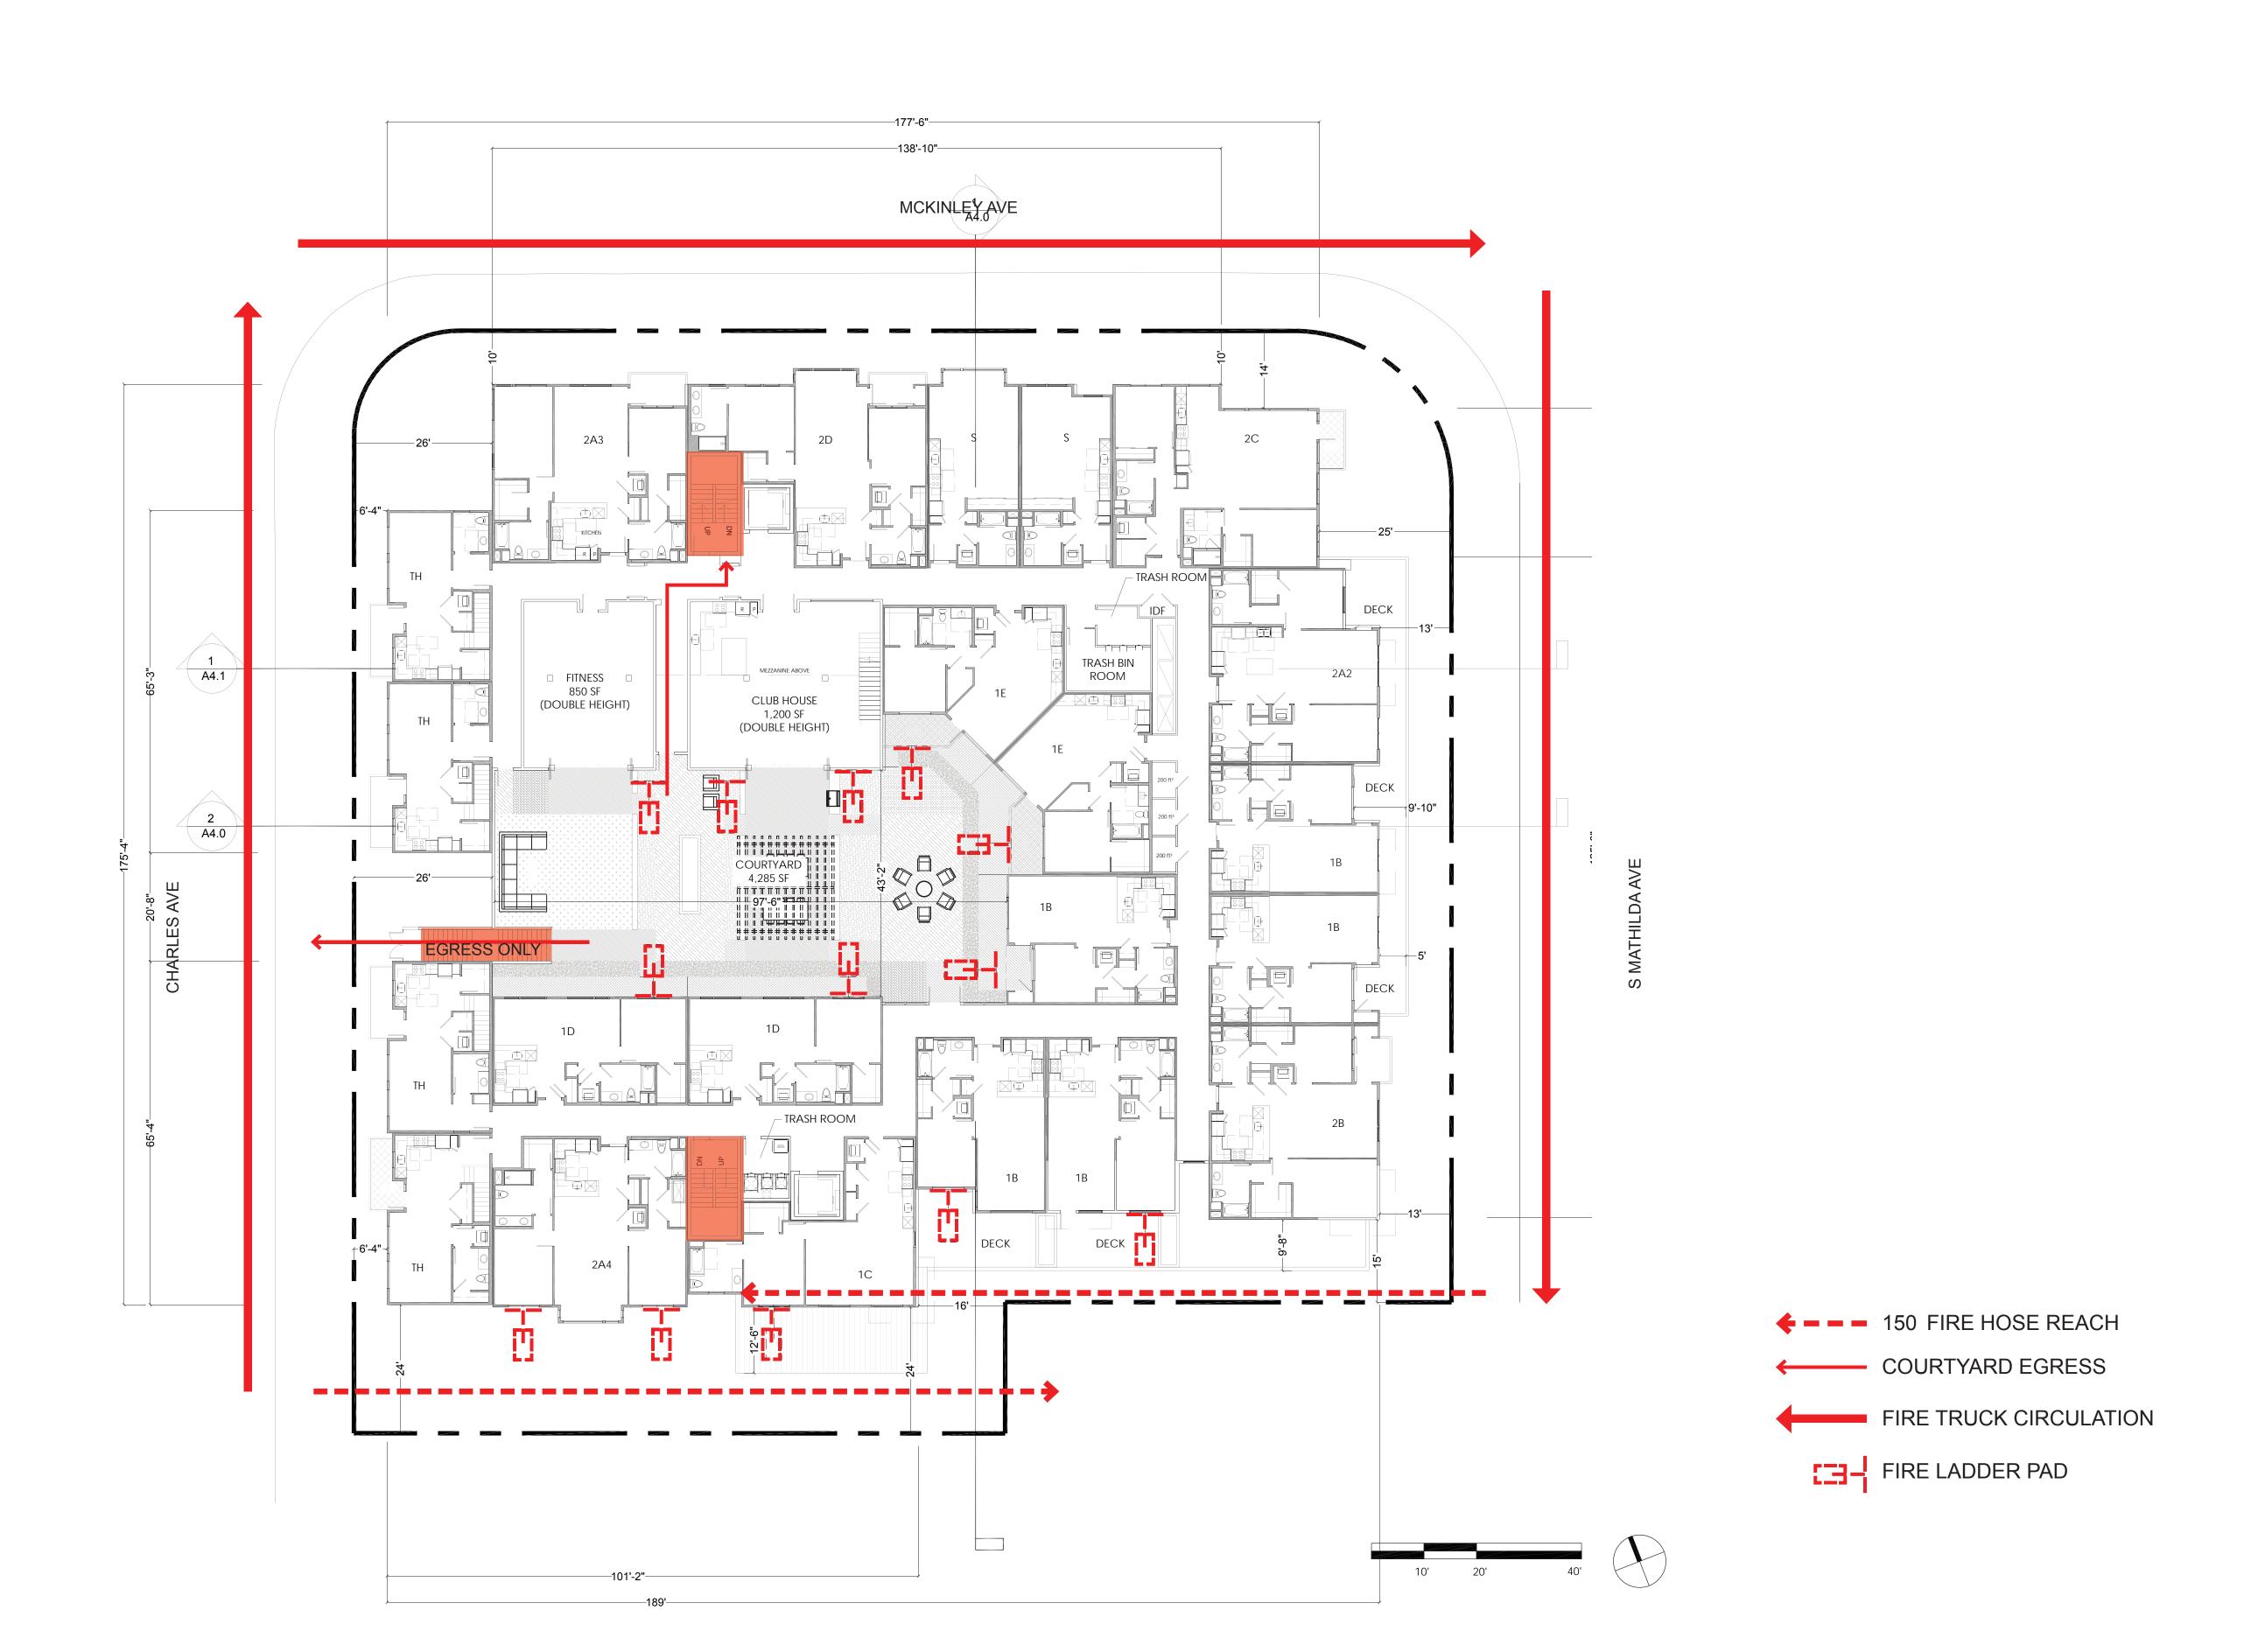
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FIRE ACCESS PLAN

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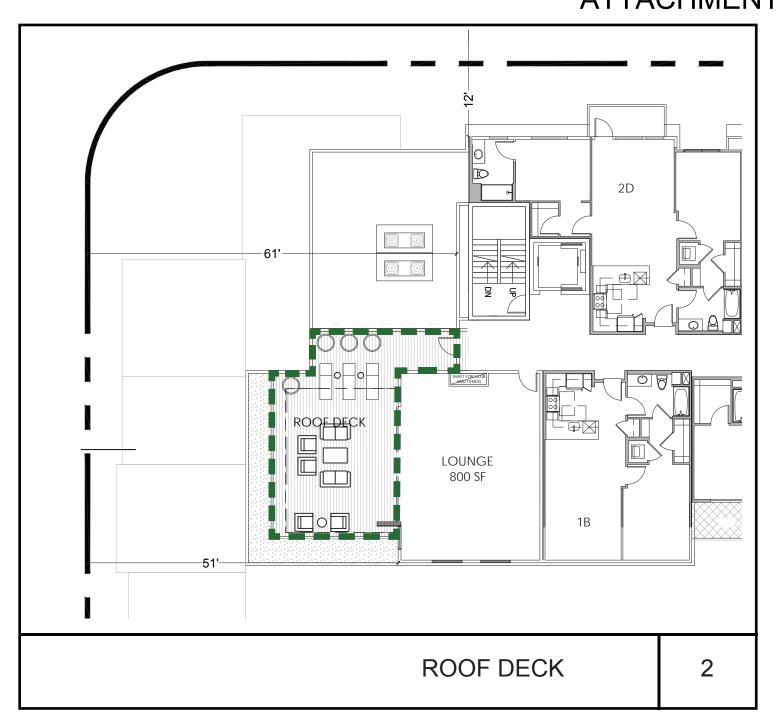
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#### **OPEN SPACE REQUIREMENT** 50 SF(PER UNIT) X 75 =3750 SF

OPEN SPACE PROVIDED

EXTERIOR PUBLIC = 1,990 SF COURTYARD = 4,285 SF PRIVATE BALCONIES = 3,465 SF ROOF DECK = 750 SF

TOTAL PROVIDED = 10,490 SF (WITH EXTERIOR PUBLIC) 8,500 SF (WITHOUT EXTERIOR PUBLIC)

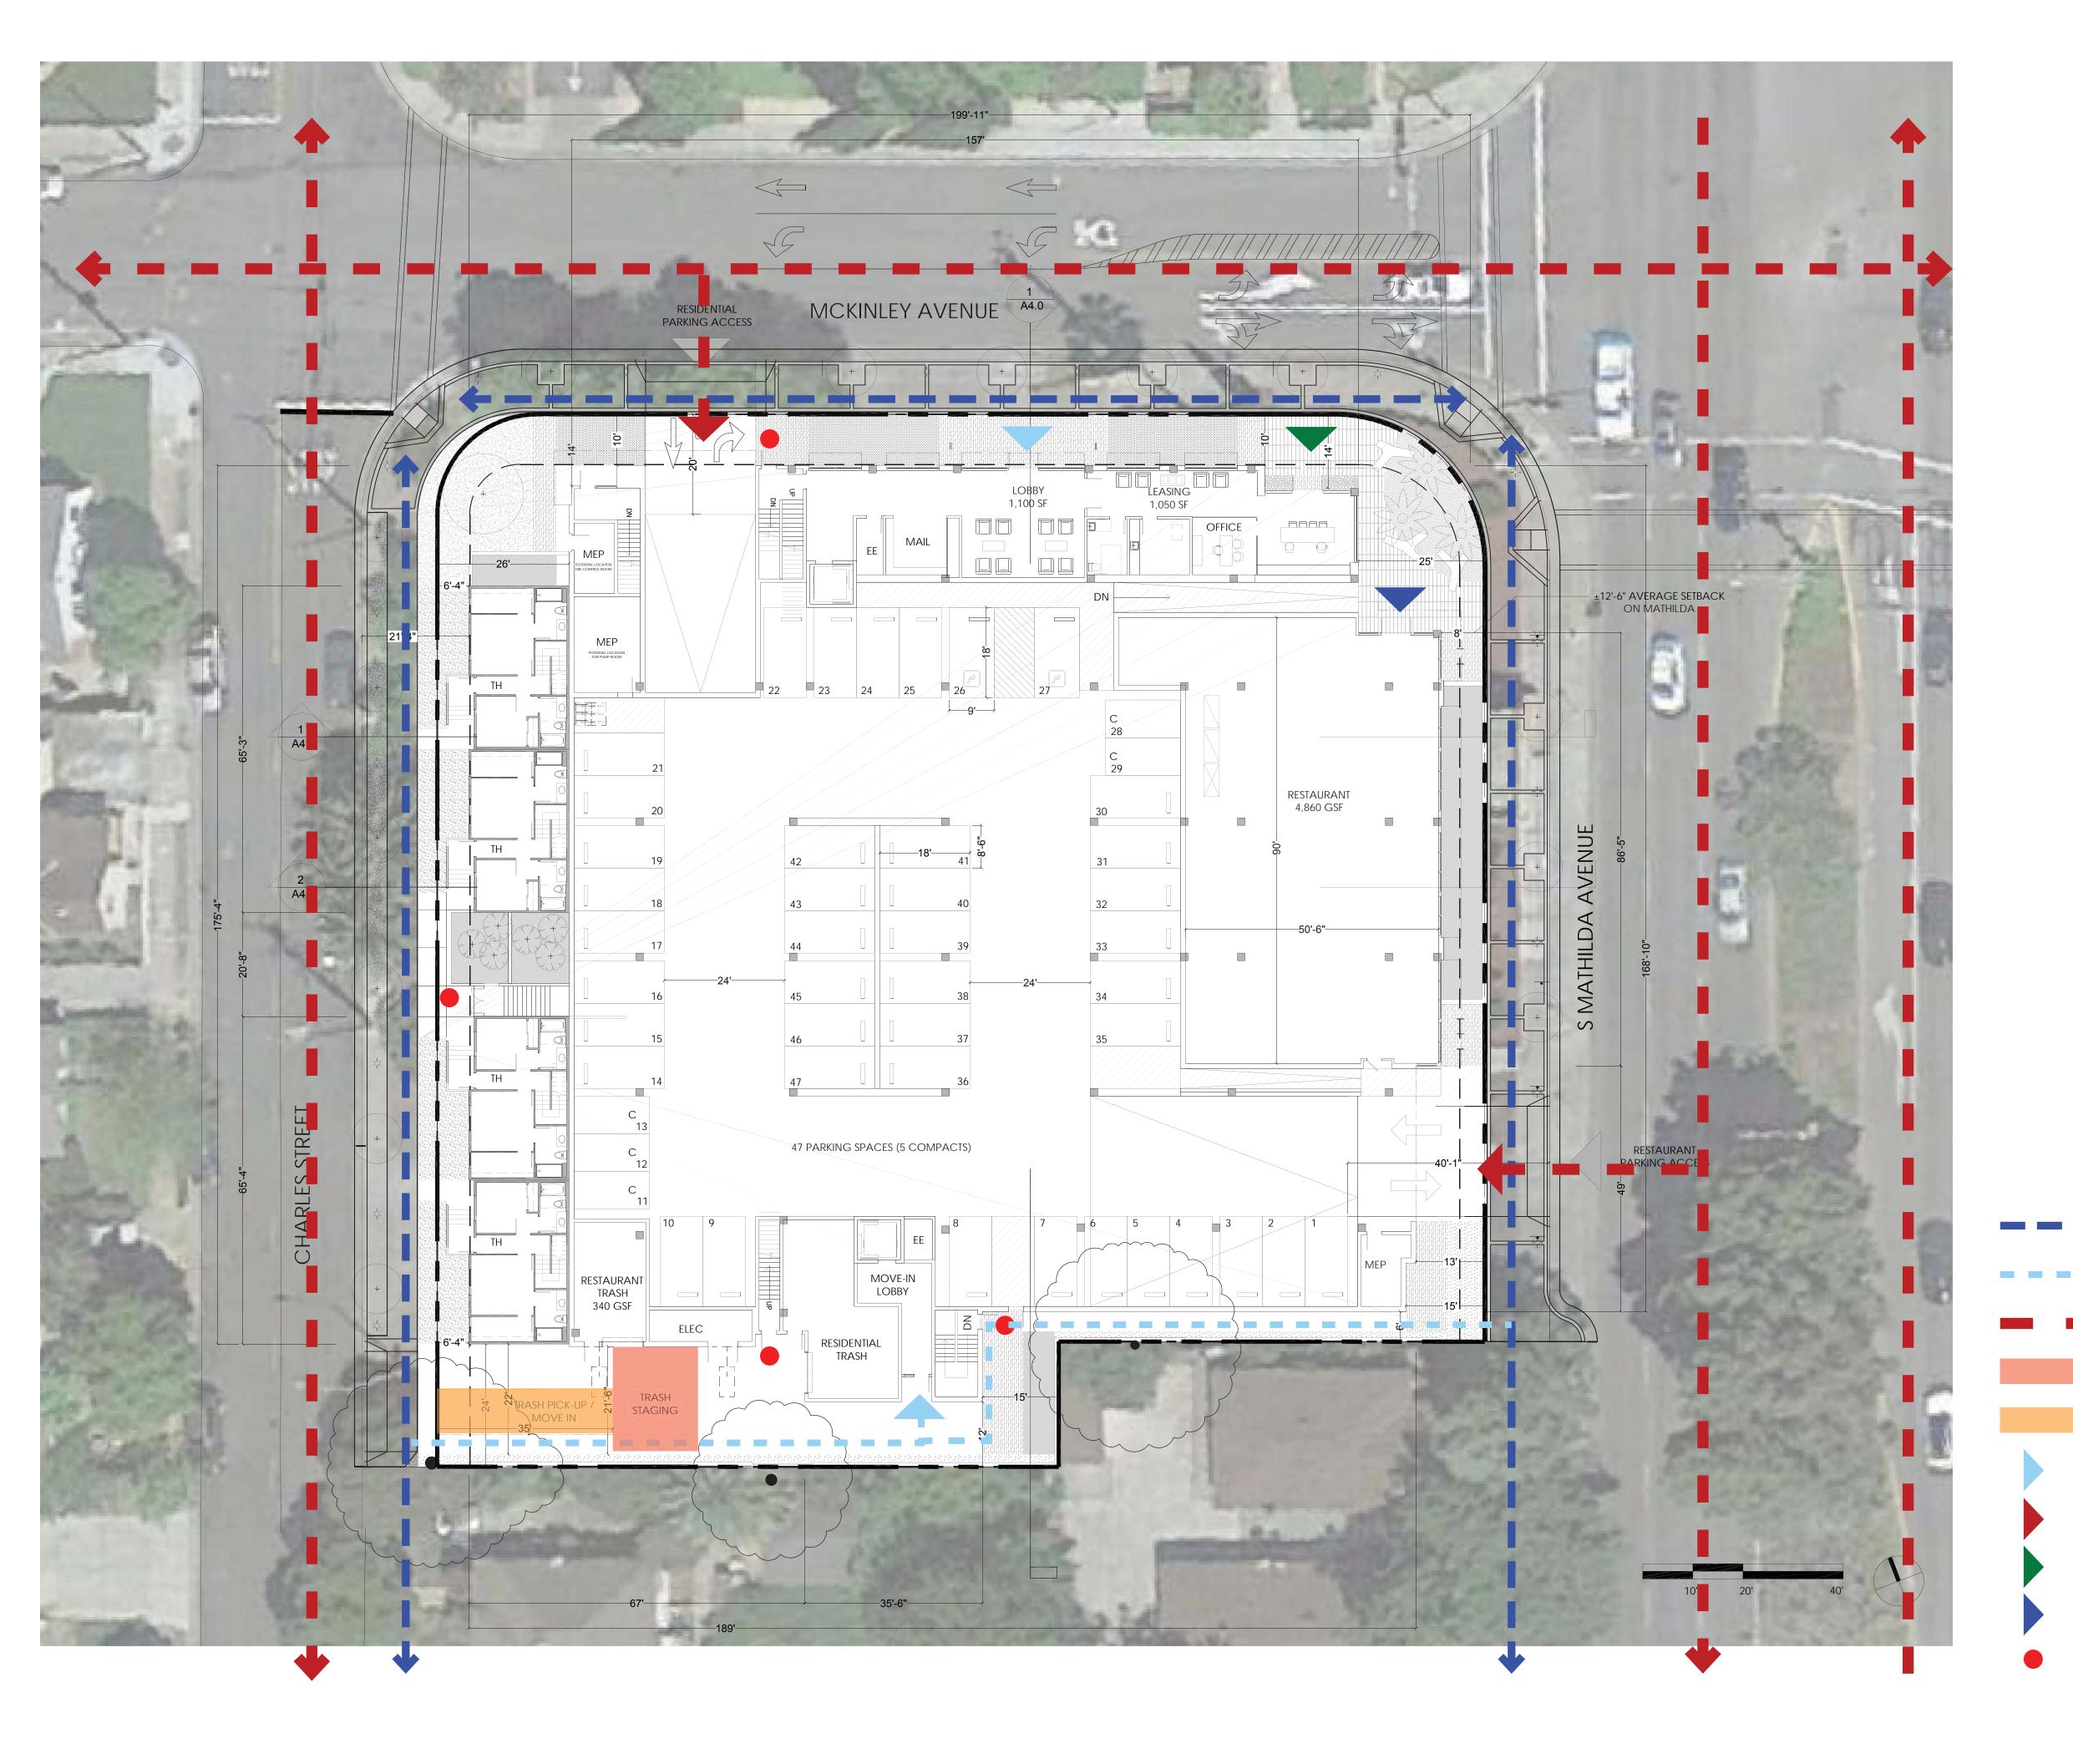

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Sheet Title: OPEN SPACE CALCULATION

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Sheet Title: SHADOW STUDY

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SP1.5




















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Sheet Title: BASEMENT LEVEL PLAN

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Sheet Title:
STREET LEVEL

Mathilda

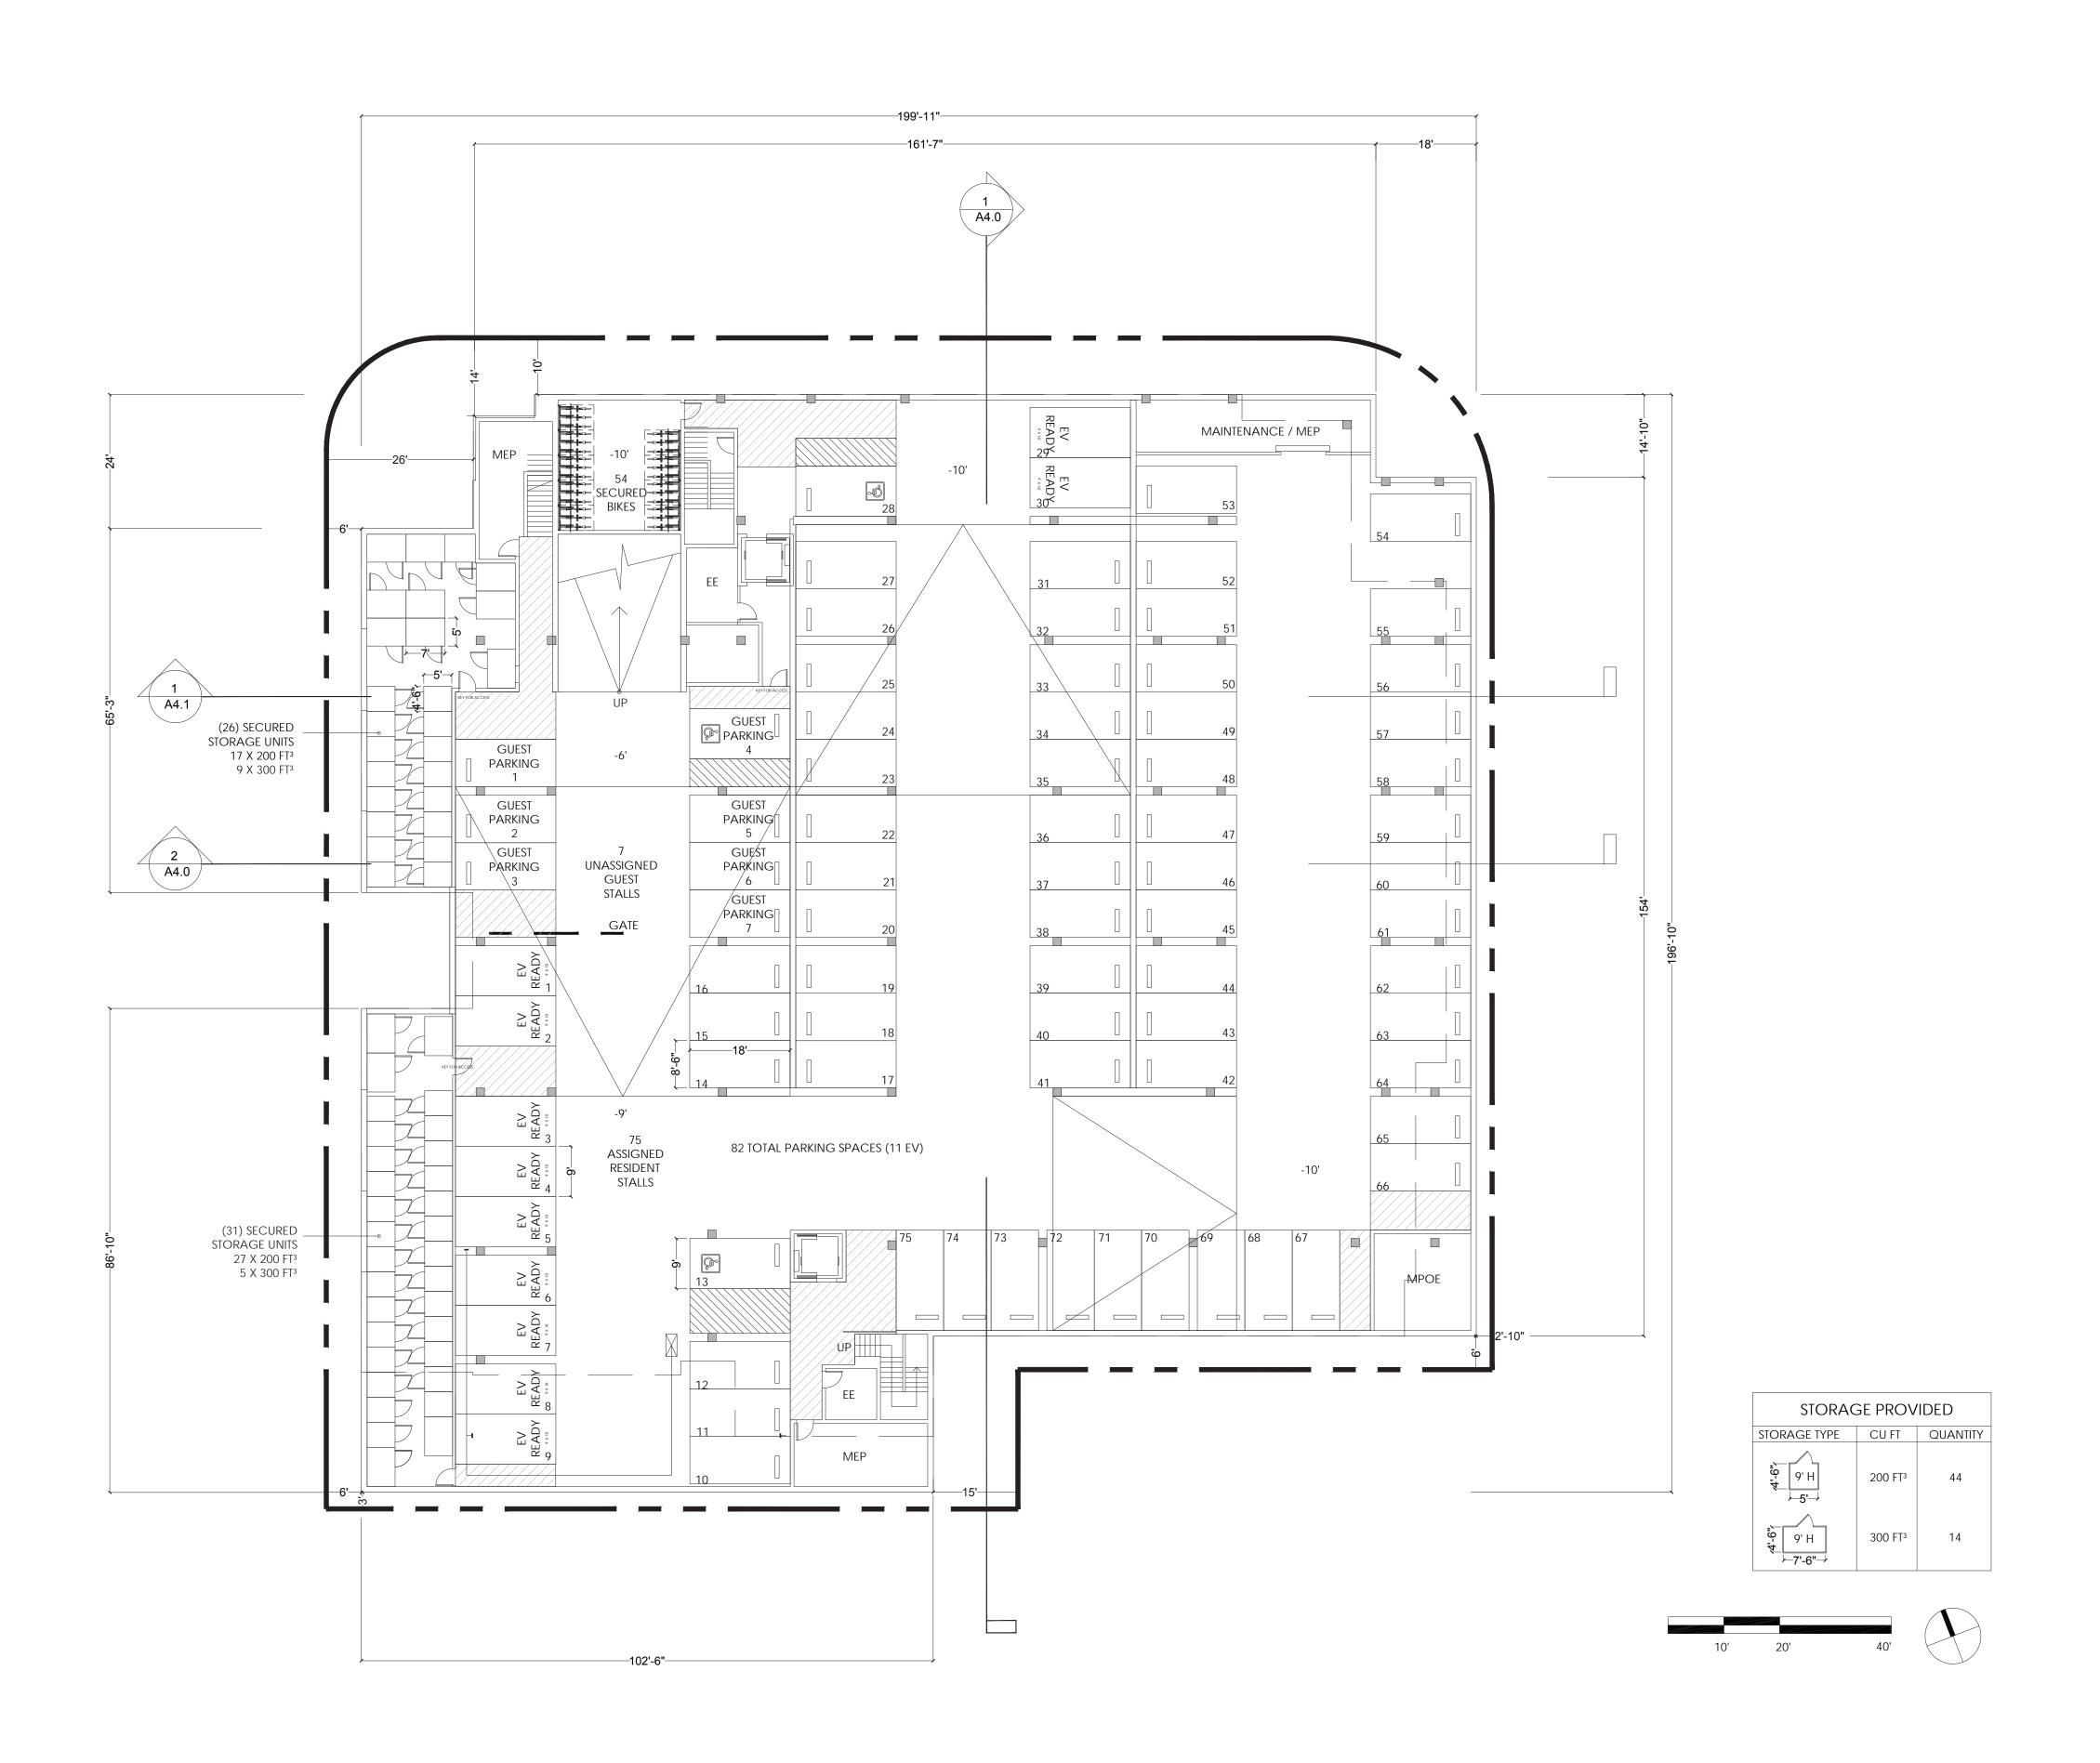
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PLAN





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Sheet Title:
PODIUM LEVEL
PLAN


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Sheet Title:
THIRD LEVEL PLAN
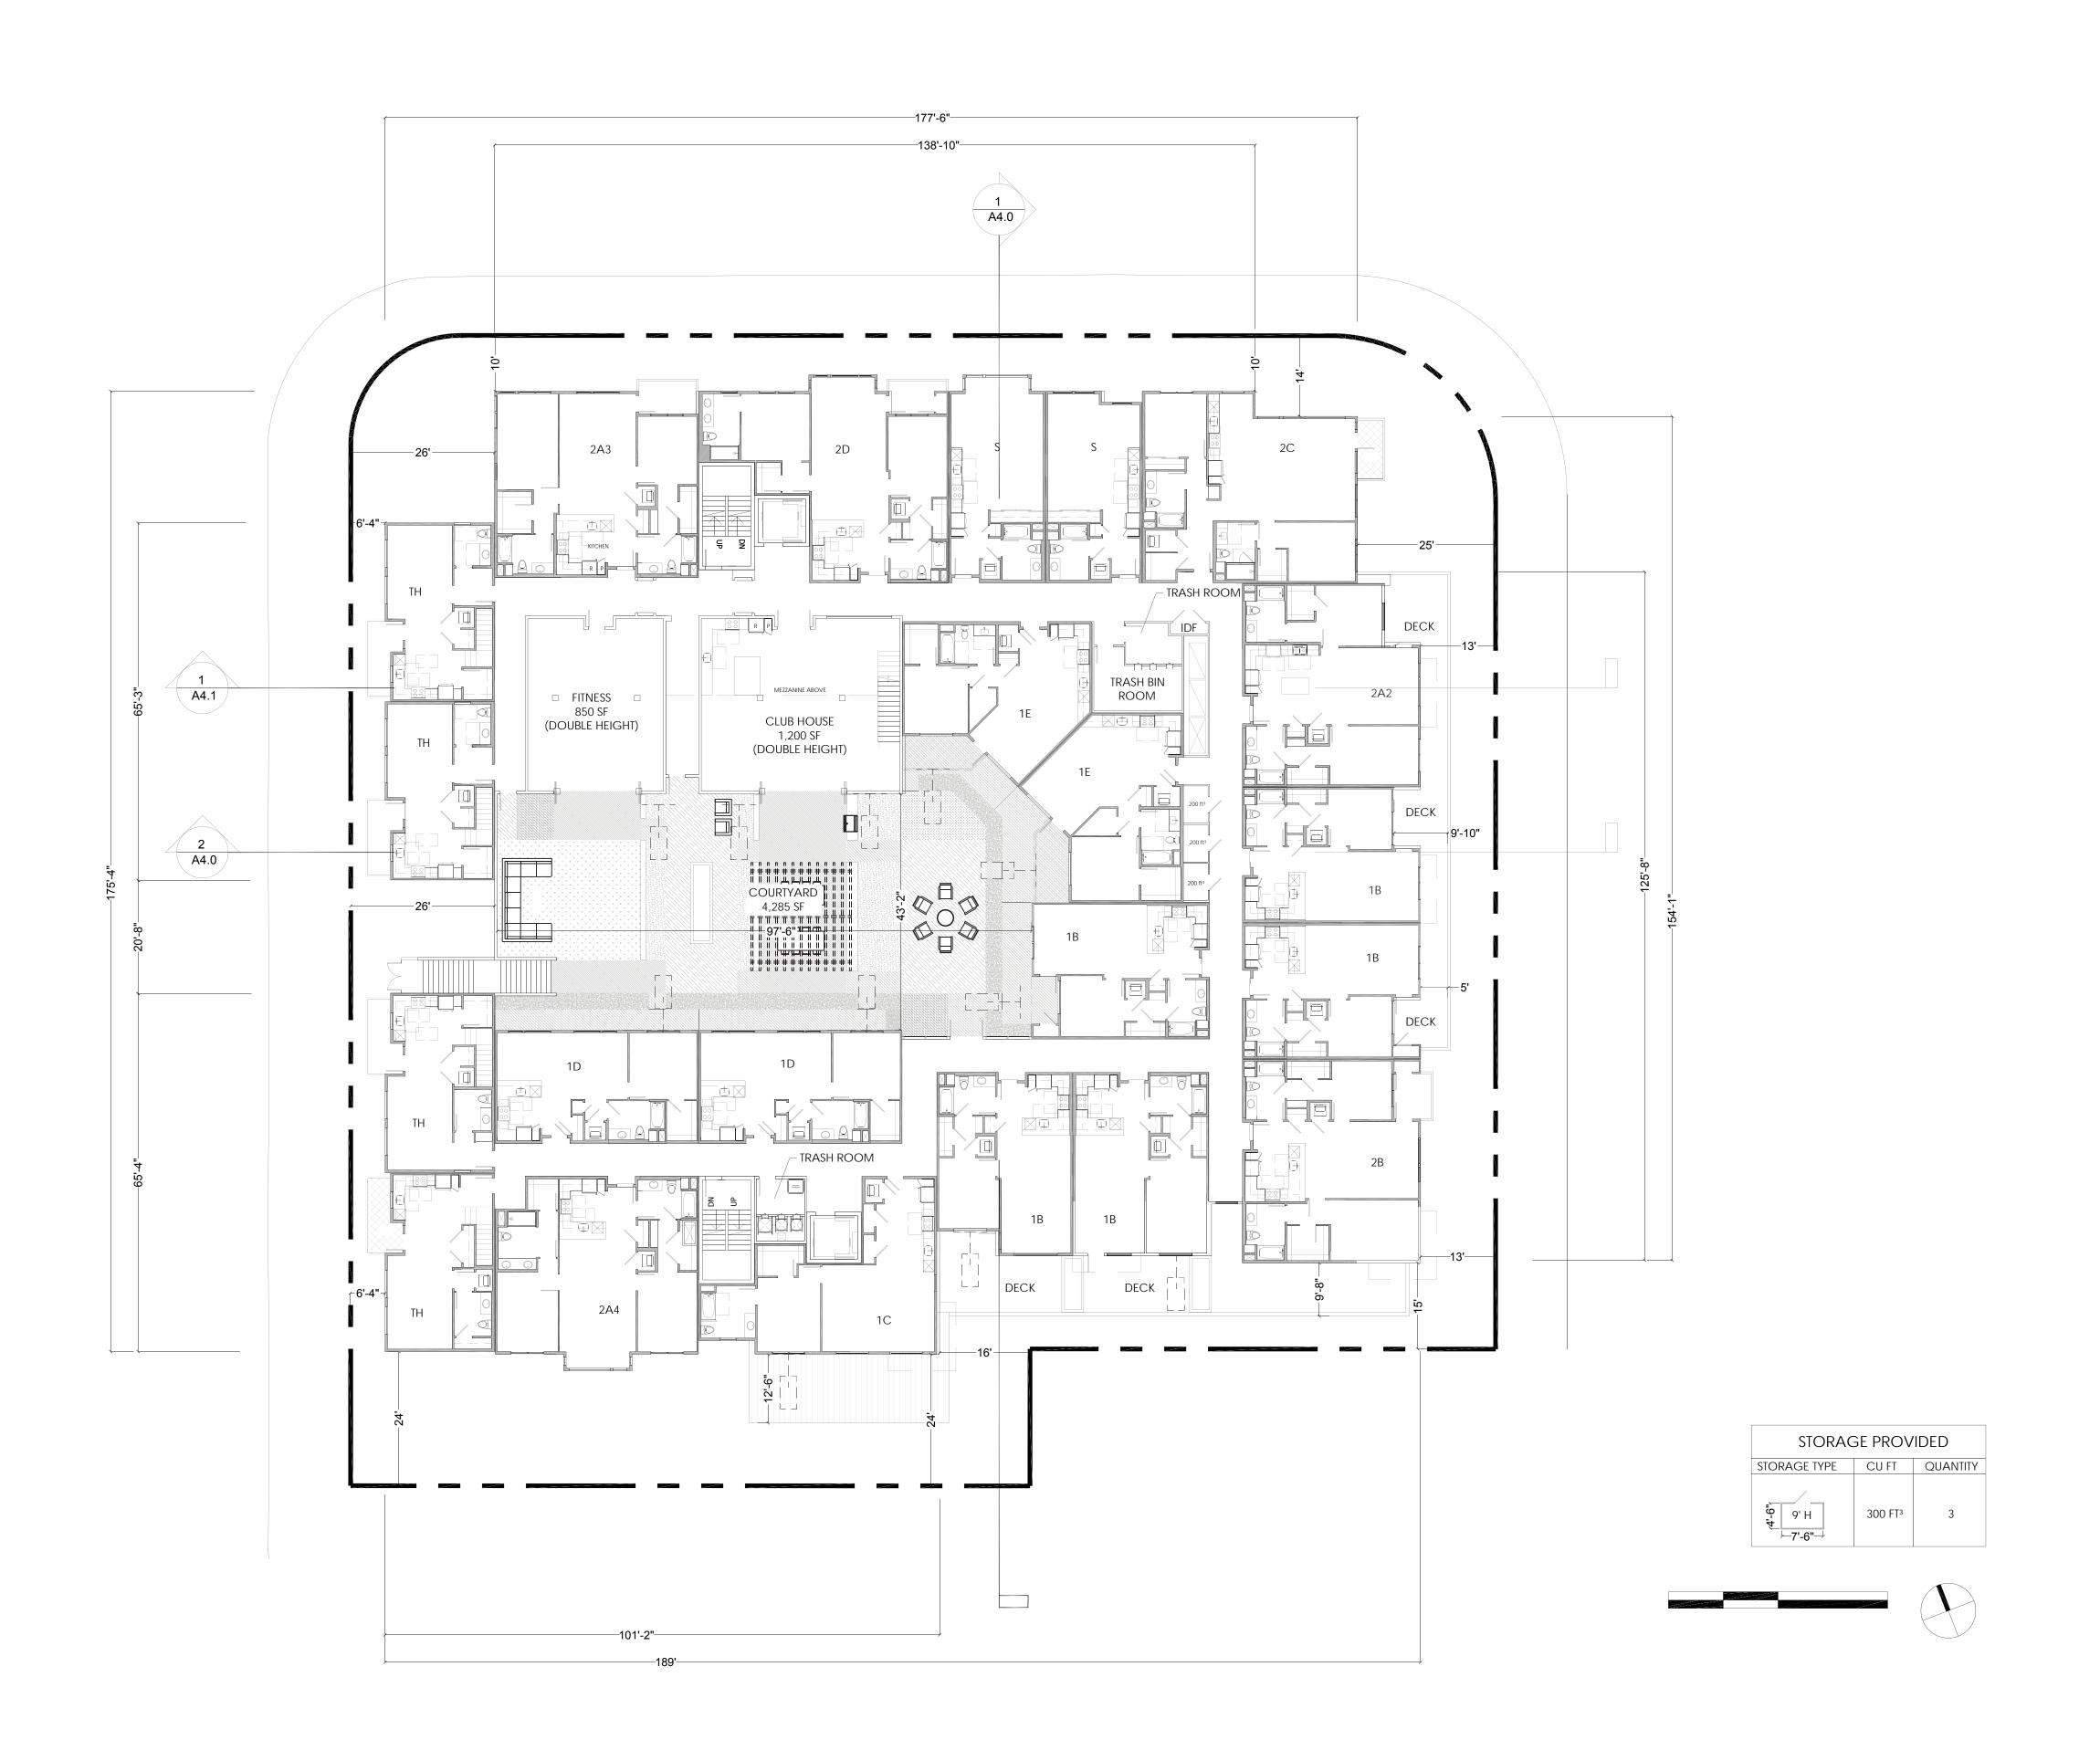
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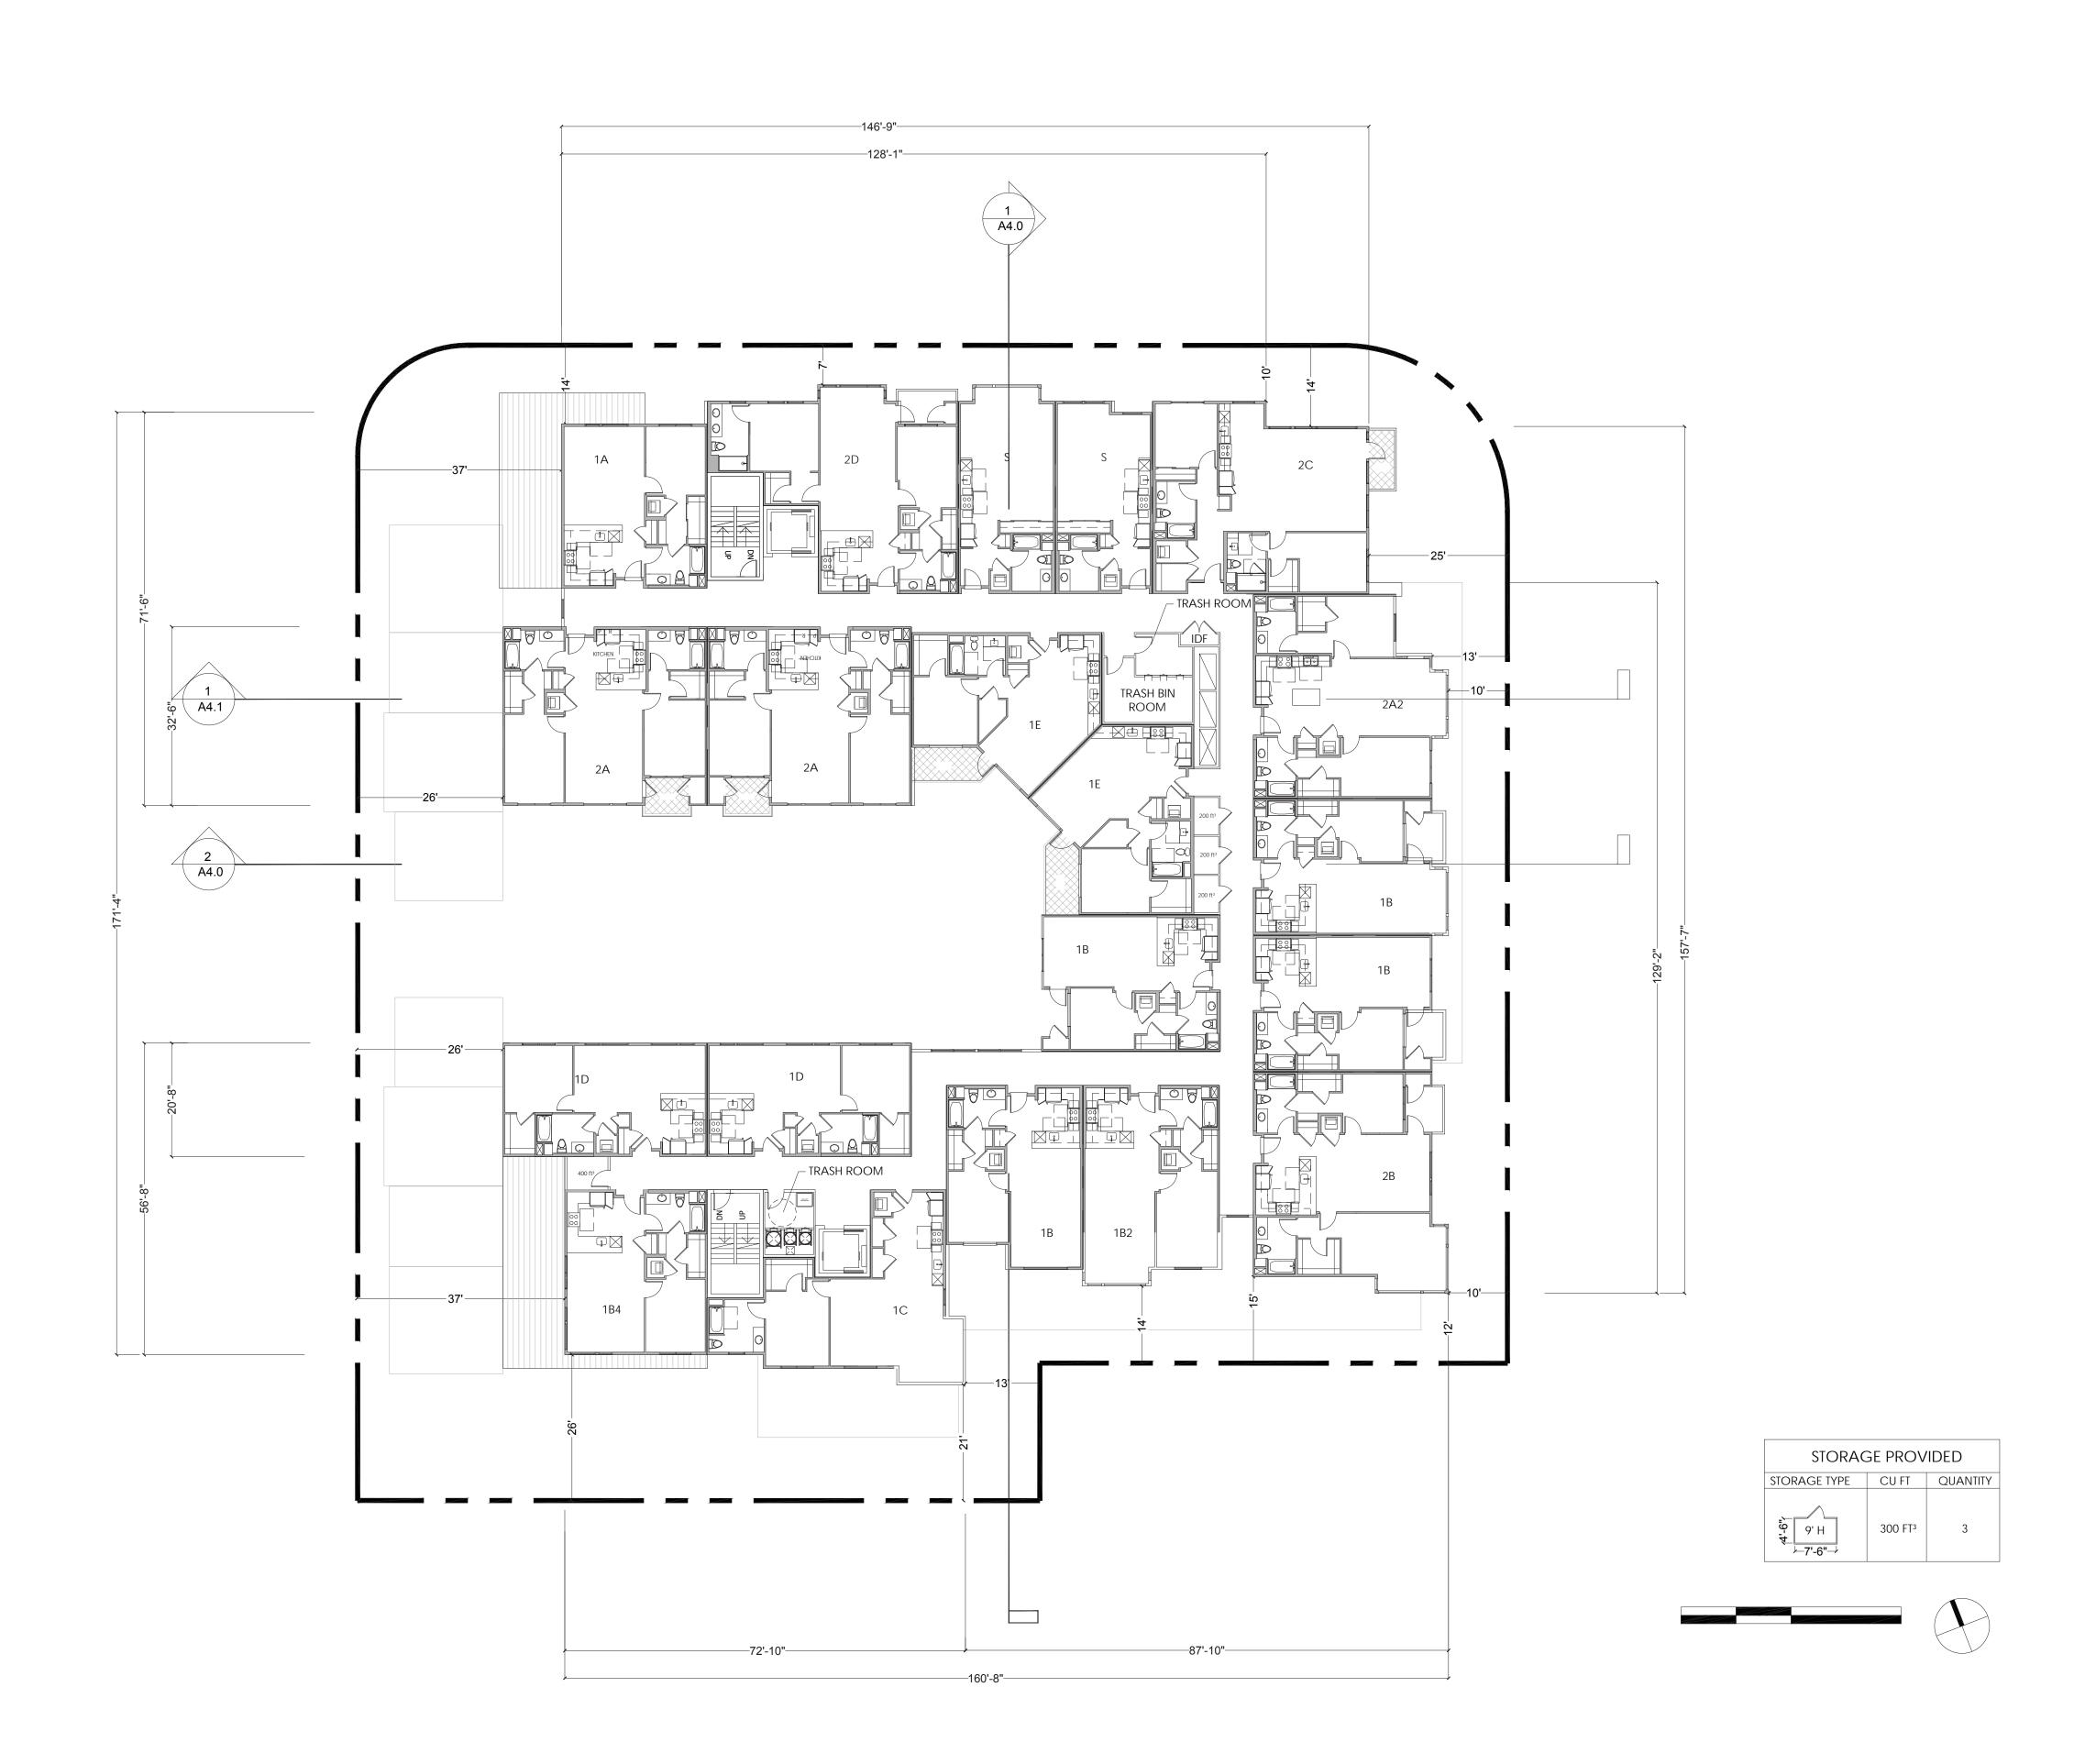
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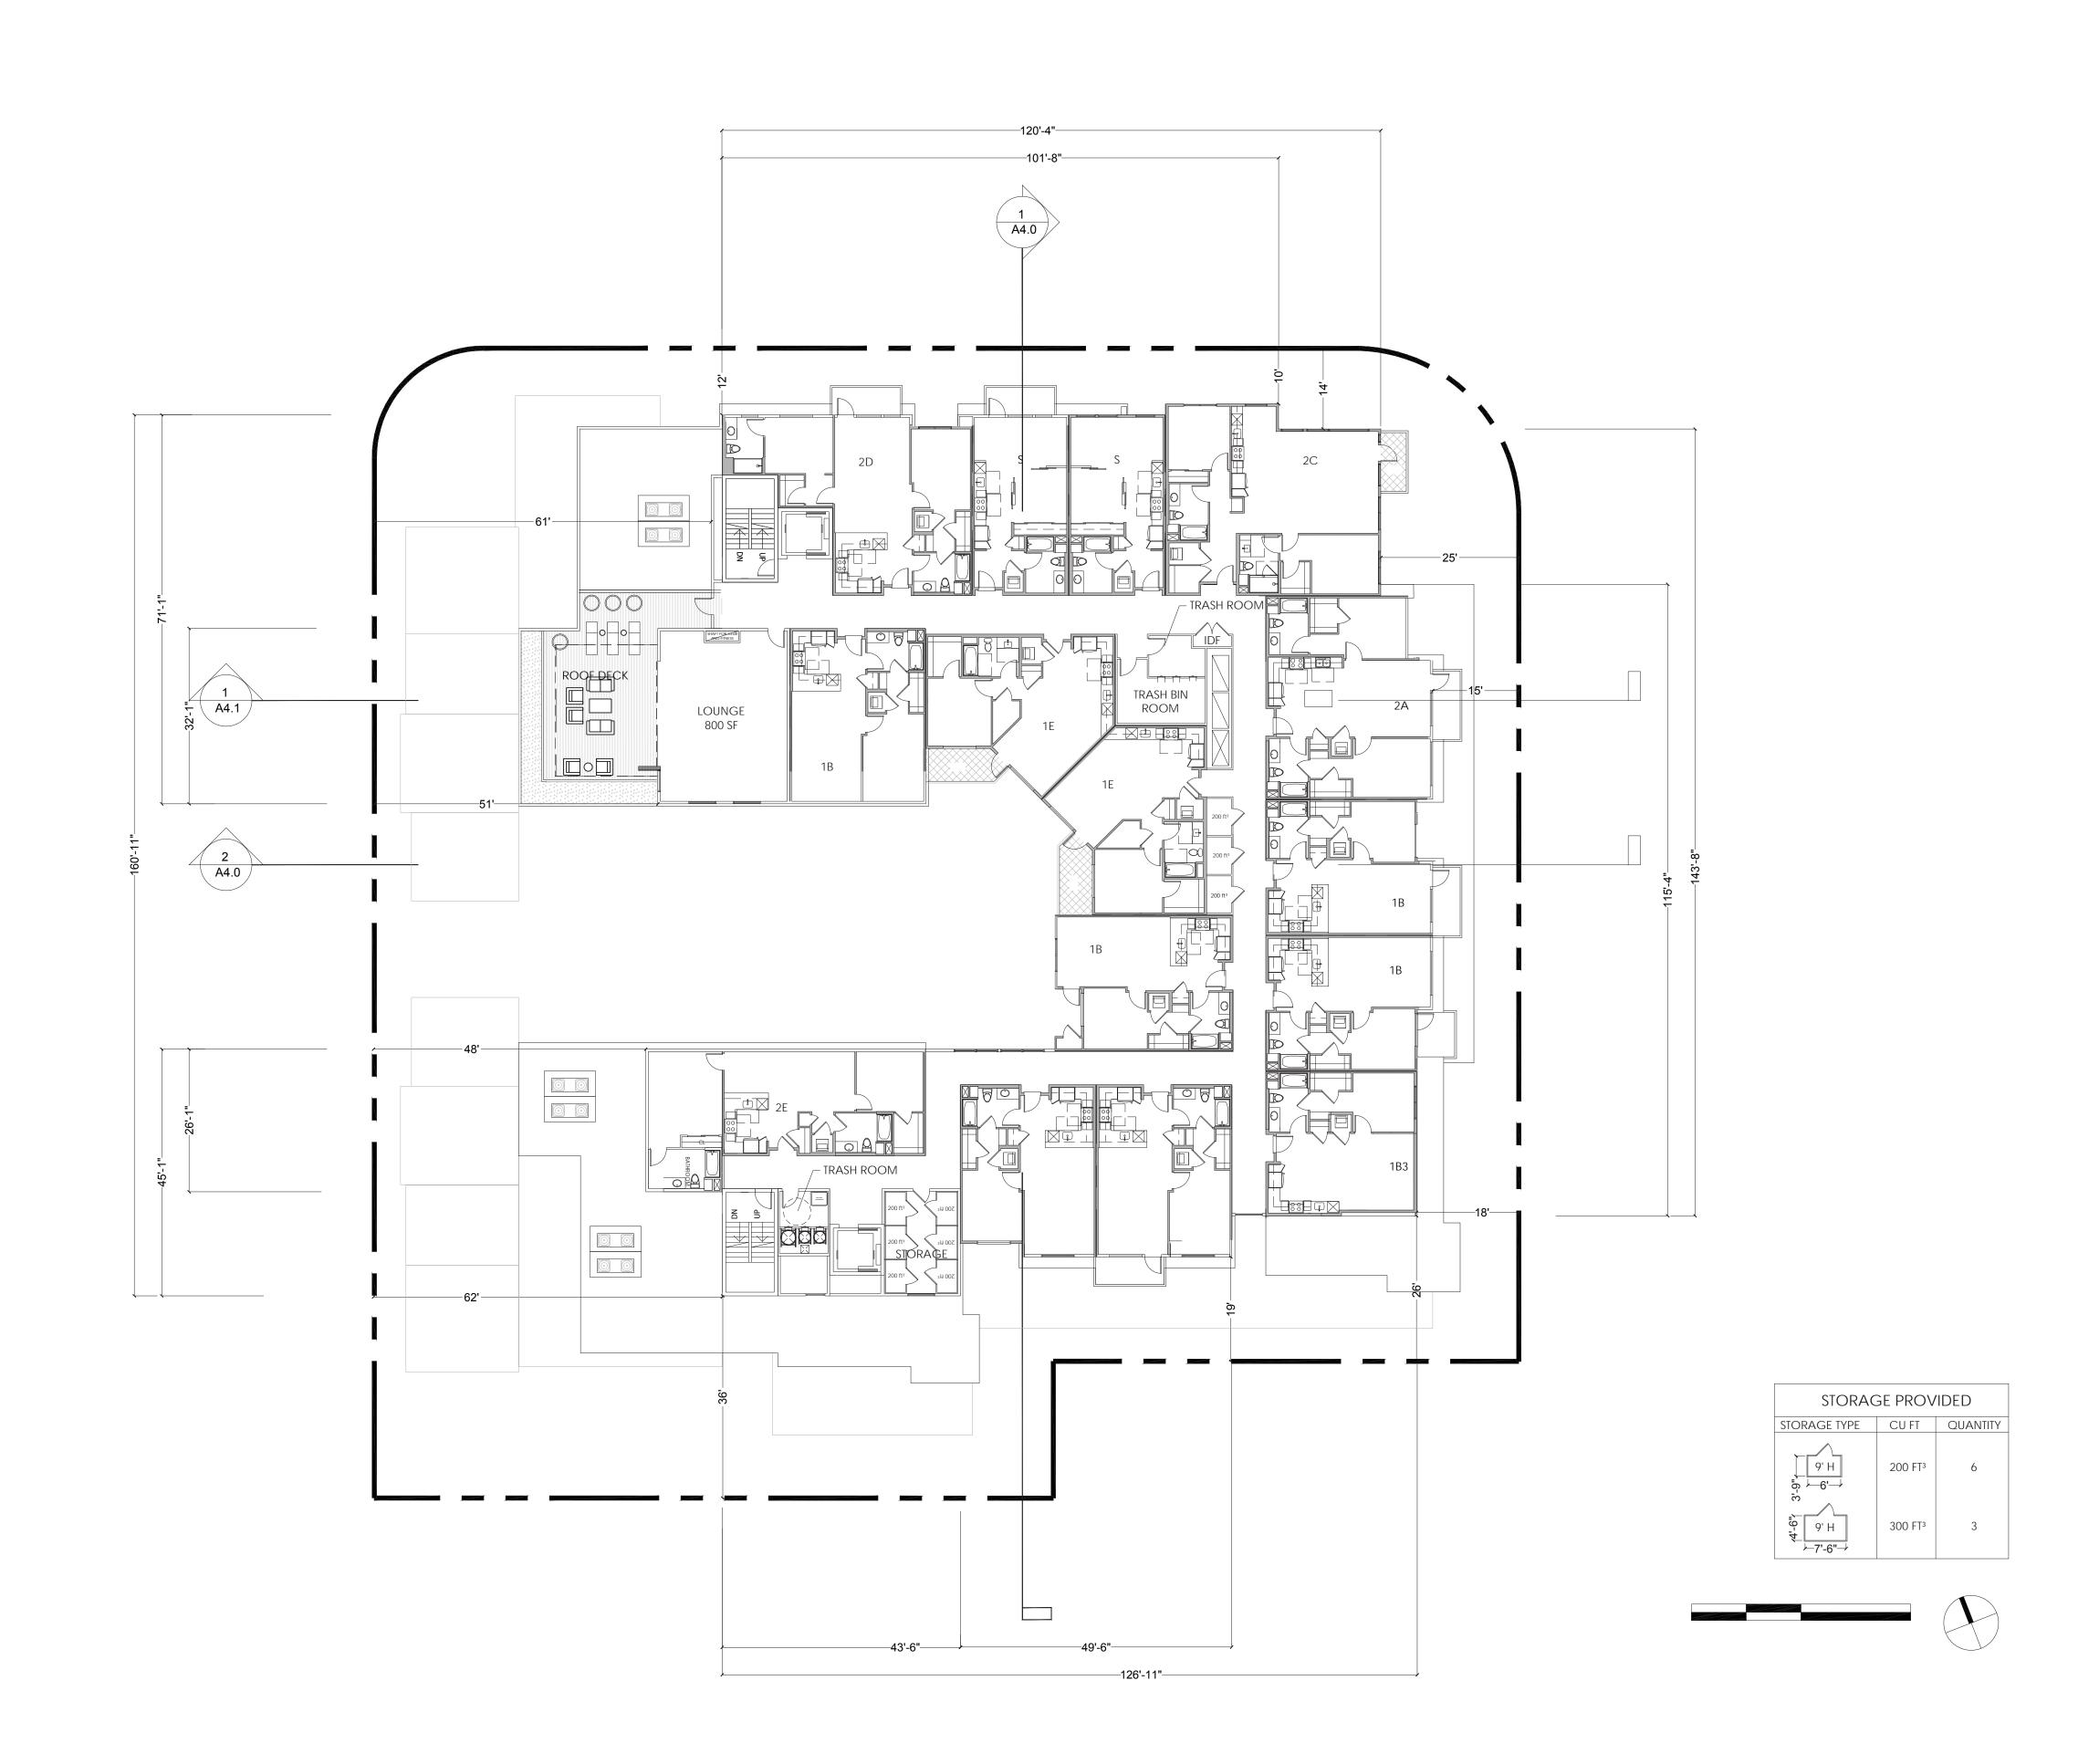
Sheet Title: FOURTH LEVEL PLAN

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FIFTH LEVEL PLAN

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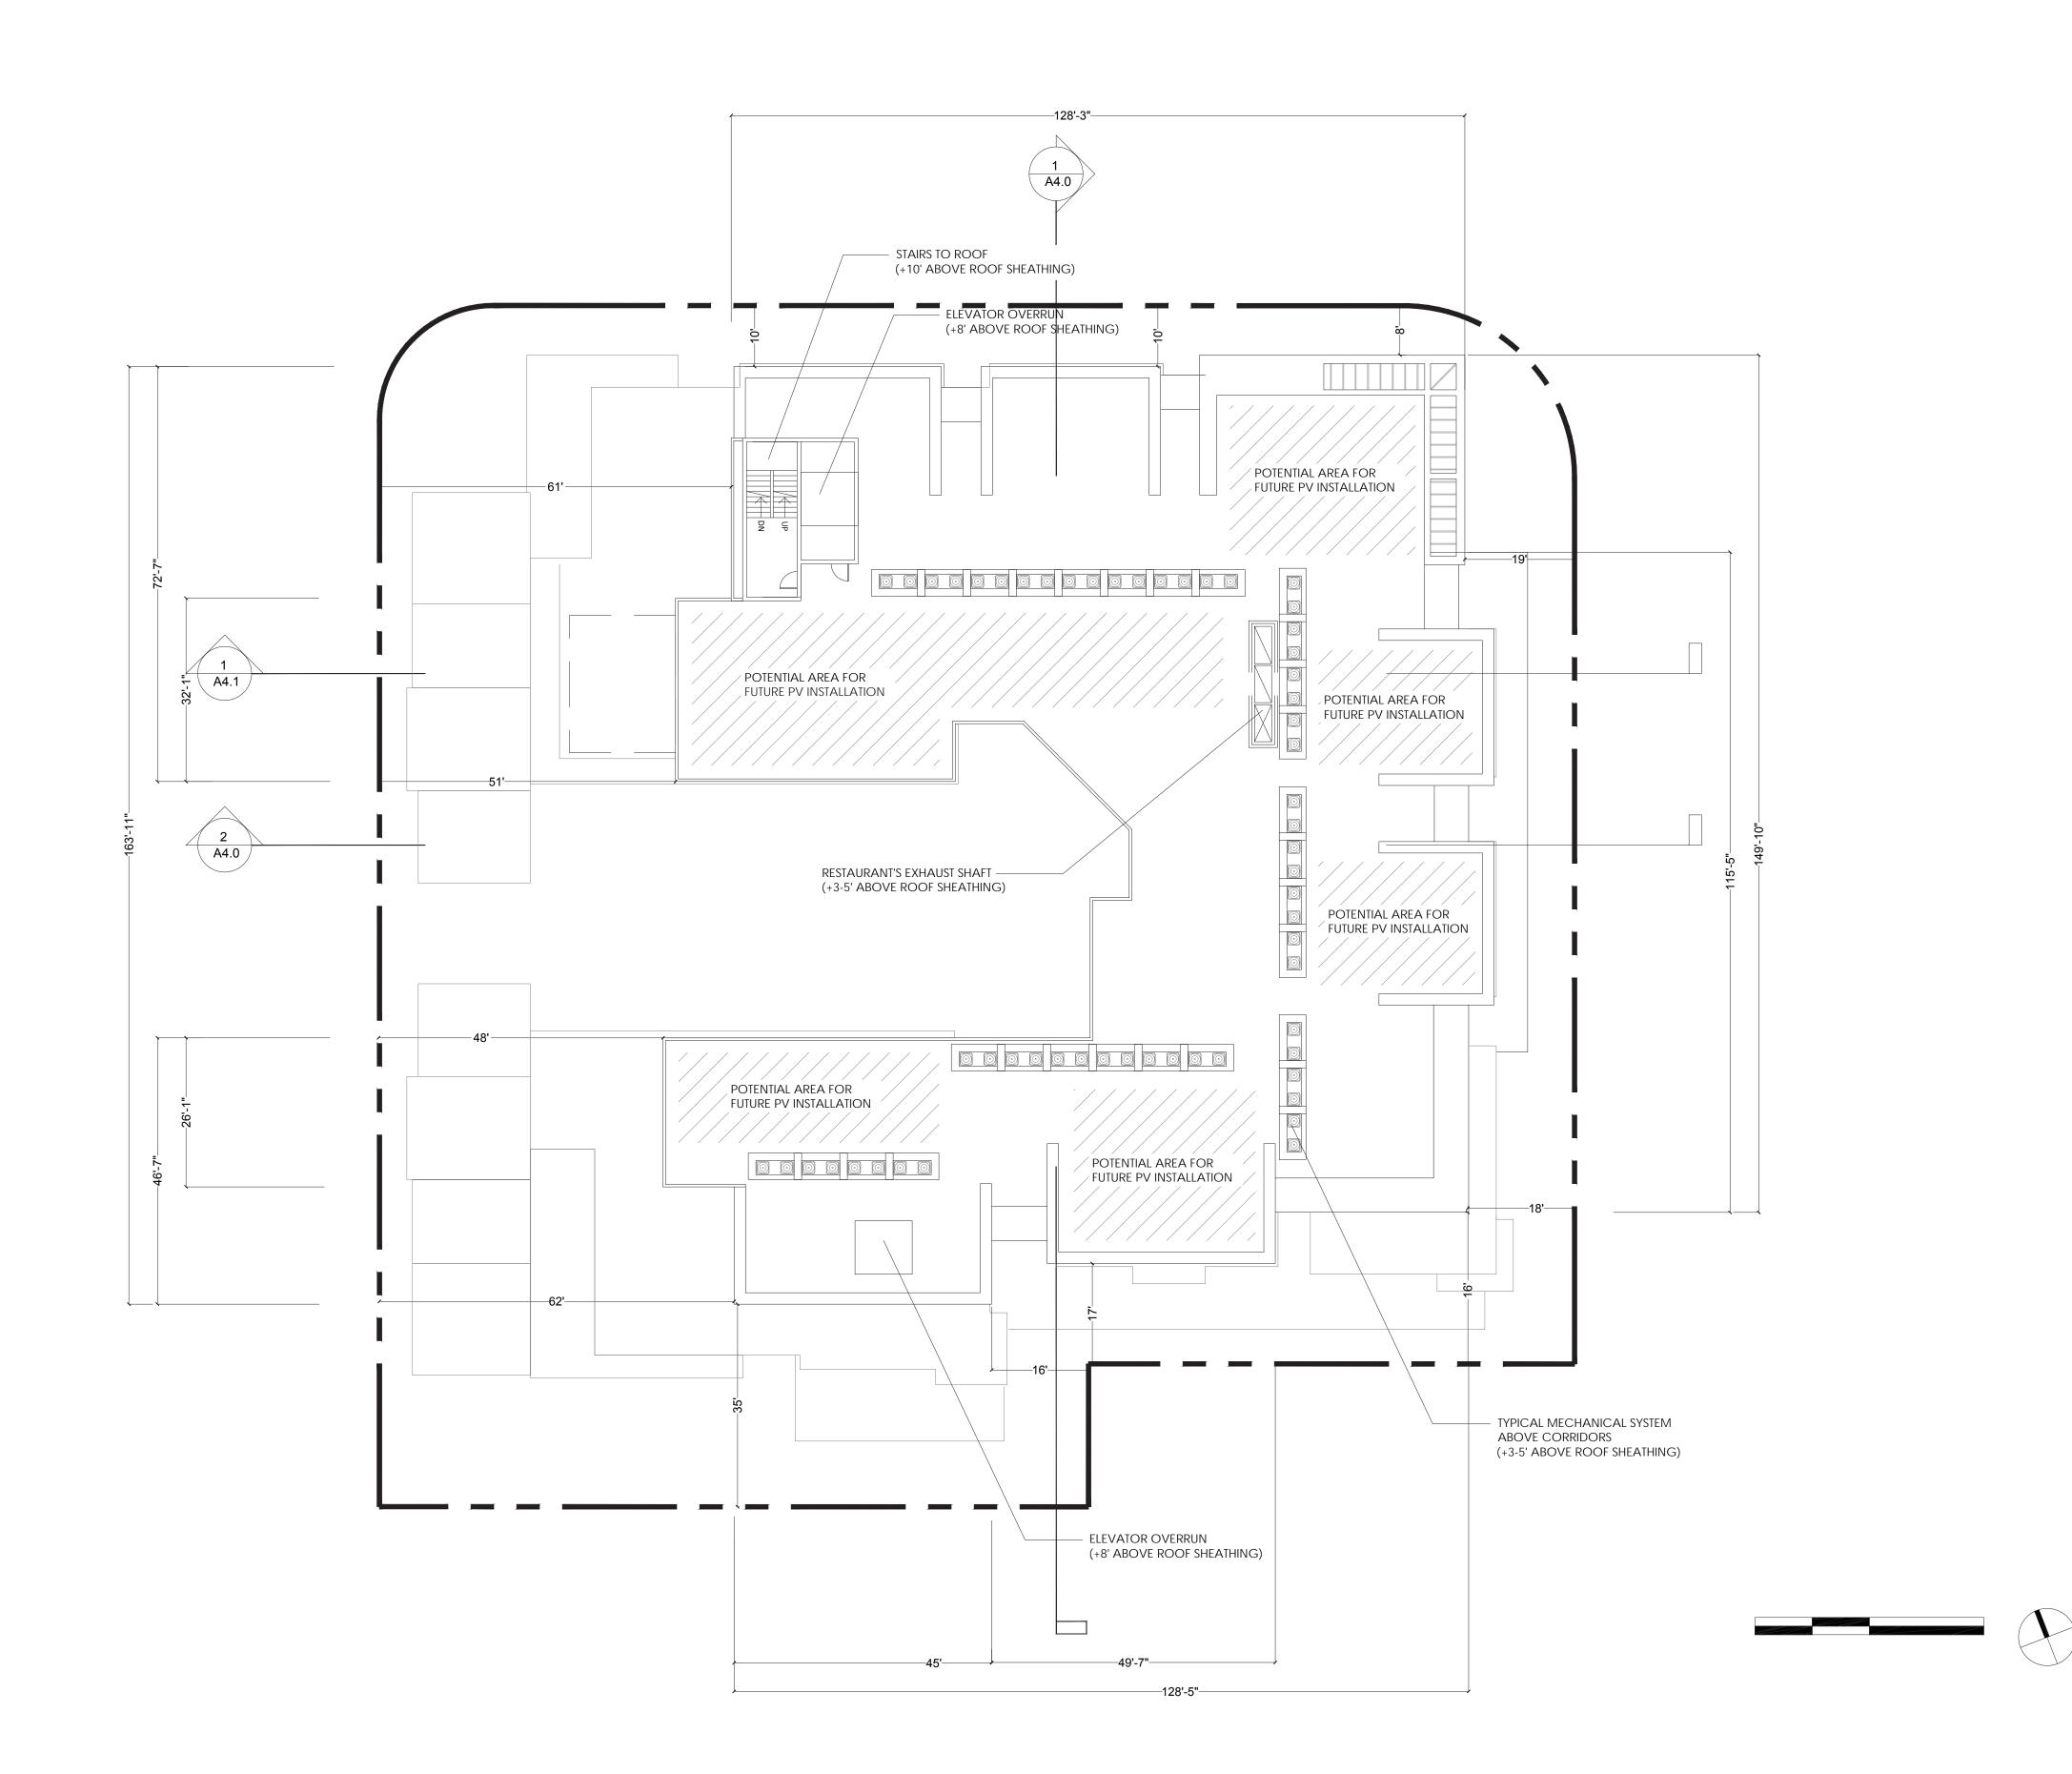
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ROOF LEVEL PLAN

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Drawn By:
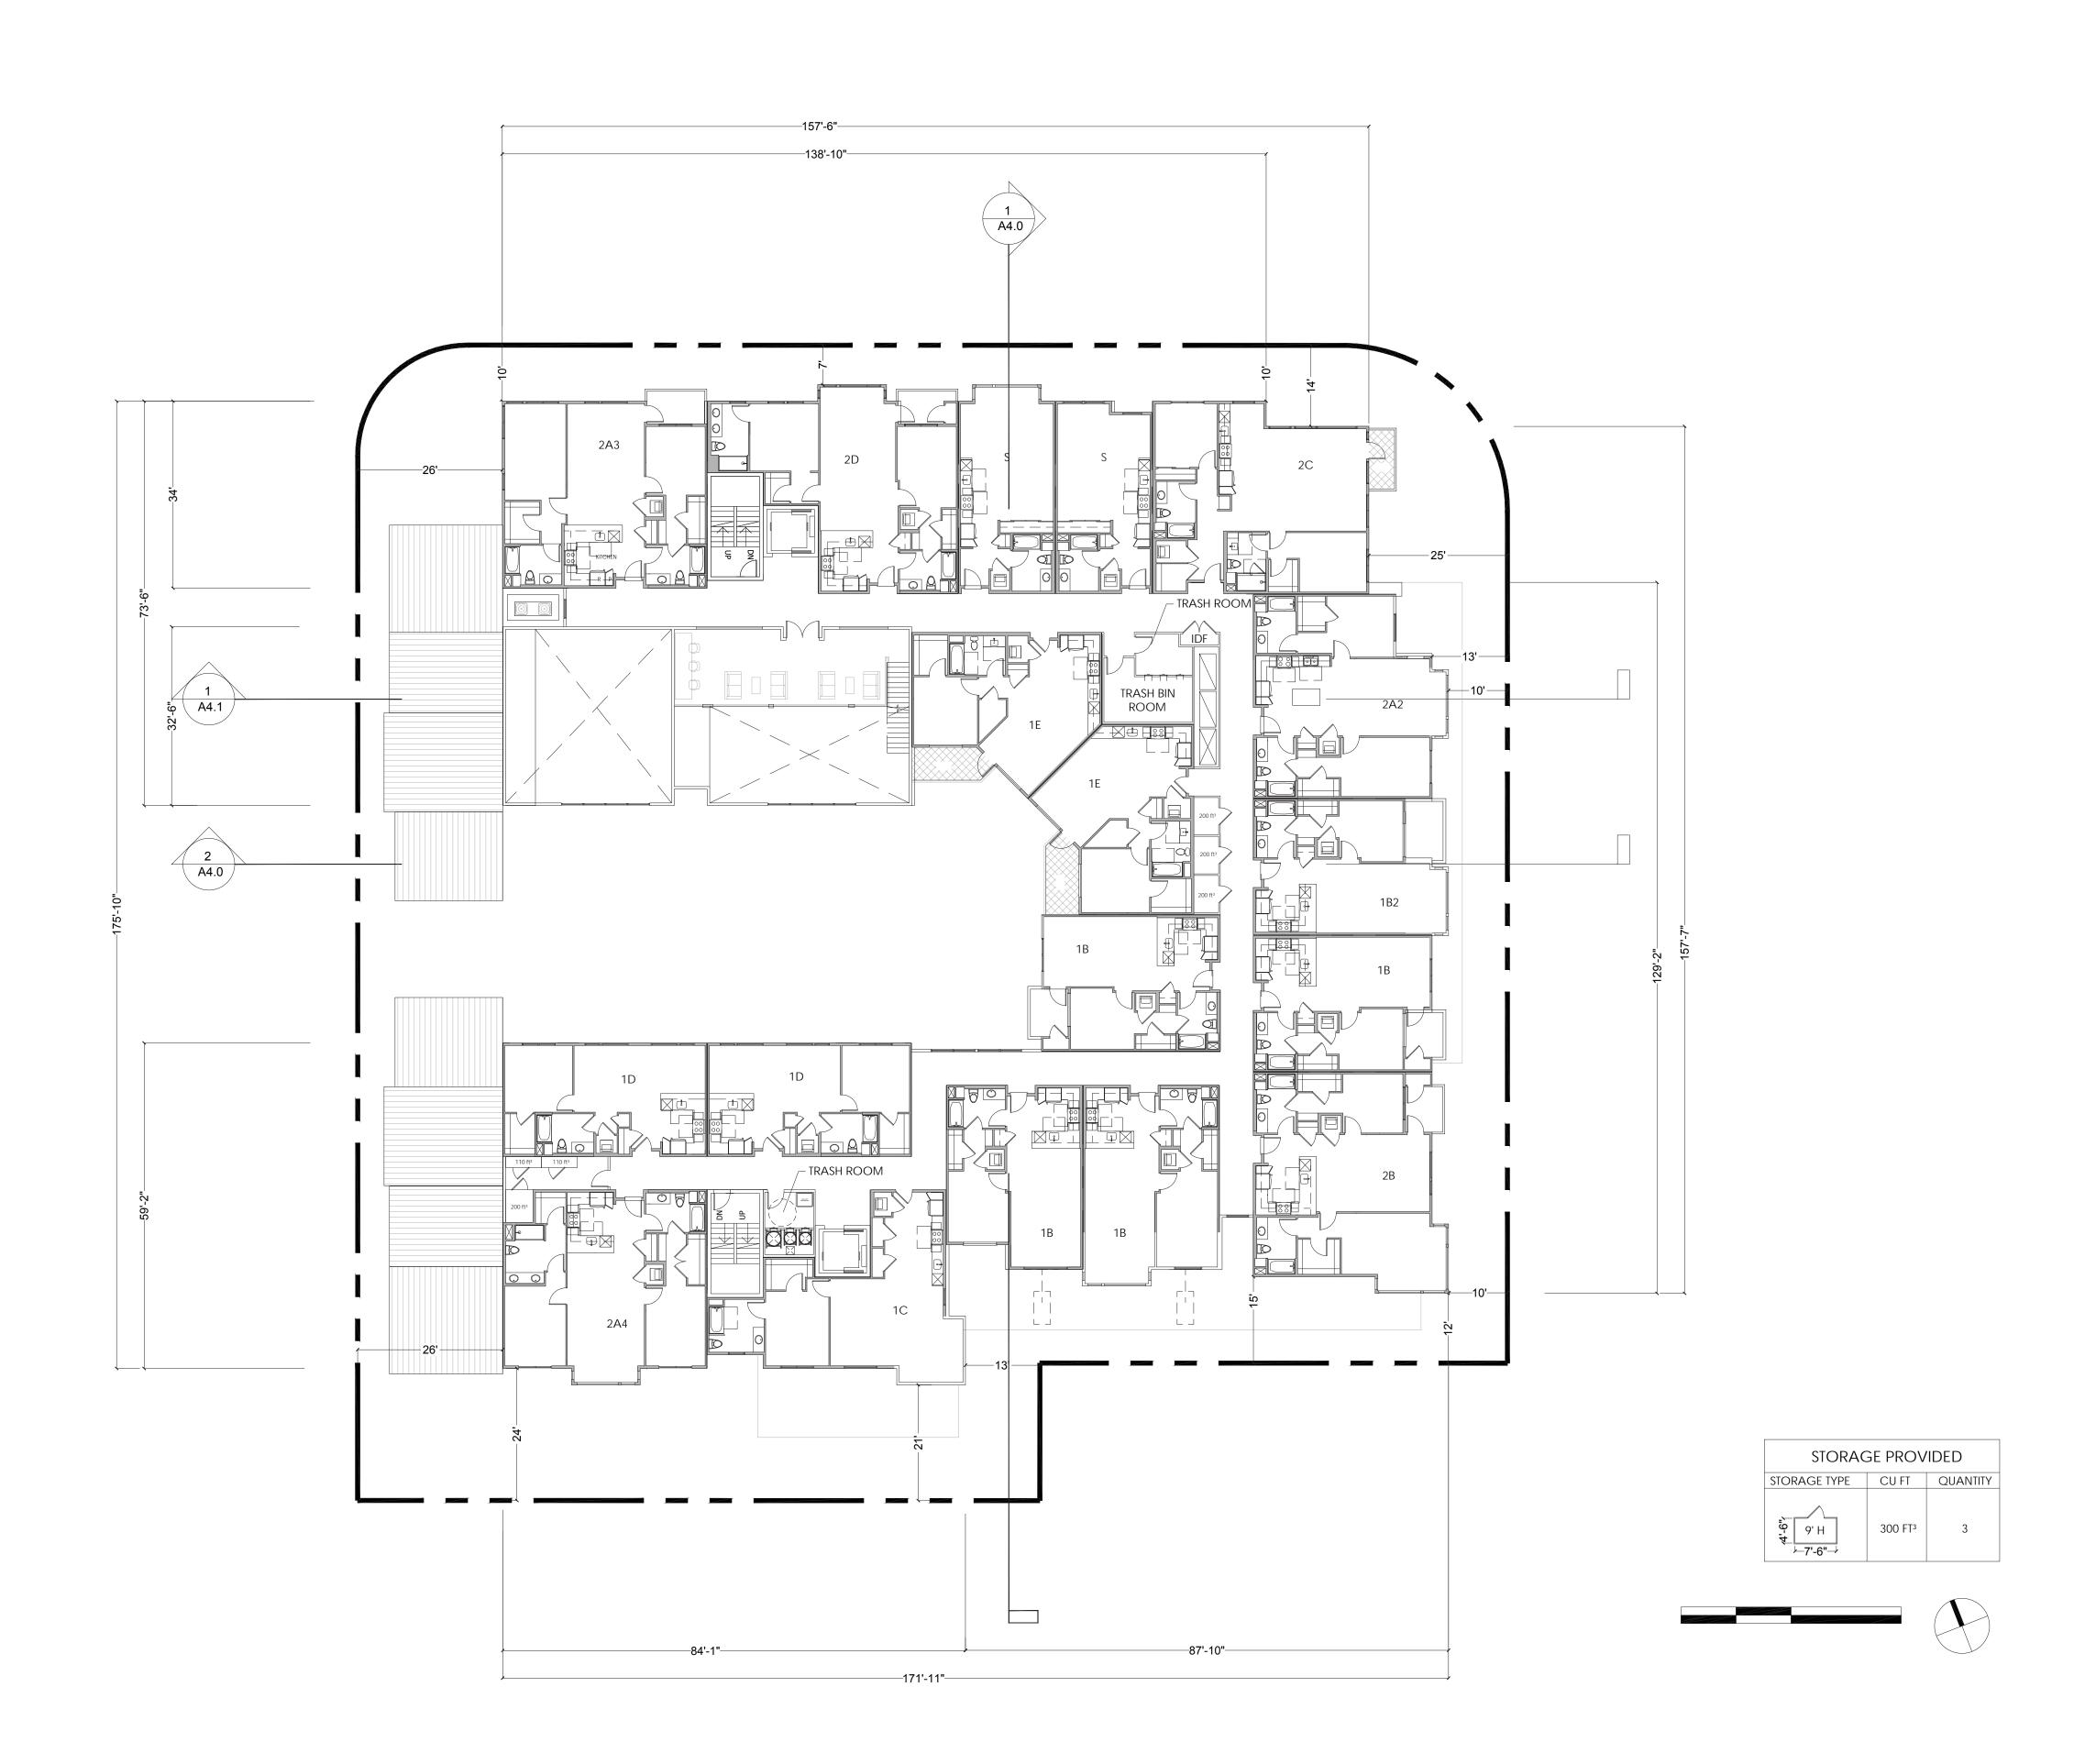
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S MATHILDA AVE ELEVATION

SCALE: 1/16" = 1' - 0"



S MATHILDA AVE PERSPECTIVE

SCALE: N.T.S.

## ATTACHMENT 6 PAGE 16 OF 48

1 STUCCO (SW7656 RHINESTONE) 2 STUCCO (SW7073 NETWORK GRAY) 3 STUCCO (SW7075 WEB GRAY) 4 STUCCO (SW6118 LEATHER BOUND) 5 SIDING (SW7633 TAUPE TONE) 6 SIDING (SW7705 WHEAT PENNY) 7 RAIN SCREEN (NICHIHA VINTAGE WOOD CEDAR) 8 METAL AWNING (BLACK) 9 METAL SEAMED ROOF 10 STOREFRONT (BLACK) 11 ALUMINUM WINDOW (BLACK) (SW7656 RHINESTONE)  3 STUCCO (SW7073 NETWORK GRAY)  4 STUCCO (SW7075 WEB GRAY)  4 STUCCO (SW6118 LEATHER BOUND)  5 SIDING (SW7705 WHEAT PENNY)  7 RAIN SCREEN (NICHIHA VINTAGE WOOD CEDAR)  4 STUCCO (SW7075 WEB GRAY)		
2 (SW7073 NETWORK GRAY)  3 STUCCO (SW7075 WEB GRAY)  4 STUCCO (SW6118 LEATHER BOUND)  5 SIDING (SW7633 TAUPE TONE)  6 SIDING (SW7705 WHEAT PENNY)  7 RAIN SCREEN (NICHIHA VINTAGE WOOD CEDAR)  8 METAL AWNING (BLACK)  9 METAL SEAMED ROOF  10 STOREFRONT (BLACK)  11 ALUMINUM WINDOW (BLACK)	1	
(SW7075 WEB GRAY)  STUCCO (SW6118 LEATHER BOUND)  SIDING (SW7633 TAUPE TONE)  SIDING (SW7705 WHEAT PENNY)  RAIN SCREEN (NICHIHA VINTAGE WOOD CEDAR)  METAL AWNING (BLACK)  METAL SEAMED ROOF  STOREFRONT (BLACK)  ALUMINUM WINDOW (BLACK)  VINYL WINDOW	2	
(SW6118 LEATHER BOUND)  SIDING (SW7633 TAUPE TONE)  SIDING (SW7705 WHEAT PENNY)  RAIN SCREEN (NICHIHA VINTAGE WOOD CEDAR)  METAL AWNING (BLACK)  METAL SEAMED ROOF  STOREFRONT (BLACK)  ALUMINUM WINDOW (BLACK)  VINYL WINDOW	3	
(SW7633 TAUPE TONE)  SIDING (SW7705 WHEAT PENNY)  RAIN SCREEN (NICHIHA VINTAGE WOOD CEDAR)  METAL AWNING (BLACK)  METAL SEAMED ROOF  STOREFRONT (BLACK)  ALUMINUM WINDOW (BLACK)	4	
6 (SW7705 WHEAT PENNY)  7 RAIN SCREEN (NICHIHA VINTAGE WOOD CEDAR)  8 METAL AWNING (BLACK)  9 METAL SEAMED ROOF  10 STOREFRONT (BLACK)  ALUMINUM WINDOW (BLACK)	5	
(NICHIHA VINTAGE WOOD CEDAR)  METAL AWNING (BLACK)  METAL SEAMED ROOF  STOREFRONT (BLACK)  ALUMINUM WINDOW (BLACK)  VINYL WINDOW	6	
8 (BLACK)  9 METAL SEAMED ROOF  10 STOREFRONT (BLACK)  ALUMINUM WINDOW (BLACK)	7	
STOREFRONT (BLACK)  ALUMINUM WINDOW (BLACK)  VINYL WINDOW	8	
(BLACK)  ALUMINUM WINDOW (BLACK)  VINYL WINDOW	9	METAL SEAMED ROOF
(BLACK)	10	
VINYL WINDOW	11)	
(BLACK)	12	
(13) GLASS RAILING	13	GLASS RAILING
14 PERFORATED METAL RAILING	14)	PERFORATED METAL RAILING



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Mathilda 3118

Sheet Title: BUILDING **ELEVATIONS AND** PERSPECTIVES

4/18/2018 AS NOTED

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A3.0



-LOBBY

EGRESS/

PUBLIC PLAZA

-LEASING-

-MATHILDA-

MCKINLEY AVE ELEVATION

-CHARLES-

SCALE: 1/16" = 1' - 0"



RESIDENTIAL

ACCESS

PARKING - EGRESS

\_TOWN\_ HOUSE

MCKINLEY AVE PERSPECTIVE

SCALE: N.T.S.

## ATTACHMENT 6 PAGE 17 OF 48

1	STUCCO (SW7656 RHINESTONE)
2	STUCCO (SW7073 NETWORK GRAY)
3	STUCCO (SW7075 WEB GRAY)
4	STUCCO (SW6118 LEATHER BOUND)
5	SIDING (SW7633 TAUPE TONE)
6	SIDING (SW7705 WHEAT PENNY)
7	RAIN SCREEN (NICHIHA VINTAGE WOOD CEDAR)
8	METAL AWNING (BLACK)
9	METAL SEAMED ROOF
10	STOREFRONT (BLACK)
11	ALUMINUM WINDOW (BLACK)
12	VINYL WINDOW (BLACK)
13	GLASS RAILING
14	PERFORATED METAL RAILING



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4/18/2018

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A3.1

Mathilda 311 S N TWO STORY TOWNHOUSE

-MCKINLEY-

-WELLS FARGO-

COURTYARD

**ABOVE** 

-TWO STORY TOWNHOUSE-

CHARLES ST ELEVATION

SERVICE

DRIVEWAY

SCALE: 1/16" = 1' - 0"

-SFH-



CHARLES ST PERSPECTIVE

SCALE: N.T.S.

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BUILDING
ELEVATIONS AND
PERSPECTIVES

lob No. 16044 Date: 4/18/2018 Scale: AS NOTED

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A3.2

Architecture Planning

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BUILDING
ELEVATIONS AND

No. 16044 : 4/18/2018 e: AS NOTED

**PERSPECTIVES** 

Scale: Drawn By:

31

Sheet No:

A3.3



SOUTH ELEVATION /

SCALE: 1/16" = 1' - 0"



CHARLES ST LOOKING NORTH PERSPECTIVE

SCALE: N.T.S.

RAIN SCREEN (NICHIHA VINTAGE WOOD CEDAR)

METAL AWNING (BLACK)

METAL SEAMED ROOF

STOREFRONT (BLACK)

ALUMINUM WINDOW (BLACK)

VINYL WINDOW (BLACK)

GLASS RAILING

14 PERFORATED METAL RAILING

STUCCO (SW7656 RHINESTONE)

(SW7075 WEB GRAY)

(SW7633 TAUPE TONE)

(SW7705 WHEAT PENNY)

(SW7073 NETWORK GRAY)

(SW6118 LEATHER BOUND)

STUCCO

STUCCO

STUCCO

SIDING

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Mathilda 311.8


Sheet Title: COLOR AND MATERIAL BOARD

4/18/2018 Date: Scale:

Sheet No:

Drawn By:

A3.4

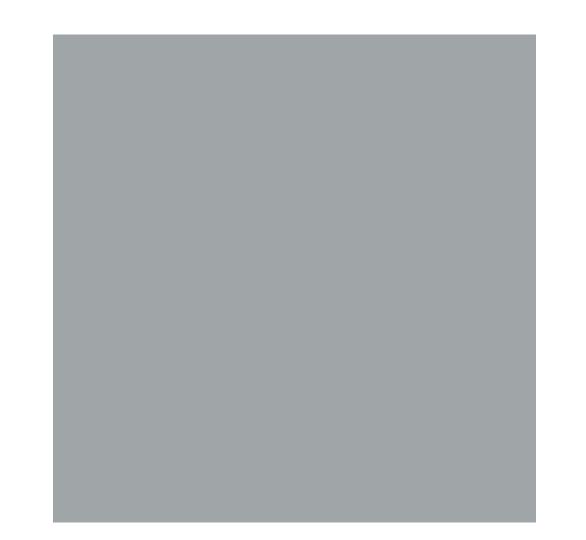





03 STUCCO (SW7075 WEB GRAY)




04) STUCCO (SW6118 LEATHER BOUND)




06 SIDING (SW7705 WHEAT PENNY)



07) RAIN SCREEN (NICHIHA VINTAGE WOOD CEDAR)

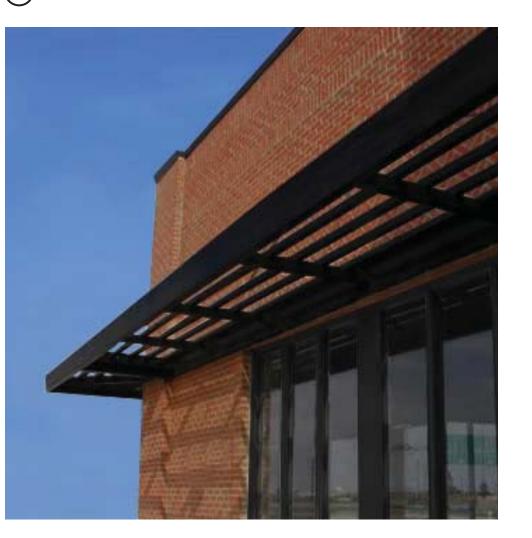

08 METAL AWNING (BLACK)

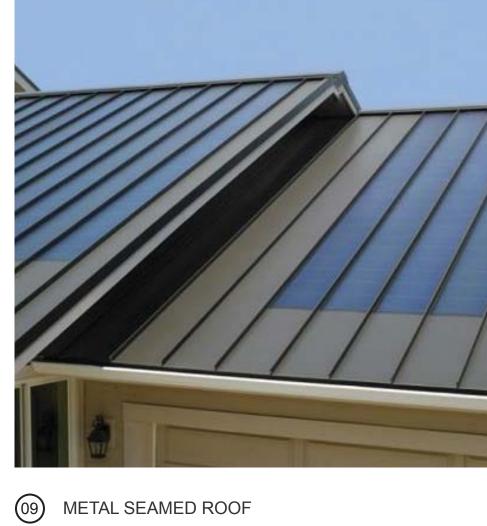




11) ALUMINUM WINDOW (BLACK)




12) VINYL WINDOW (BLACK)



(13) GLASS RAILING

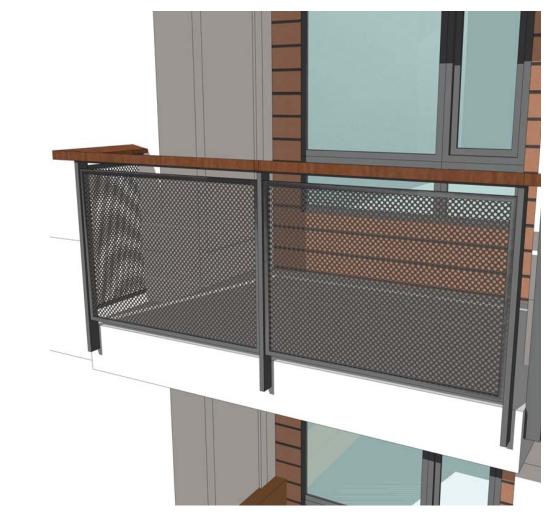

14) PERFORATED METAL RAILING

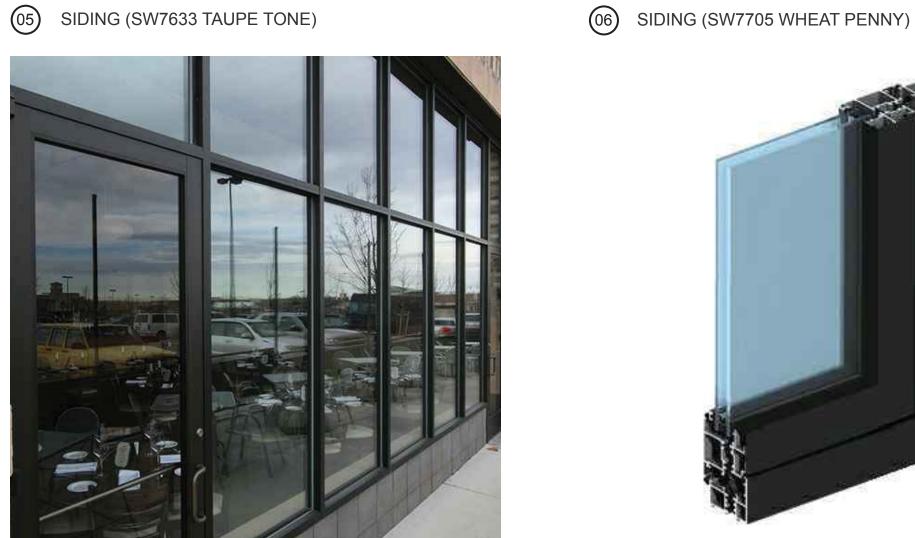

10 STOREFRONT (BLACK)



Architecture Planning

10' 20'

SECTION 2

SCALE: 1/16" = 1' - 0"

SCALE: 1/16" = 1' - 0"

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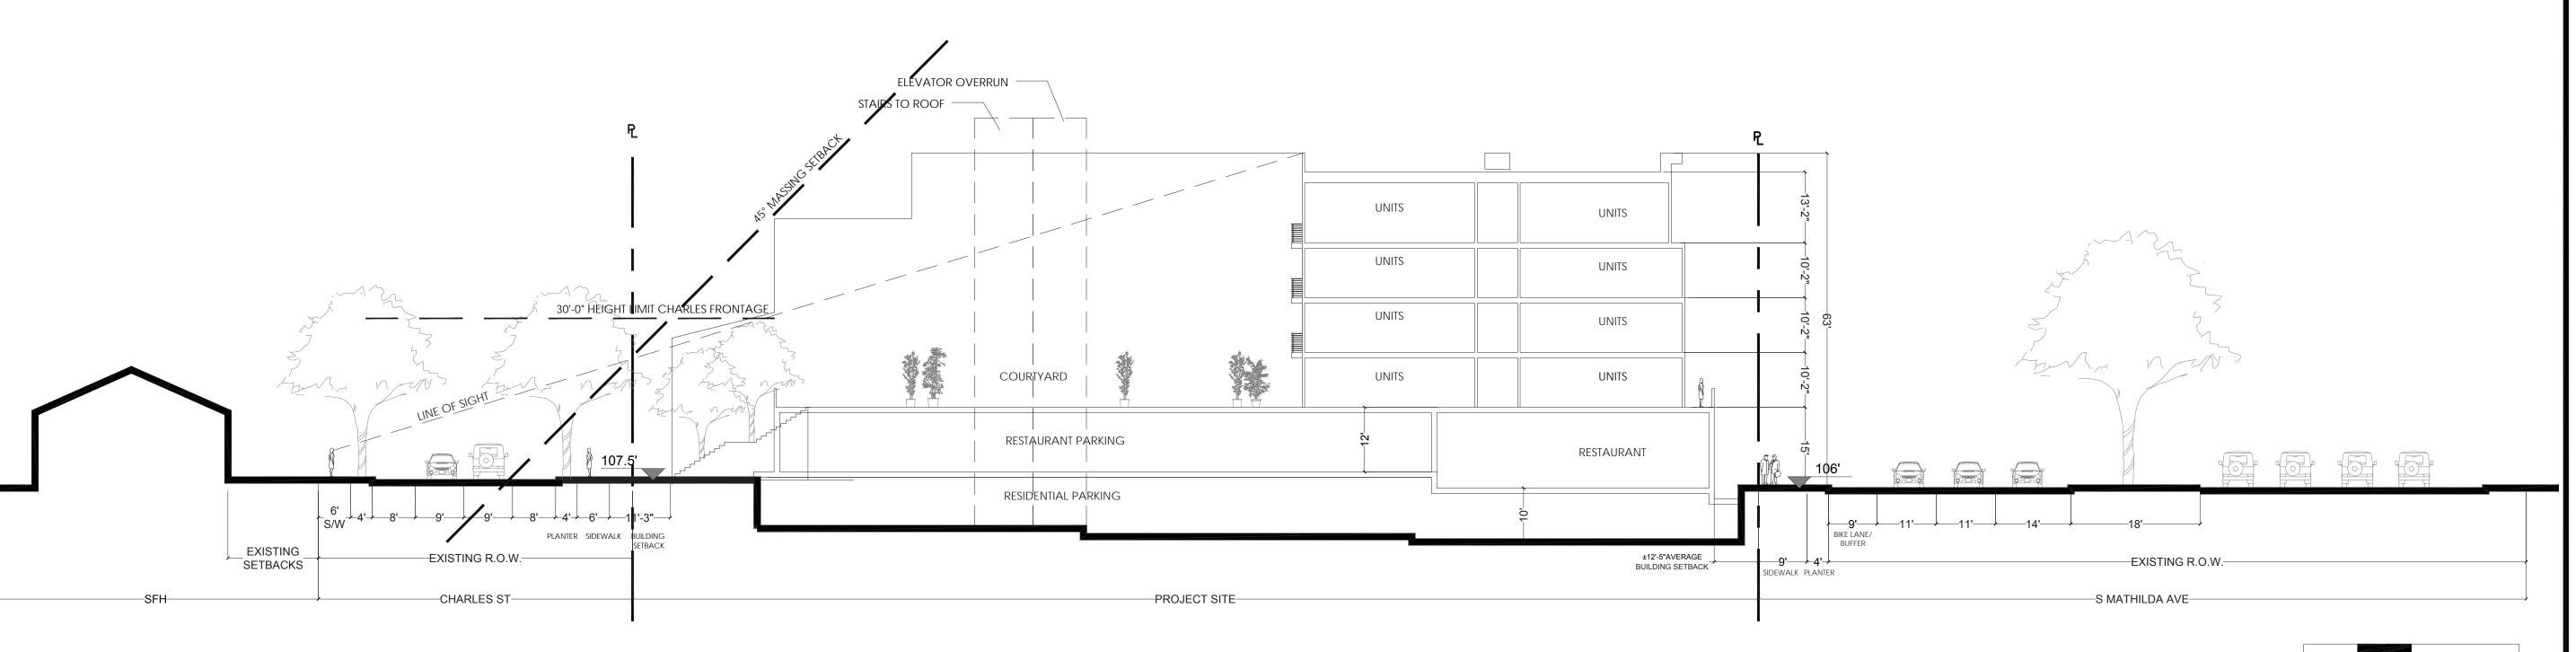
311 S Mathilda Ave, Sunny


Sheet Title: BUILDING SECTIONS

Job No. Date:

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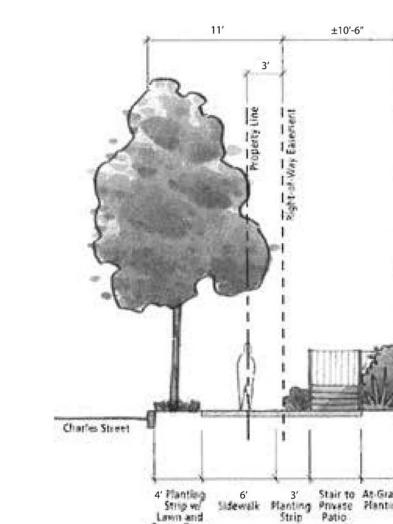
Sheet Title: BUILDING SECTIONS

311 S Mathilda Ave, Sunny

Job No. 4/18/2018 Date: AS NOTED

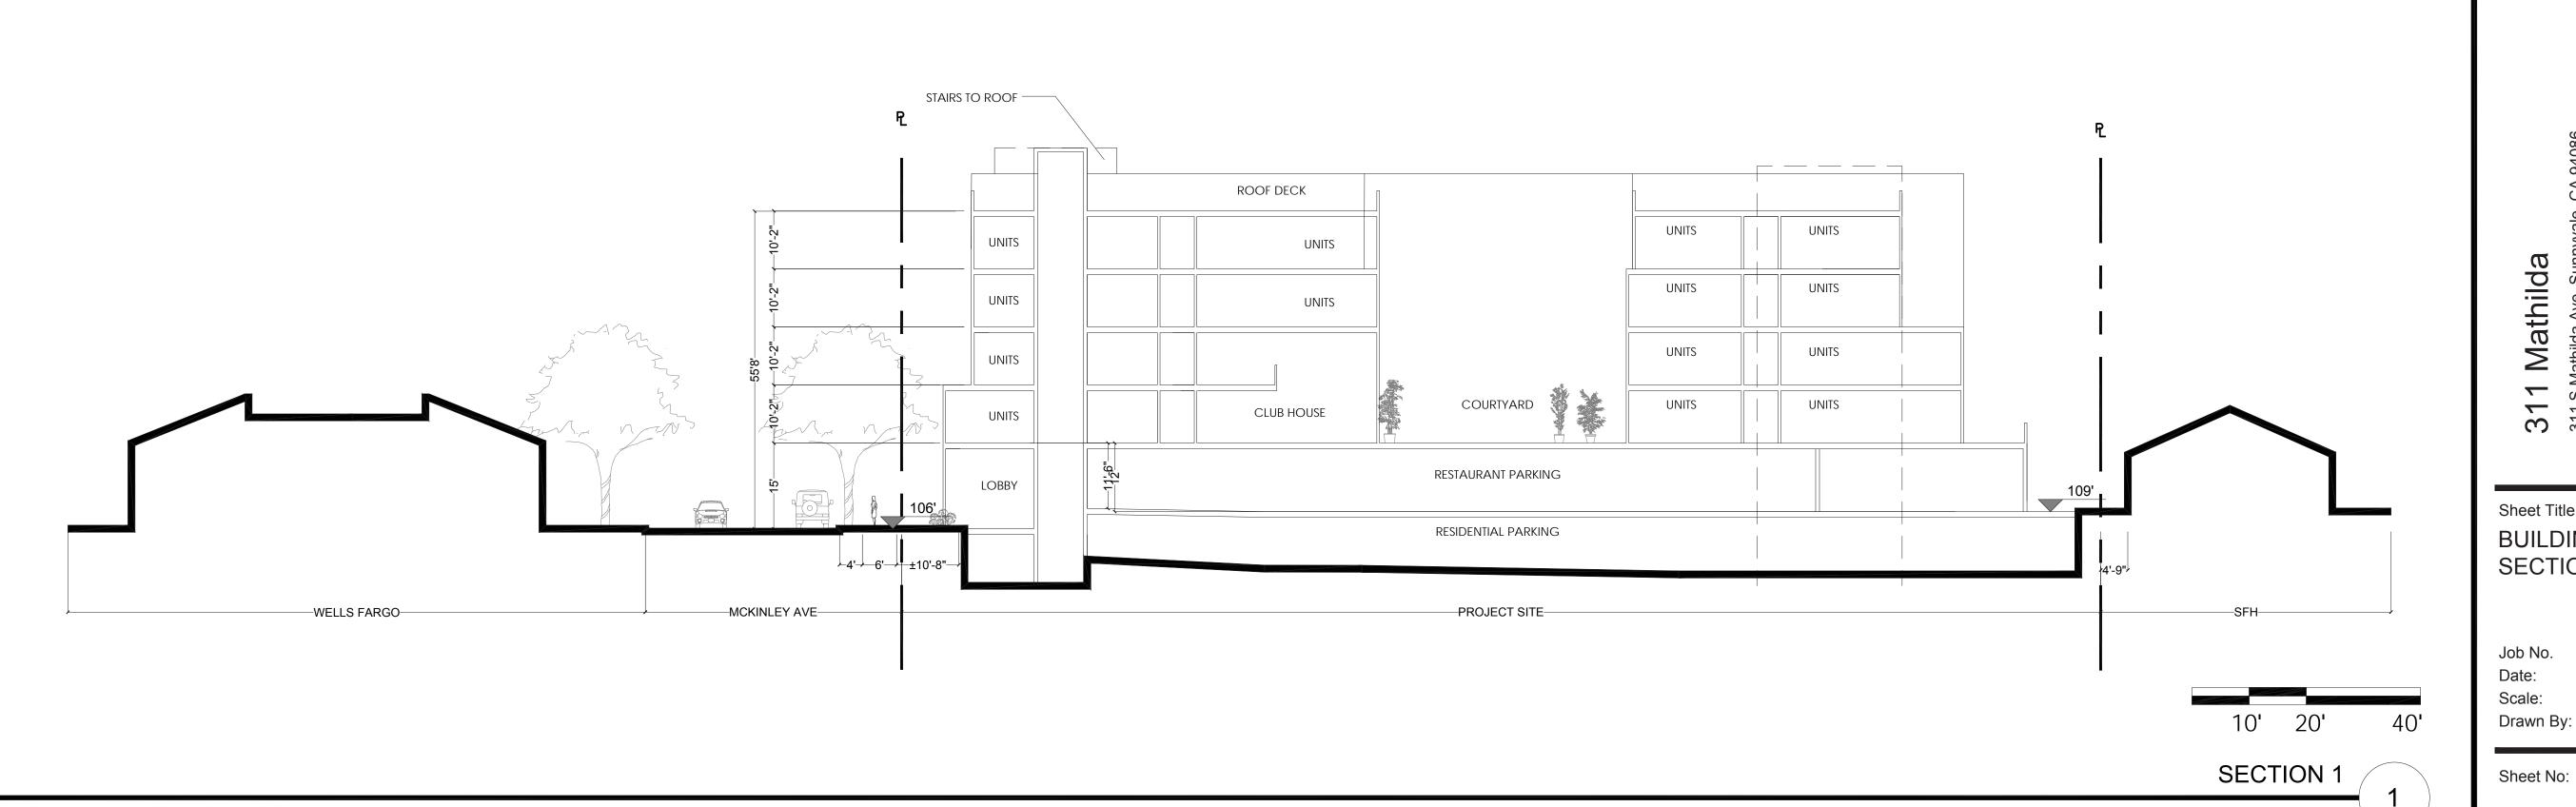Scale: Drawn By:

Sheet No:



481 MATHILDA PROPOSED CHARLES AVENUE SECTION

DTPP-CHARLES AVENUE SECTION

10' Setback

8' Parking 3' 5'

Existing 50' R.O.W.

N.T.S.


N.T.S.


DTPP-MATHILDA AVENUE SECTION

SEE A4.1/3 ELEVATOR OVERRUN **AMENITY** UNITS UNITS STORAGE UNITS SEE A4.1/2 STORAGE UNITS UNITS UNITS UNITS 30'-0" HEIGHT LIMIT CHARLES RONTAGE UNITS STORAGE UNITS **FITNESS** CLUB HOUSE STORAGE UNITS UNITS TOWN HOUSE RESTAURANT PARKING RESTAURANT RESIDENTIAL PARKING \_\_EXISTING \_\_ SETBACKS ±12'-5"AVERAGE BUILDING SETBACK -EXISTING R.O.W.----CHARLES ST-PROJECT SITE —S MATHILDA AVE—

SECTION 1


SCALE: 1/16" = 1' - 0"

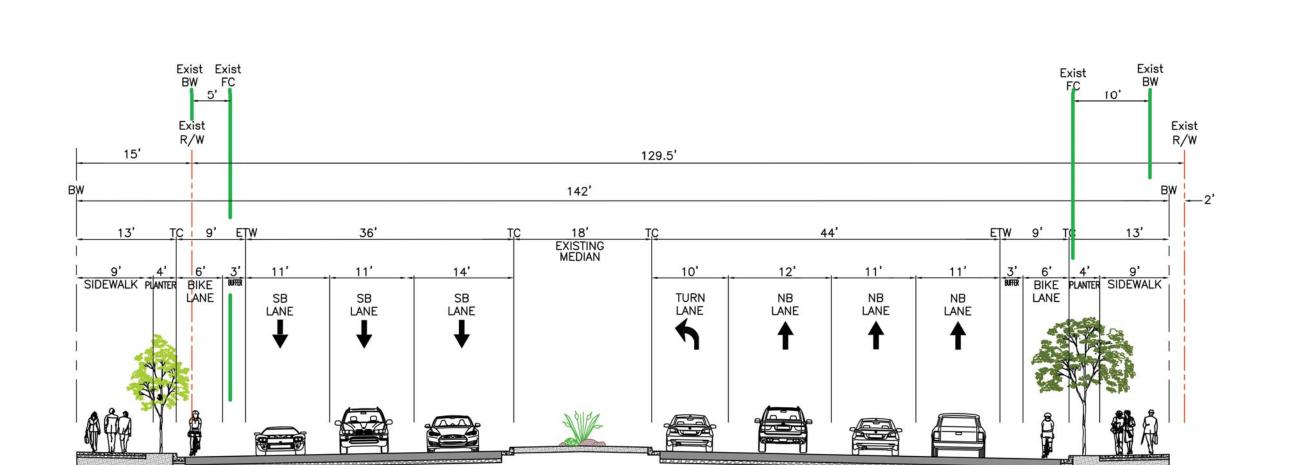


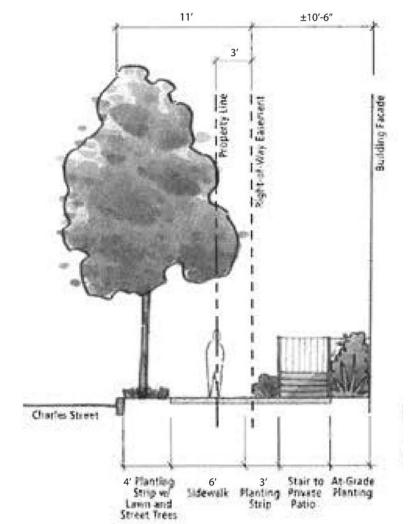

4' Planting 6' 3' Stair to At-Grade Strip wi Sidewelk Planting Private Planting Lawn and Street Trees



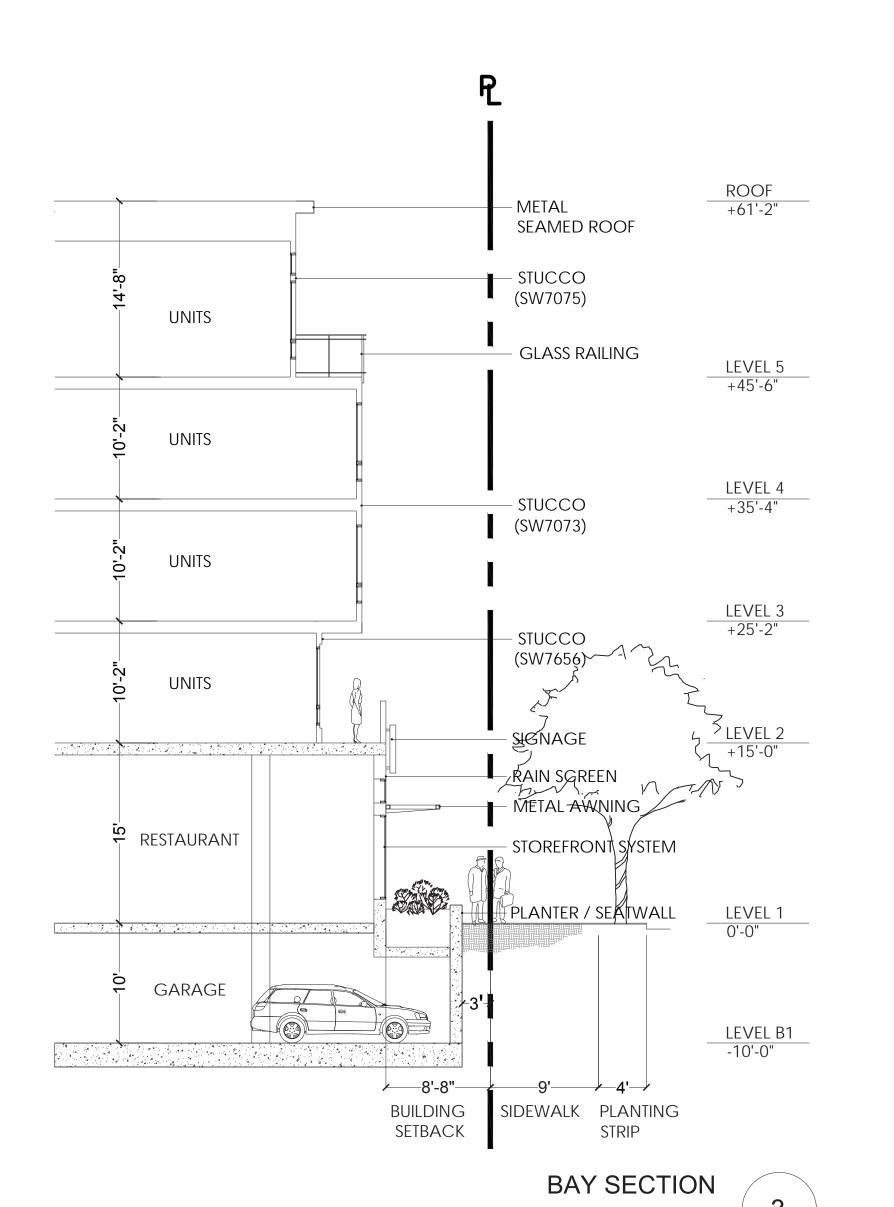

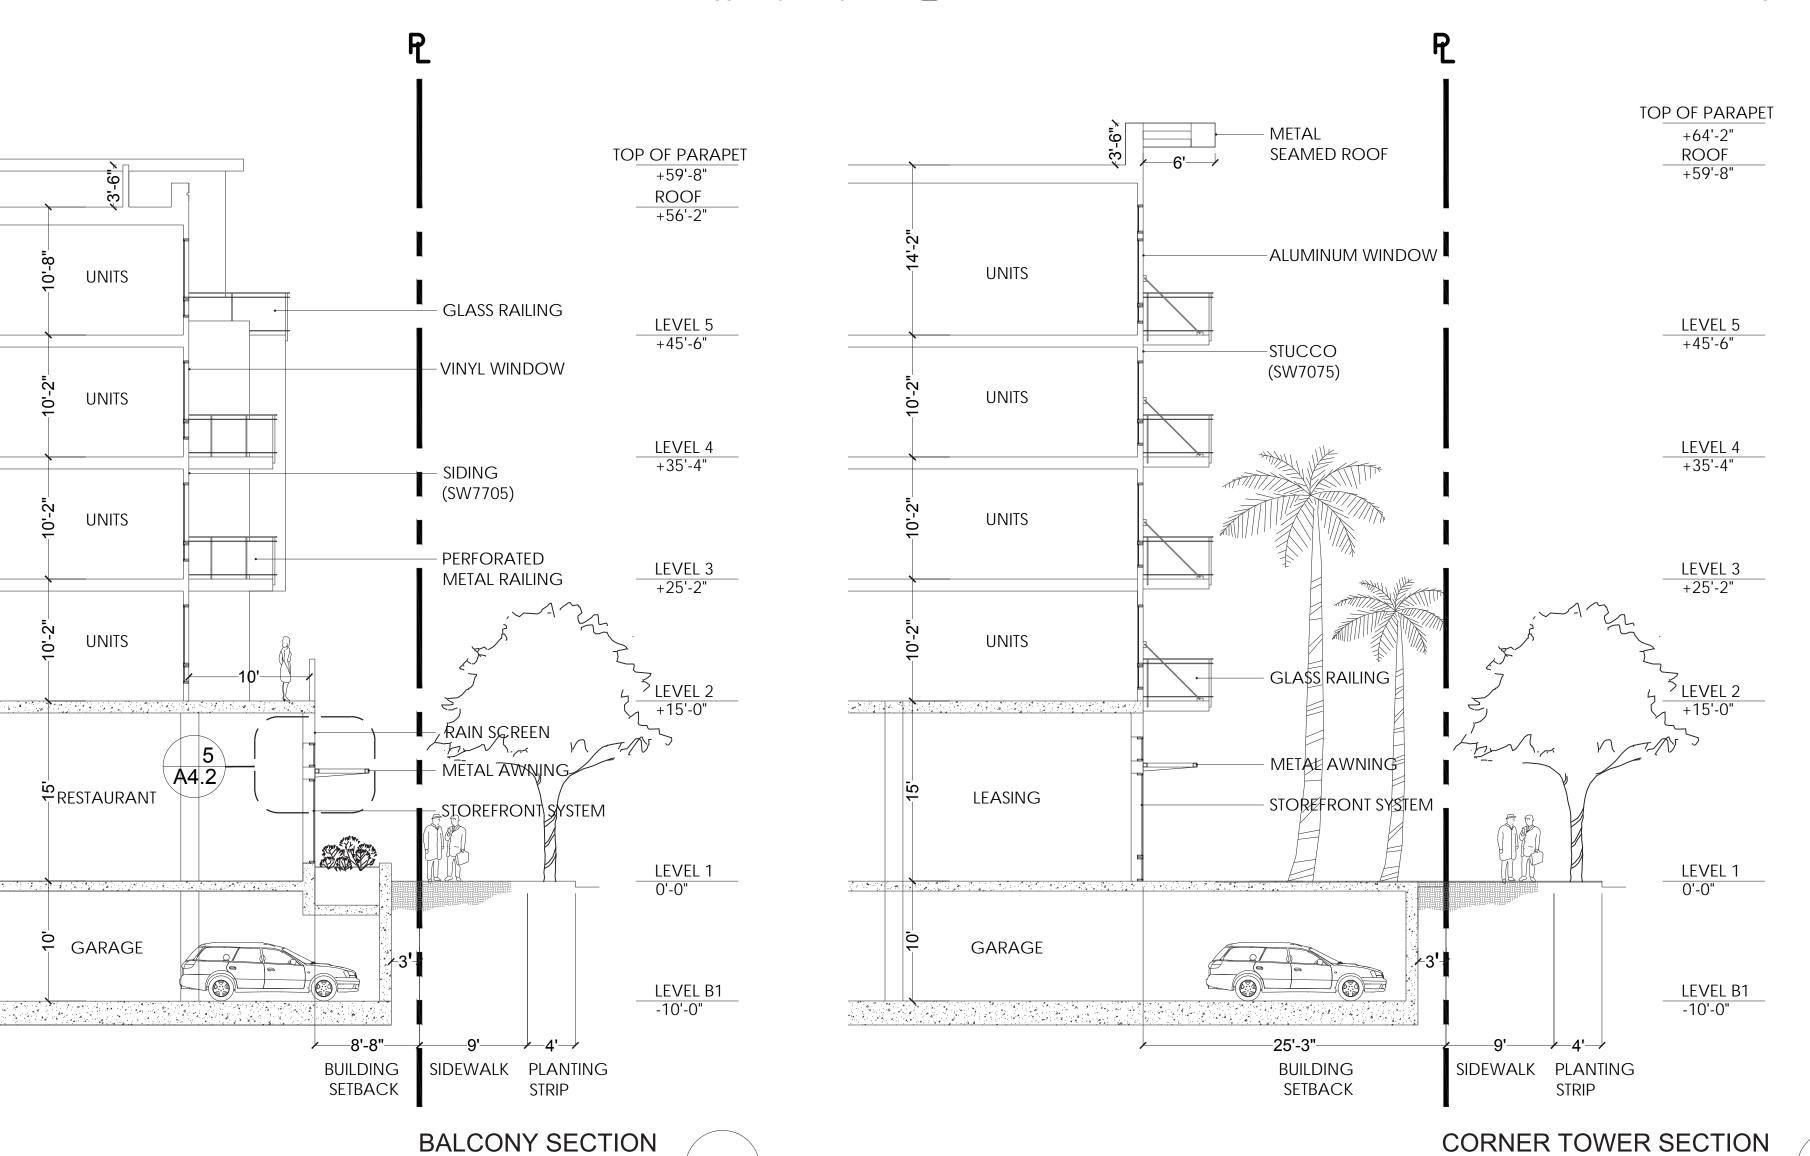

SQUARE

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2nd Floo

Mathilda 3118

Sheet Title: SCHEMATIC DETAIL

Job No. Date: Scale:

4/18/2018 AS NOTED Drawn By:

16044

Sheet No:

A4.2

SCALE: 1/8" = 1' - 0"



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2nd Floo

Suite 1 Partners on ners: 644 Menlo Avers 1725 S. Bascom A.

Mathilda 3118

Sheet Title: SCHEMATIC DETAIL

Job No. 16044 Date: Scale:

4/18/2018 AS NOTED Drawn By:

Sheet No:

A4.3



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Lane Partners: 644 Menlo Ave Bay West: 1725 S. Bascom Av

Mathilda 311 S M


Sheet Title: **UNIT PLANS** 


16044 Job No. 4/18/2018 Date: 1/4 = 1 - 0Scale:


Drawn By:

Sheet No:

A5.0

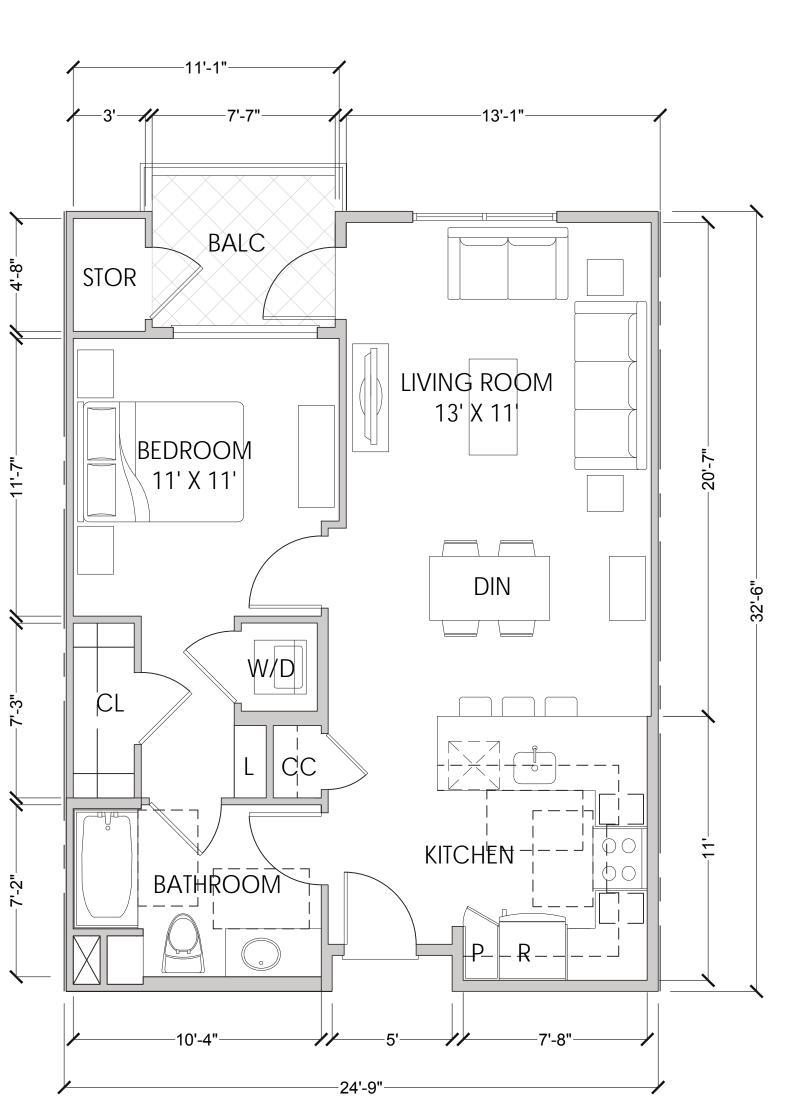

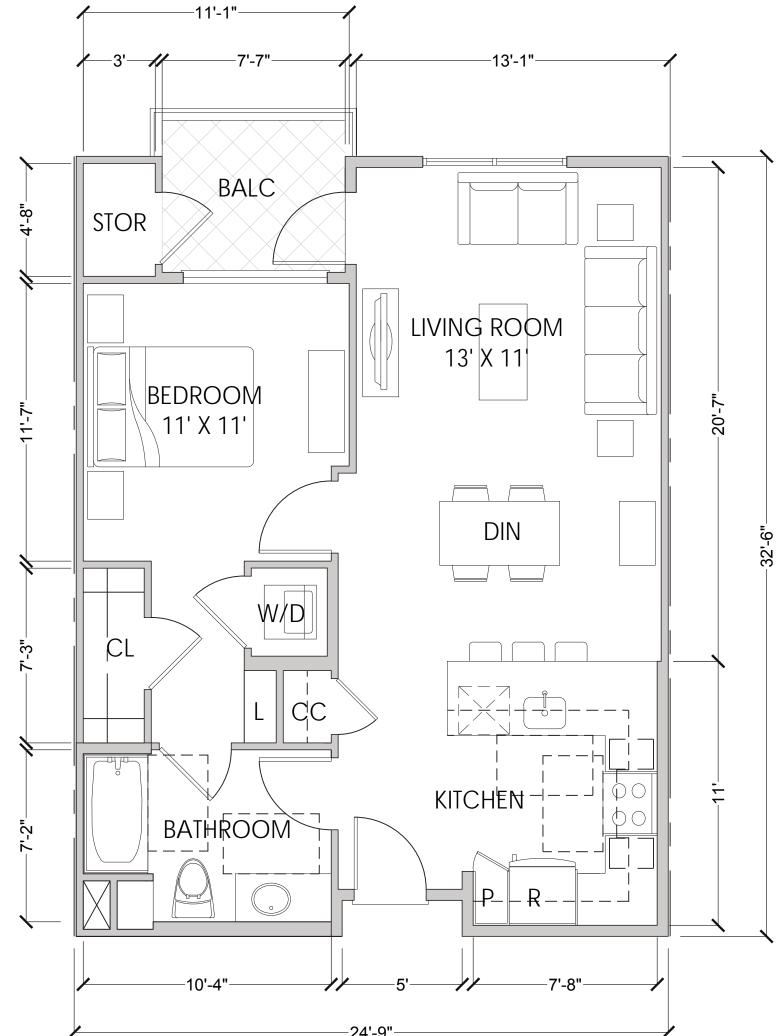

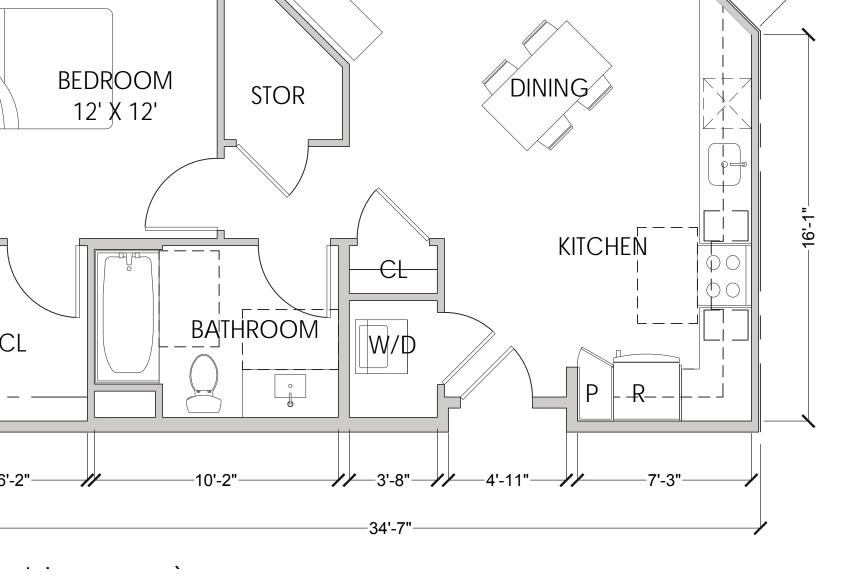

LIVING 11'-1" x 13'

× BALC



UNIT 1B - 1BR + 1BA (705-848 SF) SCALE: 1/4" = 1' - 0"

UNIT S - STUDIO (560-633 SF) SCALE: 1/4" = 1' - 0"

W/D

-17'-5<u>1</u>"-

SLIDING DOORS & WALLS OPTIONAL

BATHROOM

UDN N ND P ND



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Sheet Title: **UNIT PLANS** 


16044 Job No. 4/18/2018 Date: 1/4 = 1 - 0 Scale:


Drawn By:

Sheet No:

A5.1

N ND P

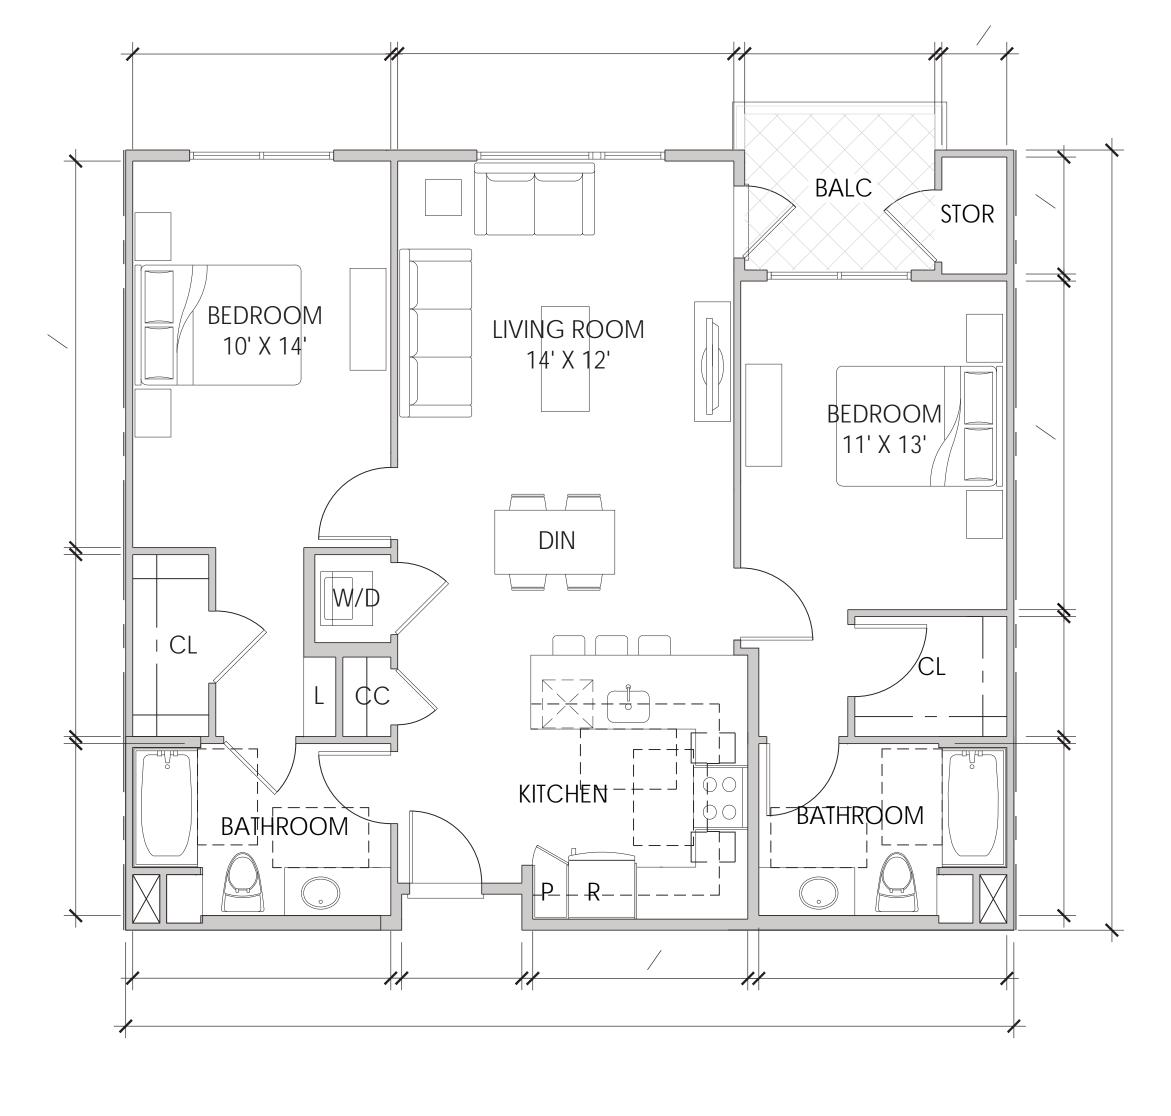

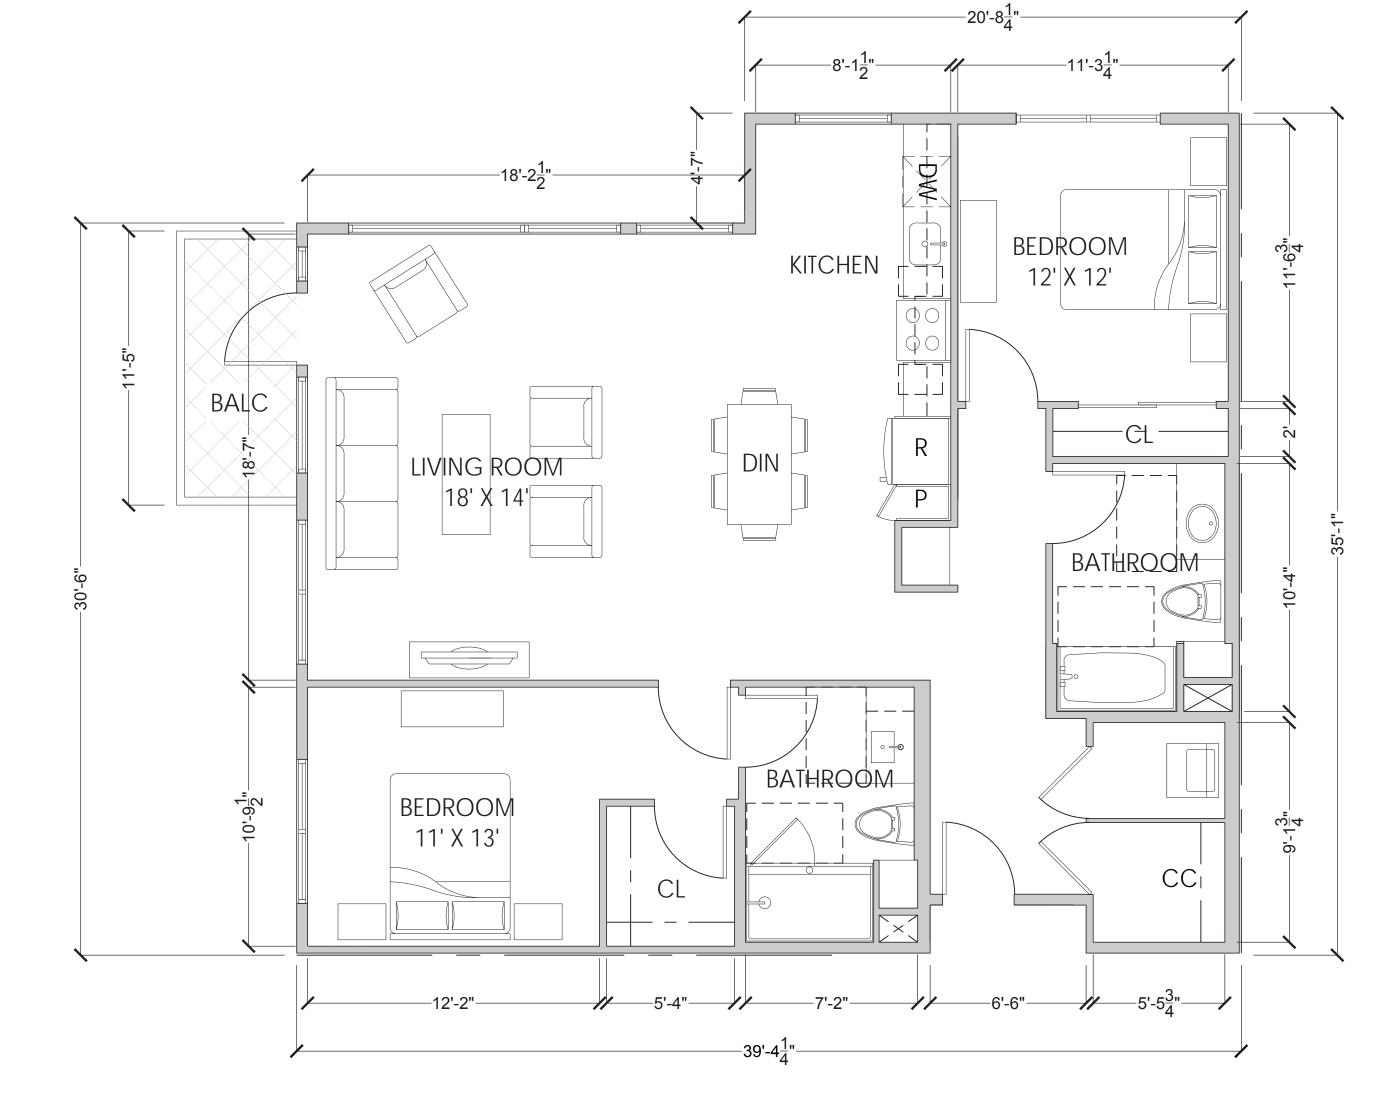

UNIT 2C - 2BR + 2BA (1270 SF)

SCALE: 1/4" = 1' - 0"

UNIT 2A - 2BR + 2BA (1120-1190 SF)

UDN

SCALE: 1/4" = 1' - 0"



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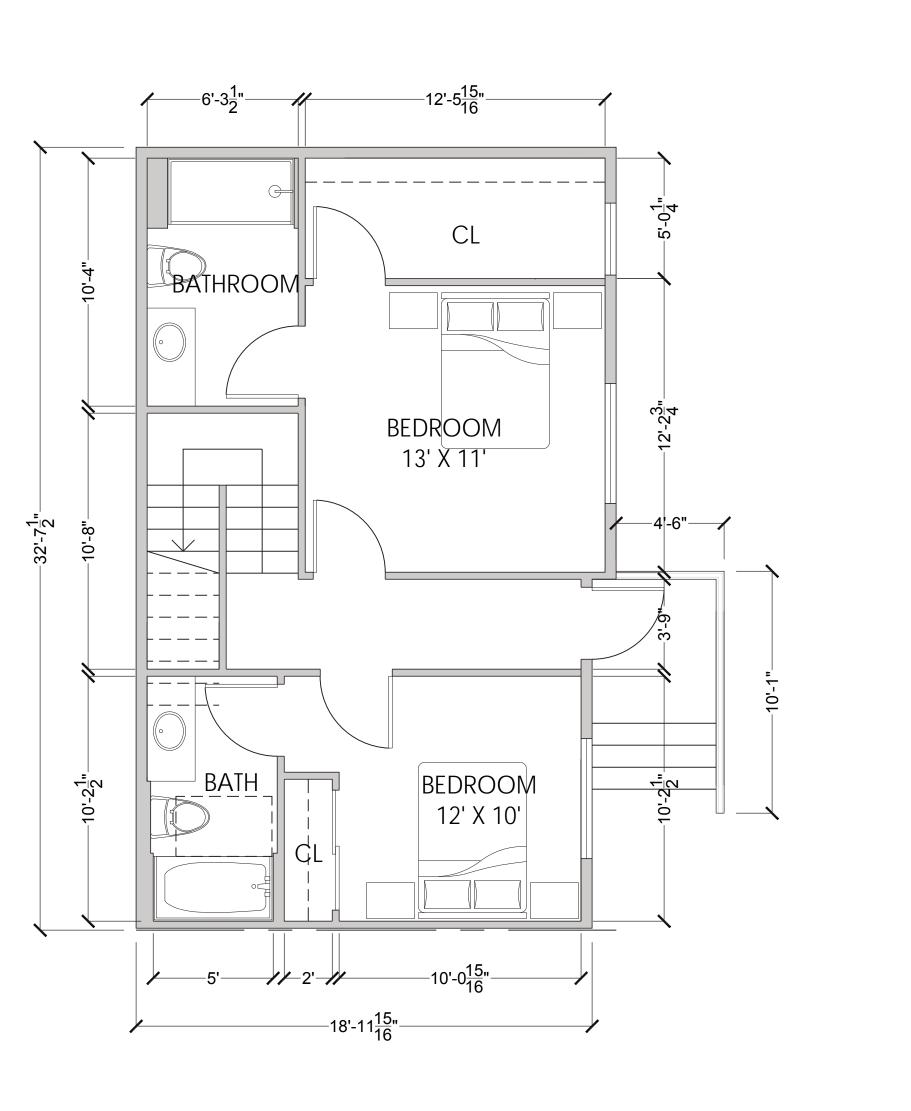
Sheet Title: UNIT PLANS


16044 Job No. 4/18/2018 Date: 1/4 = 1 - 0 Scale:

Drawn By:

Sheet No:

A5.2



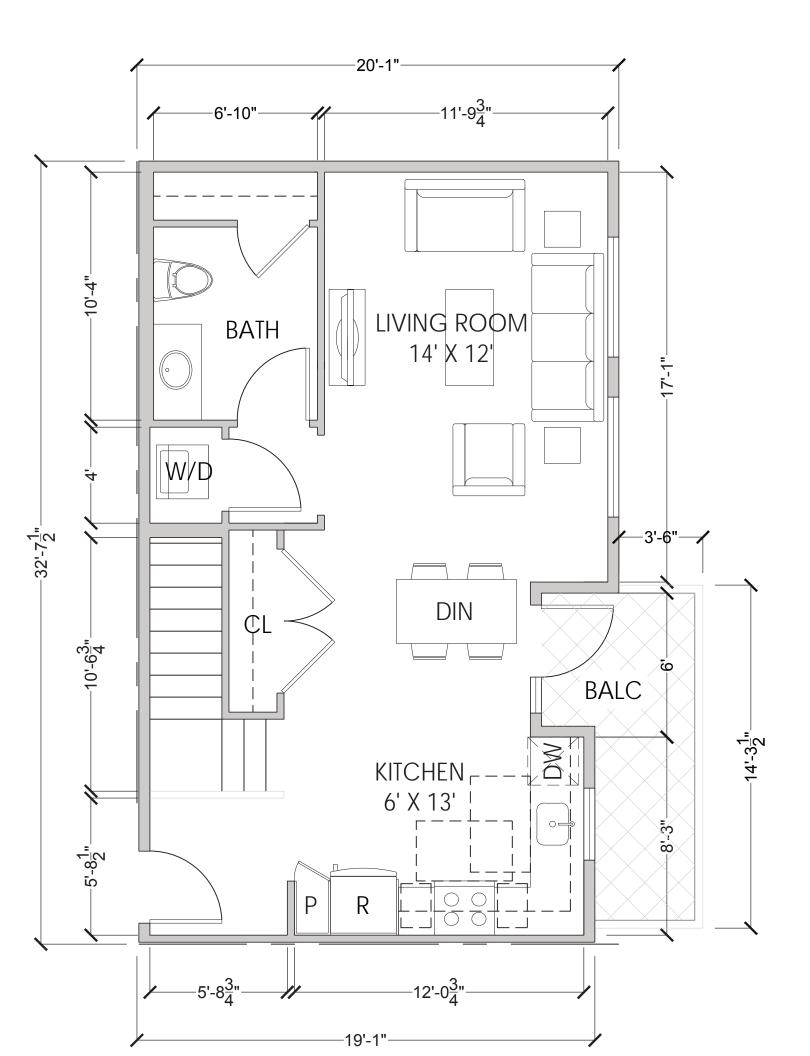

UPP

UNIT TH - 2BR + 2.5BA (1248 SF)

SCALE: 1/4" = 1' - 0"

UDN

N ND P ND

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**D**, 2nd ... Su

Partners ners: 644 Menlo Av : 1725 S. Bascom A

Lane Partne Bay West:

Mathilda ~ S **—** 311

Sheet Title: **GREENPOINT** RATED CHECK LIST

16044 Job No. 4/18/2018 Date:

Scale: Drawn By:

Sheet No:

		Points Achieved	Community	rgy	AQ/Health	Resources	je.	
Yes	C14. Large Stature Tree(s)			Energy	ΔĀ	Res	Water	
TBD	C15. Third Party Landscape Program Certification	1	1				1	
Yes	C16. Maintenance Contract with Certified Professional	1					1	
TBD	C17. Community Garden		2				<u> </u>	
. STRUCTURAL FRA	AME AND BUILDING ENVELOPE		_					
	D1. Optimal Value Engineering							
No	D1.1 Joists, Rafters, and Studs at 24 Inches on Center	0		1		2		
Yes	D1.2 Non-Load Bearing Door and Window Headers Si ed for Load	1				1		
No	D1.3 Advanced Framing Measures	0				2		
TBD	D2. Construction Material Efficiencies					1		
	D3. Engineered Lumber							
TBD	D3.1 Engineered Beams and Headers					1		
Yes	D3.2 Wood I-Joists or Web Trusses for Floors	1				1		
Yes	D3.3 Engineered Lumber for Roof Rafters	1				1		
No	D3.4 Engineered or Finger-Jointed Studs for Vertical Applications	0				1		
TBD	D3.5 OSB for Subfloor					0.5		
TBD	D3.6 OSB for Wall and Roof Sheathing					0.5		
No	D4. Insulated Headers D5. FSC-Certified Wood	0		1				
No	D5.1 Dimensional Lumber, Studs, and Timber	0				6		
No	D5.2 Panel Products	0				3		
110	D6. Solid Wall Systems	0				3		
TBD	D6.1 At Least 90 of Floors					1		
TBD	D6.2 At Least 90 of Exterior Walls			1		1		
TBD	D6.3 At Least 90 of Roofs			1		1		
Yes	D7. Energy Heels on Roof Trusses	1		1				
TBD	D8. Overhangs and Gutters			1		1		
	D9. Reduced Pollution Entering the Home from the Garage							
No	D9.1 Detached Garage	0			2			
No	D9.2 Mitigation Strategies for Attached Garage	0			1			
	D10. Structural Pest and Rot Controls							
Yes	D10.1 All Wood Located At Least 12 Inches Above the Soil	1				1		
No	D10.2 Wood Framing Treating With Borates or Factory-Impregnated, or Wall  Materials Other Than Wood	0				1		
Yes	D11. Moisture-Resistant Materials in Wet Areas (such as Kitchen, Bathrooms, Utility							
	Rooms, and Basements)	2			1	1		
. EXTERIOR TBD	E4 Environmentally Professible Deaking						Г	
Yes	E1. Environmentally Preferable Decking E2. Flashing Installation Third-Party Verified	_				1		
TBD	E3. Rain Screen Wall System	2				2		
Yes	E4. Durable and Non-Combustible Cladding Materials	1				1		
	E5. Durable Roofing Materials	'				'		
Yes	E5.1 Durable and Fire Resistant Roofing Materials or Assembly	1				1		
Yes	E5.2 Roofing Warranty for Shingle Roofing	Y	R	R	R	R	R	
TBD	E6. Vegetated Roof		2	2	Ė	Ė	Ė	
. INSULATION								
	F1. Insulation with 30% Post-Consumer or 60% Post-Industrial Recycled Content							
TBD	F1.1 Walls and Floors					1		
TBD	F1.2 Ceilings					1		
	F2. Insulation that Meets the CDPH Standard Method—Residential for Low Emissions							
Yes	F2.1 Walls and Floors	1			1			
Yes	F2.2 Ceilings	1			1			
	F3. Insulation That Does Not Contain Fire Retardants		_					
TBD	F3.1 Cavity Walls and Floors				1			
TBD	F3.2 Ceilings				1			
TBD	F3.3 Interior and Exterior Insulation				1			
. PLUMBING	G1. Efficient Distribution of Domestic Hot Water							
TBD	G1.1 Insulated Hot Water Pipes			4				
TBD	G1.2 WaterSense Volume Limit for Hot Water Distribution			1			1	
TBD	G1.3 Increased Efficiency in Hot Water Distribution						2	
			_					

		Points Achieved	Community	Energy	IAQ/Health	Resources	Water	
Yes	N5.3 Porches Oriented to Street and Public Space	1	1	ш		~	>	
	N6. Passive Solar Design							
No	N6.1 Heating Load	0		2				
No	N6.2 Cooling Load	0		2				
	N7. Adaptable Building							
No	N7.1 Universal Design Principles in Units	0	1		1			
No	N7.2 Full-Function Independent Rental Unit	0	1					
	N8. Affordability							
≥25	N8.1 Dedicated Units for Households Making 80 of AMI or Less	1	2					
Yes	N8.2 Units with Multiple Bedrooms for Households Making 80 of AMI or Less	1	1					
TBD	N8.3 At Least 20 of Units at 120 AMI or Less are For Sale		1					
No	N9. Mixed-Use Developments  N9.1 Live/Work Units Include a Dedicated Commercial Entrance		-					
No Yes	N9.1 Live/work Units include a Decicated Commercial Entrance  N9.2 At Least 2 of Development Floor Space Supports Mixed Use	0	1				-	
No	N9.3 Half of the Non-Residential Floor Space is Dedicated to Community Service	1	1					
	N8. Resiliency	0	1					
TBD	N8.1 Climate Impact Assessment		1		1	1		
TBD	N8.2 Strategies to Address Assessment Findings		1		1	1		
	N9. Social Equity		Ė		-	<u> </u>		
TBD	N9.1 Diverse Workforce		1			1		
TBD	N9.2 Community Location		1		1			
R								
Yes	O1. GreenPoint Rated Checklist in Blueprints	Y	R	R	R	R	R	
Yes	O2. Pre-Construction Kickoff Meeting with Rater and Subcontractors	2		0.5		1	0.5	
TBD	O3. Orientation and Training to Occupants—Conduct Educational Walkthroughs			0.5	0.5	0.5	0.5	
TBD	O4. Builder's or Developer's Management Staff are Certified Green Building Professionals			0.5				
	O5. Home System Monitors			0.5	0.5	0.5	0.5	
TBD	O5.1 Energy Home System Monitors			1				
TBD	O5.2. Water Home System Monitors			· ·			1	
	O6. Green Building Education							
TBD	O6.1 Marketing Green Building		2					
TBD	O6.2 Green Building Signage			0.5			0.5	
TBD	O7. Green Appraisal Addendum		R	R	R	R	R	
No	O8. Detailed Durability Plan and Third-Party Verification of Plan Implementation	0				1		
TBD	O9. Residents Are Offered Free or Discounted Transit Passes		2					
TBD	O10. Vandalism Deterrence Practices and Vandalism Management Plan					1		
Yes	O11. Smokefree Buildings	2			2			
Yes	O12. Integrated Pest Management Plan	1				1		
N CONSIDER								
	P1. Acoustics: Noise and Vibration Control		1		1			
	Enter the number of Tier 1 practices							
	Enter the number of Tier 2 practices  P2. Mixed-Use Design Strategies	-						
Yes	P2.1 Tenant Improvement Re uirements for Build-Outs	2			1		1	+
Yes	P2.2 Commercial Loading Area Separated for Residential Area	1			1		<u> </u>	-
Yes	P2.3 Separate Mechanical and Plumbing Systems	1			1			
	P3. Commissioning				-			
TBD	P3.1 Design Phase			1	1			
TBD	P3.2 Construction Phase			2	1			
TBD	P3.3 Post-Construction Phase			2	1			
TBD	P4. Building Enclosure Testing			1	1	1		
	Summary							
	- Carrinar y							
	Total Available Points in Specific Categorie	s 404	46	141	69	94	54	

Directions for Use: Column A is a dropdown menu with the options of "Yes", "No", or "TBD" or a range of percentages to allocate points. Select the appropriate dropdown and the appropriate points will appear in the blue "points achieved" column.  The criteria for the green building practices listed below are described in the GreenPoint Rated New Home Rating Manual. For more information please visit www.builditgreen.org/greenpointrated					POINTS REQUIRED  #Minimum Point  Targeted Point  Targeted Point  Targeted Point  Targeted Point  Point  Targeted Point  Target			
ild It Green is not	a code enforcement agency.		2	25				
ome is only GreenPo w Home Multifan	int Rated if all features are verified by a Certified GreenPoint Rater through Build It Green.	2			6	6	6	
		Points Achieved	Community	Energy	IAQ/Health	Resources	Water	
	Measures			Pos	sible P	oints		Notes
LGreen	CAL Casas Pag (RECURED)							
Yes	CALGreen Res (REQUIRED)	4		1	1	1	1	
TBD	A1. Construction Footprint					1		
100	A2. Job Site Construction Waste Diversion					'		
Yes	A2.1 75 C&D Waste Diversion (Including Alternative Daily Cover)	2				2		
TBD	A2.2 65 C&D Waste Diversion (Excluding Alternative Daily Cover)					2		
TBD	A2.3 Recycling Rates from Third-Party Verified Mixed-Use Waste Facility					1		
TBD	A3. Recycled Content Base Material					1		
TBD	A4. Heat Island Effect Reduction (Non-Roof)			1		Ė		
Yes	A5. Construction Environmental Quality Management Plan Including Flush-Out	1			1			
	A6. Stormwater Control: Prescriptive Path							
TBD	A6.1 Permeable Paving Material						1	
Yes	A6.2 Filtration and/or Bio-Retention Features	1					1	
TBD	A6.3 Non-Leaching Roofing Materials						1	
TBD	A6.4 Smart Stormwater Street Design		1					
TBD	A7. Stormwater Control: Performance Path						3	
FOUNDATION								
TBD	B1. Fly Ash and/or Slag in Concrete					1		
Yes	B2. Radon-Resistant Construction	2			2			
TBD	B3. Foundation Drainage System					2		
No	B4. Moisture Controlled Crawlspace	0			1			
	B5. Structural Pest Controls							
TBD	B5.1 Termite Shields and Separated Exterior Wood-to-Concrete Connections					1		
No	B5.2 Plant Trunks, Bases, or Stems at Least 36 Inches from the Foundation	0				1		
LANDSCAPE								
20.00	Enter the landscape area percentage							
No	C1. Plants Grouped by Water Needs (Hydrozoning)	0					1	
Yes	C2. Three Inches of Mulch in Planting Beds	1					1	
	C3. Resource Efficient Landscapes							
Yes	C3.1 No Invasive Species Listed by Cal-IPC	1				1		
Yes	C3.2 Plants Chosen and Located to Grow to Natural Si e C3.3 Drought Tolerant, California Native, Mediterranean Species, or Other	1				1		
Yes	Appropriate Species	3					3	
	C4. Minimal Turf in Landscape							
Yes	C4.1 No Turf on Slopes Exceeding 10 and No Overhead Sprinklers Installed in							
Yes	Areas Less Than Eight Feet Wide  C4.2 Turf on a Small Percentage of Landscaped Area	2					2	1
No	C5. Trees to Moderate Building Temperature	2		-	1		2	<del> </del>
Yes	C6. High-Efficiency Irrigation System	0		1	1		2	
Yes	C7. One Inch of Compost in the Top Six to Twelve Inches of Soil	2					2	
No	C8. Rainwater Harvesting System	0					3	
No	C9. Recycled Wastewater Irrigation System	0					1	
Yes	C10. Submeter or Dedicated Meter for Landscape Irrigation	2					2	
≤0.5 ETo	C11. Landscape Meets Water Budget	0					1	
	C12. Environmentally Preferable Materials for Site  C12.1 Environmentally Preferable Materials for 70 of Non-Plant Landscape							
No	Elements and Fencing	0				1		
No	C12.2 Play Structures and Surfaces Have an Average Recycled Content ≥20	0				1		
Yes	C13. Reduced Light Pollution		1	1	1	1	1	1 Control of the Cont

Total Points Targeted: 110

Certification Level:

NEW HOME RATING SYSTEM, VERSION 7.0

MULTIFAMILY CHECKLIST

The GreenPoint Rated checklist tracks green features incorporated into the home. GreenPoint Rated is administered by Build It Green, a non-profit whose mission is to promote healthy, energy and resource efficient buildings in California.

© Build It Green GreenPoint Rated New Home Multifamily Checklist Version 7.0

© Build It Green

TBD K4.3 Shelving K4.5 Countertops K5. Formaldehyde Emissions in Interior Finish Exceed CARB TBD K5.1 Doors
TBD K5.2 Cabinets at
TBD K5.3 Interior Trin K5.2 Cabinets and Countertops K5.3 Interior Trim and Shelving No K6. Products That Comply With the Health Product Declaration Open Standard

K7. Indoor Air Formaldehyde Level Less Than 27 Parts Per Billion No K8. Comprehensive Inclusion of Low Emitting Finishes Yes K9. Durable Cabinets

Yes K10. At Least 25% of Interior Furniture Has Environmentally Preferable Attributes L1. Environmentally Preferable Flooring ≥25 L2. Low-Emitting Flooring Meets CDPH 2010 Standard Method—Residential TBD L3. Durable Flooring
No L4. Thermal Mass Flooring M. APPLIANCES AND LIGHTING Yes M1. ENERGY STAR® Dishwasher M2. Efficient Clothes Washing and Drying CEE Tier 2 M2.1 CEE-Rated Clothes Washer Yes M2.2 Energy Star Dryer

TBD M2.3 Solar Dryer/ Laundry Lines 25 cubic feet M3. Size-Efficient ENERGY STAR Refrigerator M4. Permanent Centers for Waste Reduction Strategies No M4.1 Built-In Recycling Center
M4.2 Built-In Composting Center
M5. Lighting Efficiency Yes M5.1 High-Efficacy Lighting
M5.2 Lighting System Designed to IESNA Footcandle Standards or Designed by Lighting Consultant Tier 1 M6. Electric Vehicle Charging Stations and Infrastructure 1 2 No M7. Central Laundry TBD M8. Gearless Elevator N. COMMUNITY N1. Smart Development Yes N1.1 Infill Site
No N1.2 Designated Brownfield Site
N1.3 Conserve Resources by Increasing Density N1.4 Cluster Homes for Land Preservation N1.5 Home Si e Efficiency Enter the area of the home, in s uare feet Enter the number of bedrooms N2. Home(s)/Development Located Near Major Transit Stop Yes N2.1 Within 1 Mile of a Ma or Transit Stop

N2.2 Within 1/2 mile of a Ma or Transit Stop 1 1 0 2 N3. Pedestrian and Bicycle Access N3.1 Pedestrian Access to Services Within 1/2 Mile of Community Services 0 Enter the number of Tier 1 services Enter the number of Tier 2 services N3.2 Connection to Pedestrian Pathways TBD N3.3 Traffic Calming Strategies TBD N3.4 Sidewalks Buffered from Roadways :
Yes N3.5 Bicycle Storage for Residents
TBD N3.6 Bicycle Storage for Non-Residents N3.4 Sidewalks Buffered from Roadways and 5-8 Feet Wide 1.5 spaces per unit N3.7 Reduced Parking Capacity N4. Outdoor Gathering Places Yes N4.1 Public or Semi-Public Outdoor Gathering Places for Residents
N4.2 Public Outdoor Gathering Places with Direct Access to Tier 1 Community
Services N5. Social Interaction No N5.1 Residence Entries with Views to Callers
No N5.2 Entrances Visible from Street and/or Other Front Doors

GreenPoint Rated New Home Multifamily Checklist Version 7.0

GreenPoint Rated New Home Multifamily Checklist Version 7.0

GreenPoint Rated New Home Multifamily Checklist Version 7.0 © Build It Green

Yes G2.2 WaterSense Bathroom Faucets with 1.0gpm or less
G2.3 WaterSense Toilets with a Maximum Performance (MaP) Threshold of No Less Than 500

G2.3 WaterSense Toilets with a Maximum Performance
Grams 1.28gpf OR 1.1 gpf

TBD G2.4 Urinals with Flush Rate of ≤ 0.1 Gallons/Flush

TBD G3. Pre-Plumbing for Graywater System

G4. Operational Graywater System

H. HEATING, VENTILATION, AND AIR CONDITIONING
H1. Sealed Combustion Units No H1.1 Sealed Combustion Furnace

H3. Effective Ductwork

G5. Thermostatic Shower Valve or Auto-Diversion Tub Spout
Yes G6. Submeter Water for Tenants

Yes H1.2 Sealed Combustion Water Heater

TBD H2. High Performing Zoned Hydronic Radiant Heating System

H5. Advanced Practices for Cooling TBD H5.1 ENERGY STAR Ceiling Fans in Living Areas and Bedrooms

H6.2 Advanced Ventilation Standards Yes H6.3 Outdoor Air is Filtered and Tempered

No H7.2 Automatic Range Hood Control
TBD H8. High Efficiency HVAC Filter (MERV 13+)
H9. Adavnced Refrigerants

TBD I1. Pre-Plumbing for Solar Water Heating

I4. Net Zero Energy Home

Yes J3. Mechanical Ventilation Testing
TBD J4. Combustion Appliance Safety Testing J5. Building Energy Performance

No J9. EPA Indoor airPlus Certification
TBD J10. Blower Door Testing
TBD J11. Compartimentalization of Units

No K1.1 Entryways to Individual Units
Yes K1.2 Entryways to Buildings
Yes K2. Zero-VOC Interior Wall and Ceiling Paints

Yes K3. Low-VOC Caulks and Adhesives

TBD K4.1 Cabinets TBD K4.2 Interior Trim

© Build It Green

No I4.1 Near Zero Energy Home
No I4.2 Net Zero Electric
TBD I5. Energy Storage System

J. BUILDING PERFORMANCE AND TESTING

TBD I2. Preparation for Future Photovoltaic Installation

0.00 I3. Onsite Renewable Generation (Solar PV, Solar Thermal, and Wind)

TBD I6. Solar Hot Water Systems to Preheat Domestic Hot Water
TBD I7. Photovoltaic System for Multifamily Projects

J1. Third-Party Verification of Quality of Insulation Installation

TBD J2. Supply and Return Air Flow Testing

J5.1 Home Meets or Exceeds Energy Compliance Pathway

J5.2 Non-Residential Spaces Outperform Title 24 Yes J6. Title 24 Prepared and Signed by a CABEC Certified Energy Analyst J7. Participation in Utility Program with Third-Party Plan Review

J8. ENERGY STAR for Homes

K1. Entryways Designed to Reduce Tracked-In Contaminants

K4. Environmentally Preferable Materials for Interior Finish

GreenPoint Rated New Home Multifamily Checklist Version 7.0

H7. Effective Range Design and Installation H7.1 Effective Range Hood Ducting and Design

Yes H3.1 Duct Mastic on Duct Joints and Seams
Yes H3.2 Pressure Balance the Ductwork System
Yes H4. ENERGY STAR® Bathroom Fans Per HVI Standards with Air Flow Verified

TBD H5.2 Operable Windows and Skylights Located to Induce Cross Ventilation in At Least One Room in 80 of Units

H6.1 Meet ASHRAE Standard 62.2-2010 Ventilation Residential Standards

H6. Whole House Mechanical Ventilation Practices to Improve Indoor Air Quality

0 25


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7 30

1

- 1. For Building Details, See Arch Dwgs.
- 2. For Street Improvement Details, See Civil Dwgs.
- 3. For Planting Information, See L4.0 Landscape Planting Plan



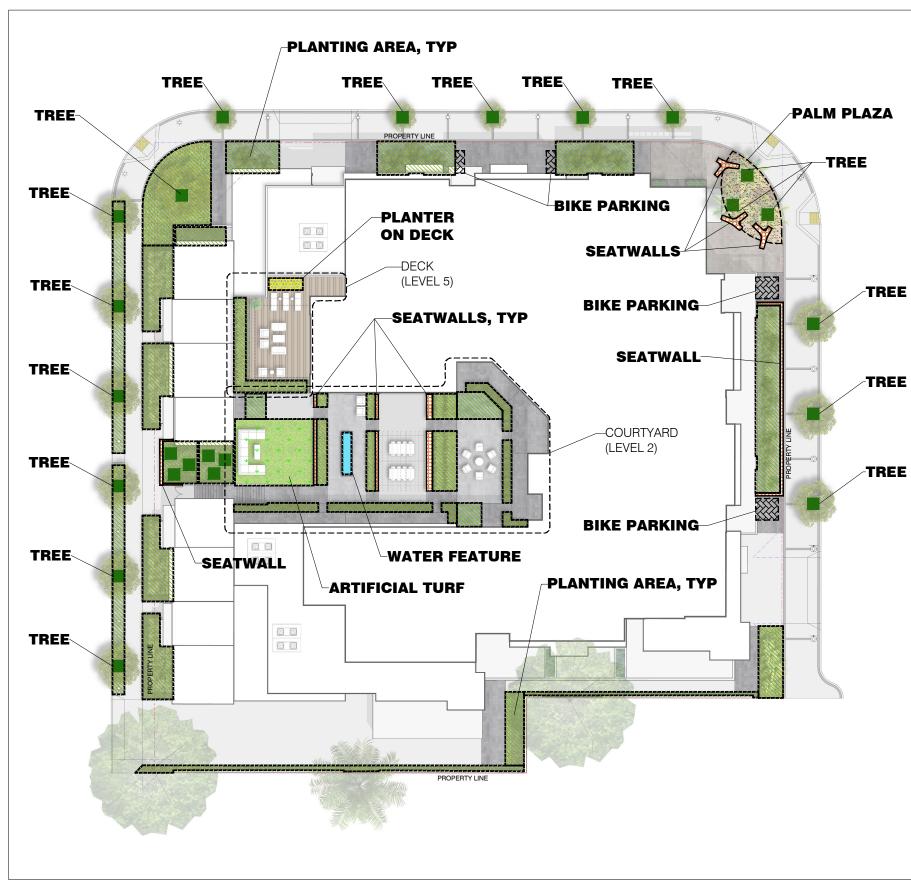

### LANDSCAPE AREA LEGEND:

SYMBOL	LANDSCAPE ZONE	AREA/ SQ FT (INSIDE OF PROPERTY LINE)	AREA/ SQ FT (OUTSIDE OF PROPERTY LINE)	AREA/ SQ FT (TOTAL)
	TREES	112	272	384
	PLANTING AREA	4417	1198	5615
	PALM PLAZA	311	14	325
* * * * * * * * * * * * * * * * * * *	ARTIFICIAL TURF	581	0	581
	WATER FEATURE	42	0	42
	SEATWALLS	238	32	270
	BIKE PARKING	155	0	155
	PLANTER ON DECK	45	0	45
	TOTAL	5901	1516	7417

LANDSCAPE AREA DIAGRAM:

/ Bay West Development e, 2nd Floor, Menlo Park CA 94025 Ave, Suite 1050, Campbell, CA 95008 Lane Partners / Lane Partners: 644 Menlo Ave Bay West: 1725 S. Bascom Av

Sheet Title:

Mathilda

Landscape Concept Plan

16044 Job No. 03/20/2018 Date: 1/16" = 1'-0" Scale: Drawn By:

Sheet No:

LANDSCAPE CONCEPT PLAN


- For Building Details, See Arch Dwgs.
- 2. For Street Improvement Details, See Civil Dwgs.
- 3. For Landscape Materials, See L1.0 Landscape Concept Plan
- 4. 3" of mulch applied on all exposed planting surfaces.
- 5. Compost at a minimum rate of 4 cy per 1000 sf of permeable area, to a depth
- 6. "I have complied with the criteria of the ordinance and applied them for the efficient use of water in the landscape design plan"

PLAN

ROOF DEC	K					
SYMBOL	KEY	SPECIES	QTY	SIZE	SPACING	NOTES
	AA	Agave attenuata Foxtail Agave		5 or15 Gal	7' O.C.	
	AB	Agave shawii x attenuata 'Blue Flame' Agave 'Blue Flame'		5 or15 Gal	5' O.C.	
	AL	Aloe hybrid "LEO 3711" Super Red™Aloe		5 or15 Gal	40" O.C.	
	AY	Anigozanthos 'Bush Dawn' Yellow Kangaroo Paws		1 or 5 Gal	24" O.C.	
	CA	Calamagrostis x acutiflora 'Karl Foerster' Foerster's Feather Reed Grass		1 or 5 Gal	24" O.C.	
	PA	Panicum virgatum 'Heavy Metal' Heavy Metal Blue Switch Grass		1 or 5 Gal	30" O.C.	
	PC	Phormium cookianum 'Cream Delight' Cream Delight New Zealand Flax		1 or 5 Gal	5' O.C.	
	VB	Verbena bonariensis Tall Verbena		5 or15 Gal	30" O.C.	

COURTYARD						
SYMBOL	KEY	SPECIES	QTY	SIZE	SPACING	NOTES
	AY	Anigozanthos 'Bush Dawn' Yellow Kangaroo Paws		1 or 5 Gal	24" O.C.	
	СВ	Carex divulsa Berkeley Sedge		1 or 5 Gal	24" O.C.	
	cs	Carex phyllocephala 'sparkler' Sparkler Sedge		1 or 5 Gal	24" O.C.	
	СТ	Chondropetalum tectorum Small Cape Rush		1 or 5 Gal	30" O.C.	
	LG	Liriope 'gigantea' Giant Lilyturf		1 or 5 Gal	30" O.C.	
	LL	Lomandra longifolia 'Breeze'  Dwarf Mat Rush		1 or 5 Gal	36" O.C.	
	RV	Ribes viburnifolium Evergreen Currant		1 or 5 Gal	30" O.C.	
	NC	Nephrolepis cordifolia California Sword Fern		15 Gal	30" O.C.	
	WG	Woodwardia fimbriata Giant Chain Fern		15 Gal	36" O.C.	
	PR	Prunus caroliniana 'Compacta' Dwarf Carolina Laurel Cherry		15 Gal	36" O.C.	
	RC	Rhamnus californica California Coffeeberry		15 Gal	36" O.C.	
	i	,				

1/16" = 1' - 0"

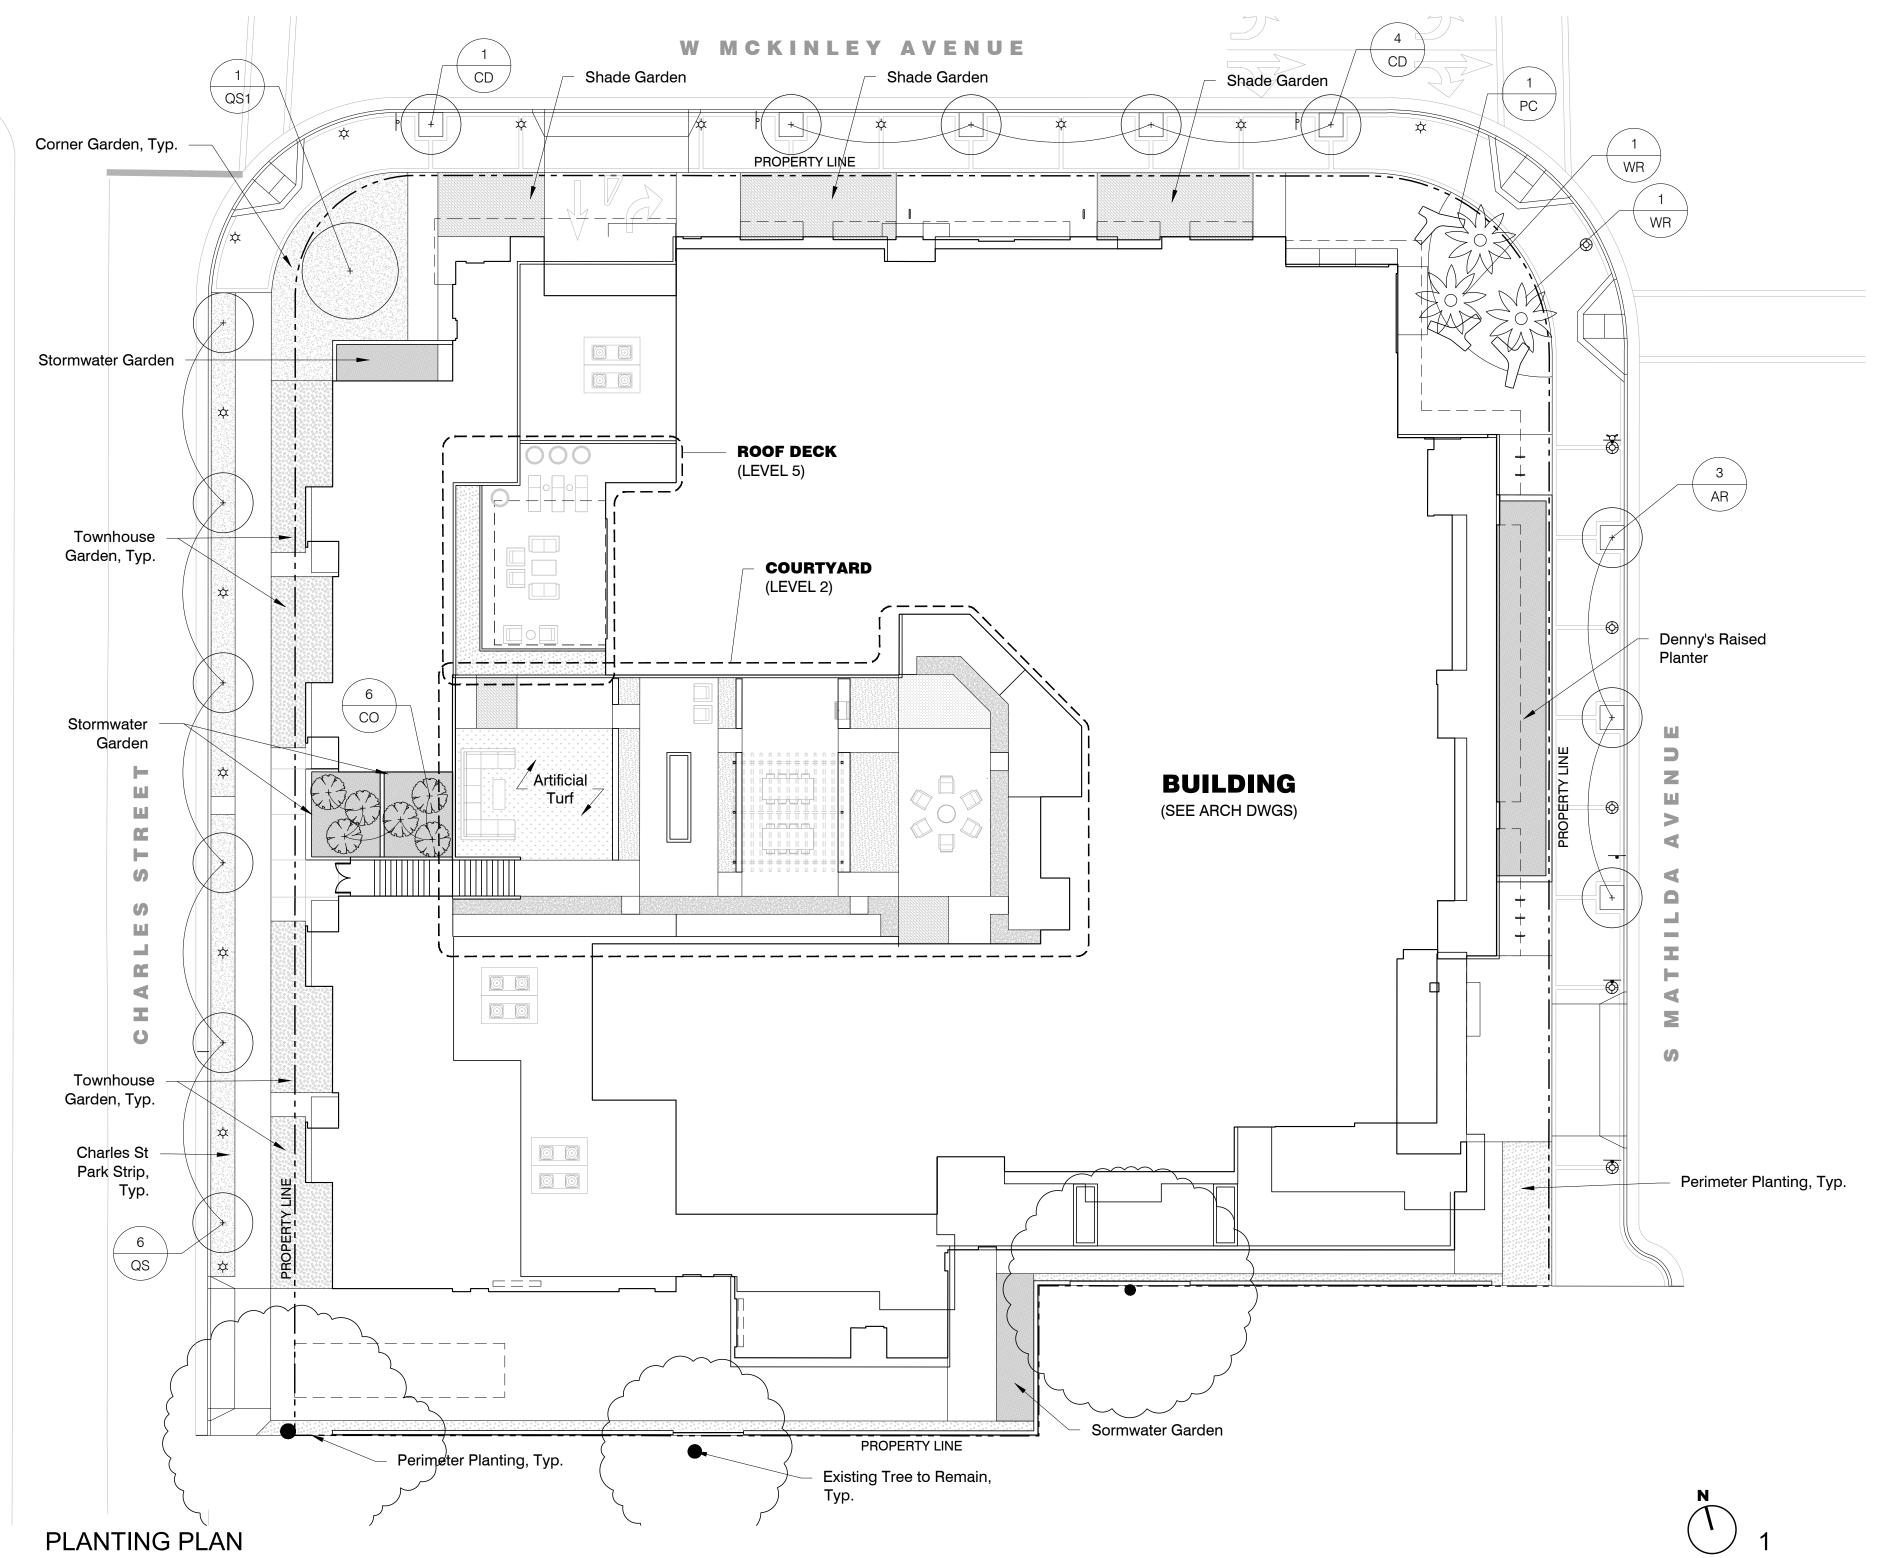

TREES						
SYMBOL	KEY	SPECIES  Acer rubrum	QTY	SIZE	SPACING 30' O.C.	NOTES Sunnyvale Street Tree for
+	AR	Red Maple	4	36" Box	As Shown	S Mathilda Avenue. Follow City Specifications.
+	CD	Calocedrus decurrens Incense Cedar	5	36" Box	30' O.C. As Shown	Sunnyvale Street Tree for W McKinley Avenue.
	СО	Cercis occidentalis	6	8'-10' Tall	15' O.C.	Follow City Specifications.  3 Multi-stem Trees, 3 Standard
		Western Redbud  Quercus shumardii			As Shown	Sunnyvale Street Tree for
+	QS	Shumard Oak	6	36" Box	30' O.C.	Charles Street. Follow City Specifications.
+	QS1	Quercus shumardii Shumard Oak	1	60" Box	30' O.C.	Sunnyvale Street Tree at Corner Garde Follow City Specifications.
ZWZ	РС	Phoenix canariensis Canary Island date palm	3	Transplant - Size Varies	As shown	Transplanted Trees from Site - Size Vari (22"-35" Diameter, 20'-45' Height)
	WR	Washingtonia robusta	3	Transplant -	As shown	Transplanted Tree from Site - Size Varie
W)	VVIX	Mexican Fan Palm		Size Varies	A3 3HOWH	(15"-21" Diameter, 40'-50' Height)
		K STRIP & CORNER GARDEN	OTV	0175		NOTEO
SYMBOL	KEY	SPECIES Dianella revoluta 'Little Rev'	QTY	SIZE 1 or 5 Gal	SPACING 24" O.C.	NOTES
	DA	Little Rev™ Flax Lily		i di 5 Gai	24 U.C.	
	DI	Dietes iridioides African Iris		1 or 5 Gal	30" O.C.	
	LG	Liriope 'Gigantea' Giant Lilyturf		1 or 5 Gal	30" O.C.	
PERIMETER	R PLAN	•				
SYMBOL	KEY	SPECIES	QTY	SIZE	SPACING	NOTES
	AB	Agave shawii x attenuata 'Blue Flame' Agave 'Blue Flame'		5 or15 Gal	5' O.C.	
37 4 77 4 77 4 77 4 77 4 77 4 77 4 77 4	AG	Agave 'Blue Glow' Blue Glow Agave		5 or15 Gal	24" O.C.	
	0.0	Carex phyllocephala 'sparkler'		4 501	45" 0 0	
	СР	Sparkler Sedge		1 or 5 Gal	15" O.C.	
	PC	Phormium cookianum 'Cream Delight' Cream Delight New Zealand Flax		1 or 5 Gal	5' O.C.	
	SF	Semiarundinaria fastuosa 'Viridis' Temple Bamboo		1 Gal	30" O.C.	
DENNY'S R	V C C	PLANTER (STORMWATER GARDEN)				
SYMBOL	KEY	SPECIES Agave attenuata	QTY	SIZE	SPACING	NOTES
	AA	Foxtail Agave		5 or15 Gal	5' O.C.	
	AC	Aloe capitata var. quartziticola Aloe		5 or15 Gal	30" O.C.	
	cs	Carex barbarae		1 or 5 Gal	12' O.C.	
		Santa Barbara sedge  Anigozanthos 'Big Red'				
	AN	Big Red Kangaroo Paws		8'-10' Tall	30" O.C.	
	CA	Calamagrostis x acutiflora 'Karl Foerster' Foerster's Feather Reed Grass		1 or 5 Gal	24" O.C.	
	СР	Carex phyllocephala 'sparkler'		1 or 5 Gal	15" O.C.	
	<b>D</b>	Sparkler Sedge  Deschampia caespitosa 'Susan's Choice'		4 501	0011 0 0	
	DC	Tufted Hair Grass		1 or 5 Gal	30" O.C.	
	FF	Furcraea foetida False Agave		5 or15 Gal	6' O.C.	
	HR	Hesperaloe parviflora Red Yucca		5 or15 Gal	30" O.C.	
	LG	Liriope 'Gigantea'		1 or 5 Gal	30" O.C.	
	LG	Giant Lilyturf  Dianella tasmanica		1 01 5 Gai	30 O.C.	
	DT	Tasman Flax-lily		1 or 5 Gal	24" O.C.	
	JC	Juncus patens California Grey Rush		1 or 5 Gal	12' O.C.	
	PA	Panicum virgatum 'Heavy Metal'		1 or 5 Gal	30" O.C.	
		Heavy Metal Blue Switch Grass  Pennisetum orientale 'Fairy Tails'				
	PE	Evergreen Fountain Grass		1 or 5 Gal	30" O.C.	
	СТ	Chondropetalum tectorum Small Cape Rush		1 or 5 Gal	12' O.C.	
SHADE GAI		'				
SYMBOL	KEY	SPECIES  Dicksonia antarctica	QTY	SIZE	SPACING	NOTES
	DI	Tasmanian tree fern		15 Gal	12' O.C.	
	NE	Nephrolepis cordifolia California Sword Fern		15 Gal	30" O.C.	
	RI	Ribes viburnifolium		1 or 5 Gal	30" O.C.	
		Evergreen Currant  Woodwardia fimbriata				
	WO	Giant Chain Fern		15 Gal	36" O.C.	
STORMWA <sup>*</sup> SYMBOL	TER GA	ARDEN SPECIES	QTY	SIZE	SPACING	NOTES
		Carex barbarae		1 or 5 Gal	12' O.C.	
XXXXXX	CS	0 1 5 1		. J. J Jul		
	CS	Santa Barbara sedge  Carex divulsa			, <del>-</del> -	
	CS CB	Carex divulsa Berkeley Sedge		1 or 5 Gal	12' O.C.	
		Carex divulsa		1 or 5 Gal 1 or 5 Gal	12' O.C. 24" O.C.	
	СВ	Carex divulsa Berkeley Sedge Chondropetalum elephantium Large Cape Rush Chondropetalum tectorum				
	CB CL CT	Carex divulsa Berkeley Sedge Chondropetalum elephantium Large Cape Rush Chondropetalum tectorum Small Cape Rush Juncus patens		1 or 5 Gal 1 or 5 Gal	24" O.C. 12' O.C.	
	CB CL CT JC	Carex divulsa Berkeley Sedge Chondropetalum elephantium Large Cape Rush Chondropetalum tectorum Small Cape Rush Juncus patens California Grey Rush		1 or 5 Gal 1 or 5 Gal 1 or 5 Gal	24" O.C. 12' O.C. 12' O.C.	
	CB CL CT JC JC	Carex divulsa Berkeley Sedge Chondropetalum elephantium Large Cape Rush Chondropetalum tectorum Small Cape Rush Juncus patens California Grey Rush Juncus patens 'Elk Blue' Elk Blue CA Rush		1 or 5 Gal 1 or 5 Gal	24" O.C. 12' O.C.	
TOWNHOUSYMBOL	CB CL CT JC JE SE GAI	Carex divulsa Berkeley Sedge Chondropetalum elephantium Large Cape Rush Chondropetalum tectorum Small Cape Rush Juncus patens California Grey Rush Juncus patens 'Elk Blue' Elk Blue CA Rush		1 or 5 Gal 1 or 5 Gal 1 or 5 Gal 1 or 5 Gal	24" O.C. 12' O.C. 12' O.C. 12' O.C.	NOTES
TOWNHOU: SYMBOL	CB CL CT JC JC	Carex divulsa Berkeley Sedge Chondropetalum elephantium Large Cape Rush Chondropetalum tectorum Small Cape Rush Juncus patens California Grey Rush Juncus patens 'Elk Blue' Elk Blue CA Rush RDEN SPECIES Dianella revoluta 'Little Rev'		1 or 5 Gal 1 or 5 Gal 1 or 5 Gal	24" O.C. 12' O.C. 12' O.C.	NOTES
	CB CL CT JC JE SE GAI KEY DA	Carex divulsa Berkeley Sedge  Chondropetalum elephantium Large Cape Rush  Chondropetalum tectorum Small Cape Rush  Juncus patens California Grey Rush  Juncus patens 'Elk Blue' Elk Blue CA Rush  RDEN  SPECIES  Dianella revoluta 'Little Rev' Little Rev™ Flax Lily	   QTY	1 or 5 Gal 1 or 5 Gal 1 or 5 Gal 1 or 5 Gal SIZE 1 or 5 Gal	24" O.C.  12' O.C.  12' O.C.  12' O.C.  SPACING  24" O.C.	NOTES
	CB CL CT JC JE SE GAI KEY	Carex divulsa Berkeley Sedge  Chondropetalum elephantium Large Cape Rush  Chondropetalum tectorum Small Cape Rush  Juncus patens California Grey Rush  Juncus patens 'Elk Blue' Elk Blue CA Rush  RDEN  SPECIES  Dianella revoluta 'Little Rev' Little Rev™ Flax Lily  Dietes iridioides African Iris	   QTY	1 or 5 Gal 1 or 5 Gal 1 or 5 Gal 1 or 5 Gal SIZE	24" O.C.  12' O.C.  12' O.C.  12' O.C.	NOTES
	CB CL CT JC JE SE GAI KEY DA	Carex divulsa Berkeley Sedge  Chondropetalum elephantium Large Cape Rush  Chondropetalum tectorum Small Cape Rush  Juncus patens California Grey Rush  Juncus patens 'Elk Blue' Elk Blue CA Rush  RDEN  SPECIES  Dianella revoluta 'Little Rev' Little Rev™ Flax Lily  Dietes iridioides	   QTY	1 or 5 Gal 1 or 5 Gal 1 or 5 Gal 1 or 5 Gal SIZE 1 or 5 Gal	24" O.C.  12' O.C.  12' O.C.  12' O.C.  SPACING  24" O.C.	NOTES
	CB CL CT JC JE SE GAI KEY DA DI	Carex divulsa Berkeley Sedge  Chondropetalum elephantium Large Cape Rush  Chondropetalum tectorum Small Cape Rush  Juncus patens California Grey Rush  Juncus patens 'Elk Blue' Elk Blue CA Rush  RDEN  SPECIES  Dianella revoluta 'Little Rev' Little Rev™ Flax Lily  Dietes iridioides African Iris  Escallonia bifida White Escallonia  Hydrangea quercifolia	   QTY 	1 or 5 Gal 1 or 5 Gal 1 or 5 Gal 1 or 5 Gal SIZE 1 or 5 Gal 1 or 5 Gal	24" O.C.  12' O.C.  12' O.C.  12' O.C.  30" O.C.	NOTES
	CB CL CT JC JE SE GAI KEY DA DI EB HQ	Carex divulsa Berkeley Sedge  Chondropetalum elephantium Large Cape Rush  Chondropetalum tectorum Small Cape Rush  Juncus patens California Grey Rush  Juncus patens 'Elk Blue' Elk Blue CA Rush  RDEN  SPECIES  Dianella revoluta 'Little Rev' Little Rev™ Flax Lily  Dietes iridioides African Iris  Escallonia bifida White Escallonia  Hydrangea quercifolia Oakleaf Hydrangea	   QTY 	1 or 5 Gal SIZE 1 or 5 Gal 1 or 5 Gal 1 or 5 Gal 15 Gal	24" O.C.  12' O.C.  12' O.C.  12' O.C.  30" O.C.  36" O.C.  4' O.C.	NOTES
	CB CL CT JC JE SE GAI KEY DA DI EB	Carex divulsa Berkeley Sedge  Chondropetalum elephantium Large Cape Rush  Chondropetalum tectorum Small Cape Rush  Juncus patens California Grey Rush  Juncus patens 'Elk Blue' Elk Blue CA Rush  RDEN  SPECIES  Dianella revoluta 'Little Rev' Little Rev™ Flax Lily  Dietes iridioides African Iris  Escallonia bifida White Escallonia  Hydrangea quercifolia	   QTY 	1 or 5 Gal 1 or 5 Gal 1 or 5 Gal 1 or 5 Gal SIZE 1 or 5 Gal 1 or 5 Gal 1 or 5 Gal	24" O.C.  12' O.C.  12' O.C.  12' O.C.  30" O.C.  36" O.C.	NOTES



/ Bay West Development re, 2nd Floor, Menlo Park CA 94025 Ave, Suite 1050, Campbell, CA 95008 Lane Partners / Lane Partners: 644 Menlo Ave Bay West: 1725 S. Bascom Av

Sheet Title:


Mathilda

# Landscape Planting Plan

16044 Job No. 03/20/2018 1/16" = 1'-0" Scale: Drawn By:

Sheet No:

- 1. For Building Details, See Arch Dwgs.
- 2. For Street Improvement Details, See Civil Dwgs.
- 3. For Landscape Materials, See L1.0 Landscape Concept Plan
- 4. For Planting Information, See L4.0 Landscape Planting Plan

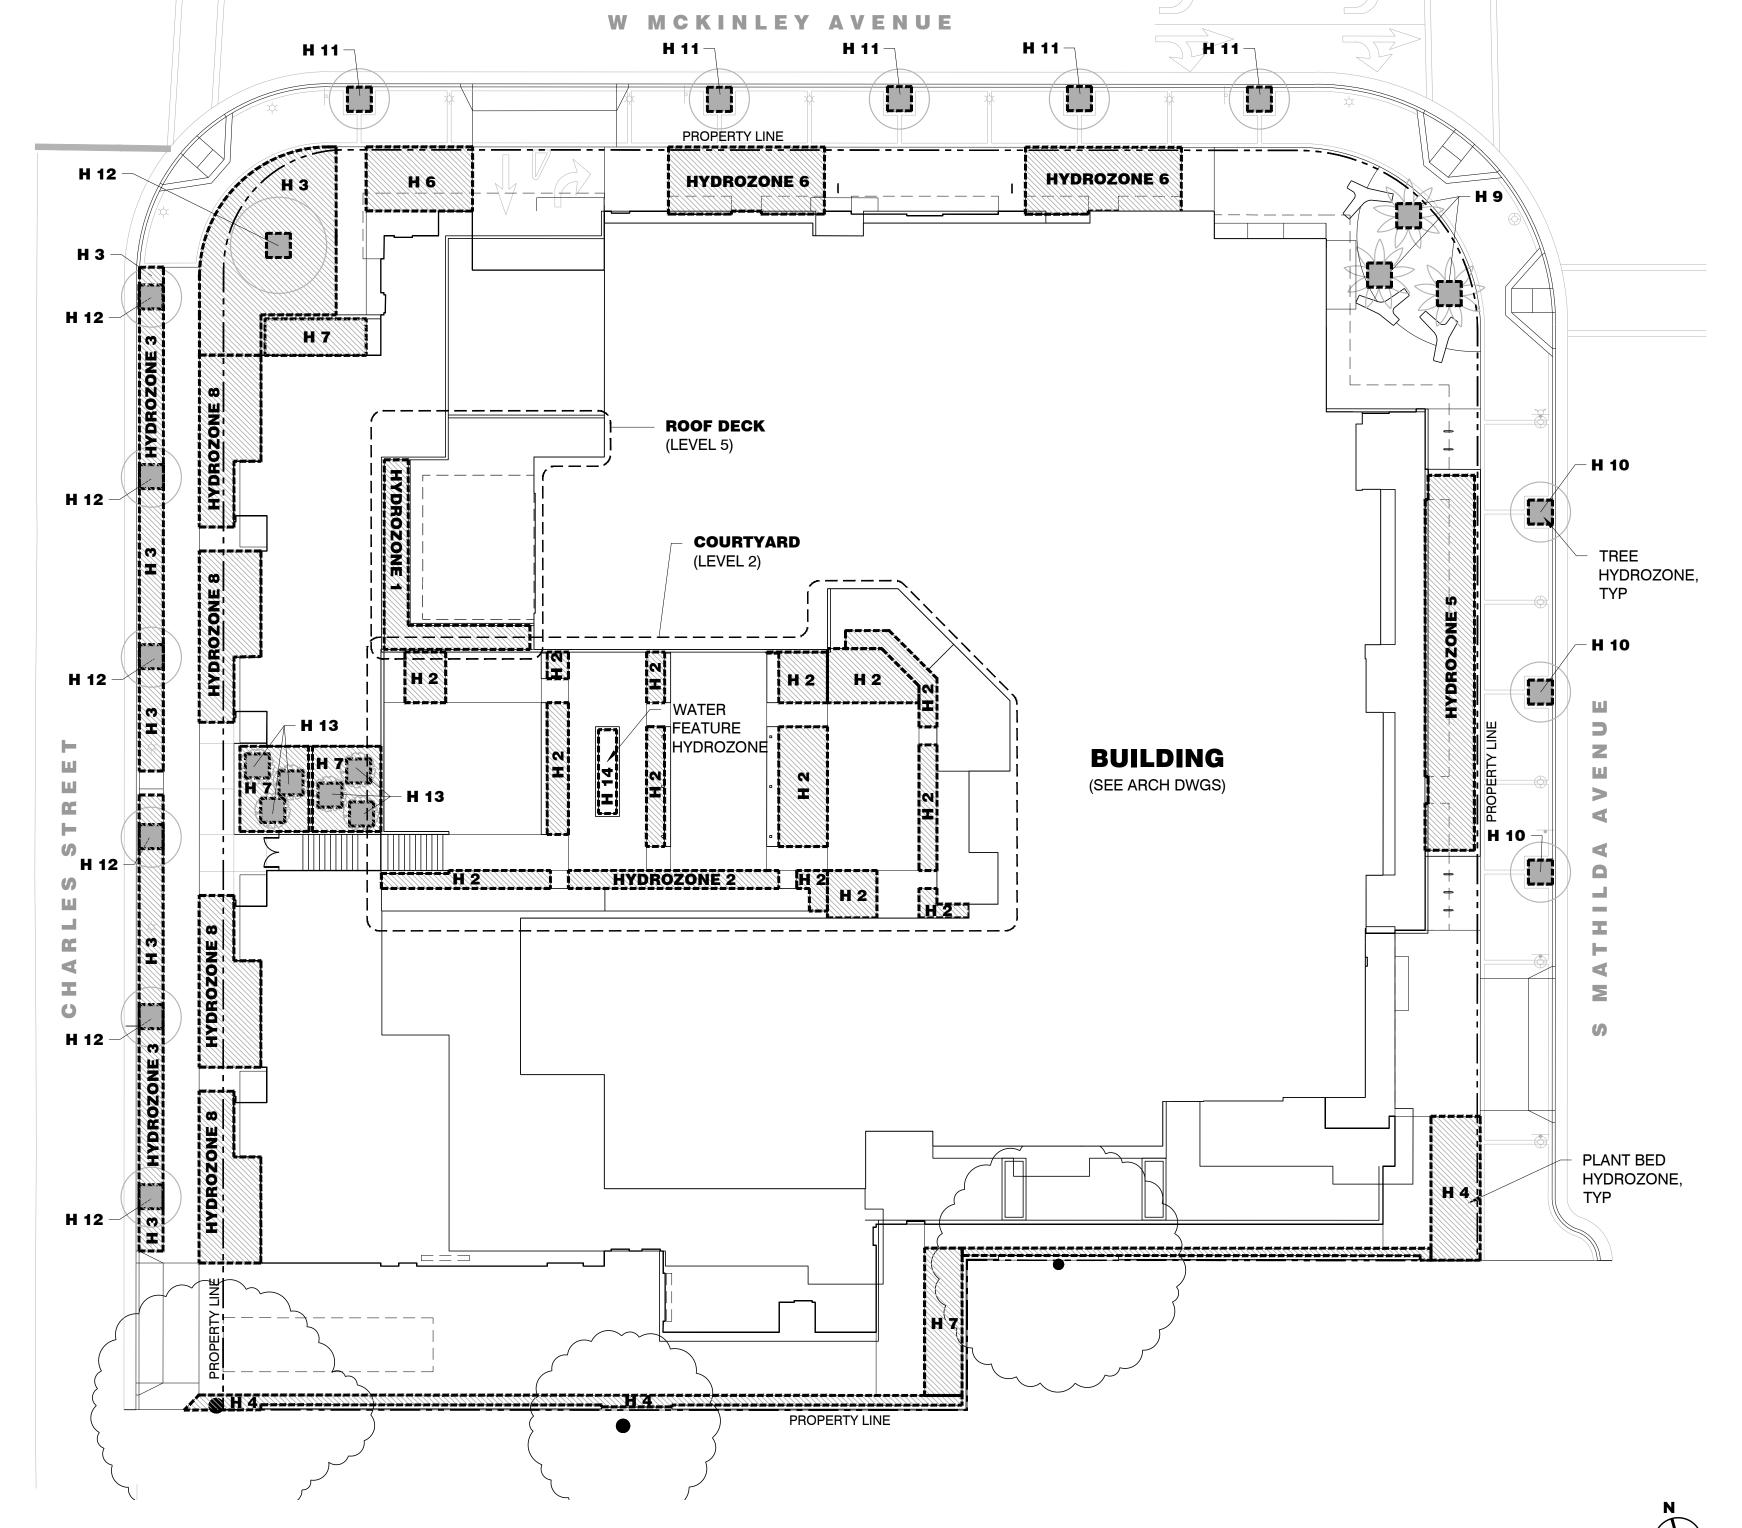

MAXIMUM APPLIED WATER ALLOWANCE PROJECT #: MAWA = (ETo) x (0.62) x  $[(0.45 \times LA)+(0.55 \times SLA)]$ San Jose (Sunnyvale) ETo\*\* 45.30 ETo (inches/year) Enter total project Landscaped Area 6,042 LA (square feet) Enter Special Landscaped Area SLA (square feet) RESULTS: 76,363.03 MAWA (gallons/year) \*\* Eto Values derived from Appendix A of the CA Model Water Efficient Landscape Ordinance, CA Dept. of Water Resources

MAWA= Maximum applied water allowance (gallons per year) ETo = Reference Evapotranspiration (inches per year)

0.45 = ET Adjustment Factor (ETAF) for nonresidential projects

LA = Planted landscaped area including SLA and not including hardscapes. Also include surface area

of water features not using recycled water. 0.62 = Conversion Factor (to gallons per square foot)

SLA = Portion of the Landscaped Area identified as Special Landscaped Area. Also include surface area

of water features using recycled water. 0.55 = The additional ET Adjustment Factor for SLA (1.0 - 0.45 = 0.55)

ESTIMATED TOTAL WATER USE PROJECT #: ETWU = (ETo) x (0.62) x [(PF x HA)/IE + SLA] Irrigation Efficiency Values 0.81 Estimated total water use per year (gallons per year) ETo = Reference Evapotranspiration (inches per year) 0.75 Overhead Spray System PF = Plant Factor from WUCOLS\* or equivalent reference subject to approval 0.75 Water Feature/Other HA = Hydrozone Area (square feet) SLA = Special Landscaped Area (square feet) Plant Water Use Type **Plant Factor** 0 - 0.1 0.2 - 0.3 0.62 = Conversion Factor (to gallons per square foot) IE = Average Irrigation Efficiency (minimum 0.75, assumed to be 0.76 for overhead spray system and 0.81 for drip 0.4 - 0.6 0.7 - 1.0 Water Feature (High) 1.0 1.0

(sq ft) 77 505 281 628 126 377 60
505 281 628 126 377
281 628 126 377
126 377
377
60
484
12
24
20
28
24
56

MAWA = |76,363|75,854 gallons/year ETWU must be less than or equal to MAWA

WU complies with MAWA



elopment Lane Partners / Lane Partners / Bay West: 1725 S. Bascom Av

Sheet Title:

311 S Mathilda Ave, Sunny

Landscape Hydrozone Plan

16044 03/20/2018 1/16" = 1'-0" Scale: Drawn By:

**PROJECT MEETS WATER EFFICIENCY REQUIREMENTS:** 

ETWU is less than MAWA

1/16" = 1' - 0"

PLAN

HYDROZONE PLAN

#### **PROJECT SUMMARY**

1. OWNER/SUBDIVIDER: LANE PARTNERS 644 MENLO AVE, 2ND FLOOR MENLO PARK, CA 94025

2. ENGINEER: BKF ENGINEERS 4670 WILLOW ROAD, SUITE 250 PLEASANTON, CA 94588

TEL (925) 396-7700 FAX (925) 396-7799

3. <u>SUBDIVIDED AREA:</u> 44,111 SQ FT (APPROX. 1.01 ACRES) (41,486 SQ FT AFTER PROPOSED STREET

4. <u>UTILITIES:</u>

WATER SUPPLY: CITY OF SUNNYVALE CITY OF SUNNYVALE FIRE PROTECTION: SEWAGE DISPOSAL CITY OF SUNNYVALE STORM DRAIN: CITY OF SUNNYVALE GAS & ELECTRIC: PACIFIC GAS & ELECTRIC TELEPHONE: AT&T CABLE TELEVISION: COMCAST

5. <u>APN</u>: 165-13-050

6. <u>ZONING</u>: DSP (DOWNTOWN SPECIFIC PLAN)

7. LAND USE: MIXED USE

8. **GENERAL PLAN**: COMMERCIAL GENERAL BUSINESS

9. FLOOD ZONE DESIGNATION: ZONE X PER MAP #06085C0206H

AREA OF 0.2% ANNUAL CHANCE FLOODPLANE

**SYMBOL** 

**DESCRIPTION** 

10. NUMBER OF LOTS: 1 WITH CONDOMINIUM UNITS

11. <u>NUMBER OF</u>

<u>SYMBOL</u>

RESIDENTIAL CONDO UNITS: 75

12. <u>NUMBER OF</u> **RETAIL CONDO UNITS:** 

# **PROJECT** W McKINLEY AVE W IOWA AVE

**VICINITY MAP** 

NTS

#### **SHEET INDEX**

<u>NUMBER</u>	DESCRIPTION
C0.0	CIVIL COVER SHEET
C1.0	EXISTING CONDITIONS PLAN
C2.0	PROPOSED CIVIL SITE PLAN
C3.0	PRELIMINARY GRADING PLAN
C4.0	PRELIMINARY UTILITY PLAN
C5.0	PRELIMINARY STORMWATER CONTROL PLAN

#### **BENCHMARK**

CITY OF SUNNYVALE BRASS DISK MONUMENT, DESIGNATED "BM2," SET IN TOP OF CURB NEXT TO CATCH BASIN AT TRAFFIC SIGNAL BOX ON THE SOUTHWEST CORNER OF WEST OLIVE AVE. AND MATHILDA AVE. ELEVATION = 115.872 (NAVD88)

#### **BASIS OF BEARINGS**

NORTH 14'52'00" EAST, BEING THE EASTERLY LINE OF PARCEL 1, BEING PARALLEL AND DISTANT 60.00 FEET WESTERLY OF THE LINE BETWEEN TWO CITY MONUMENTS IN THE RIGHT OF WAY OF MATHILDA AVENUE AS SHOWN ON THAT CERTAIN PARCEL MAP FILED FOR RECORD IN BOOK 543 OF MAPS AT PAGE 24, RECORDS OF SANTA CLARA COUNTY.

#### **ABBREVIATIONS**

DI DW DW, D/W, DWY E, ELEC (E), EX, EXIST EB EG EL, ELEV EP ESMT ETW EVAE FC FDC FF FG FH FL FS GB GM HC/HCR HDPE HP INV IRR JP	CURB INLET CONCRETE CUBIC YARDS DEMOLITION DROP INLET DOMESTIC WATER DRIVEWAY ELECTRIC EXISTING ELECTRIC BOX EXISTING GROUND ELEVATION EDGE OF PAVEMENT EASEMENT EDGE OF TRAVELED WAY EMERGENCY VEHICLE ACCESS FACE OF CURB FIRE DEPARTMENT CONNECTION FINISHED FLOOR FINISH GRADE FIRE HYDRANT FLOW LINE FINISHED SURFACE GRADE BREAK GAS METER HANDICAP RAMP HIGH DENSITY POLYETHYLNE HIGH POINT INVERT IRRIGATION JOINT POLE	LF LG LP MAX MIN MH MON (N) NTS PG&E PGETLE PIV POC PR, PROP PRV PSE R CP RIM R/W. RTE RUE S DCG SDCG SDJB SDMH SL SSCO SSMH
JT	JOINT TRENCH	SW, S/W

**DESCRIPTION** LINEAR FOOT LIP OF GUTTER LOW POINT MAXIMUM MINIMUM MANHOLE MONUMENT NEW NUMBER NOT TO SCALE PACIFIC GAS & ELECTRIC PG&E EASEMENT PG&E TOWER LINE EASEMENT POST INDICATOR VALVE PROPERTY LINE POINT OF CONNECTION PROPOSED PRESSURE REDUCING VALVE PUBLIC SURVEY EASEMENT RADIUS REINFORCED CONCRETE PIPE ROADWAY EASEMENT RIM ELEVATION RIGHT OF WAY RAIL TRACK EASEMENT ROAD UTILITY EASEMENT SLOPE STORM DRAIN STORM DRAIN CATCH BASIN STORM DRAIN CURB INLET STORM DRAIN CLEANOUT STORM DRAIN JUNCTION BOX STORM DRAIN MANHOLE SHEET STREET LIGHT

STD SWE TC TEL, TELE THRU TM TOS **TRANS** TS TSB/TSPB USD VCP

**SYMBOL** 

STANDARD SIDEWALK EASEMENT TOP OF CURB TELEPHONE TOP OF GRATE THROUGH TENTATIVE MAP TOP OF SLAB TRANSFORMER TRAFFIC SIGNAL TRAFFIC SIGNAL BOX TYPICAL UTILITY BOX UTILITY EASEMENT UNION SANITARY DISTRICT VITRIFIED CLAY PIPE WATER WATER LINE WATER METER WATER VALVE

**DESCRIPTION** 

<u>PROPOSED</u> **EXISTING** PROPERTY LINE \_\_\_\_\_ ELECTRICAL LINE GAS LINE STORM DRAIN LINE *─ ─ < ─ ─* SANITARY SEWER ---EX WATER LINE -----\_...\_ -----FIRE WATER LINE MANHOLE (MH) STORM DRAIN OVERFLOW (SDO) STORMWATER TREATMENT VAULT (STV) BACKFLOW PREVENTER (BFP) FIRE HYDRANT CLEANOUT (CO) WATER VALVE (WV)  $\triangleright$ WATER METER (WM) AREA DRAIN (AD) BIORETENTION AREA (SEE DETAIL 1/C5.0)

Partners s: 644 Menlo Av 25 S. Bascom A

Sheet Title: CIVIL COVER

20177004 Job No. 06/04/2018 Date: PER PLAN Scale: Drawn By: KA

Sheet No:

SHEET


C0.0


SQUARE FEET

SANITARY SEWER SANITARY SEWER CLEANOUT SANITARY SEWER MANHOLE SIDEWALK

**LEGEND** 

FLOW-THRU PLANTER (SEE DETAIL 2/C5.0)

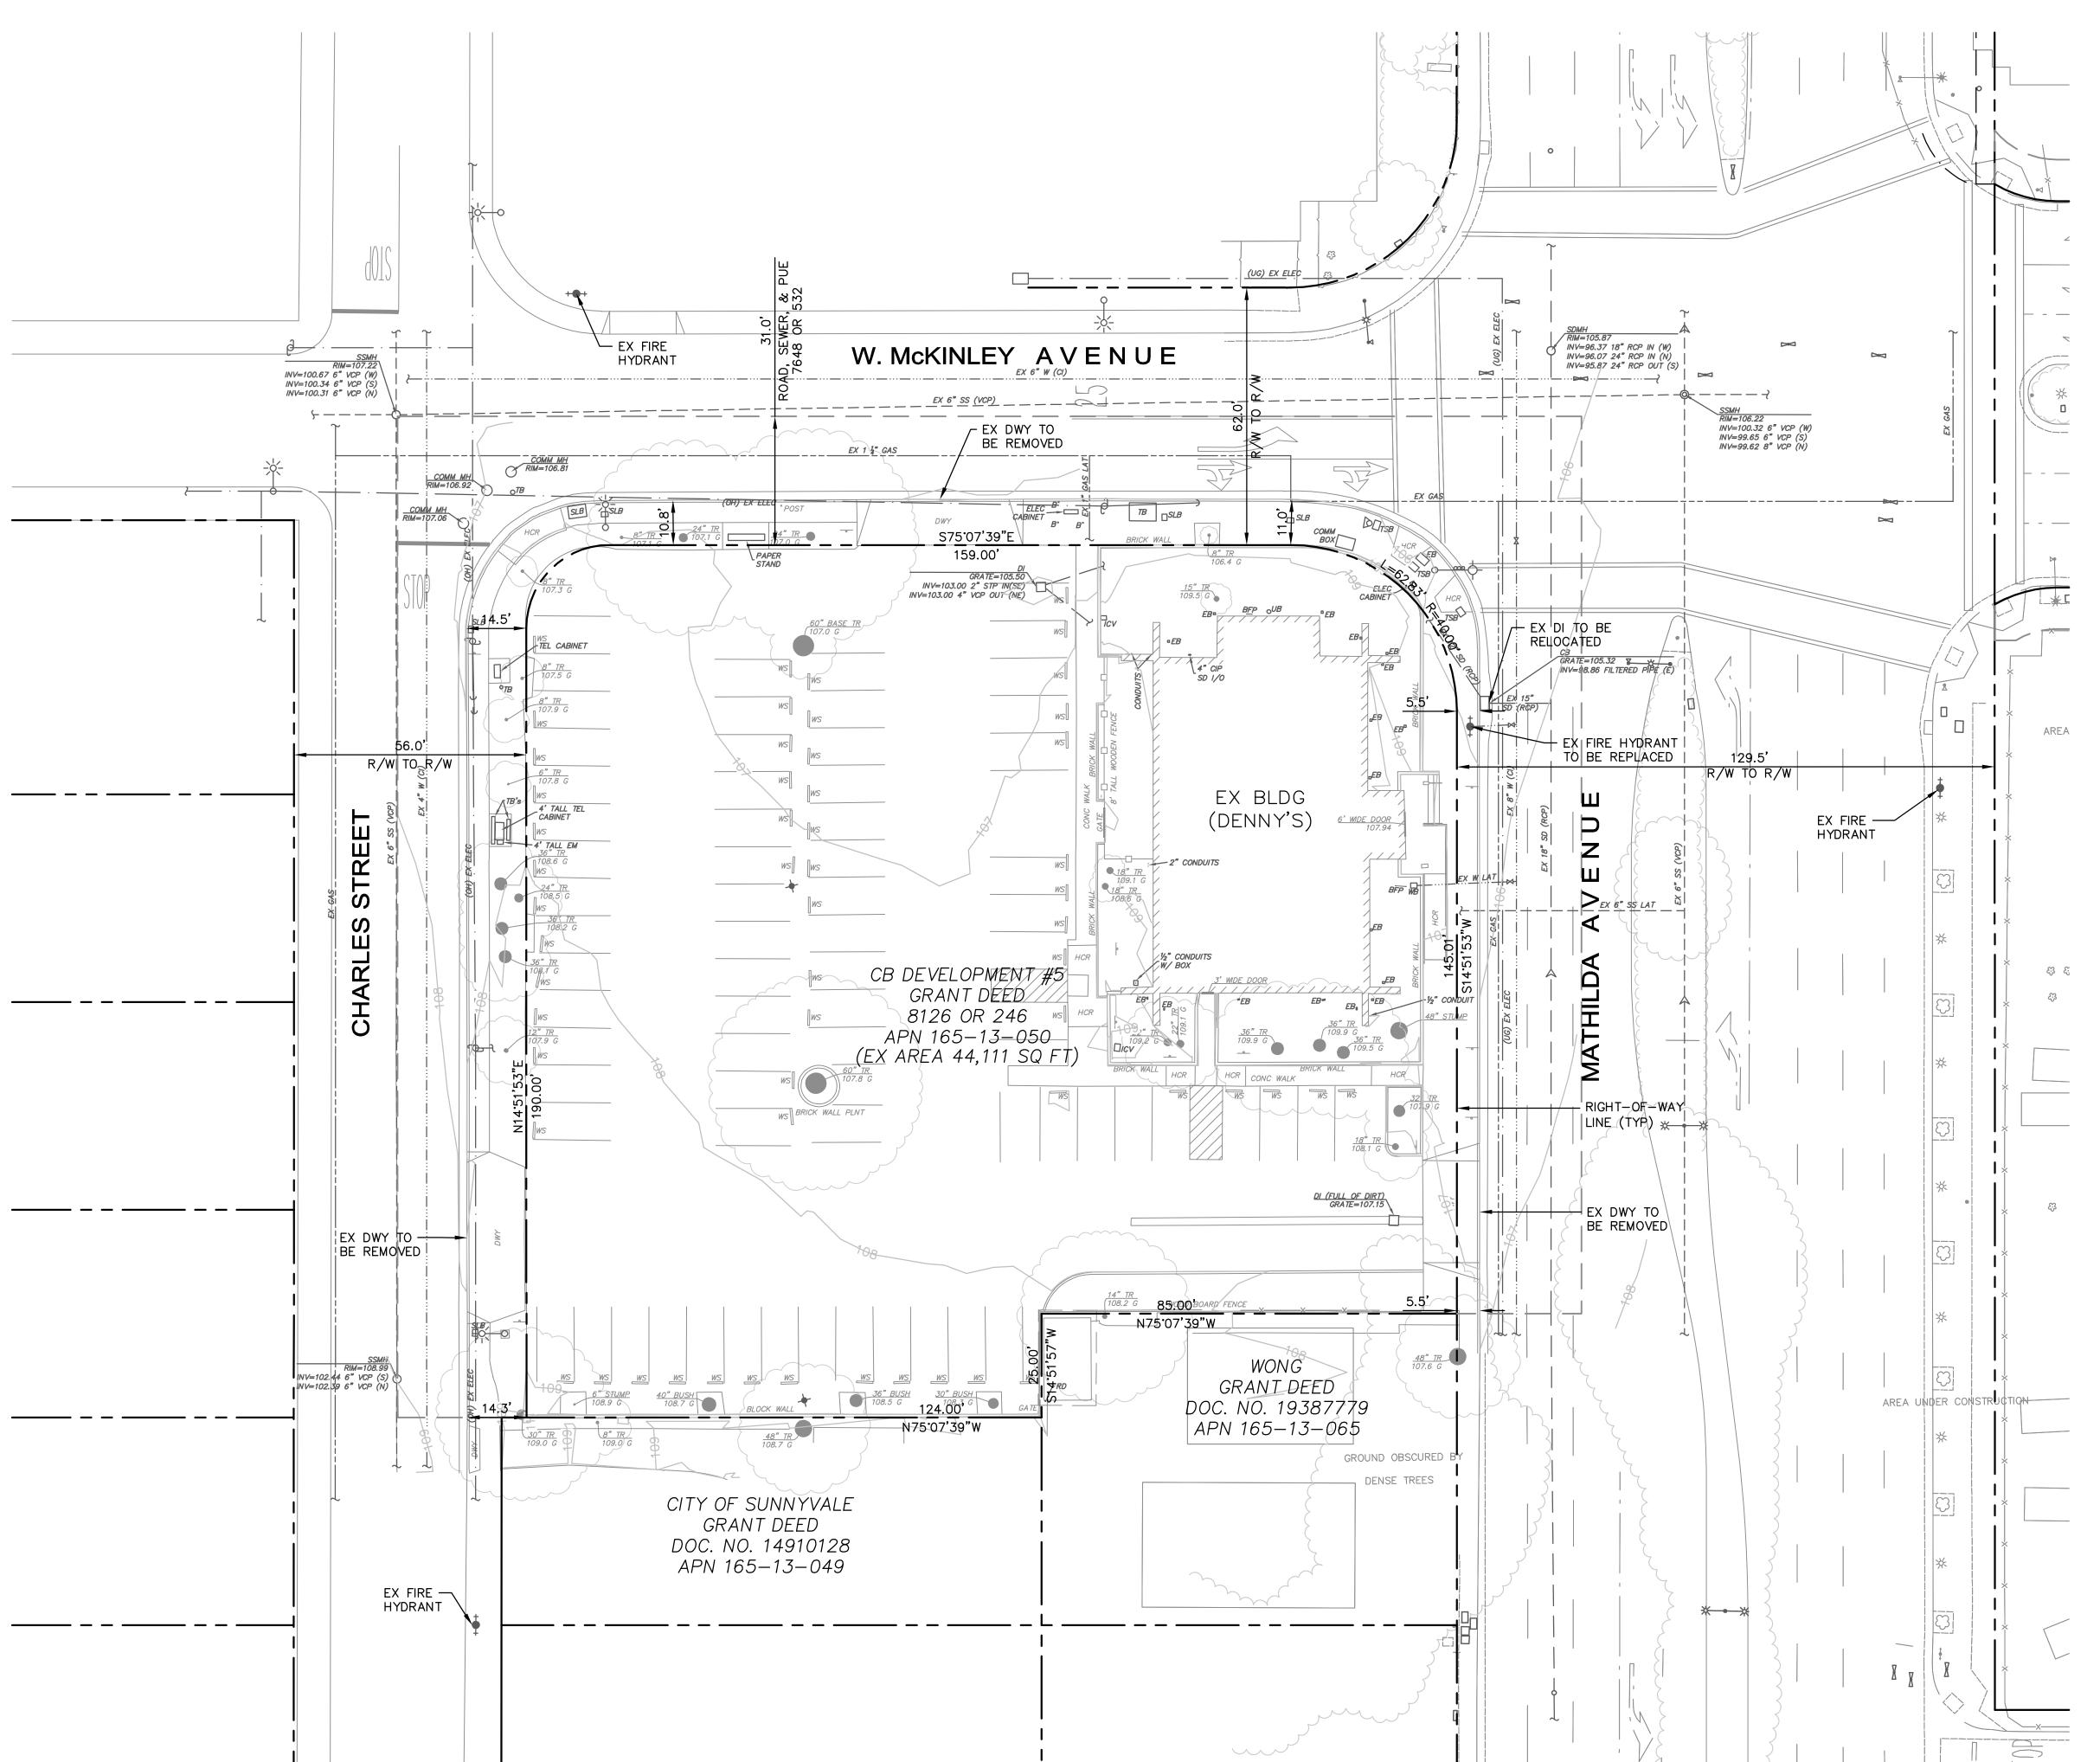

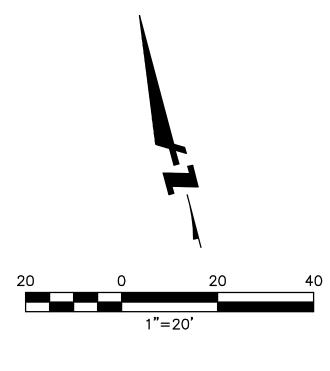

<b>LEGEND</b> :	
	PROPERTY LINE
100	EXISTING CONTOUR
<b>\$</b>	AREA/YARD LIGHT
+	ELECTROLIER
~	FIRE HYDRANT
-	SIGN
<b>-</b> - <b>♦</b> -	STREET LIGHT
$\leftarrow$	GUY WIRE
Q	JOINT POLE/POWER POLE
M	WATER VALVE

<u>~~</u>\$ ∅

LOT LINES AND TOPOGRAPHY BASED ON TOPOGRAPHIC SURVEY BY BKF ENGINEERS ON 02/01/17.

SIGNAL LIGHT

ALL DIMENSIONS ARE TO FACE OF CURB OR PROPERTY LINE UNLESS NOTED OTHERWISE.

## **ABBREVIATIONS:**

BFP COR BLDG BW CCIP COMNC EP HCV H D / H SD SSMH TELB WMS		BOLLARD BACKFLOW PREVENTOR BUILDING CORNER BACK OF WALK CATCH BASIN CONCRETE PAD CAST IRON PIPE COMMUNICATION CONCRETE DROP INLET ELECTRICAL BOX EDGE OF PAVEMENT HANDICAP RAMP IRRIGATION CONTROL VALVE MANHOLE STORM DRAIN STORM DRAIN INLET/OUTLET STORM DRAIN MANHOLE STREET LIGHTING BOX SANITARY SEWER MANHOLE TELEPHONE TRAFFIC SIGNAL BOX UTILITY BOX WATER METER
WS	=	WHEEL STOP





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Lane Partners: 644 Menlo Ave Bay West: 1725 S. Bascom Av

Mathilda


Sheet Title:

# **EXISTING** CONDITIONS PLAN

Job No. 20177004 Date: 03/21/2018 PER PLAN Scale: Drawn By: KA

Sheet No:


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> 'elopment 4025 95008 Lane Partners / Bay West Devolute Part Devolute Partners: 644 Menlo Ave, 2nd Floor, Menlo Park CA 941 Bay West: 1725 S. Bascom Ave, Suite 1050, Campbell, CA 94

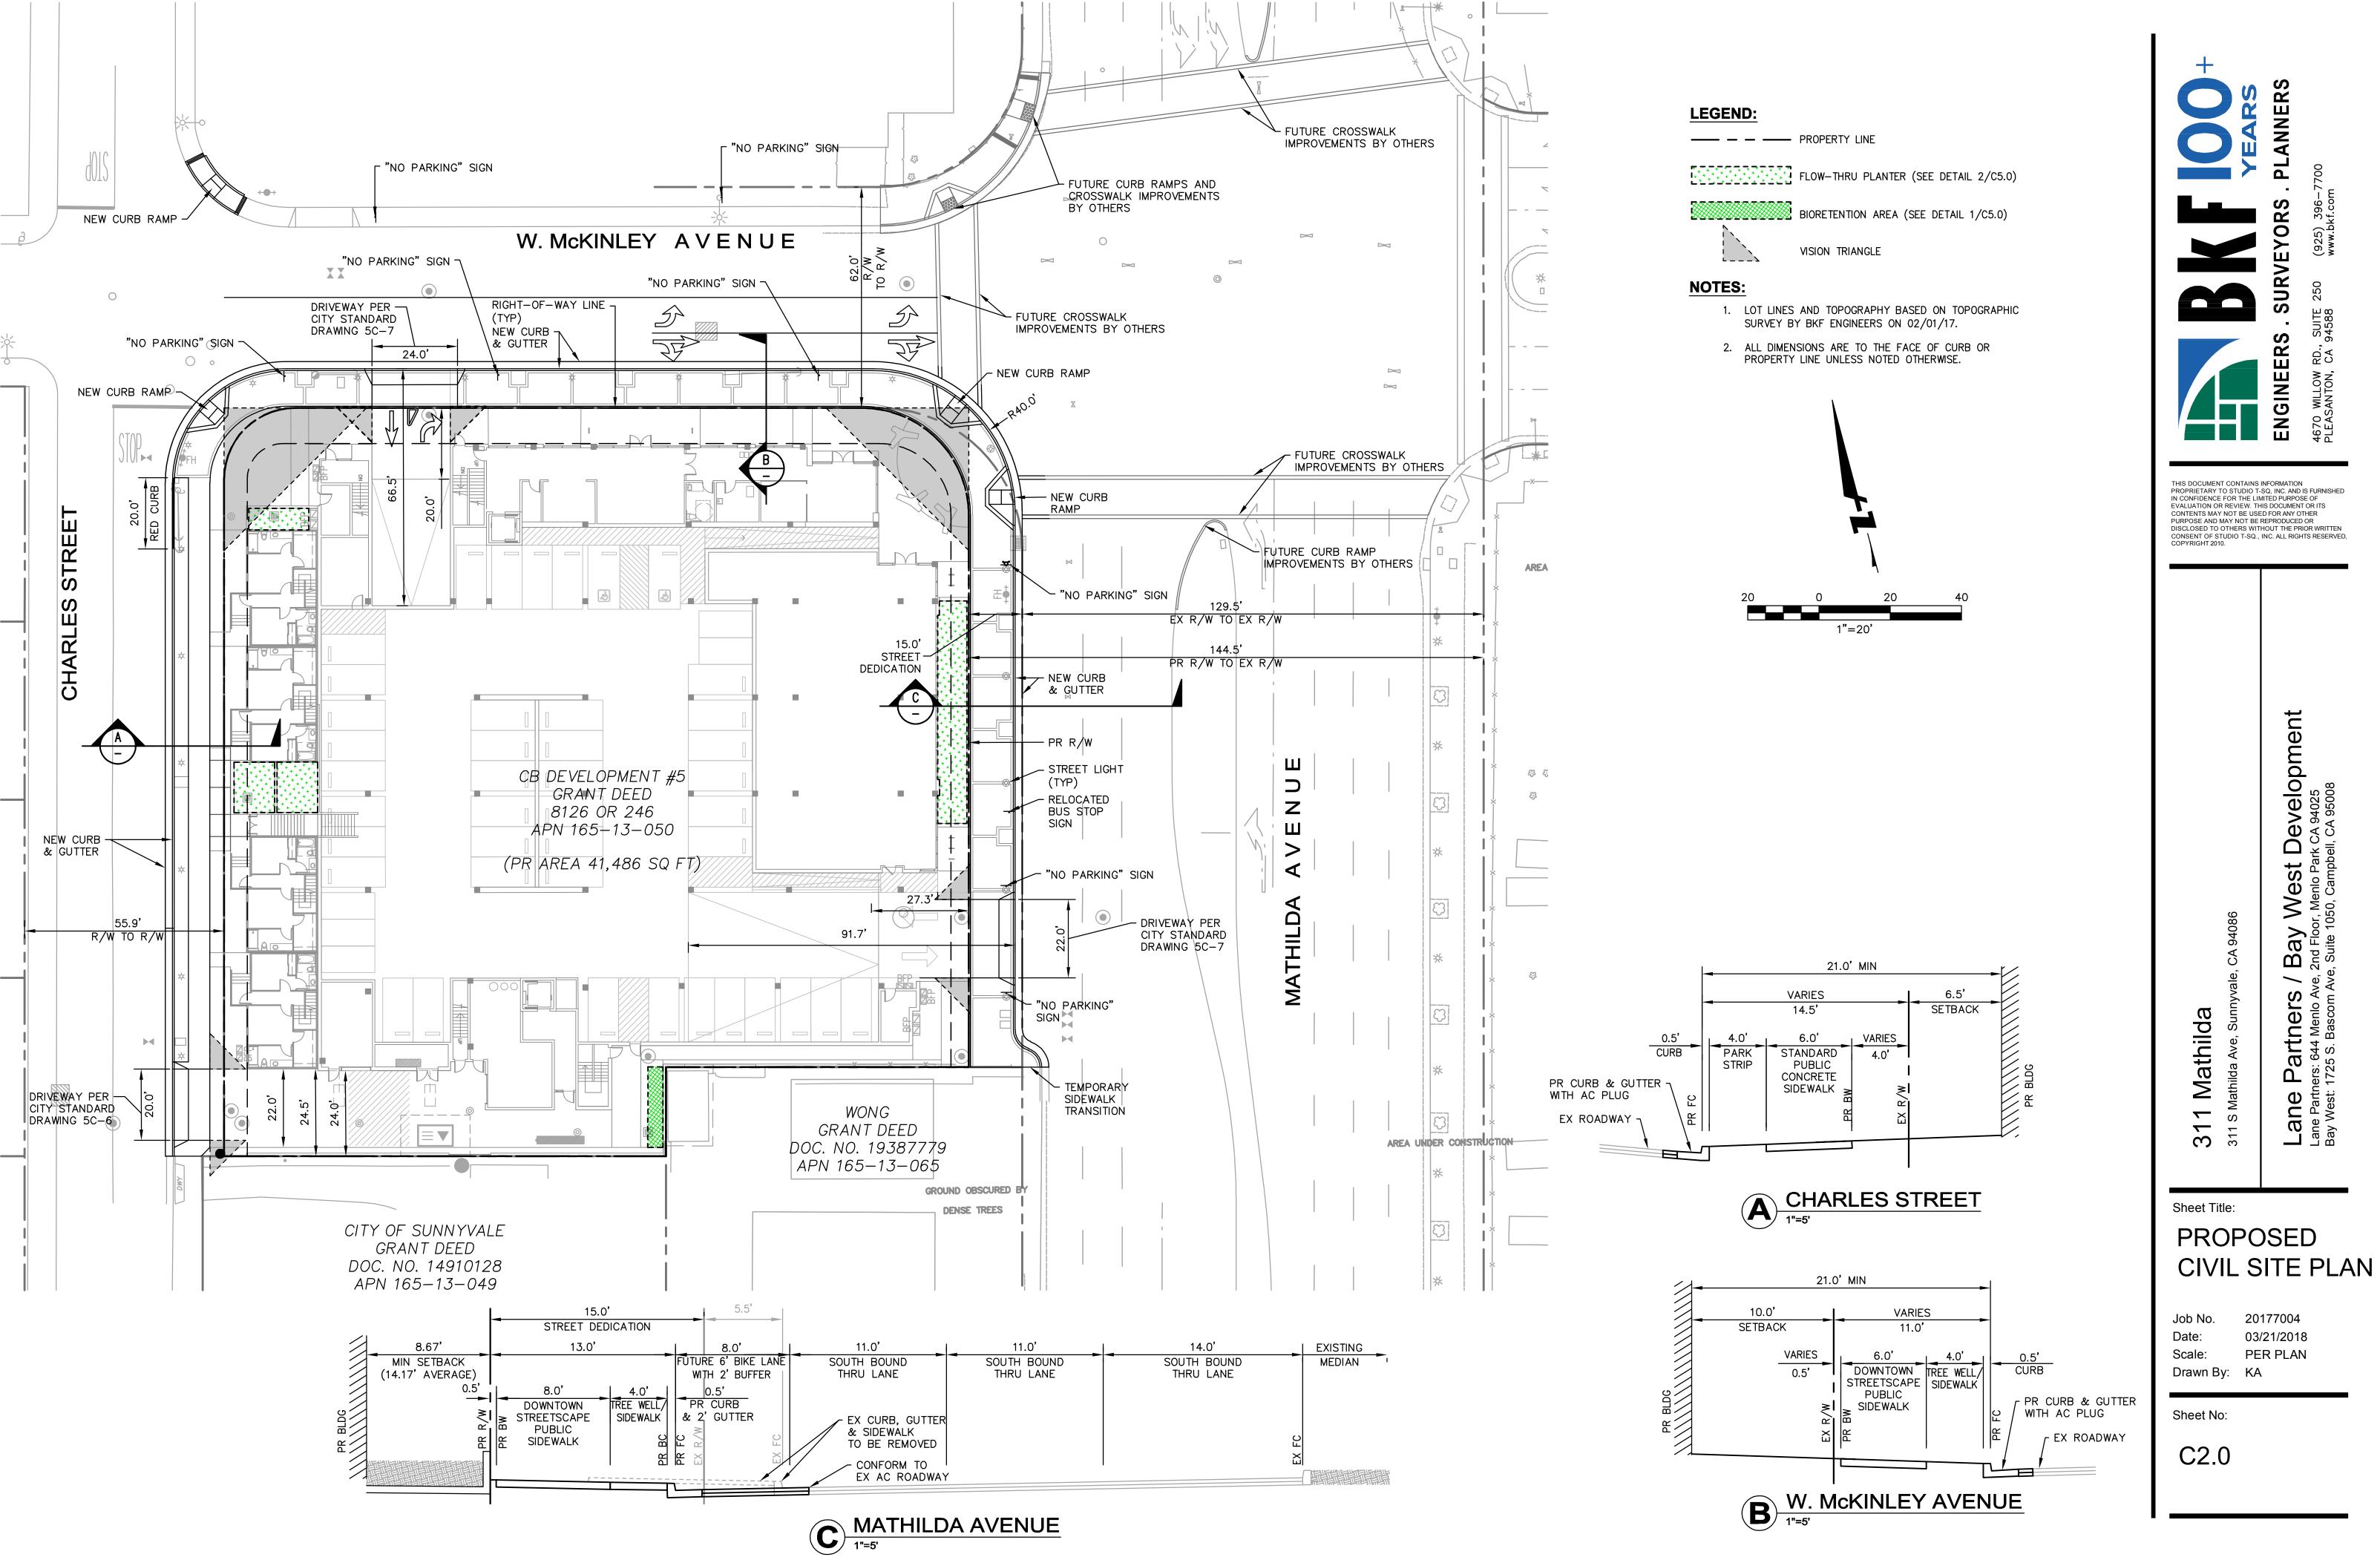20177004

03/21/2018 PER PLAN



#### **LEGEND:**

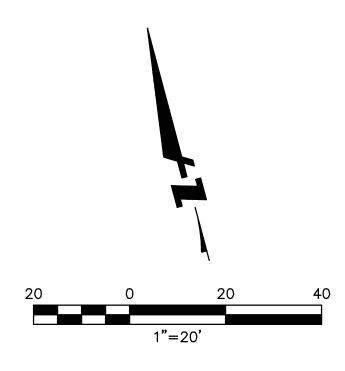---- PROPERTY LINE ---- GRADE BREAK/RIDGELINE FLOW-THRU PLANTER (SEE DETAIL 2/C5.0) BIORETENTION AREA (SEE DETAIL 1/C5.0) (XX.X)EXISTING GRADE

XX.X PROPOSED GRADE

DRAINAGE SLOPE AND DIRECTIONAL LABEL

MANHOLE


STORMWATER TREATMENT VAULT


#### **ABBREVIATIONS:**

AD CB DI AREA DRAIN CATCH BASIN DRAIN INLET EASEMENT **ESMT** INVERT LOW POINT MANHOLE STORM DRAIN STORM DRAIN MANHOLE SQ FT STV TC TYP SQUARE FEET
STORMWATER TREATMENT VAULT TOP OF CURB TYPICAL WATER

#### NOTES:

- 1. ALL GRADING WORK SHALL BE IN CONFORMANCE WITH THE PROJECT GEOTECHNICAL RECOMMENDATIONS, INCLUDING SITE STRIPPING AND OVEREXCAVATION REQUIREMENTS.
- LOT LINES AND TOPOGRAPHY BASED ON TOPOGRAPHIC SURVEY BY BKF ENGINEERS ON 02/01/17.
- 3. SEE SHEET C2.0 FOR CROSS—SECTIONS ALONG CHARLES STREET, McKINLEY AVENUE AND MATHILDA AVENUE.

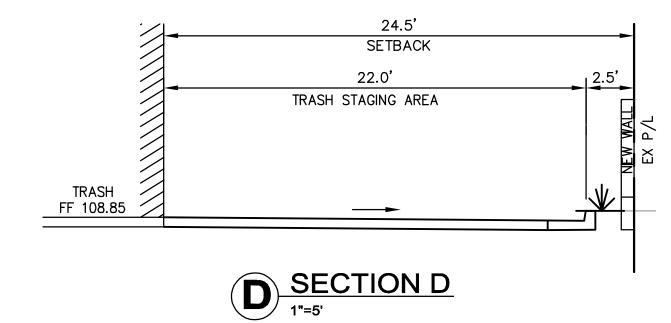

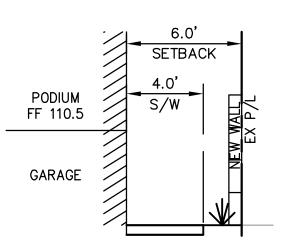



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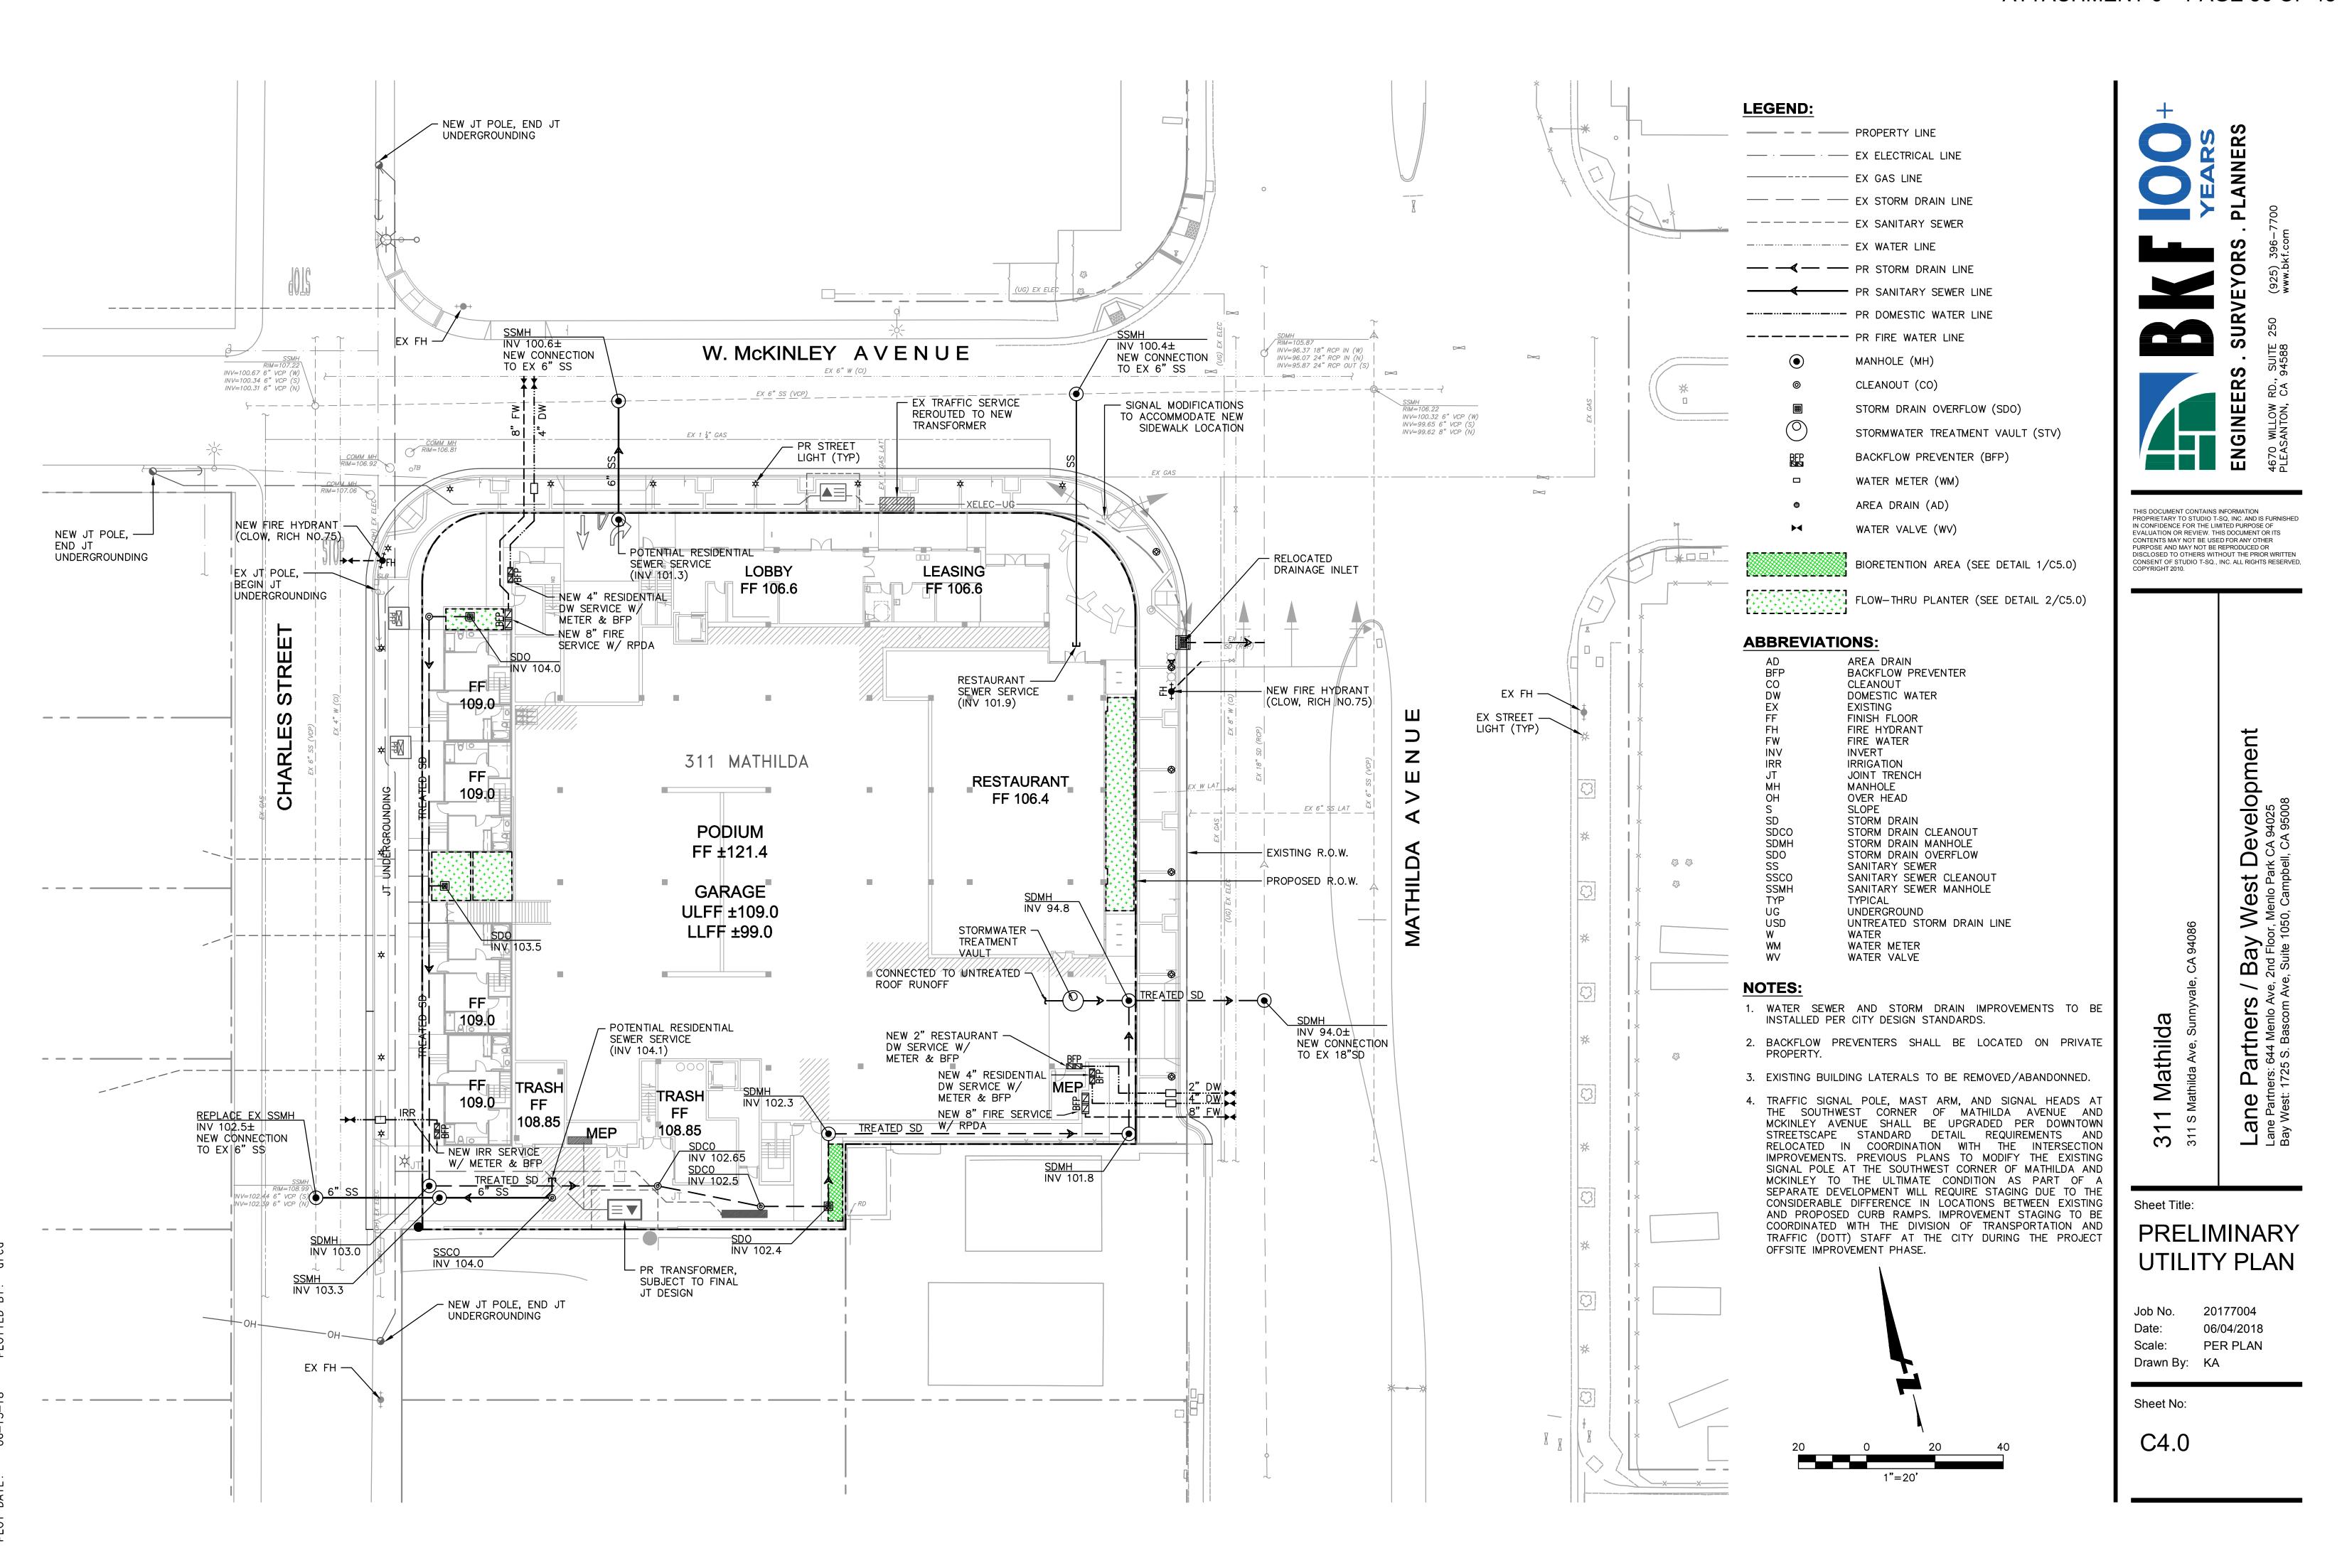
Sheet Title: PRELIMINARY **GRADING PLAN** 

20177004 Job No. 03/21/2018 Date: PER PLAN Scale: Drawn By: KA


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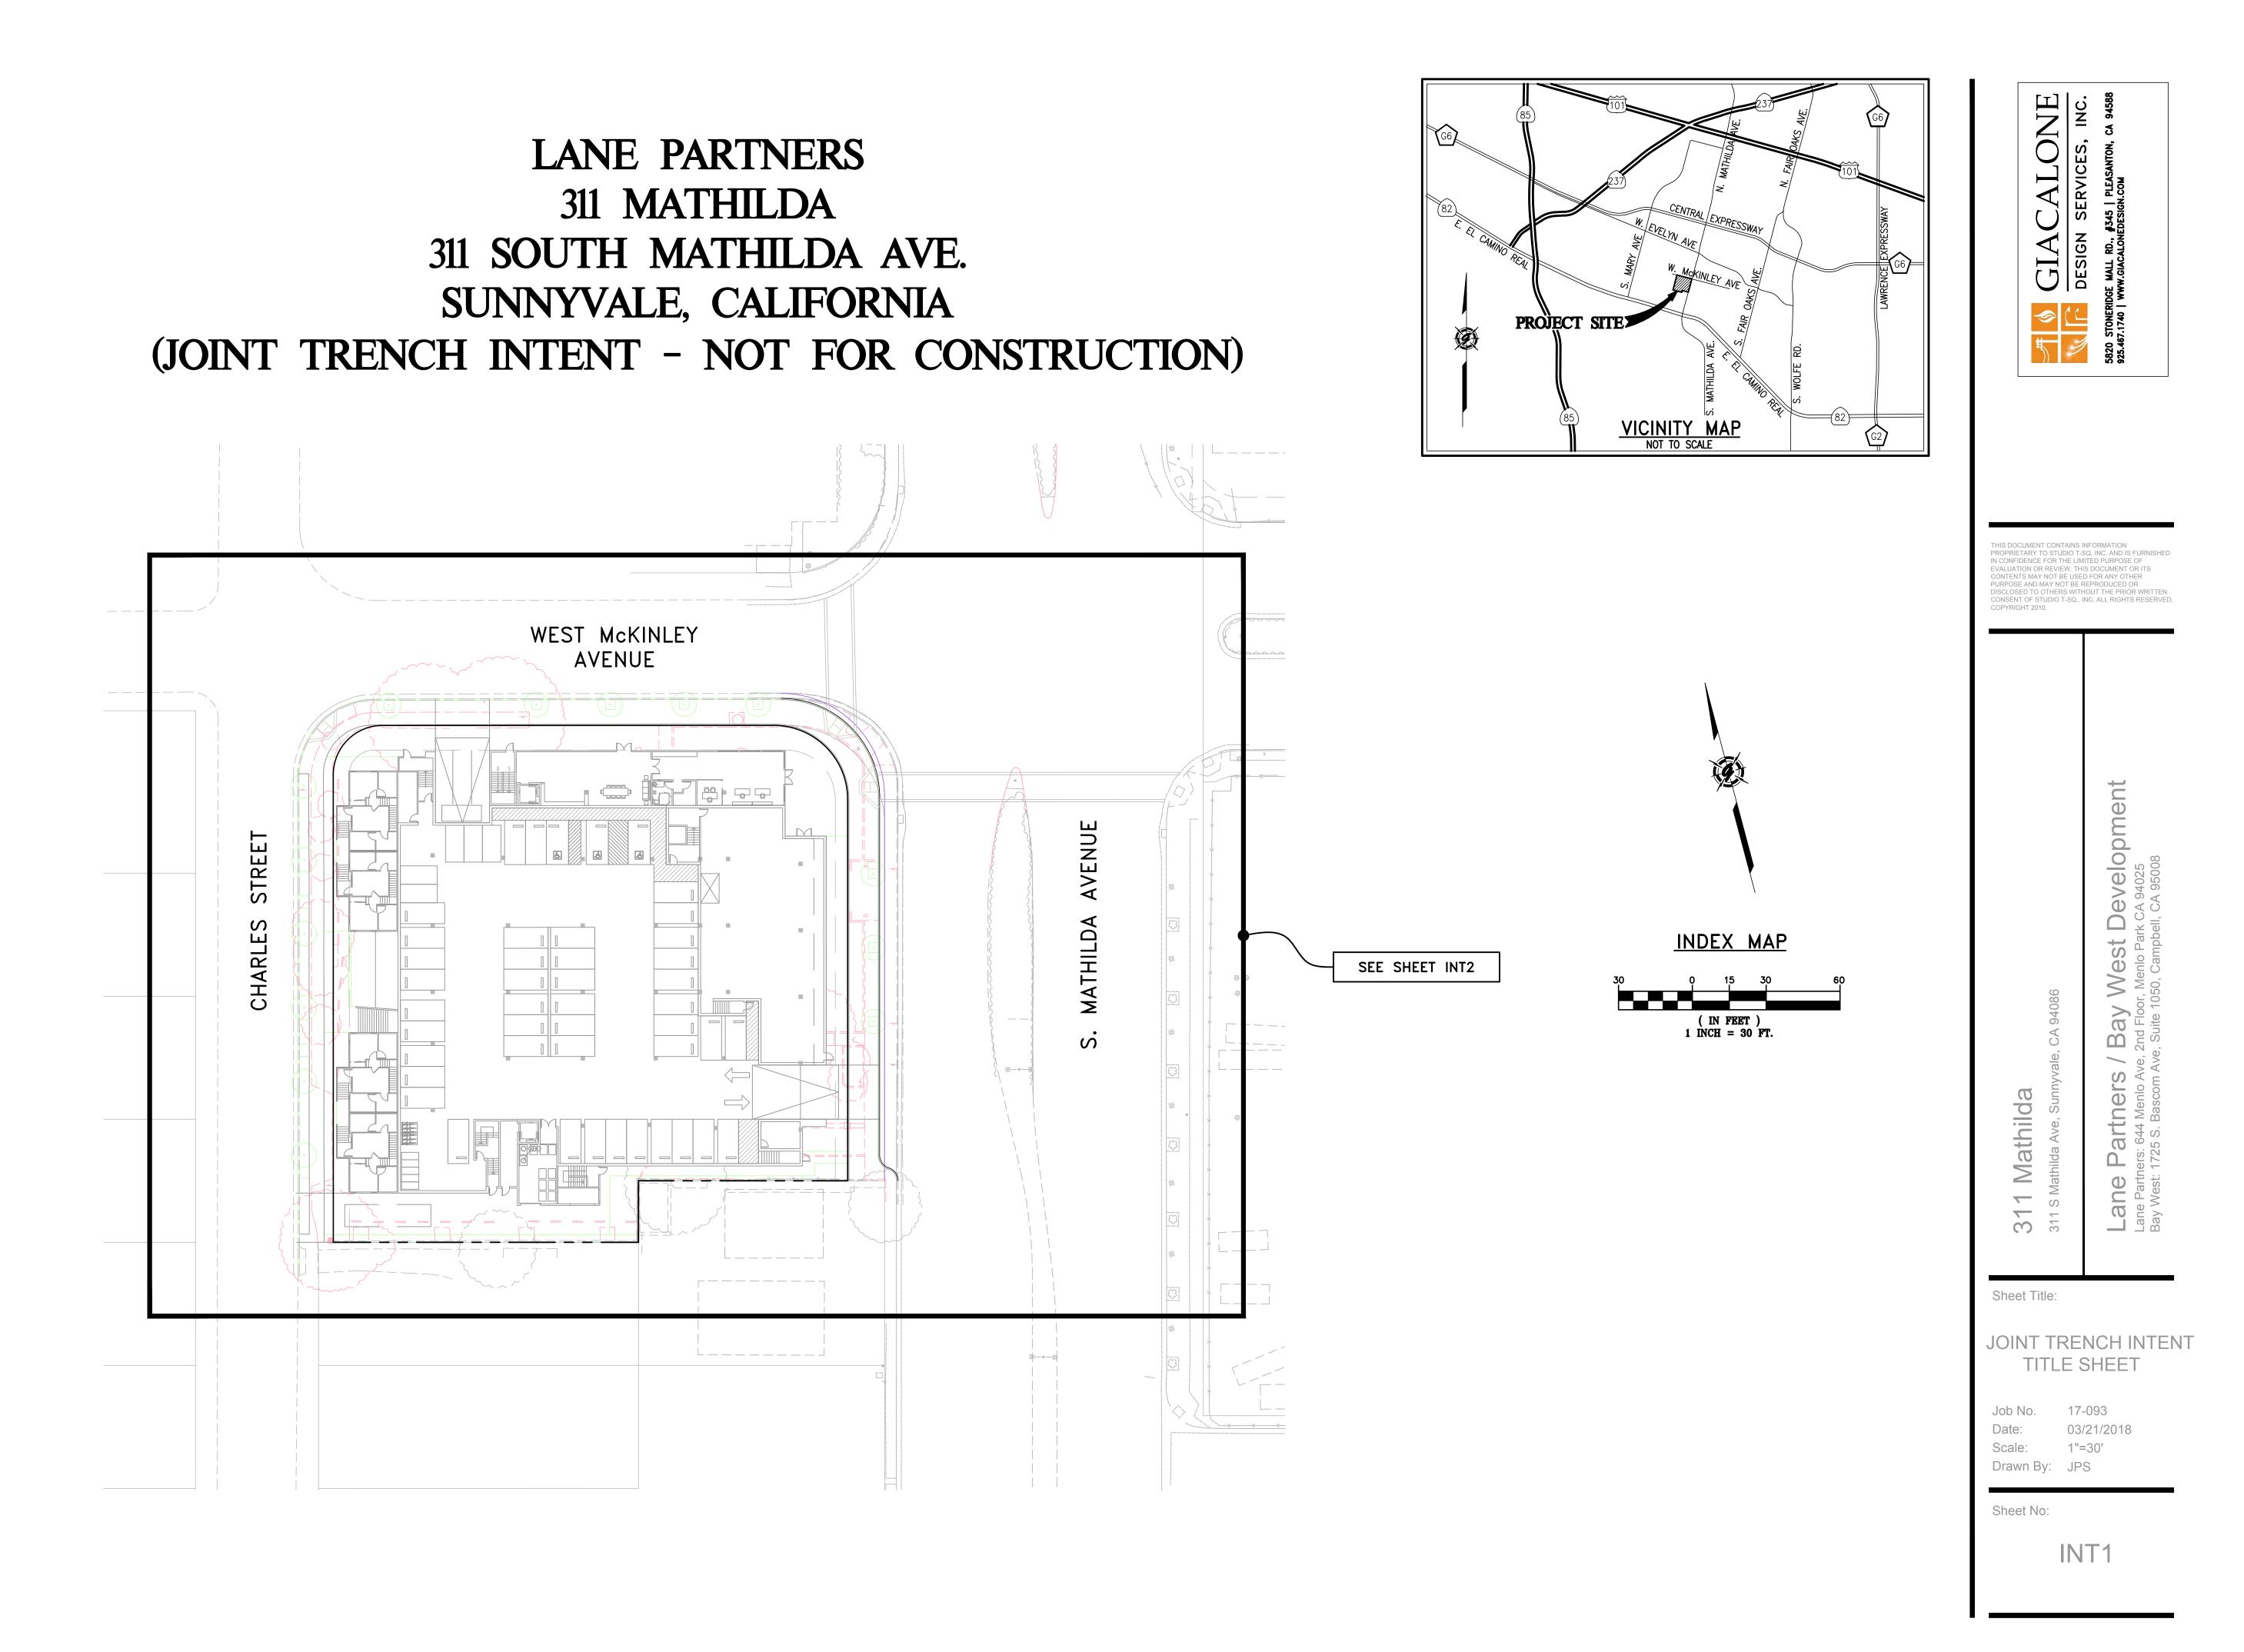
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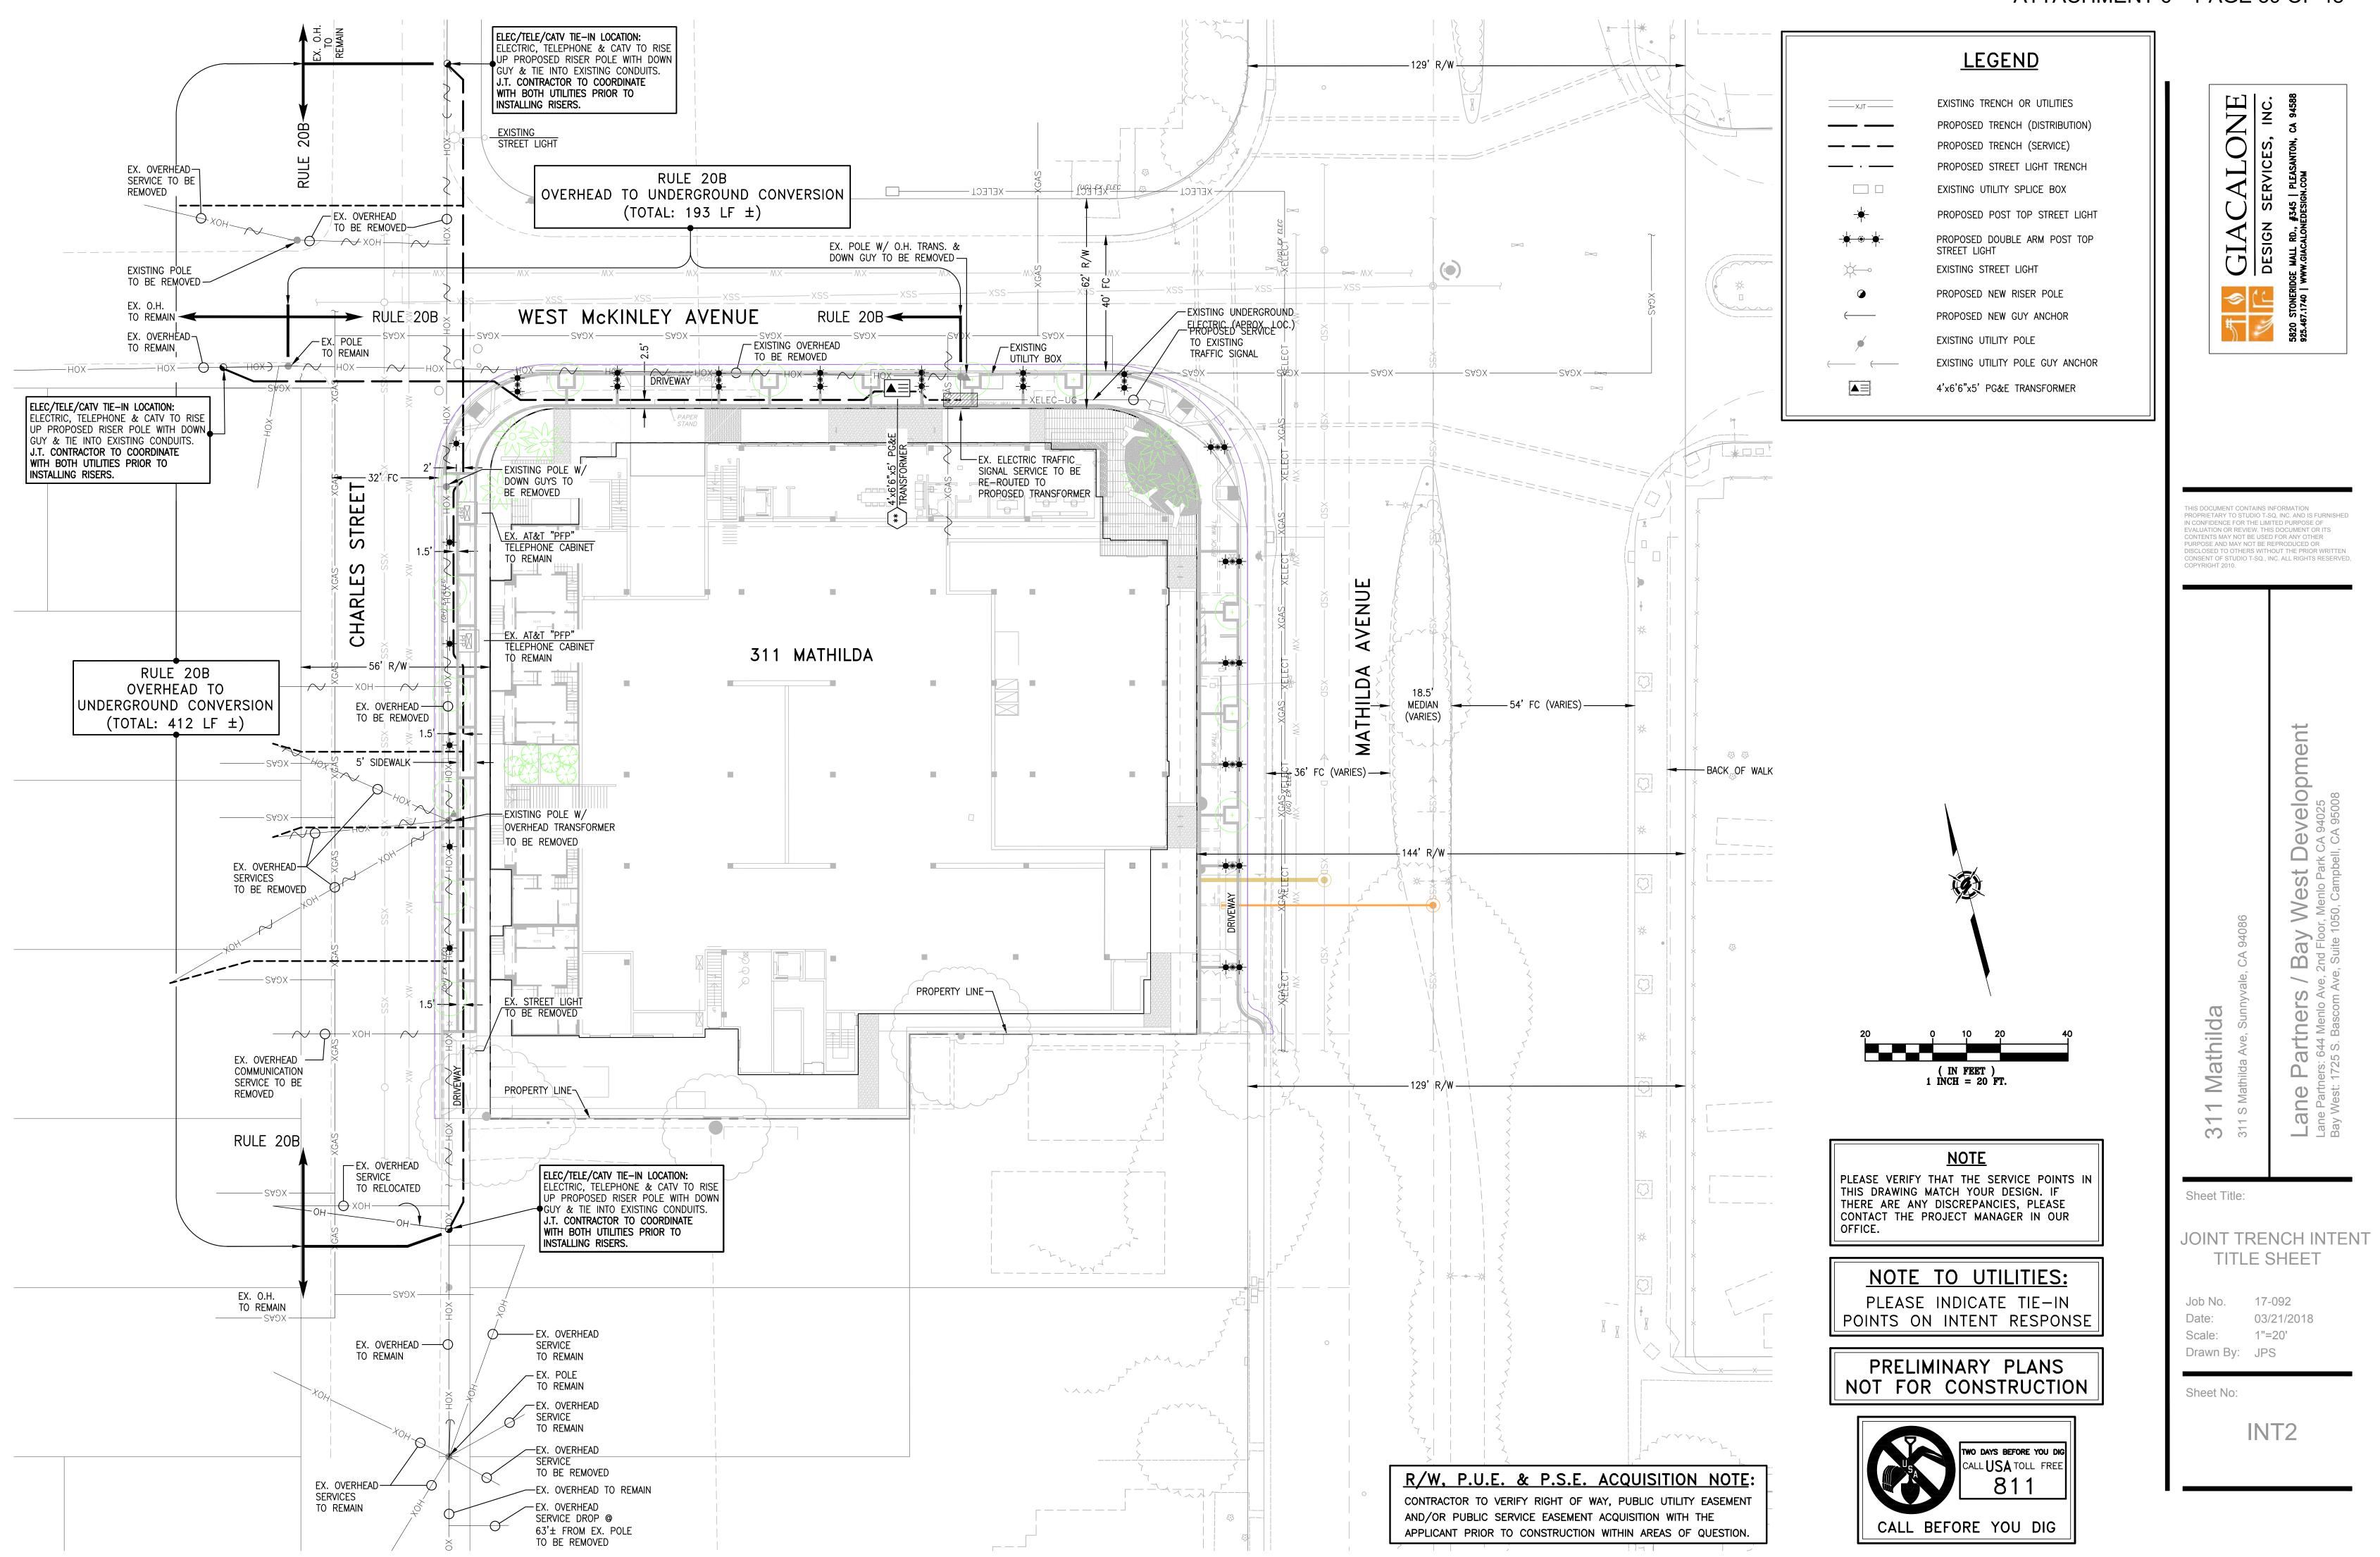
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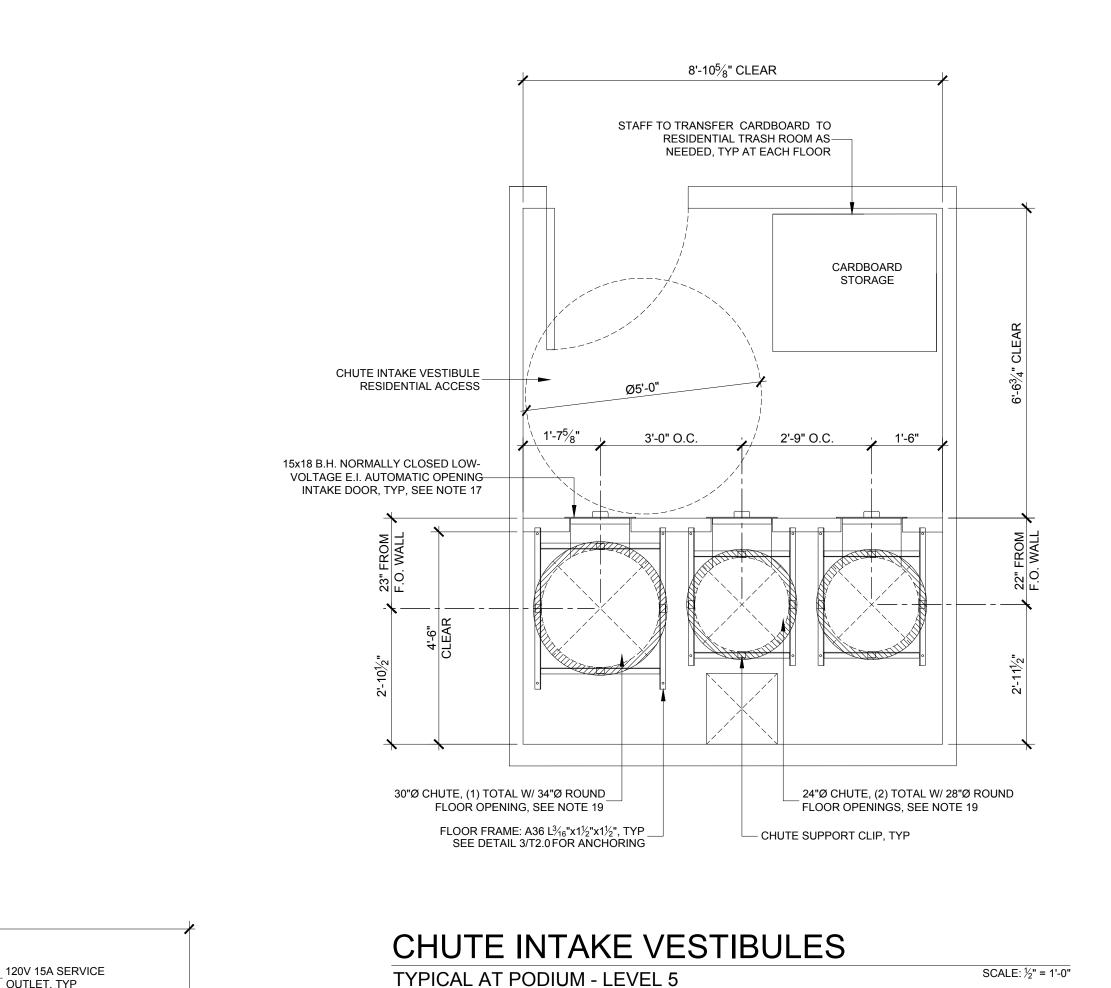
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## **PRELIMINARY** STORMWATER CONTROL PLAN

20177004 03/21/2018 PER PLAN Drawn By: KA





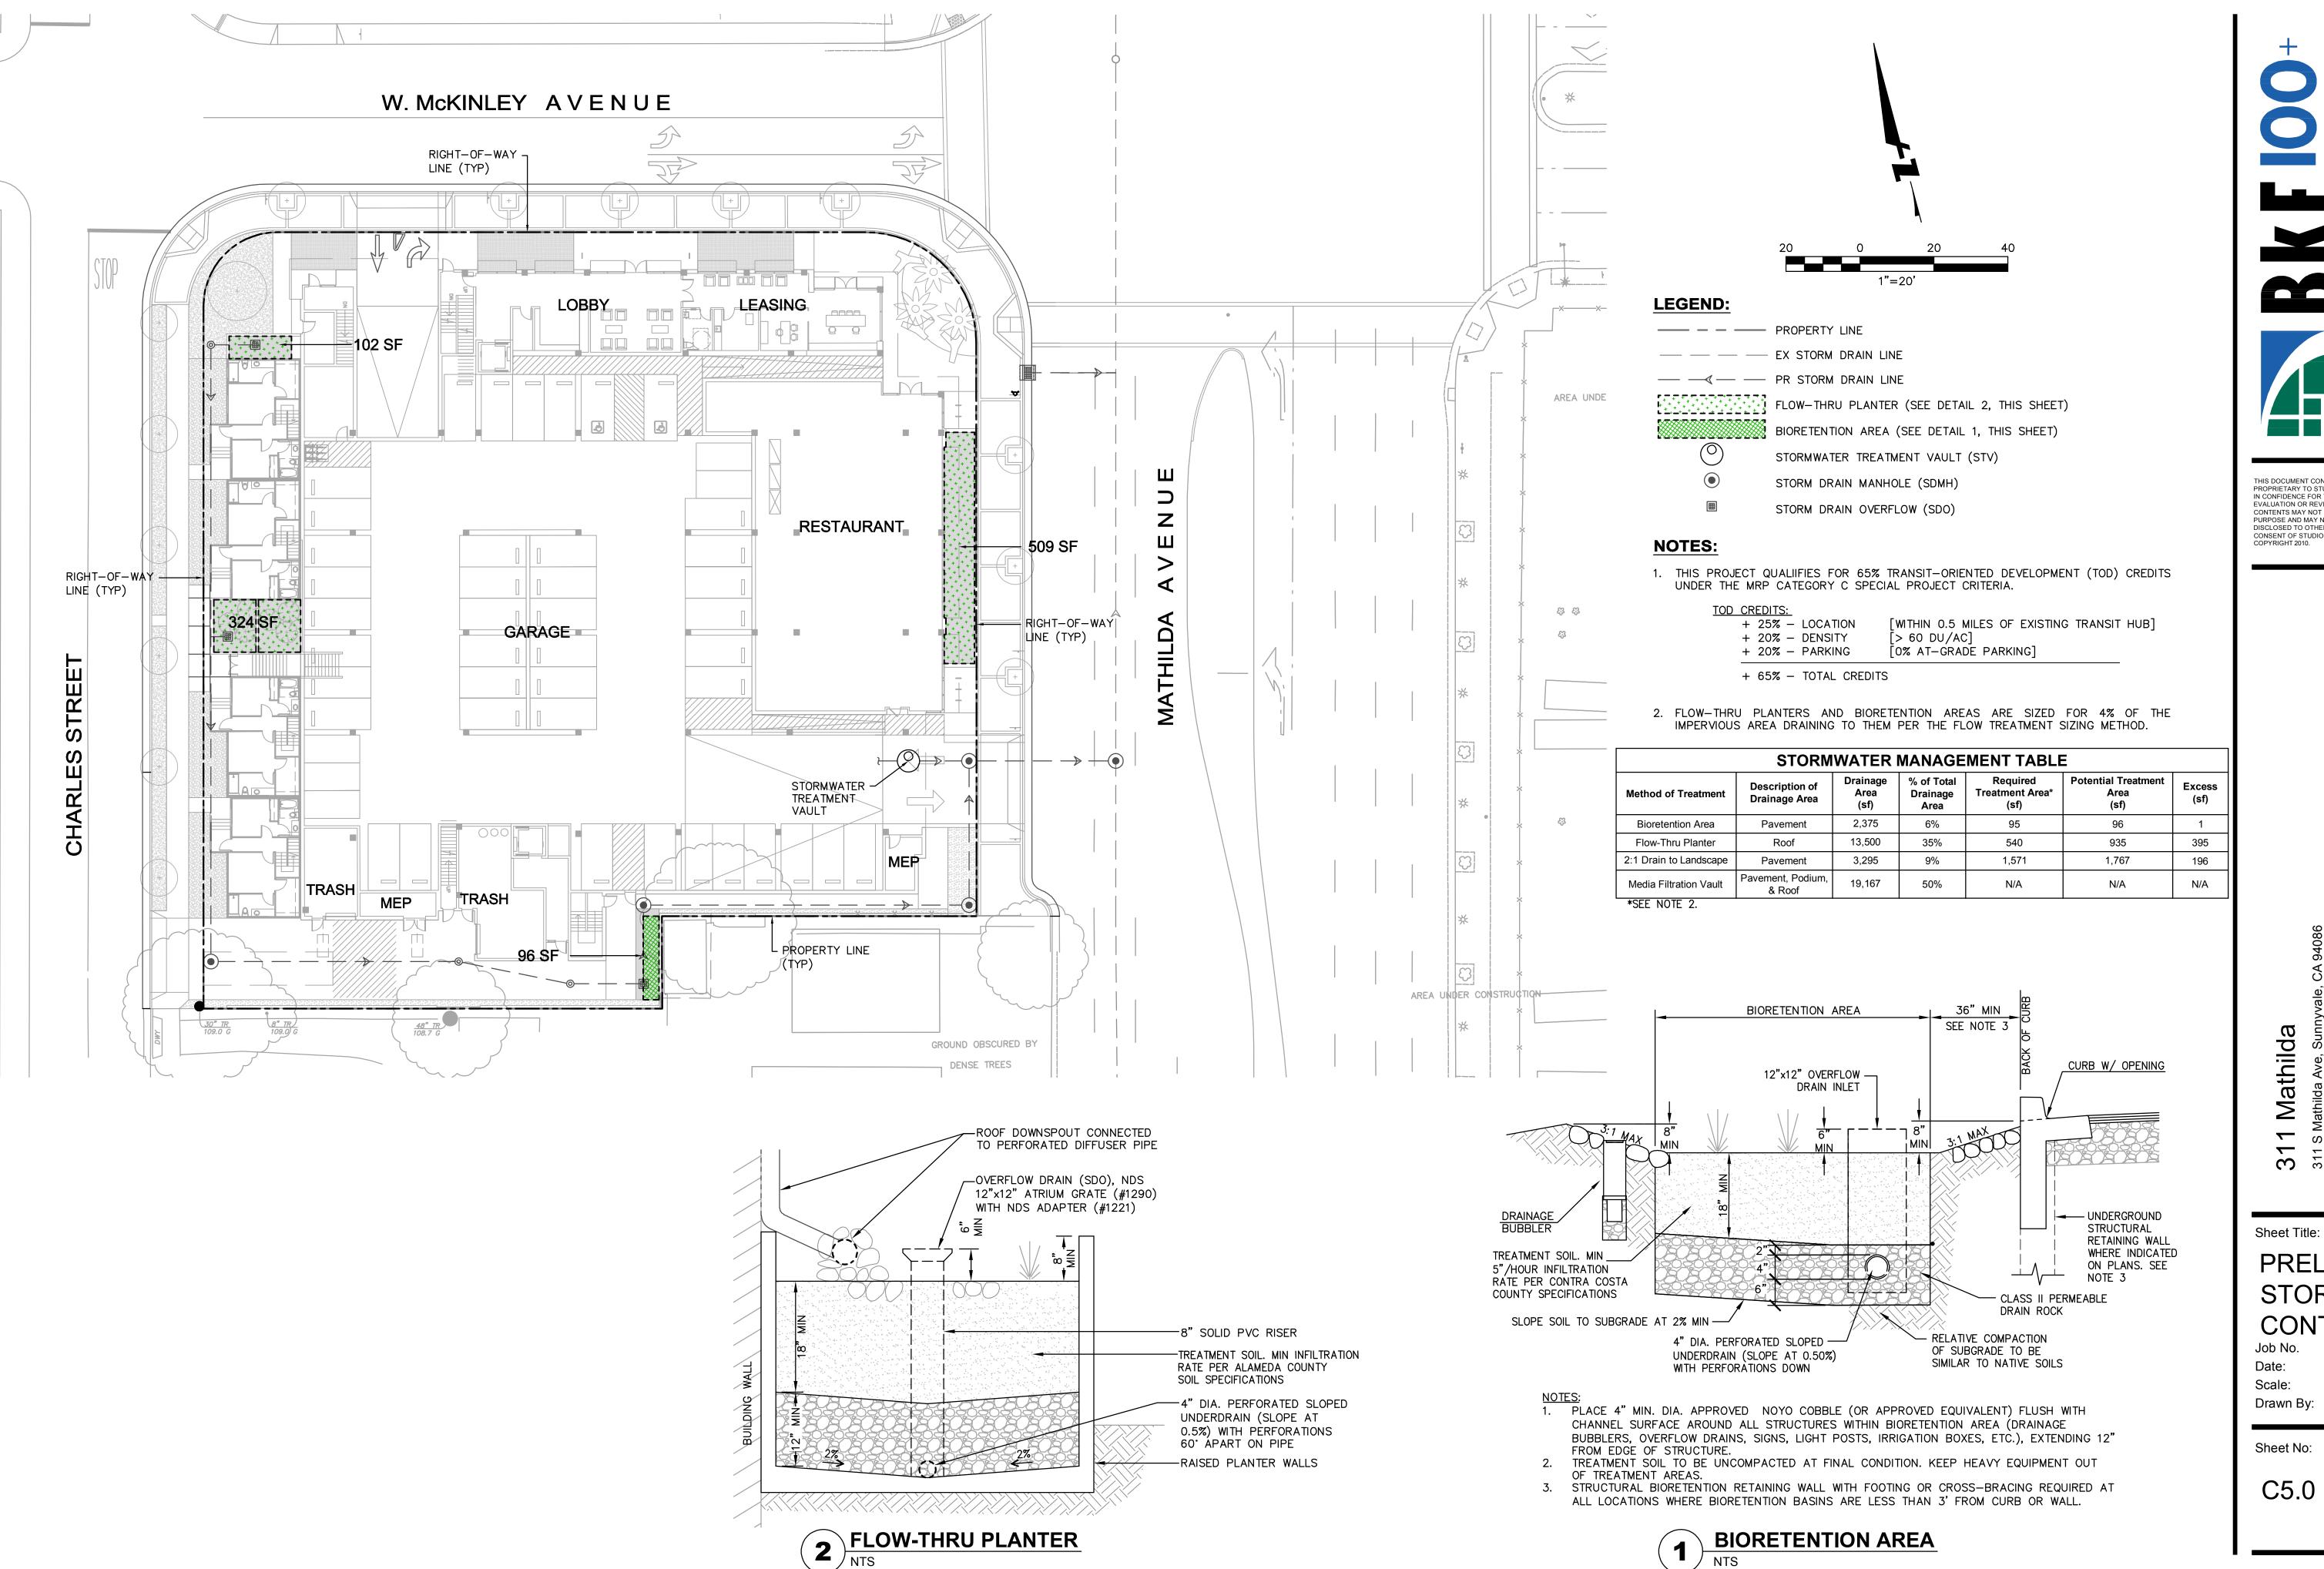

**EQUIPMENT SCHEDULE: RESIDENTIAL TRASH COLLECTION ROOM** QTY: DESCRIPTION: 5 TOTAL FLOORS GALVANIZED STEEL CHUTES: (1) 30"Ø CHUTE AND (2) 24"Ø CHUTES TOTAL FLOOR SUPPORT FRAMES (ONE AT EACH FLOOR PENETRATION) 15x18 BOTTOM HINGED, NORMALLY CLOSED LOW-VOLTAGE, ELECTRICALLY INTERLOCKED, AUTOMATIC OPENING CHUTE INTAKE DOORS TYPE-A, B-LABEL CONSTRUCTION 90 MINUTE FIRE-RATED, HORIZONTALLY INSULATED SLIDING-STEEL CHUTE DISCHARGE DOORS, HELD OPEN BY 165°F FUSIBLE LINK APOLLO MODEL A500 SINGLE-SIDE LATCH COMPACTOR COMPACTOR POWER PACK: 5HP 3-PHASE, 208/230/460V WITH 30A DISCONNECT 3 2CY FRONT-LOAD COMPACTOR CONTAINERS 3CY FRONT-LOAD LOOSE CONTAINER 12 96G LOOSE TOTER CARTS 96G LOOSE TOTER CARTS (CARDBOARD DISPOSAL AT VESTIBULES) CHUTE AIR COMPRESSOR: 2HP MOTOR CHUTE MASTER CONTROL PANEL FLOOR DRAIN ODOR CONTROL UNIT HOT AND COLD HOSE BIBB 8'-0" ROLL-UP DOOR 3'-0" FIRE EGRESS DOOR BIG JOE D40 ELECTRIC PALLET TRUCK

PROJECTED COLLECTION SCHEDULE: RESIDENTIAL TRASH COLLECTION ROOM				
SERVICE:	CONTAINER VOL / TYPE:	FREQUENCY:		
WASTE	(2) 2CY FL COMPACTOR CONTAINERS	2x/wk		
CARDBOARD	(1) 3CY FL LOOSE CONTAINER	2x/wk		
PAPER RECYCLING	(8) 96G LOOSE TOTER CARTS	2x/wk		
CONTAINER RECYCLING	(4) 96G LOOSE TOTER CARTS	2x/wk		

\_\_30"Ø CHUTE (1) TOTAL

CHUTE DISCHARGE

DOOR, SEE NOTE 15

COMPACTOR ACCESS DOOR

A A A A A A

SECTION B-B

2CY FL COMPACTOR CONTAINER WASTE

# FLOOR TO HAVE MINIMAL SLOPE AND FLOOR DRAIN. FLOOR LEVEL UNDER

1. TRASH COLLECTION ROOM IS PART OF 2HR FIRE-RATED TRASH CHUTE SHAFT -RESTRICTED ACCESS. FF: +3'-0". 2. FLOOR SHALL BE FINISHED WITH ELASTO-DECK 6001 AL-HT DECK COATING.

RESIDENTIAL TRASH COLLECTION ROOM: STREET LEVEL

- WALLS SHALL BE FINISHED WITH WASHABLE WATERPROOF SURFACE SUCH AS
- FRP OR HIGH-GLOSS ENAMEL PAINT, 8'-0" AFF. 4. INSTALL WALL PROTECTION: 10"Hx6W" CONCRETE CURB AT BASE OF WALLS. DO
- NOT INSTALL CURB ON WALL AT END OF COMPACTOR OR POWER PACK. INSTALL 8'-0" ROLL-UP DOOR AND 3'-0" FIRE EGRESS DOOR ROOM SHALL BE MECHANICALLY VENTILATED WITH (1) CFM/FT PER 2016 CBC.
- (1) 30"Ø GRAVITY CHUTE WITH (1) COMPACTOR FOR WASTE PROVIDE 2CY CONTAINER. (2) 24"Ø GRAVITY CHUTES WITH 96G TOTER CARTS FOR PAPER AND CONTAINER RECYCLING. ALL CHUTES SHALL BE304 S.S.
- 30"Ø CHUTE: TERMINATE75" AFF; 24"Ø CHUTES: TERMINATE 54" AFF. 9. PP: COMPACTOR POWER PACK SHALL BE WALL-MOUNTED 60" AFF. (1) 5HP 3-PHASE, 208/230/460V. 30A DISCONNECTS 60" AFF.
- 10. MCP: CHUTE MASTER CONTROL PANEL SHALL BE WALL-MOUNTED 60" AFF. MUST ALLOW LOCK DOWN OF CHUTE INTAKES FOR EXCHANGING CONTAINERS AND WASHING CHUTES.
- 12. OC: ODOR CONTROL UNIT SHALL BE WALL-MOUNTED 60" AFF. 13. HB: HOT AND COLD HOSE BIBB SHALL BE WALL-MOUNTED 60" AFF. 14. PROVIDE ELECTRIC PALLET TRUCK FOR TRANSFERRING CONTAINERS. 4000lb
- CAPACITY; TURNING RADIUS: 45.5". 15. CHUTE DISCHARGE DOOR: TYPE-A, B-LABEL CONSTRUCTION 90 MINUTE

11. AC: 2HP CHUTE AIR COMPRESSOR SHALL BE WALL-MOUNTED 60" AFF.

FIRE-RATED, HORIZONTALLY INSULATED SLIDING-STEEL DOOR, HELD OPEN BY 165°F FUSIBLE LINK. 16. 120V, 15A SERVICE OUTLET REQUIRED FOR ALL EQUIPMENT (U.O.N.).

### CHUTE INTAKE VESTIBULES: TYPICAL AT PODIUM - LEVEL 5

- 17. CHUTE INTAKE VESTIBULES SHALL BE 1HR FIRE-RATED WITH 1HR FIRE-RATED DOOR; 5'-0" MIN REQUIRED PER ADA STANDARDS - RESIDENTIAL ACCESS. PROVIDE (3) 15x18 BOTTOM HINGED, NORMALLY CLOSED LOW-VOLTAGE, ELECTRICALLY INTERLOCKED, AUTOMATIC OPENING CHUTE INTAKE DOORS AT EACH FLOOR, SEE DETAIL 1/T2.0.
- SOUND PROOFING PURPOSES, DOUBLE STUD-WALLS ARE REQUIRED ADJACENT TO OCCUPIED SPACES. INTERIOR OF SHAFT SHALL BE TAPED TO PREVENT ODOROUS AIR LEAKING INTO OCCUPIED SPACES.

18. CHUTE SHAFT SHALL NOT BE ERECTED UNTIL CHUTE HAS BEEN INSTALLED. FOR

19. CHUTE SUPPORT FLOOR FRAME: ROUND FLOOR OPENINGS AT CONCRETE FLOORS, AND SQUARED FLOOR OPENINGS AT WOOD-FRAME CONSTRUCTION. 24"Ø CHUTE: 35" LONG FLOOR FRAME. 30"Ø CHUTE: 41" LONG FLOOR FRAME.

#### **GENERAL NOTES:**

**SHEET NOTES:** 

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- CONTRACTOR SHALL FIELD VERIFY ALL DIMENSIONS AND CONDITIONS PRIOR TO START OF CONSTRUCTION. THE ARCHITECT SHALL BE PROMPTLY NOTIFIED OF ANY INCONSISTENCIES AND/OR DISCREPANCIES.

Planning **Urban Design** 

Architecture

304 12th Street, Suite 2A Oakland, California 94607 (510) 451 - 2850

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415.292.5410 Fax

Consultant

**BUILDING PERMIT SUBMITTAL** 09/06/2017

03/16/2018

PLAN CHECK RESPONSE

TRASH MANAGEMENT

1900 POWELL STREET, SUITE 890 EMERYVILLE, CALIFORNIA 94608 P: 415.292.5400 F: 415.292.5410 SBROWN@TRASHMANAGE.COM

CHUTE DISCHARGE DOOR, SEE NOTE 15

96G CART

SECTION C-C

SCALE: ½" = 1'-0"

RESIDENTIAL TRASH COLLECTION PLAN

STREET LEVEL

Job No. 16044 Date: 03/16/2018 Scale: AS INDICATED

Sheet No:

 $6'-7\frac{1}{8}$ "± FROM F.O. WALL 3'-0" O.C. 2'-9" O.C. 30"Ø CHUTE (1) TOTAL (2) TOTAL CHUTE DISCHARGE DOOR TYP, SEE NOTE 15 CONTAINER REC PAPER REC APOLLO MODEL A500 SSL COMPACTOR 2CY CONTAINER NOT SHOWN FOR-14'-1<sup>5</sup>/<sub>8</sub>" CLEAR

SECTION A-A

NOTE: SEE RESIDENTIAL TRASH COLLECTION ROOM PLAN FOR TRASH EQUIPMENT OR ANY OTHER INFORMATION NOT SHOWN IN SECTIONS.

SECTIONS

NOTE: SEE ARCHITECTURAL DRAWINGS FOR ALL DIMENSIONS NOT NEEDED FOR PLACEMENT OF TRASH EQUIPMENT.

RESIDENTIAL TRASH COLLECTION ROOM STREET LEVEL

3'-0" O.C. 2'-9" O.C. 1'-9½"

96G CART

COMPACTOR

CONTAINER

WASTE

CONT REC

**BIG JOE D40 PALLET** 

RESIDENTIAL TRASH COLLECTION ROOM RESTRICTED ACCESS

96G WASTE CART FROM REMOTE TRASH ROOM

96G CART

PAPER RECYCLING

MOBILE HYDRAULIC

CART DUMPER

RECYCLING

TRUCK, SEE NOTE 14

96G CART

PAPER REC

WALL PROTECTION TYP SEE NOTE 4

24"Ø CHUTES

8'-9<sup>7</sup>/<sub>8</sub>"

96G CART

CONTAINER

RECYCLING

96G CART

CONTAINER

RECYCLING

SPARE 2CY FL

CONTAINER

96G CART

RECYCLING

96G CART

RECYCLING

OUTLET, TYP

CONTAINER

RECYCLING

SPARE 2CY FL

CONTAINER

3CY FL LOOSE CONTAINER

CARDBOARD

(2) TOTAL

6'-7<sup>1</sup>/<sub>8</sub>"

96G CART

RECYCLING

PAPER RECYCLING

96G CART PAPER RECYCLING

STRUCTURAL COLUMN

3'-0" FIRE EGRESS

30"Ø CHUTE W/ WILKINSON

MODEL A500 SSL COMPACTOR

AT RESIDENTIAL TRASH COLLECTION ROOM

SCALE: ½" = 1'-0"

EQUIPMENT SCHEDULE: RESTAURANT TRASH COLLECTION ROOM		
QTY:	DESCRIPTION:	
5	TOTAL FLOORS	
1	2CY FRONT-LOAD LOOSE - FOOD SCRAPS	
1	3CY FRONT-LOAD LOOSE - CARDBOARD	
2	4CY FRONT-LOAD LOOSE - WASTE	
1	50G DRUM (HOT GREASE)	
1	FLOOR DRAIN	
1	ODOR CONTROL UNIT	
1	HOT AND COLD HOSE BIBB	
1	BIG JOE D40 ELECTRIC PALLET TRUCK	

PROJECTED COLLECTION SCHEDULE: RESTAURANT TRASH COLLECTION ROOM				
CONTAINER VOL / TYPE:	FREQUENCY:			
(2) 4CY FL LOOSE CONTAINER	2x/wk			
(1) 3CY FL LOOSE CONTAINER	2x/wk			
(1) 2CY FL LOOSE CONTAINER	2x/wk			
	CONTAINER VOL / TYPE:  (2) 4CY FL LOOSE CONTAINER  (1) 3CY FL LOOSE CONTAINER			

EQUIPMENT SCHEDULE: RESTAURANT TRASH COLLECTION ROOM			
QTY:	DESCRIPTION:		
5	TOTAL FLOORS		
1	2CY FRONT-LOAD LOOSE - FOOD SCRAPS		
1	3CY FRONT-LOAD LOOSE - CARDBOARD		
2	4CY FRONT-LOAD LOOSE - WASTE		
1	50G DRUM (HOT GREASE)		
1	FLOOR DRAIN		
1	ODOR CONTROL UNIT		
1	HOT AND COLD HOSE BIBB		
_	DIG 105 D to 51 507DIO DALL 57 7DUOY		

**GENERAL NOTES:** 

RESTAURANT TRASH COLLECTION ROOM: STREET LEVEL

FLOOR TO HAVE MINIMAL SLOPE AND FLOOR DRAIN.

5. INSTALL 8'-0" ROLL-UP DOOR AND 3'-0" FIRE EGRESS DOOR

7. OC: ODOR CONTROL UNIT SHALL BE WALL-MOUNTED 60" AFF. 8. <u>HB:</u> HOT AND COLD HOSE BIBB SHALL BE WALL-MOUNTED 60" AFF.

10. 120V, 15A SERVICE OUTLET REQUIRED FOR ALL EQUIPMENT (U.O.N.).

SUPPLEMENT THE SUBMITTAL PACKAGE FROM ARCHITECT.

ANY INCONSISTENCIES AND/OR DISCREPANCIES.

FRP OR HIGH-GLOSS ENAMEL PAINT, 8'-0" AFF.

RESTRICTED ACCESS. FF: +3'-0".

CAPACITY; TURNING RADIUS: 45.5".

1. TRASH COLLECTION ROOM SHALL BE 2HR FIRE-RATED CONSTRUCTION -

2. FLOOR SHALL BE FINISHED WITH ELASTO-DECK 6001 AL-HT DECK COATING.

3. WALLS SHALL BE FINISHED WITH WASHABLE WATERPROOF SURFACE SUCH AS

4. INSTALL WALL PROTECTION: 10"Hx6W" CONCRETE CURB AT BASE OF WALLS.

6. ROOM SHALL BE MECHANICALLY VENTILATED WITH (1) CFM/FT PER 2016 CBC.

9. PROVIDE ELECTRIC PALLET TRUCK FOR TRANSFERRING CONTAINERS. 4000lb

1. ANY DESIGNS OR SOLUTIONS SHOWN IN DRAWING, EITHER DIRECT OR IMPLIED, ARE HEREBY CLARIFIED AS EXAMPLES AND SHALL NOT BE CONSIDERED

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	OF WORK, SHALL NOT RELIEVE THE CONTRACTOR FROM COMPLETION OF		Planning
	WORK. ALL WORK SHALL BE PERFORMED TO SATISFY THE MINIMUM REQUIREMENTS OF THE CURRENT APPLICABLE BUILDING CODES.		Urban Design

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Consultant

Mathilda

Date	
09/06/2017	
03/16/2018	




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RESTAURANT TRASH COLLECTION PLAN
STREET LEVEL


Job No. 16044 Date: 03/16/2018 Scale: AS INDICATED

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RESTAURANT TRASH COLLECTION ROOM

STREET LEVEL

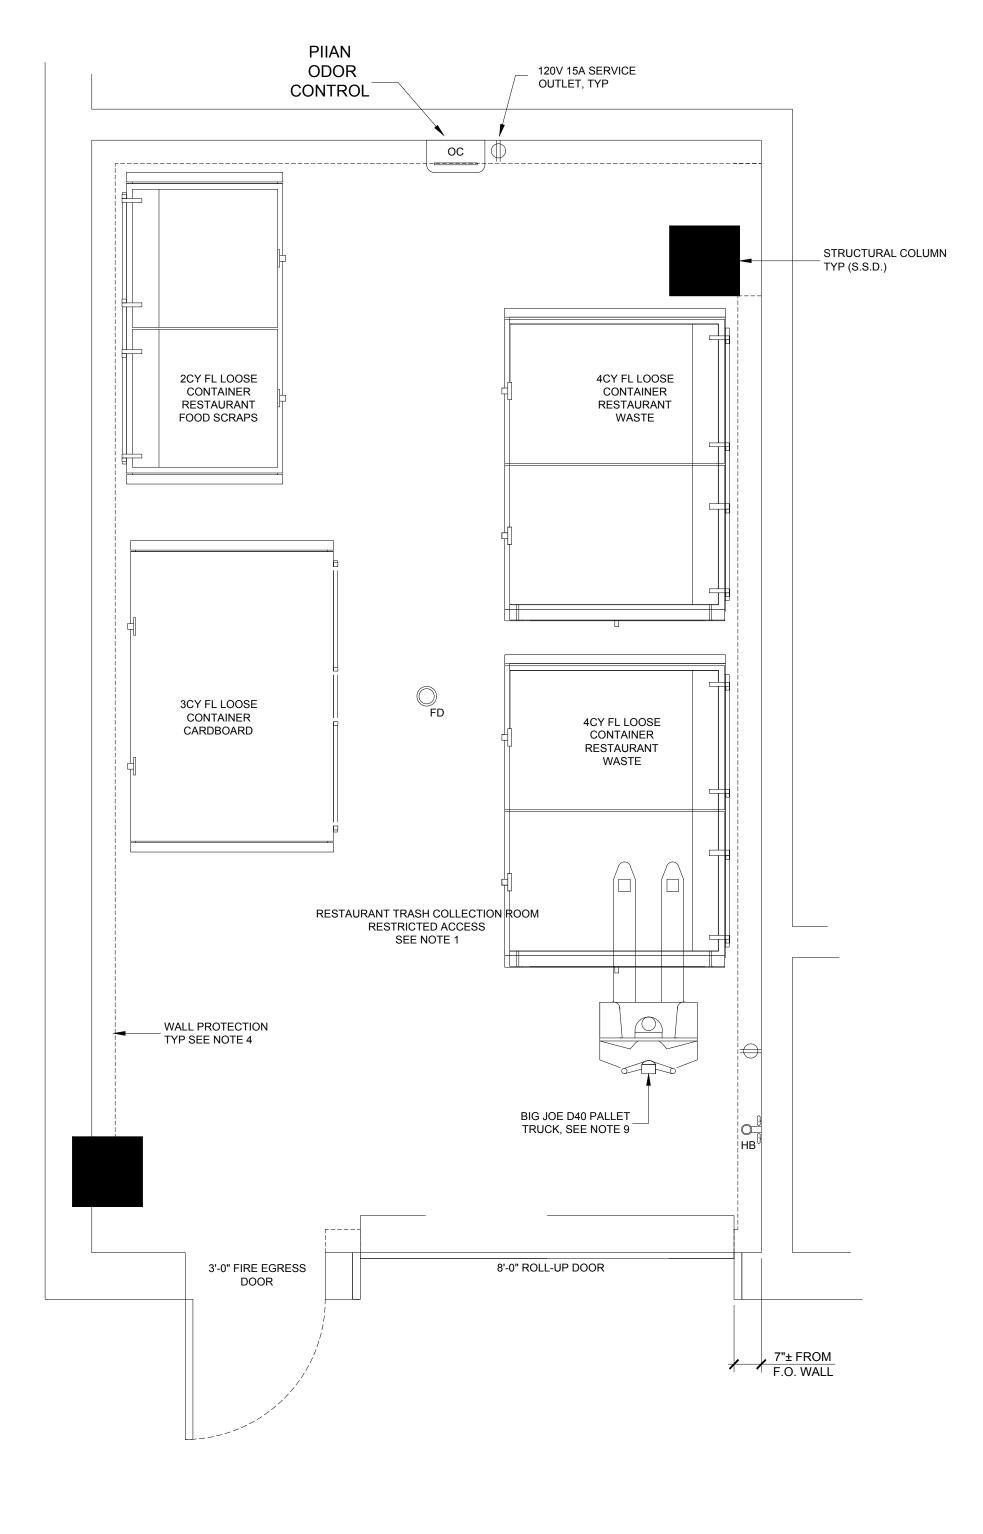



### REMOTE TRASH COLLECTION ROOM:

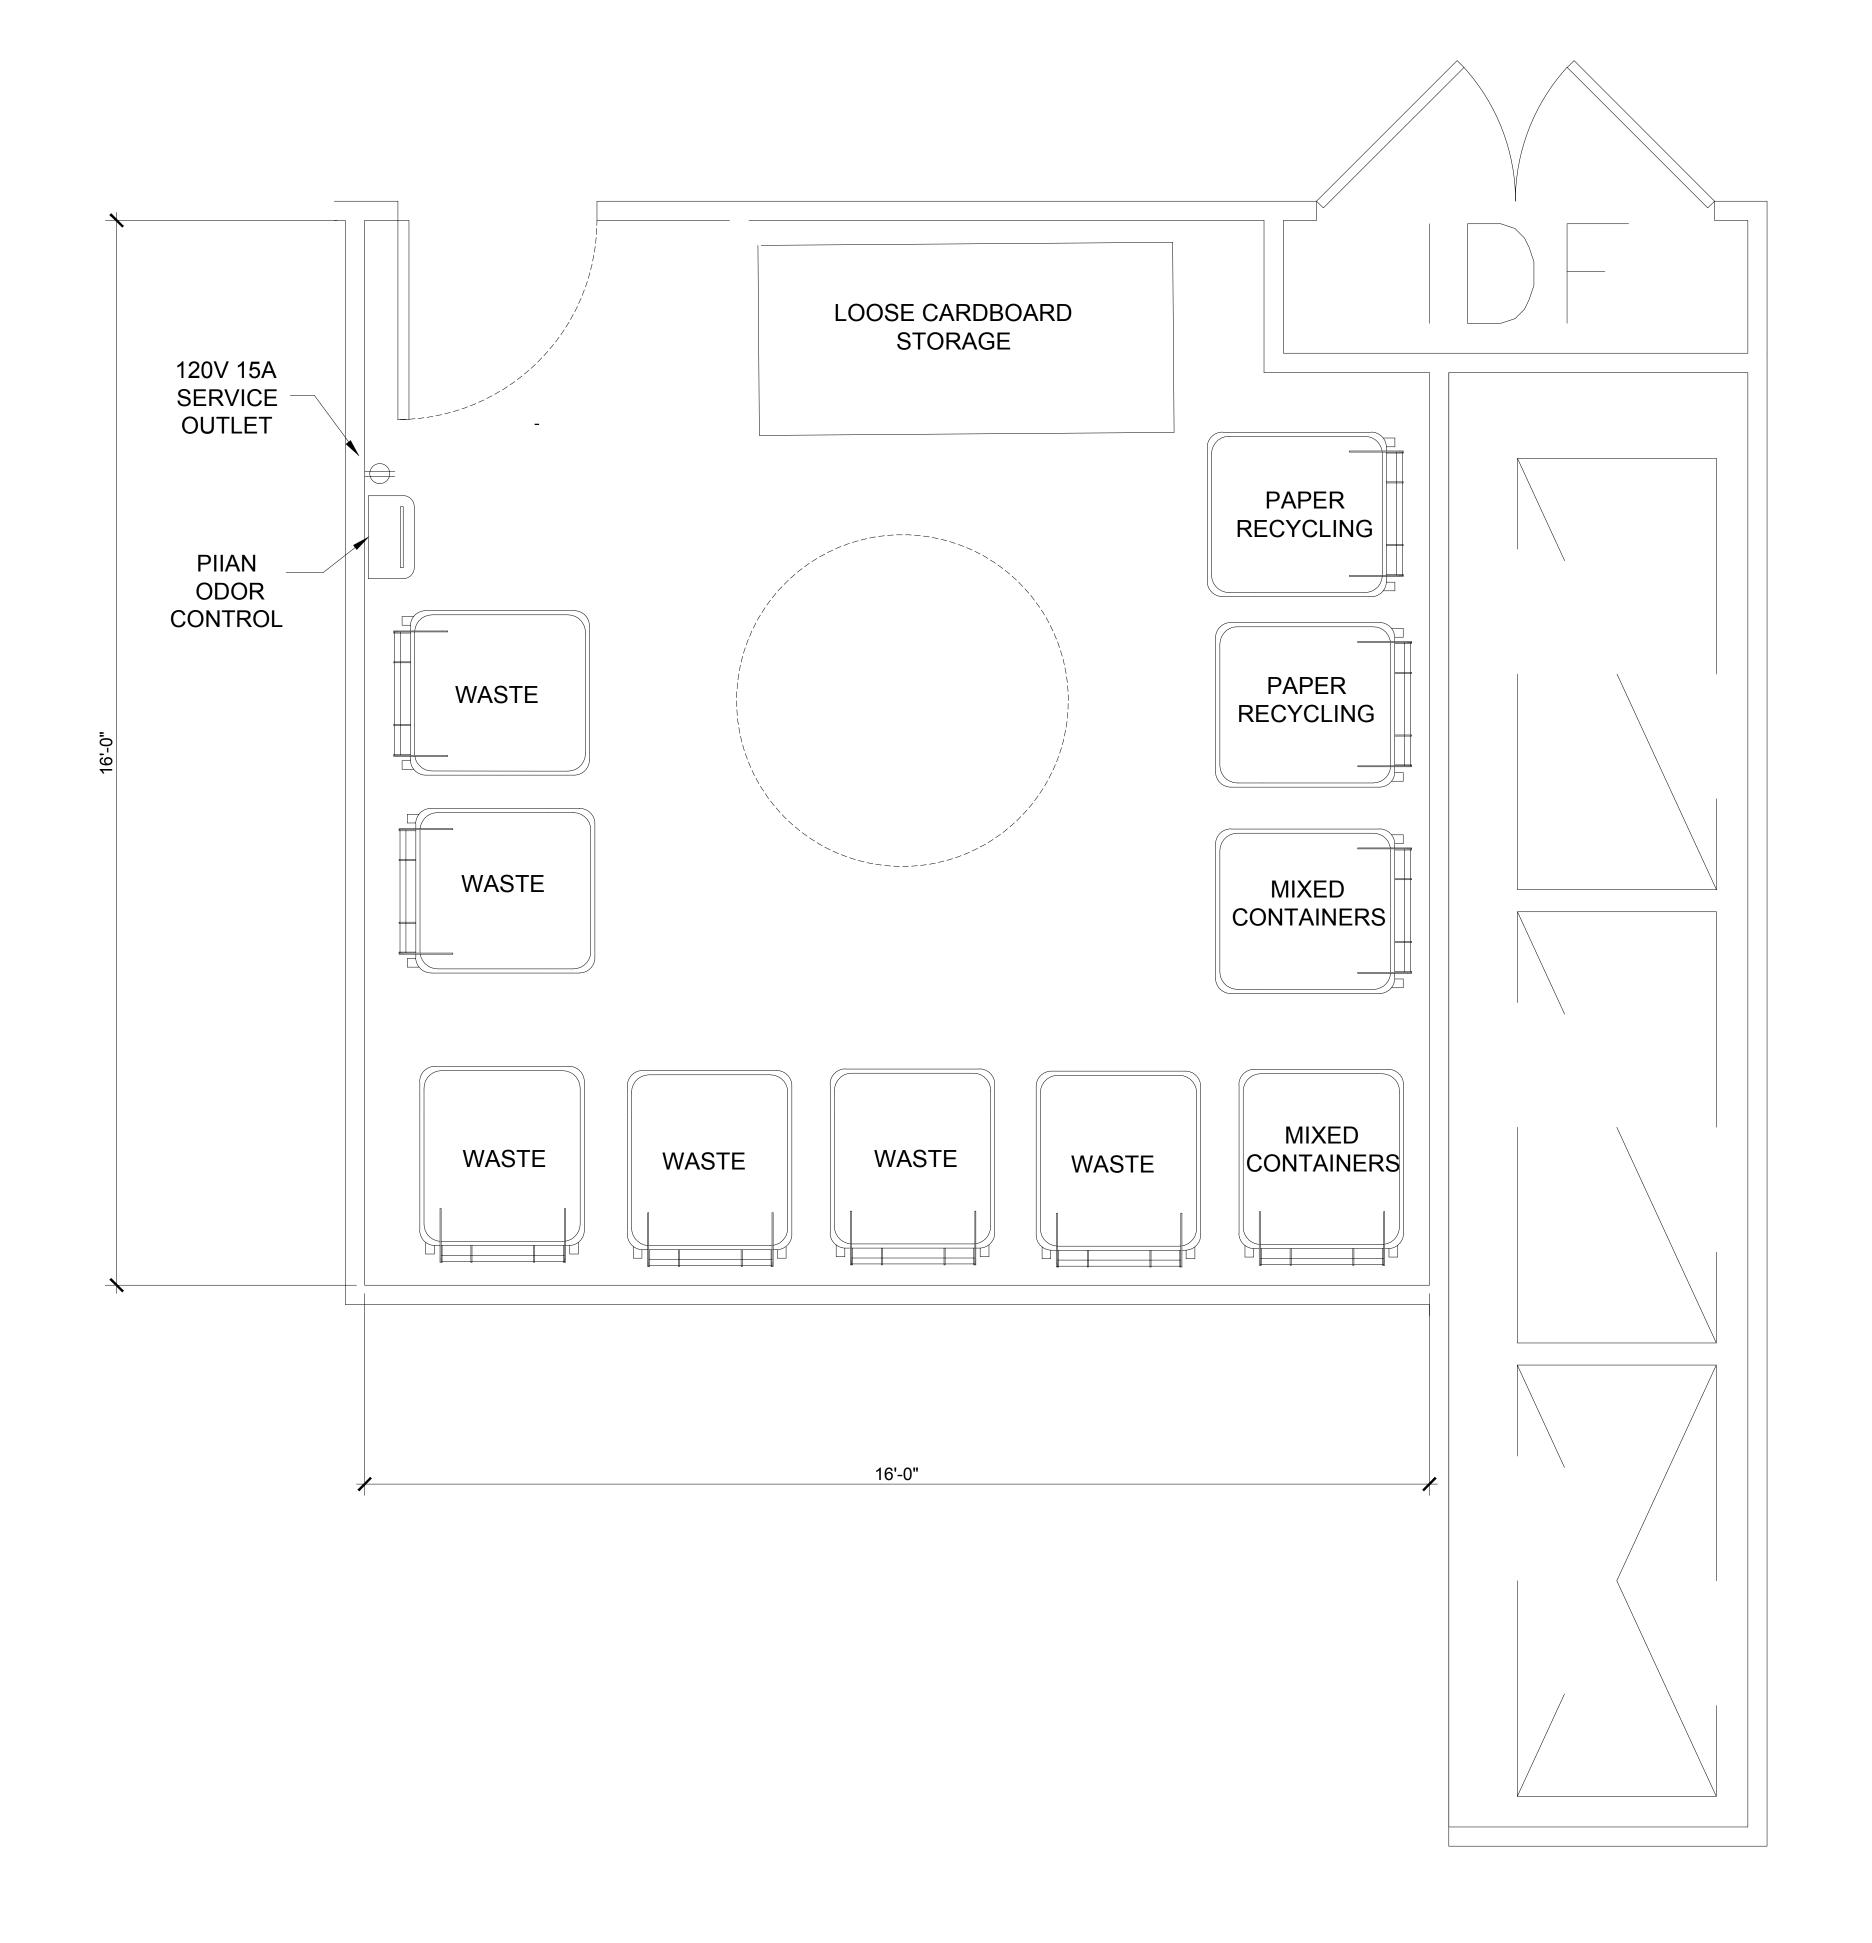
- 1. TRASH COLLECTION ROOM SHALL BE 1HR FIRE-RATED CONSTRUCTION RESTRICTED ACCESS. .
- 2. FLOOR SHALL BE FINISHED WITH ELASTO-DECK 6001 AL-HT DECK COATING. FLOOR TO HAVE MINIMAL SLOPE AND FLOOR DRAIN.
- 3. WALLS SHALL BE FINISHED WITH WASHABLE WATERPROOF SURFACE SUCH AS FRP OR HIGH-GLOSS ENAMEL PAINT, 8'-0" AFF.
- 4. OC: ODOR CONTROL UNIT SHALL BE WALL-MOUNTED 60" AFF.
- 5. 120V, 15A SERVICE OUTLET REQUIRED.

### **GENERAL NOTES:**

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- 3. CONTRACTOR SHALL FIELD VERIFY ALL DIMENSIONS AND CONDITIONS PRIOR TO START OF CONSTRUCTION. THE ARCHITECT SHALL BE PROMPTLY NOTIFIED OF ANY INCONSISTENCIES AND/OR DISCREPANCIES.

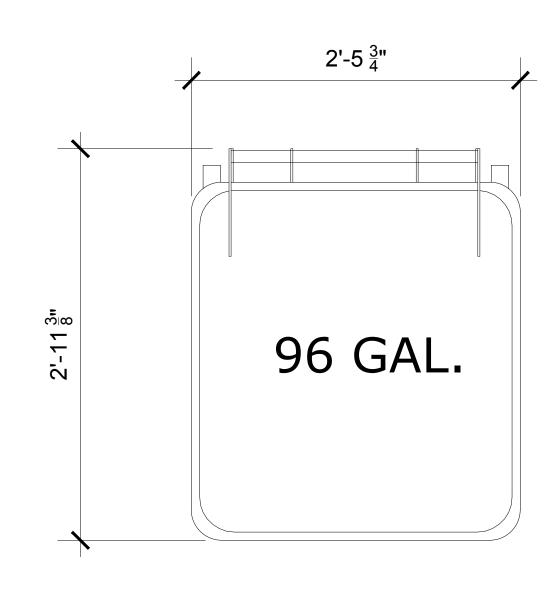

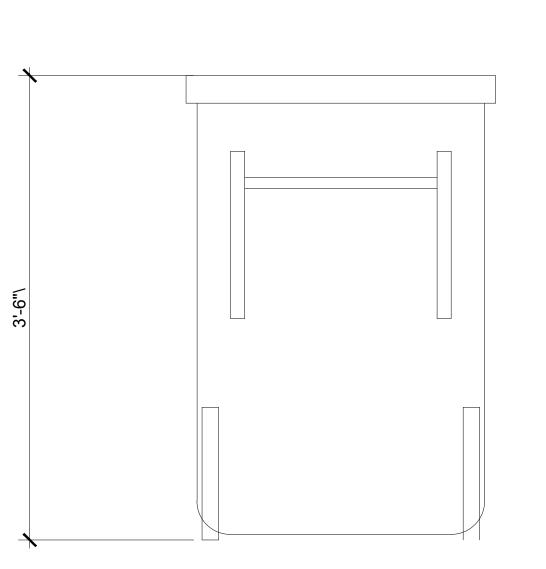

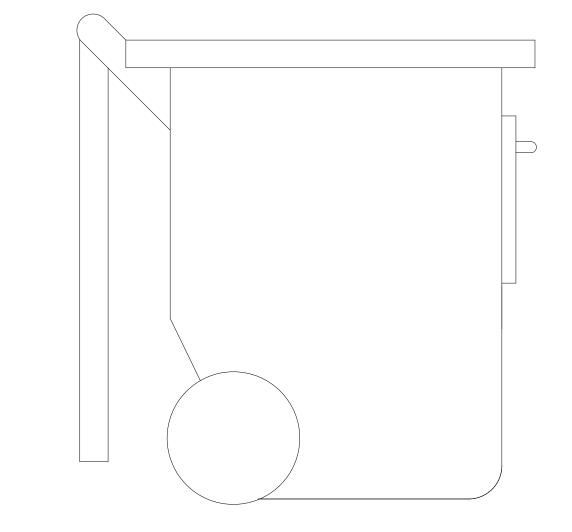

96 GAL CART

: Architecture: Planning: Urban Design

: 304 12th Street, Suite 2A: Oakland, California 94607

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311 S Mathilda Ave, Sunnyvale, CA 94086

Lane Partners
644 Menlo Ave, 2nd Floor, Menlo Park, CA 94025

Description Date

BUILDING PERMIT SUBMITTAL 09/06/2017

PLAN CHECK RESPONSE 03/16/2018



Sheet Title:

REMOTE TRASH
COLLECTION ROOM
UPPER LEVEL

Job No. 16044

Date: 03/16/2018


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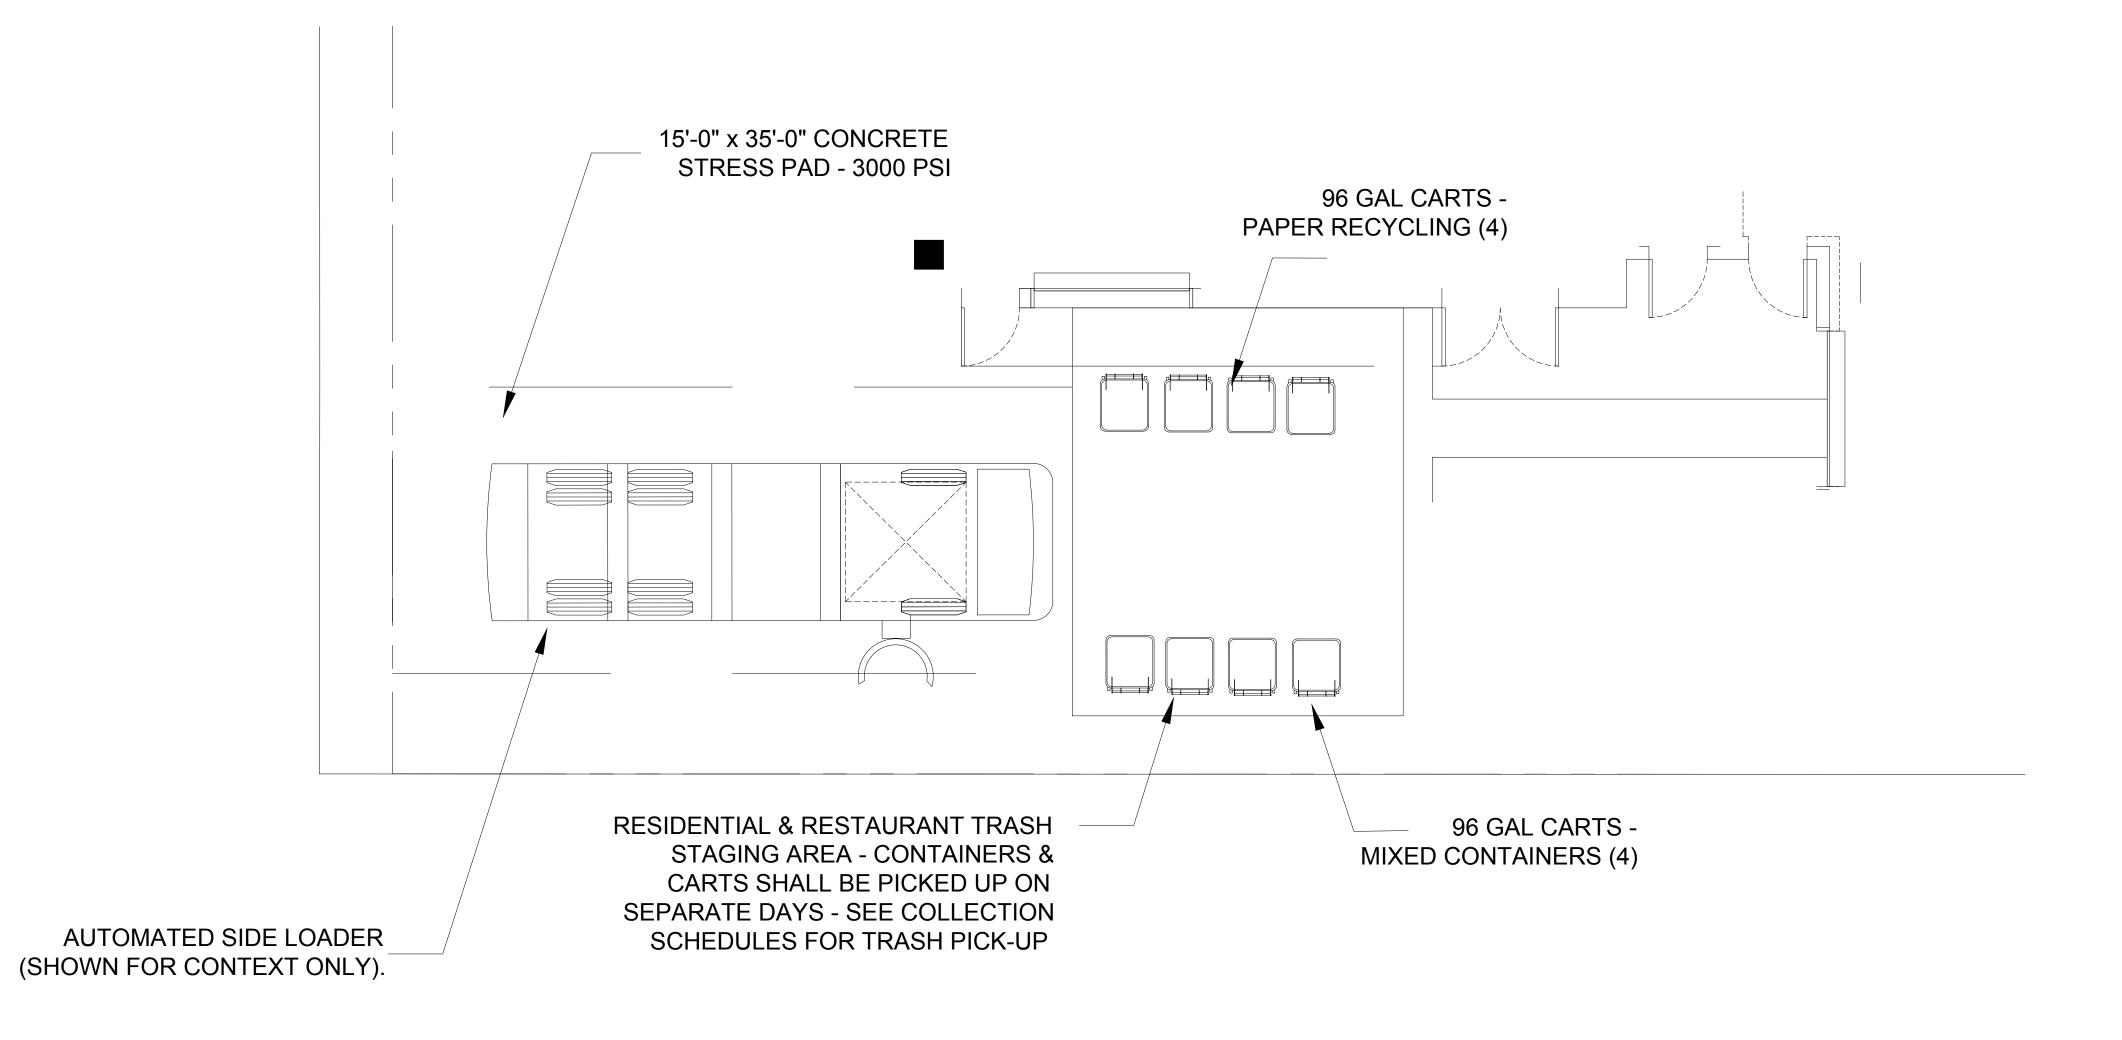
T0.3

REMOTE TRASH COLLECTION ROOM

RESIDENTIAL LEVELS



RESIDENTIAL & RESTAURANTTRASH STAGING AREA STREET LEVEL

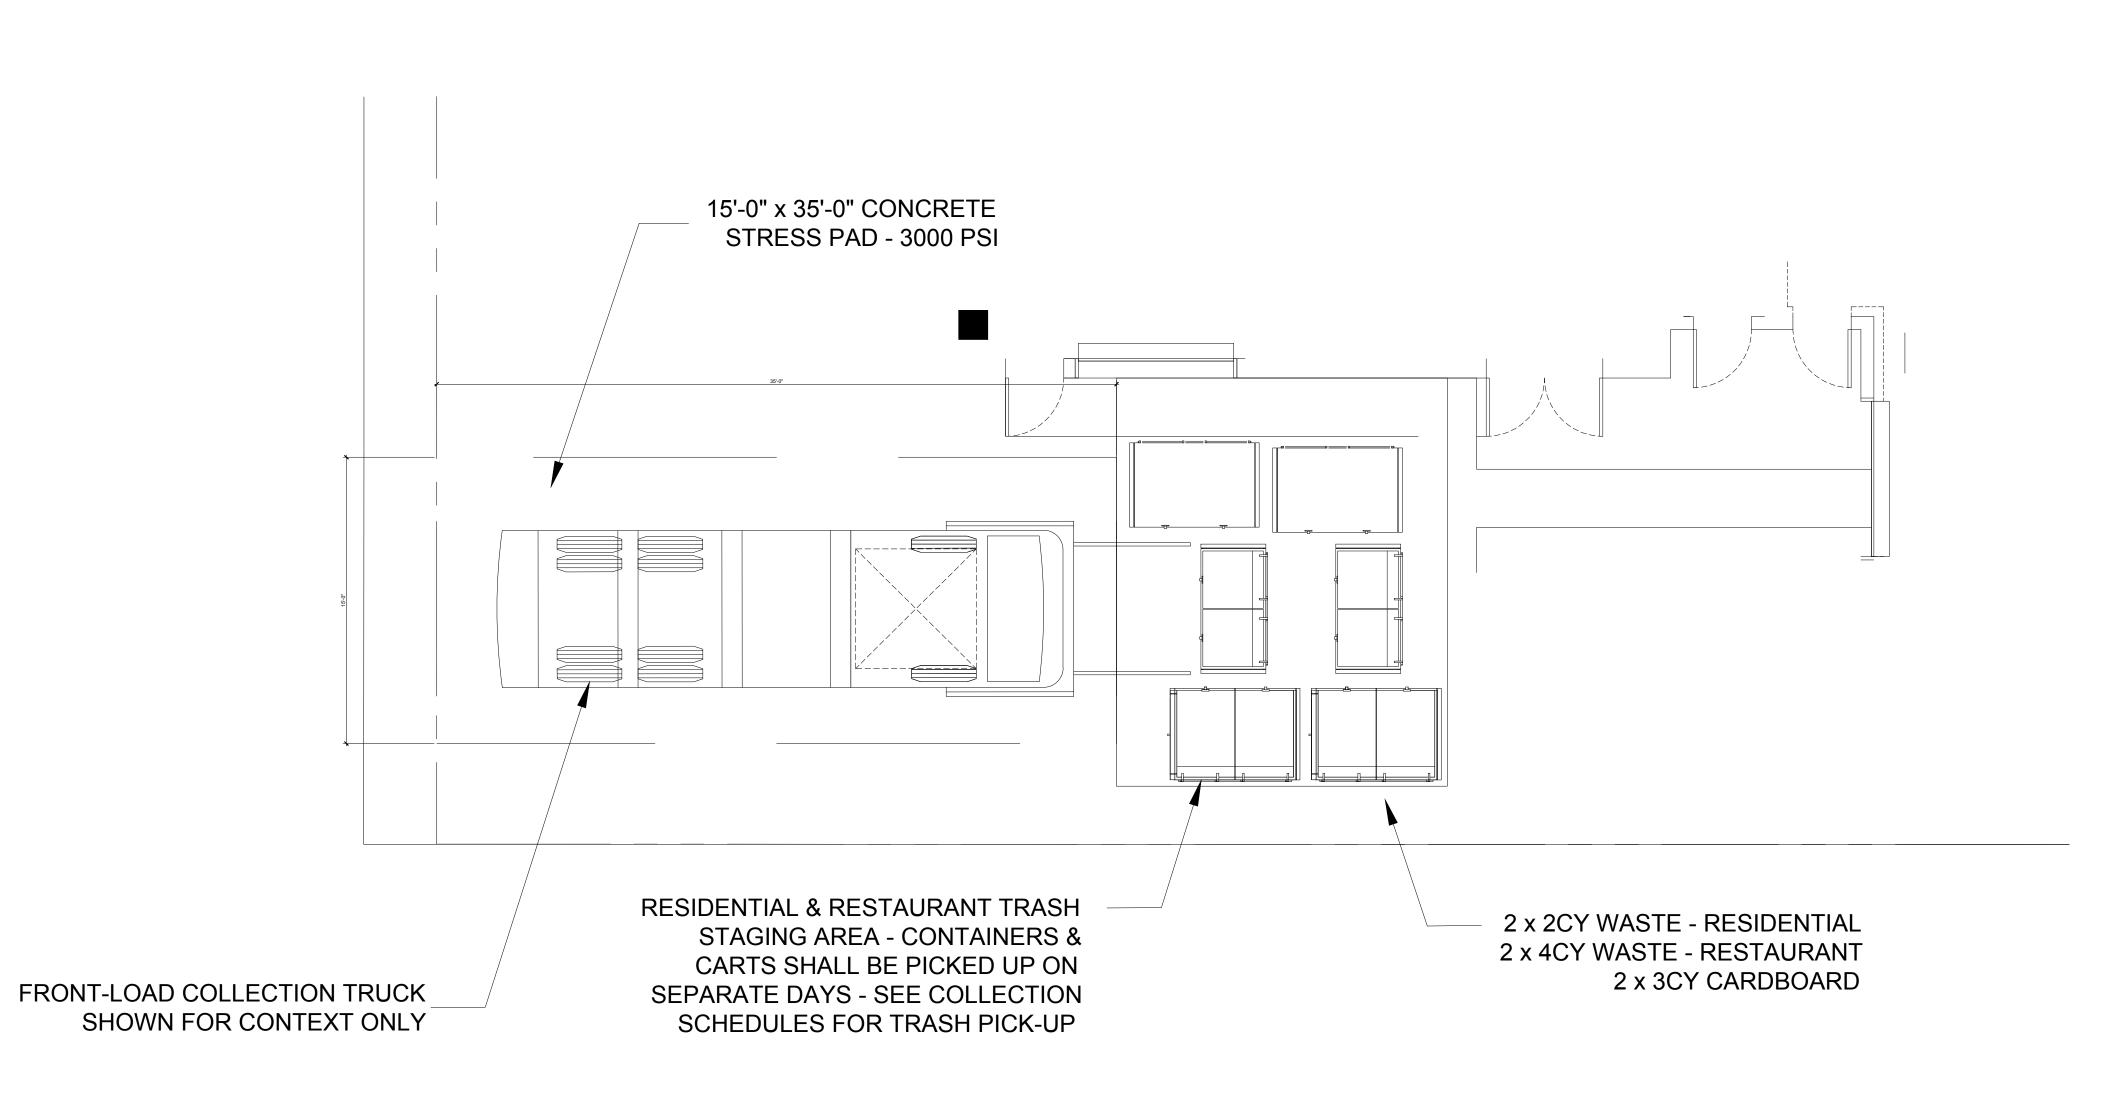

RESIDENTIAL 96 GALTRASH CART STAGING AREA

STREET LEVEL

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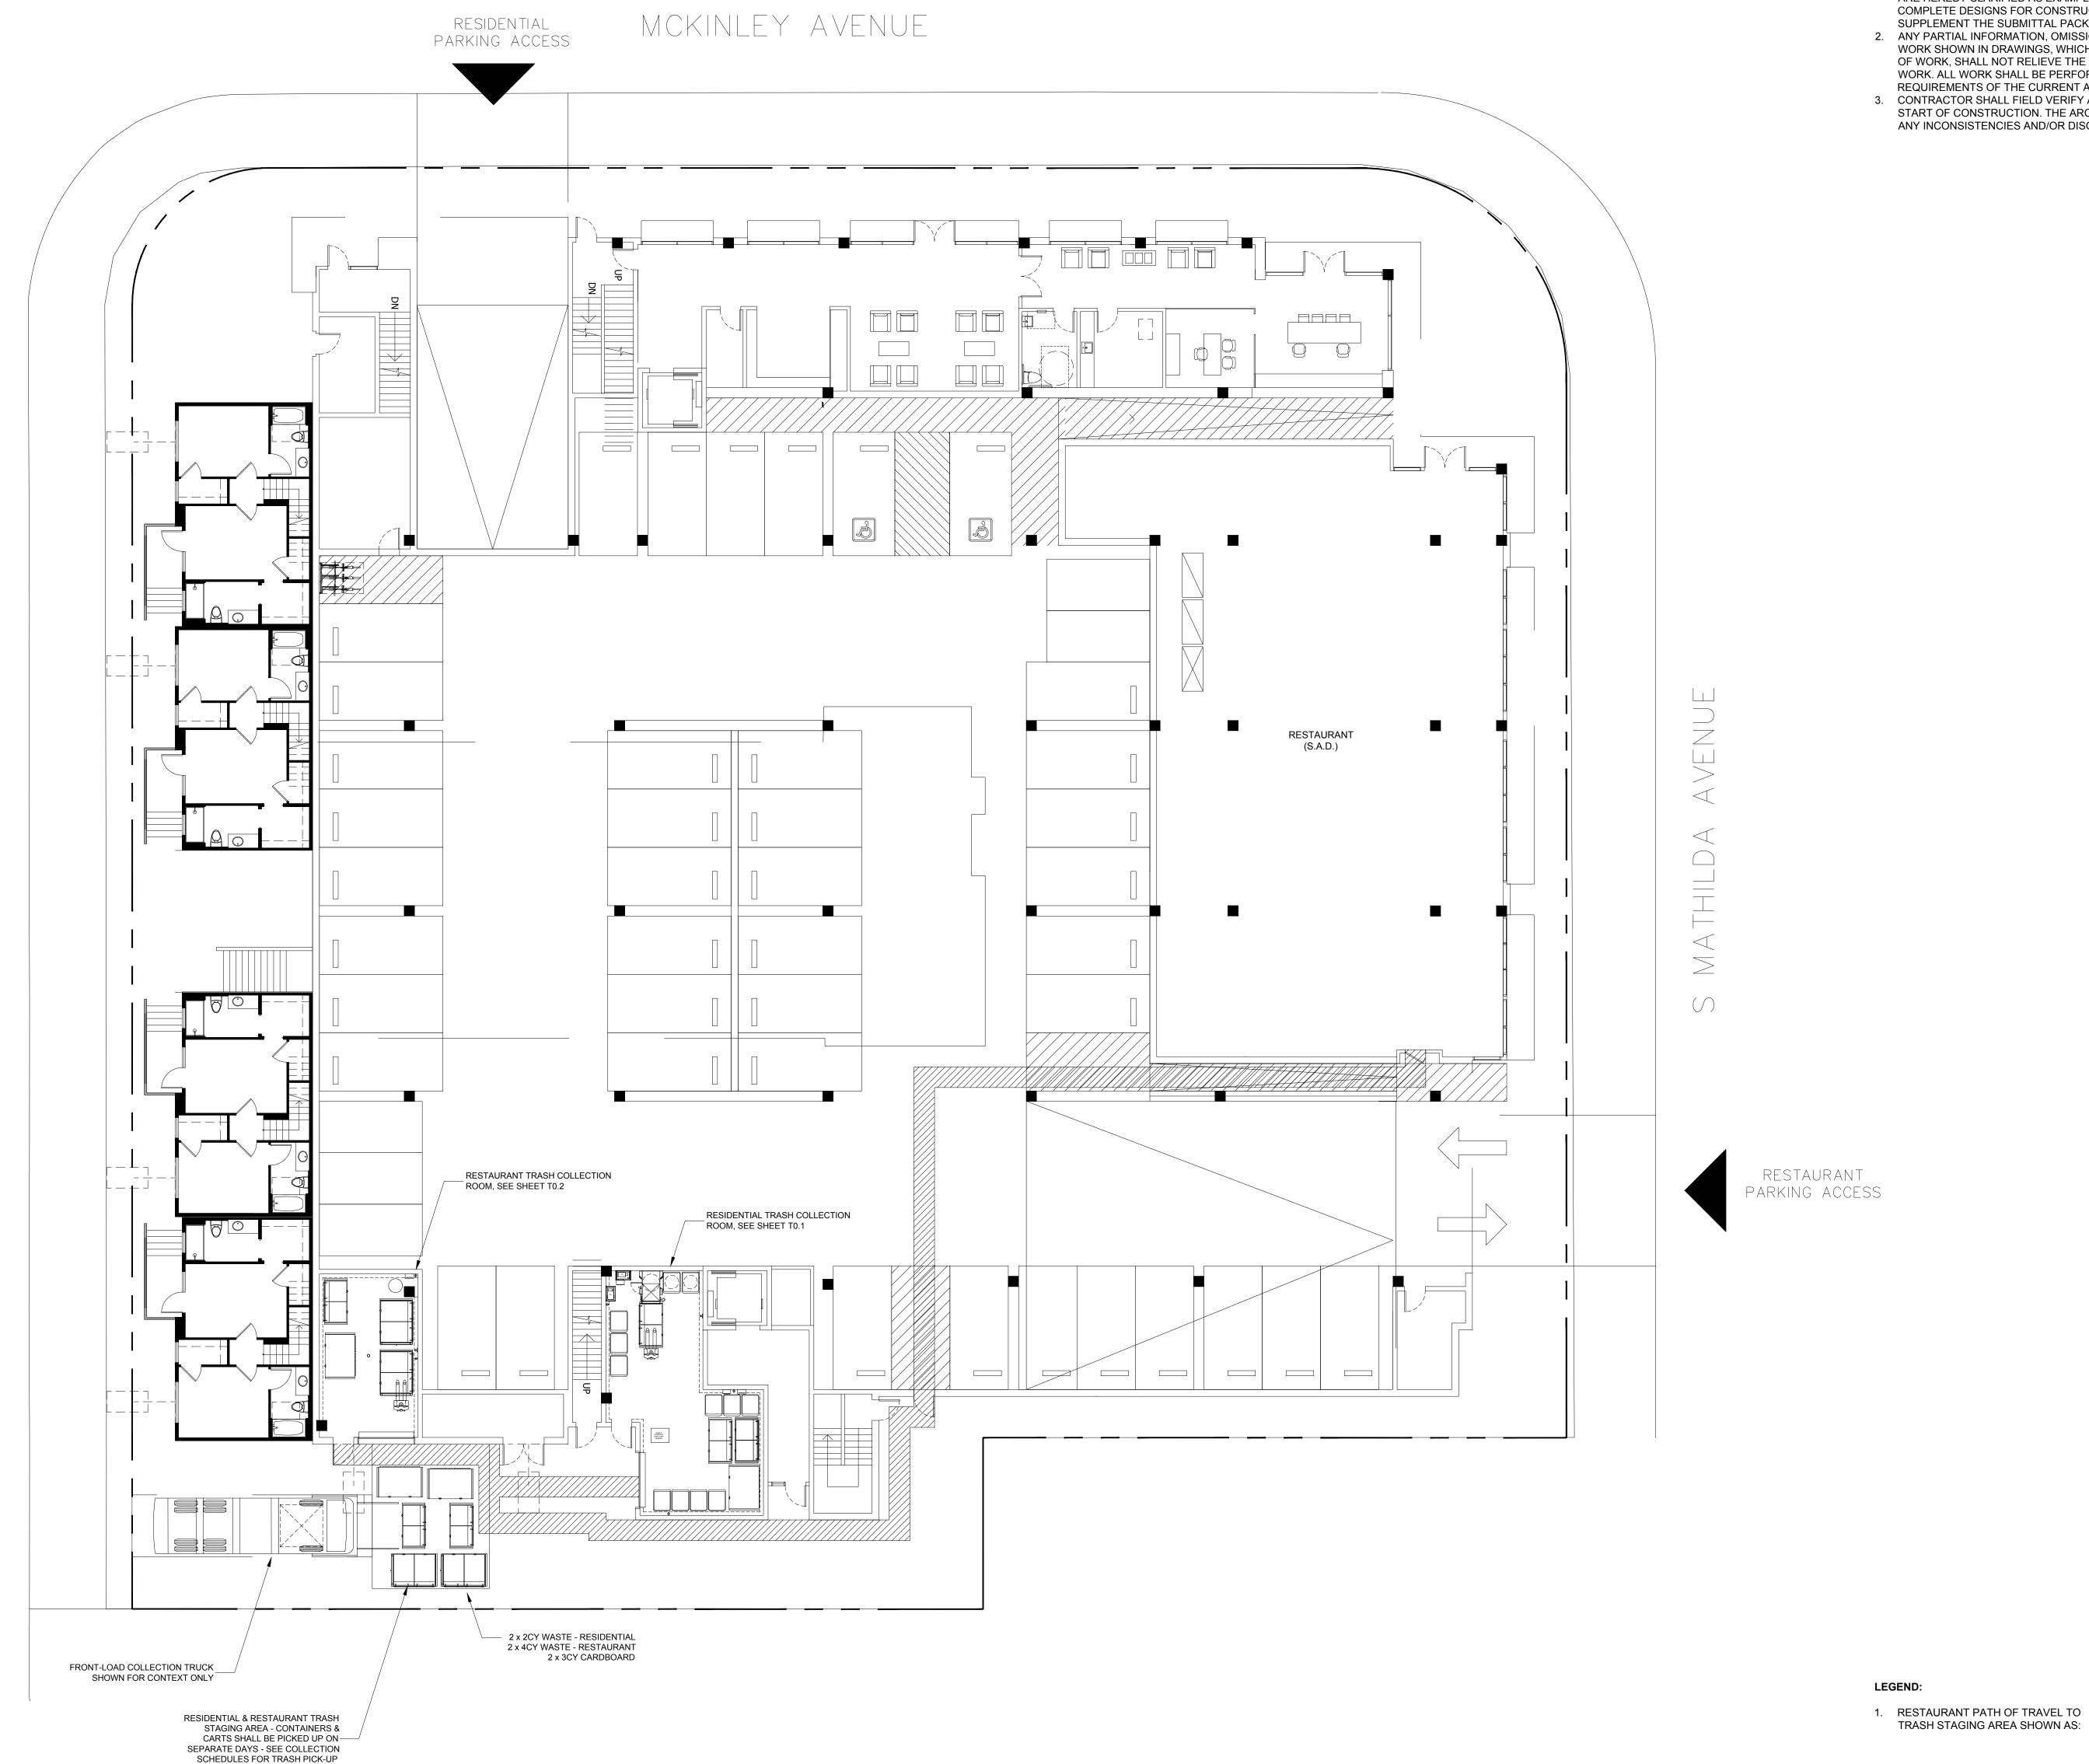


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TRASH STAGING AREA

Job No. 16044 Date: 03/16/2018 Scale: AS INDICATED

T0.4



RESTAURANT BIN MOVEMENT PLAN: STREET LEVEL

1. DISTANCE FROM RESTAURANT TO RESTAURANT TRASH COLLECTION ROOM IS ±262'-0". DISTANCE FROM RESIDENTIAL TRASH ROOM TO TRASH STAGING AREA IS ±22'-0".

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3. CONTRACTOR SHALL FIELD VERIFY ALL DIMENSIONS AND CONDITIONS PRIOR TO START OF CONSTRUCTION. THE ARCHITECT SHALL BE PROMPTLY NOTIFIED OF ANY INCONSISTENCIES AND/OR DISCREPANCIES.

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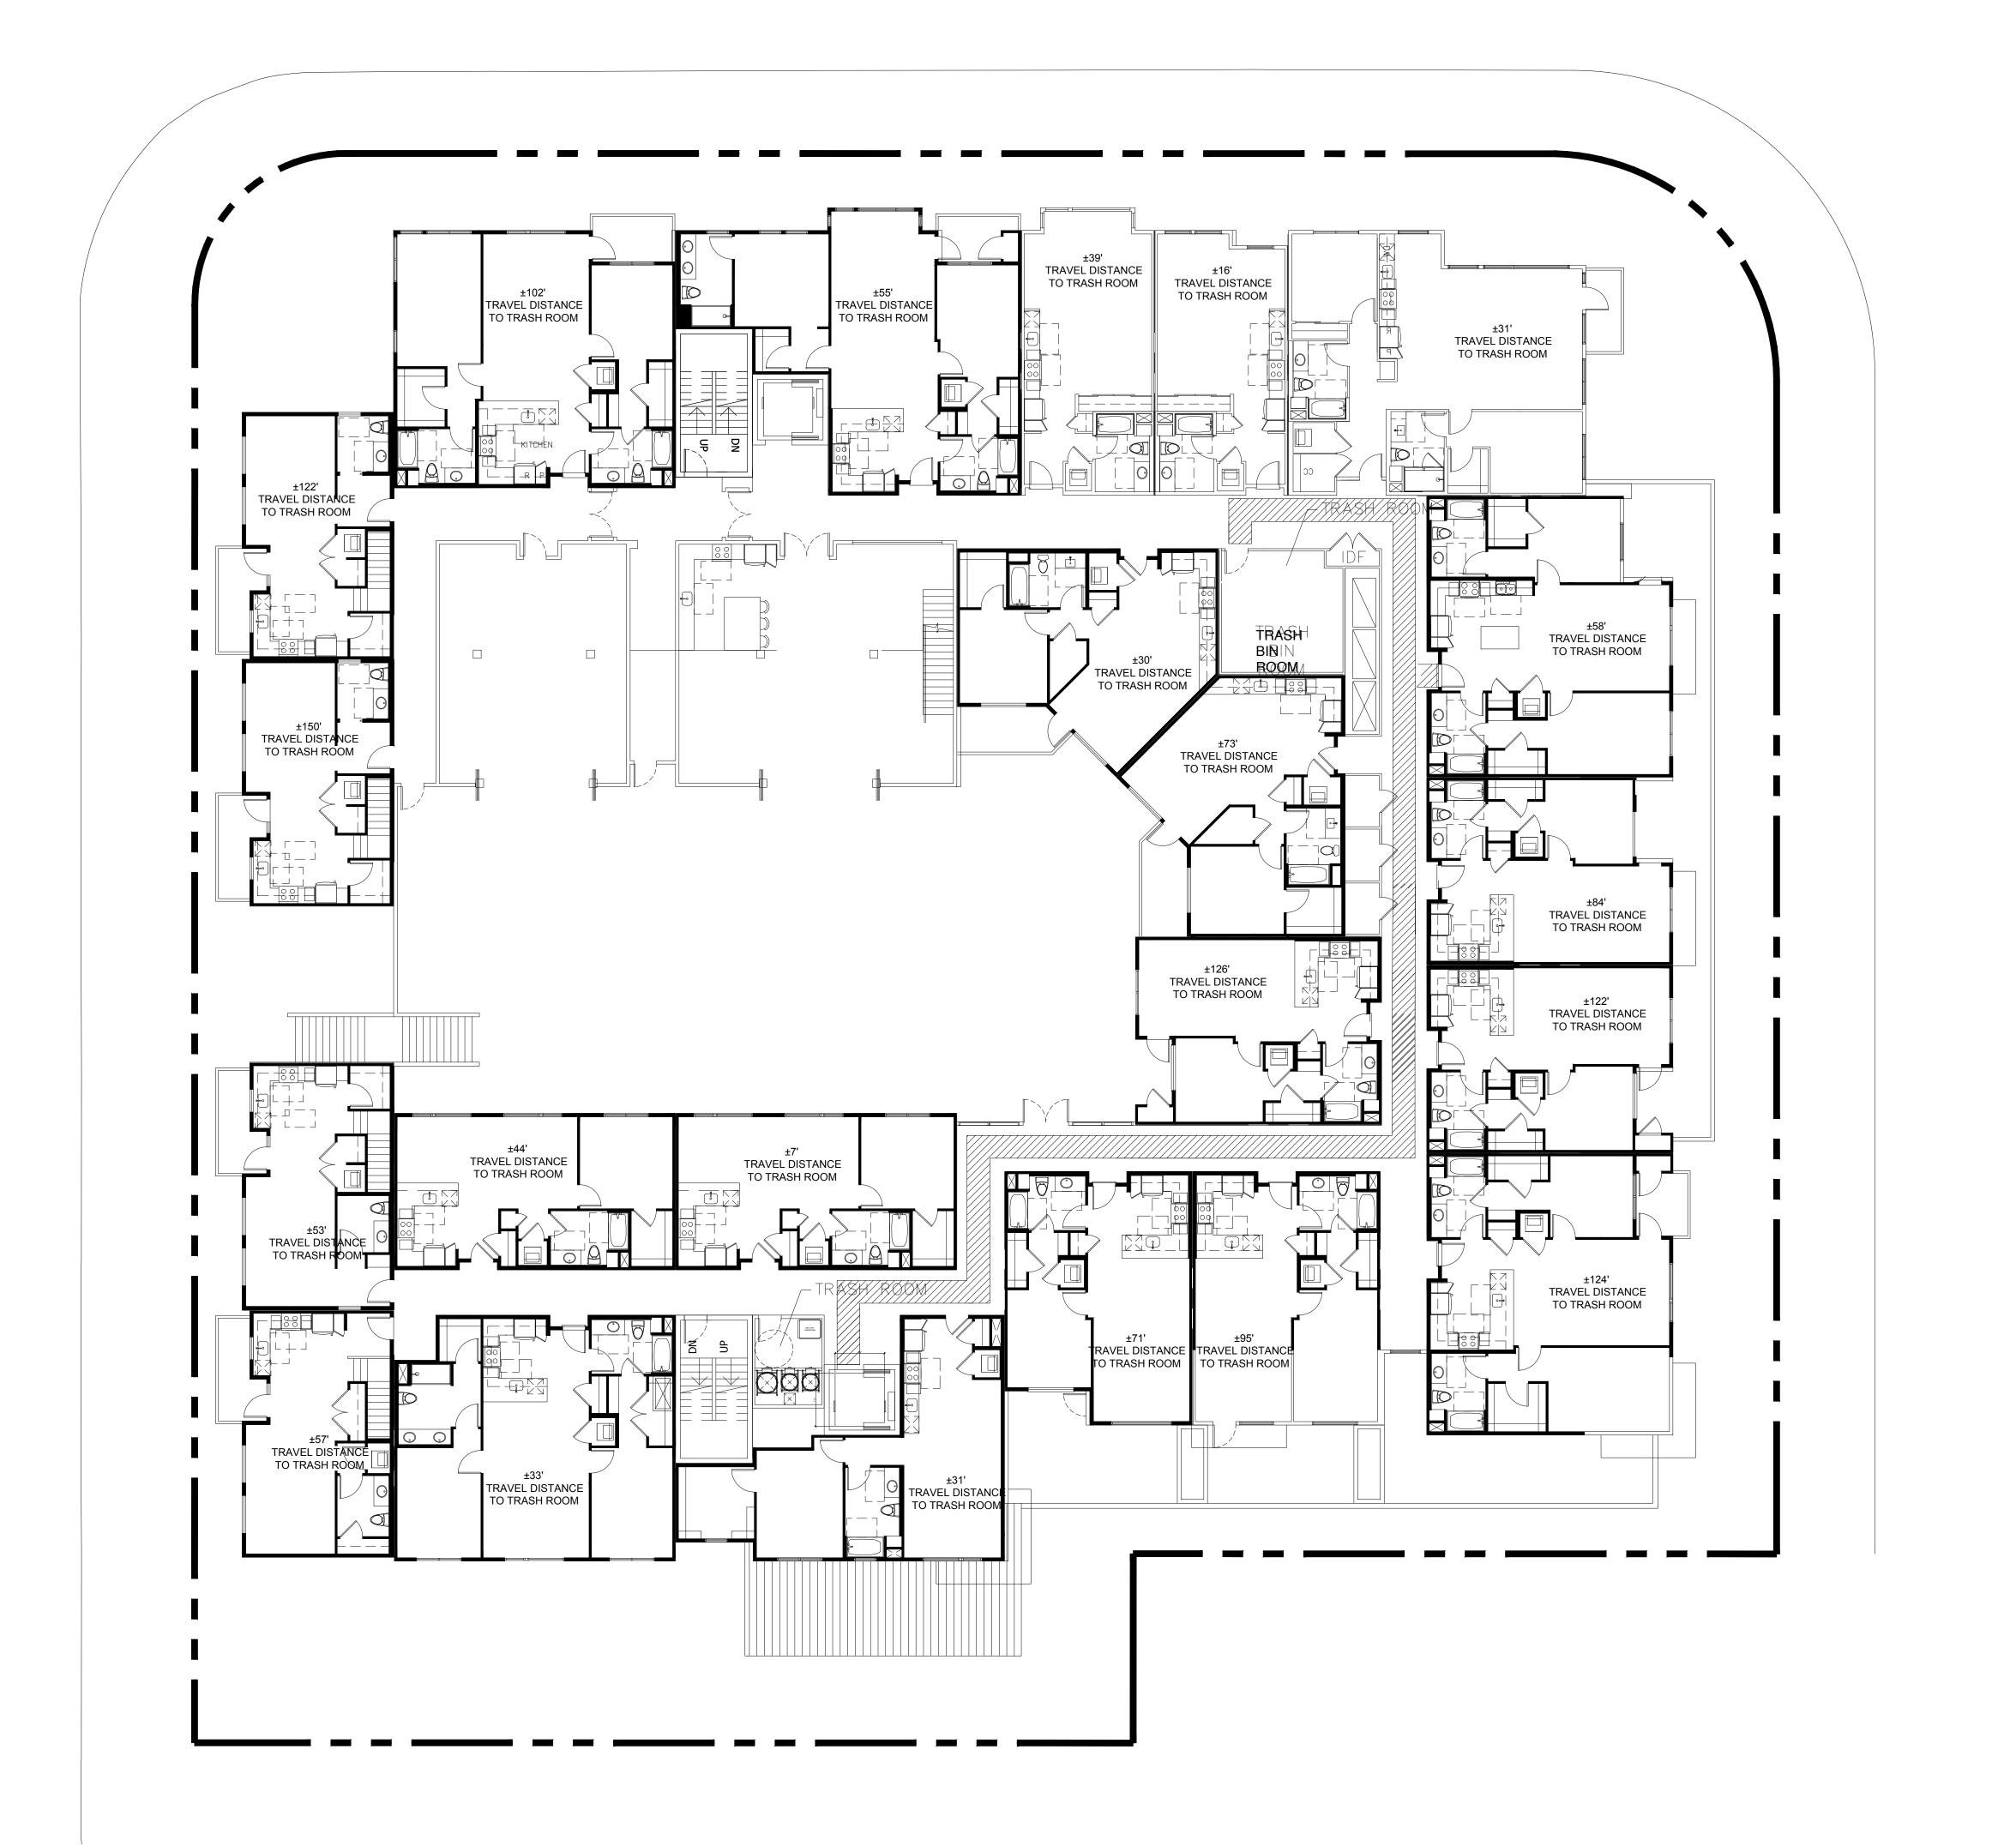
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RESTAURANT BIN **MOVEMENT PLAN** STREET LEVEL

Job No. 16044 Date: 03/16/2018 Scale: AS INDICATED

SCALE: 3/32" = 1'-0"



PATH OF TRAVEL PLAN: UPPER LEVEL


1. (35) TOTAL RESIDENTIAL UNITSEXCEED THE CITY OF SUNNYVALE'S ALLOWABLE TRAVEL DISTANCE TO TRASH ROOMS (150'-0"). SEE PLAN FOR MARKED UNITS. 2. MAX DISTANCE RESIDENTIAL UNIT FROM CHUTE INTAKE VESTIBULE: 263'-0".

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ELEVATOR WITH 96 GAL CARTS STREET LEVEL

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Consultant

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Description BUILDING PERMIT SUBMITTAL PLAN CHECK RESPONSE 03/16/2018

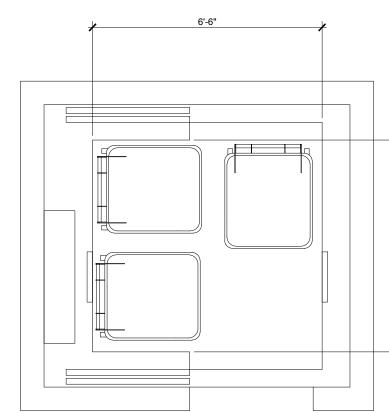


PATH OF TRAVEL PLAN UPPER LEVEL

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Job No. 16044 Date: 03/16/2018 Scale: AS INDICATED

LEGEND:

RESIDENTIAL PATH OF TRAVEL TO CHUTE INTAKE VESTIBULE SHOWN AS:

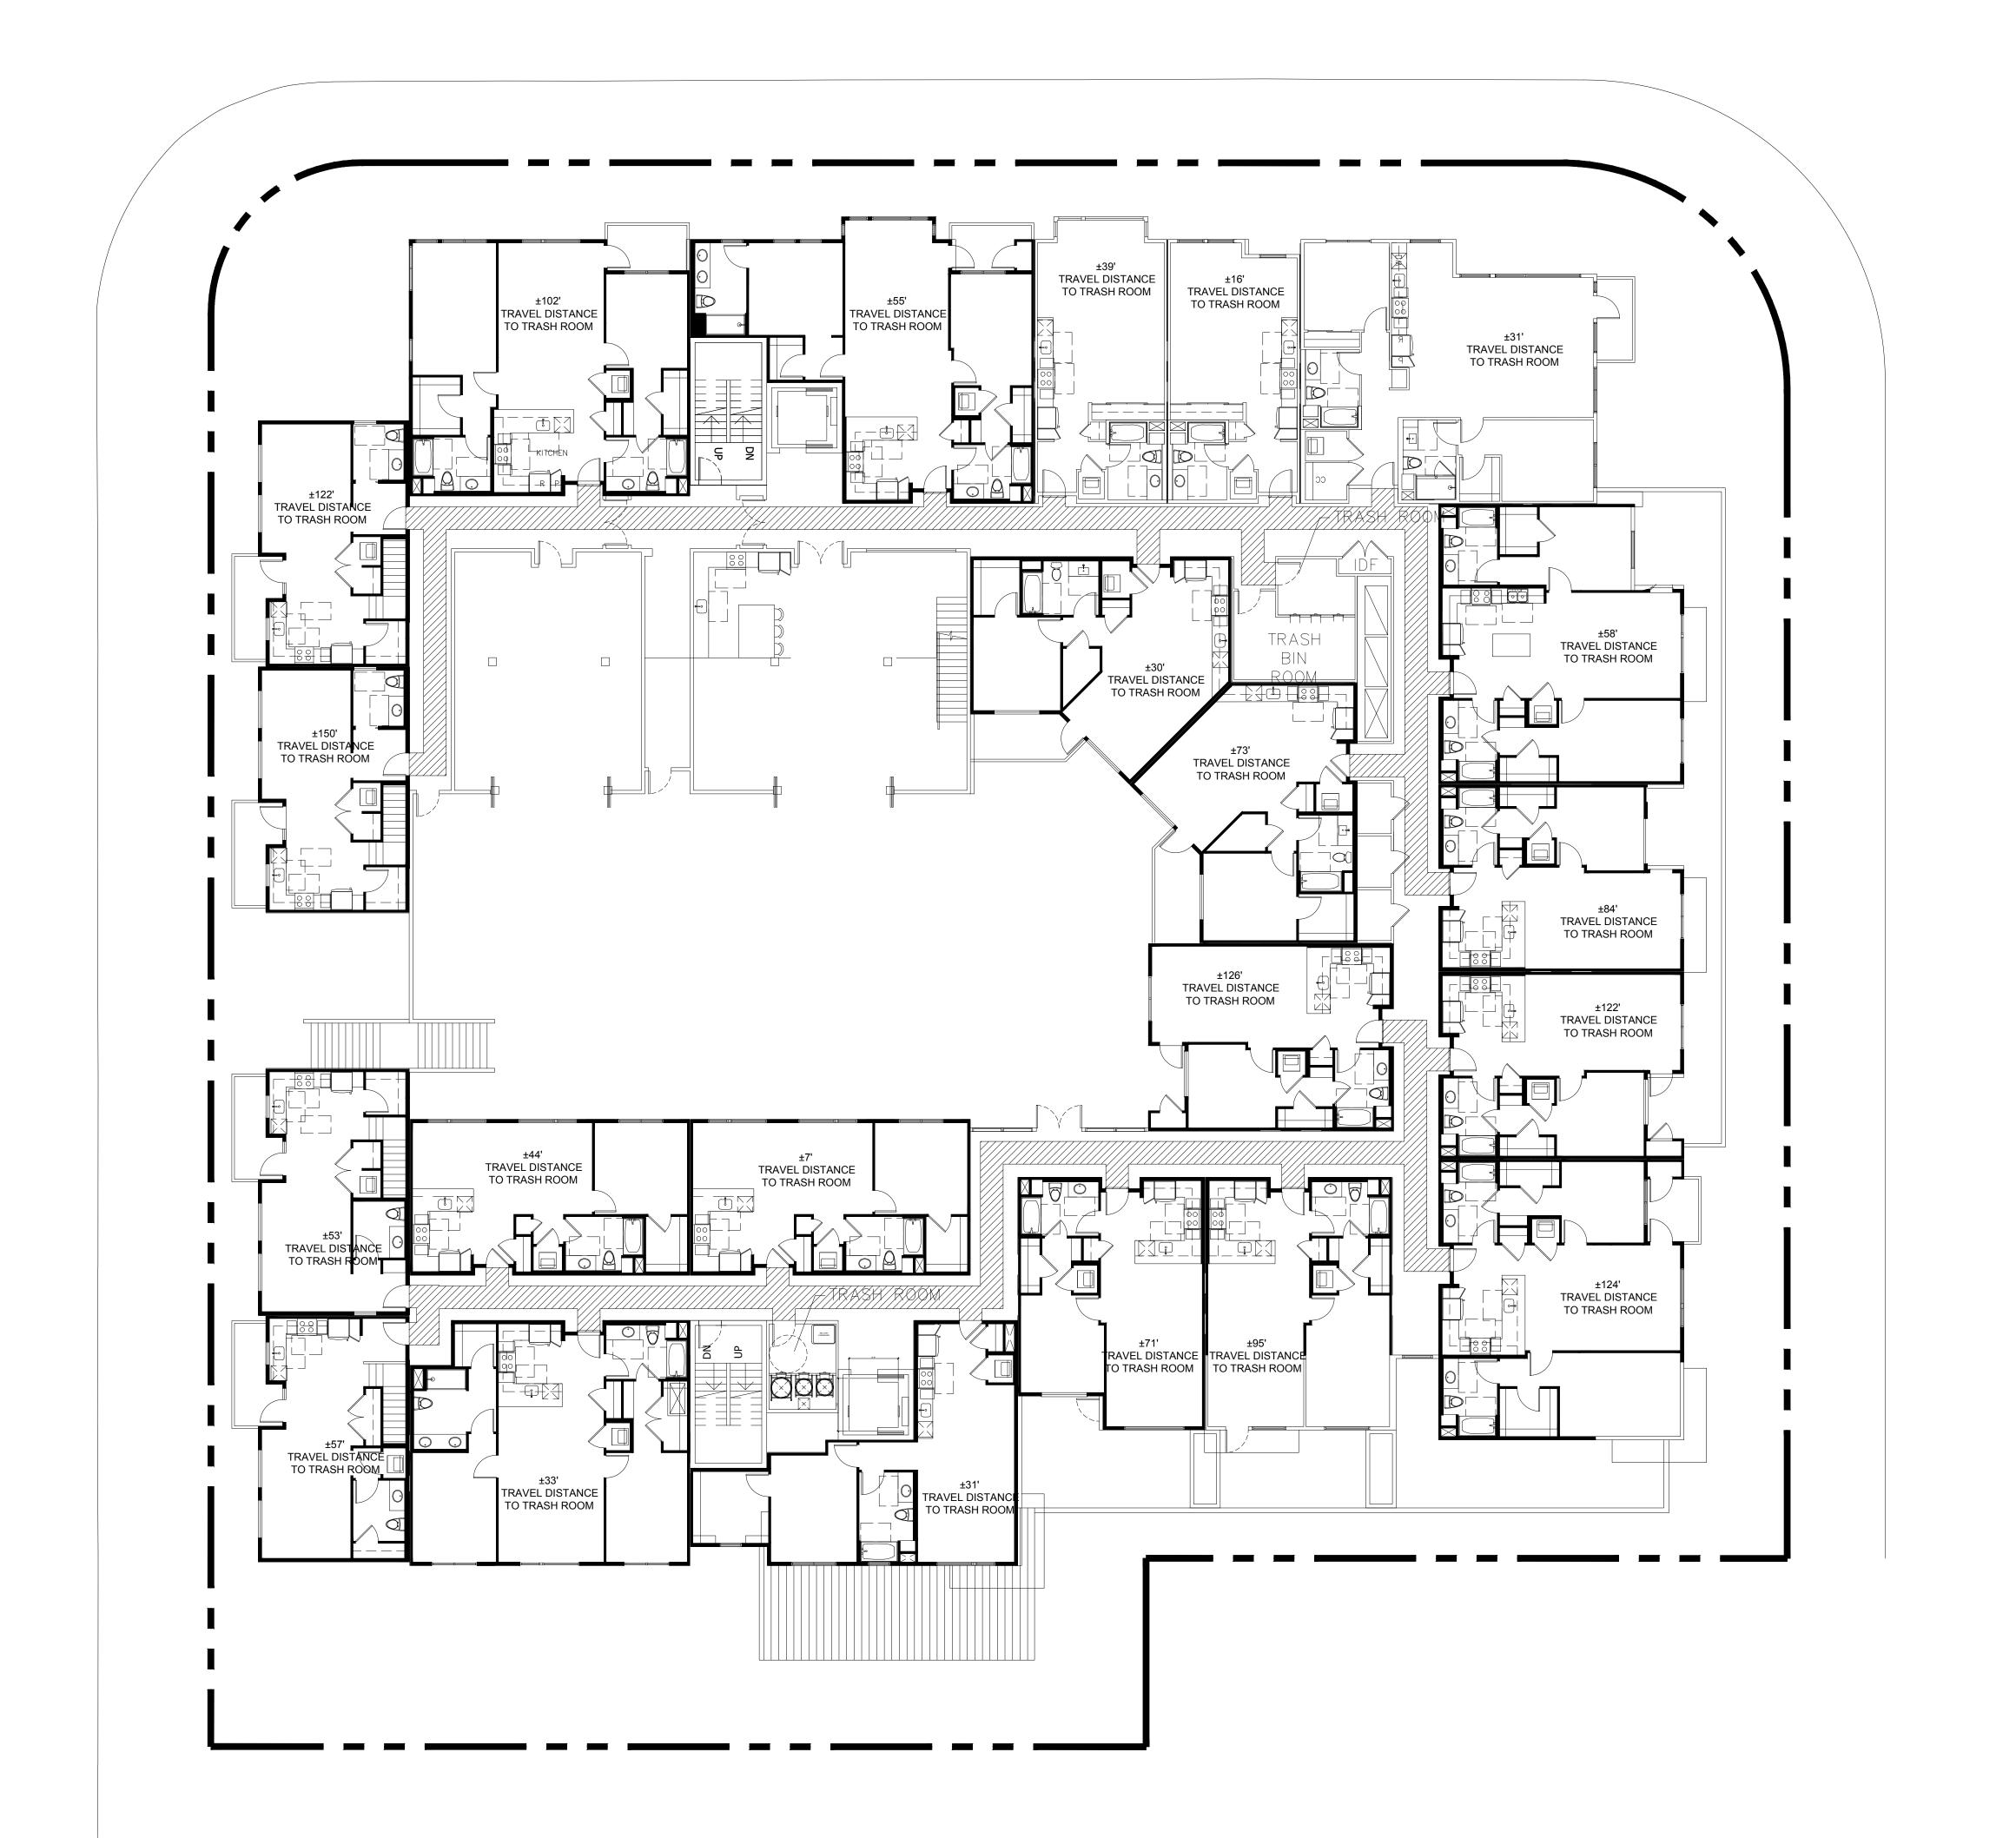

PATH OF TRAVEL PLAN: UPPER LEVEL

1. (35) TOTAL RESIDENTIAL UNITSEXCEED THE CITY OF SUNNYVALE'S ALLOWABLE TRAVEL DISTANCE TO TRASH ROOMS (150'-0"). SEE PLAN FOR MARKED UNITS. 2. MAX DISTANCE RESIDENTIAL UNIT FROM CHUTE INTAKE VESTIBULE: 263'-0".

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311 S N

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LEGEND:

RESIDENTIAL UNITS EXCEEDING 150'-0" FROM TRASH ROOM SHOWN AS:

RESIDENTIAL PATH OF TRAVEL TO CHUTE INTAKE VESTIBULE SHOWN AS:



SCALE: 3/32" = 1'-0"

Job No. 16044 Date: 03/16/2018 Scale: AS INDICATED

F: 415.292.5410


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PATH OF TRAVEL

TO VESTIBULES -UPPER LEVEL

Sheet No:

PLAN

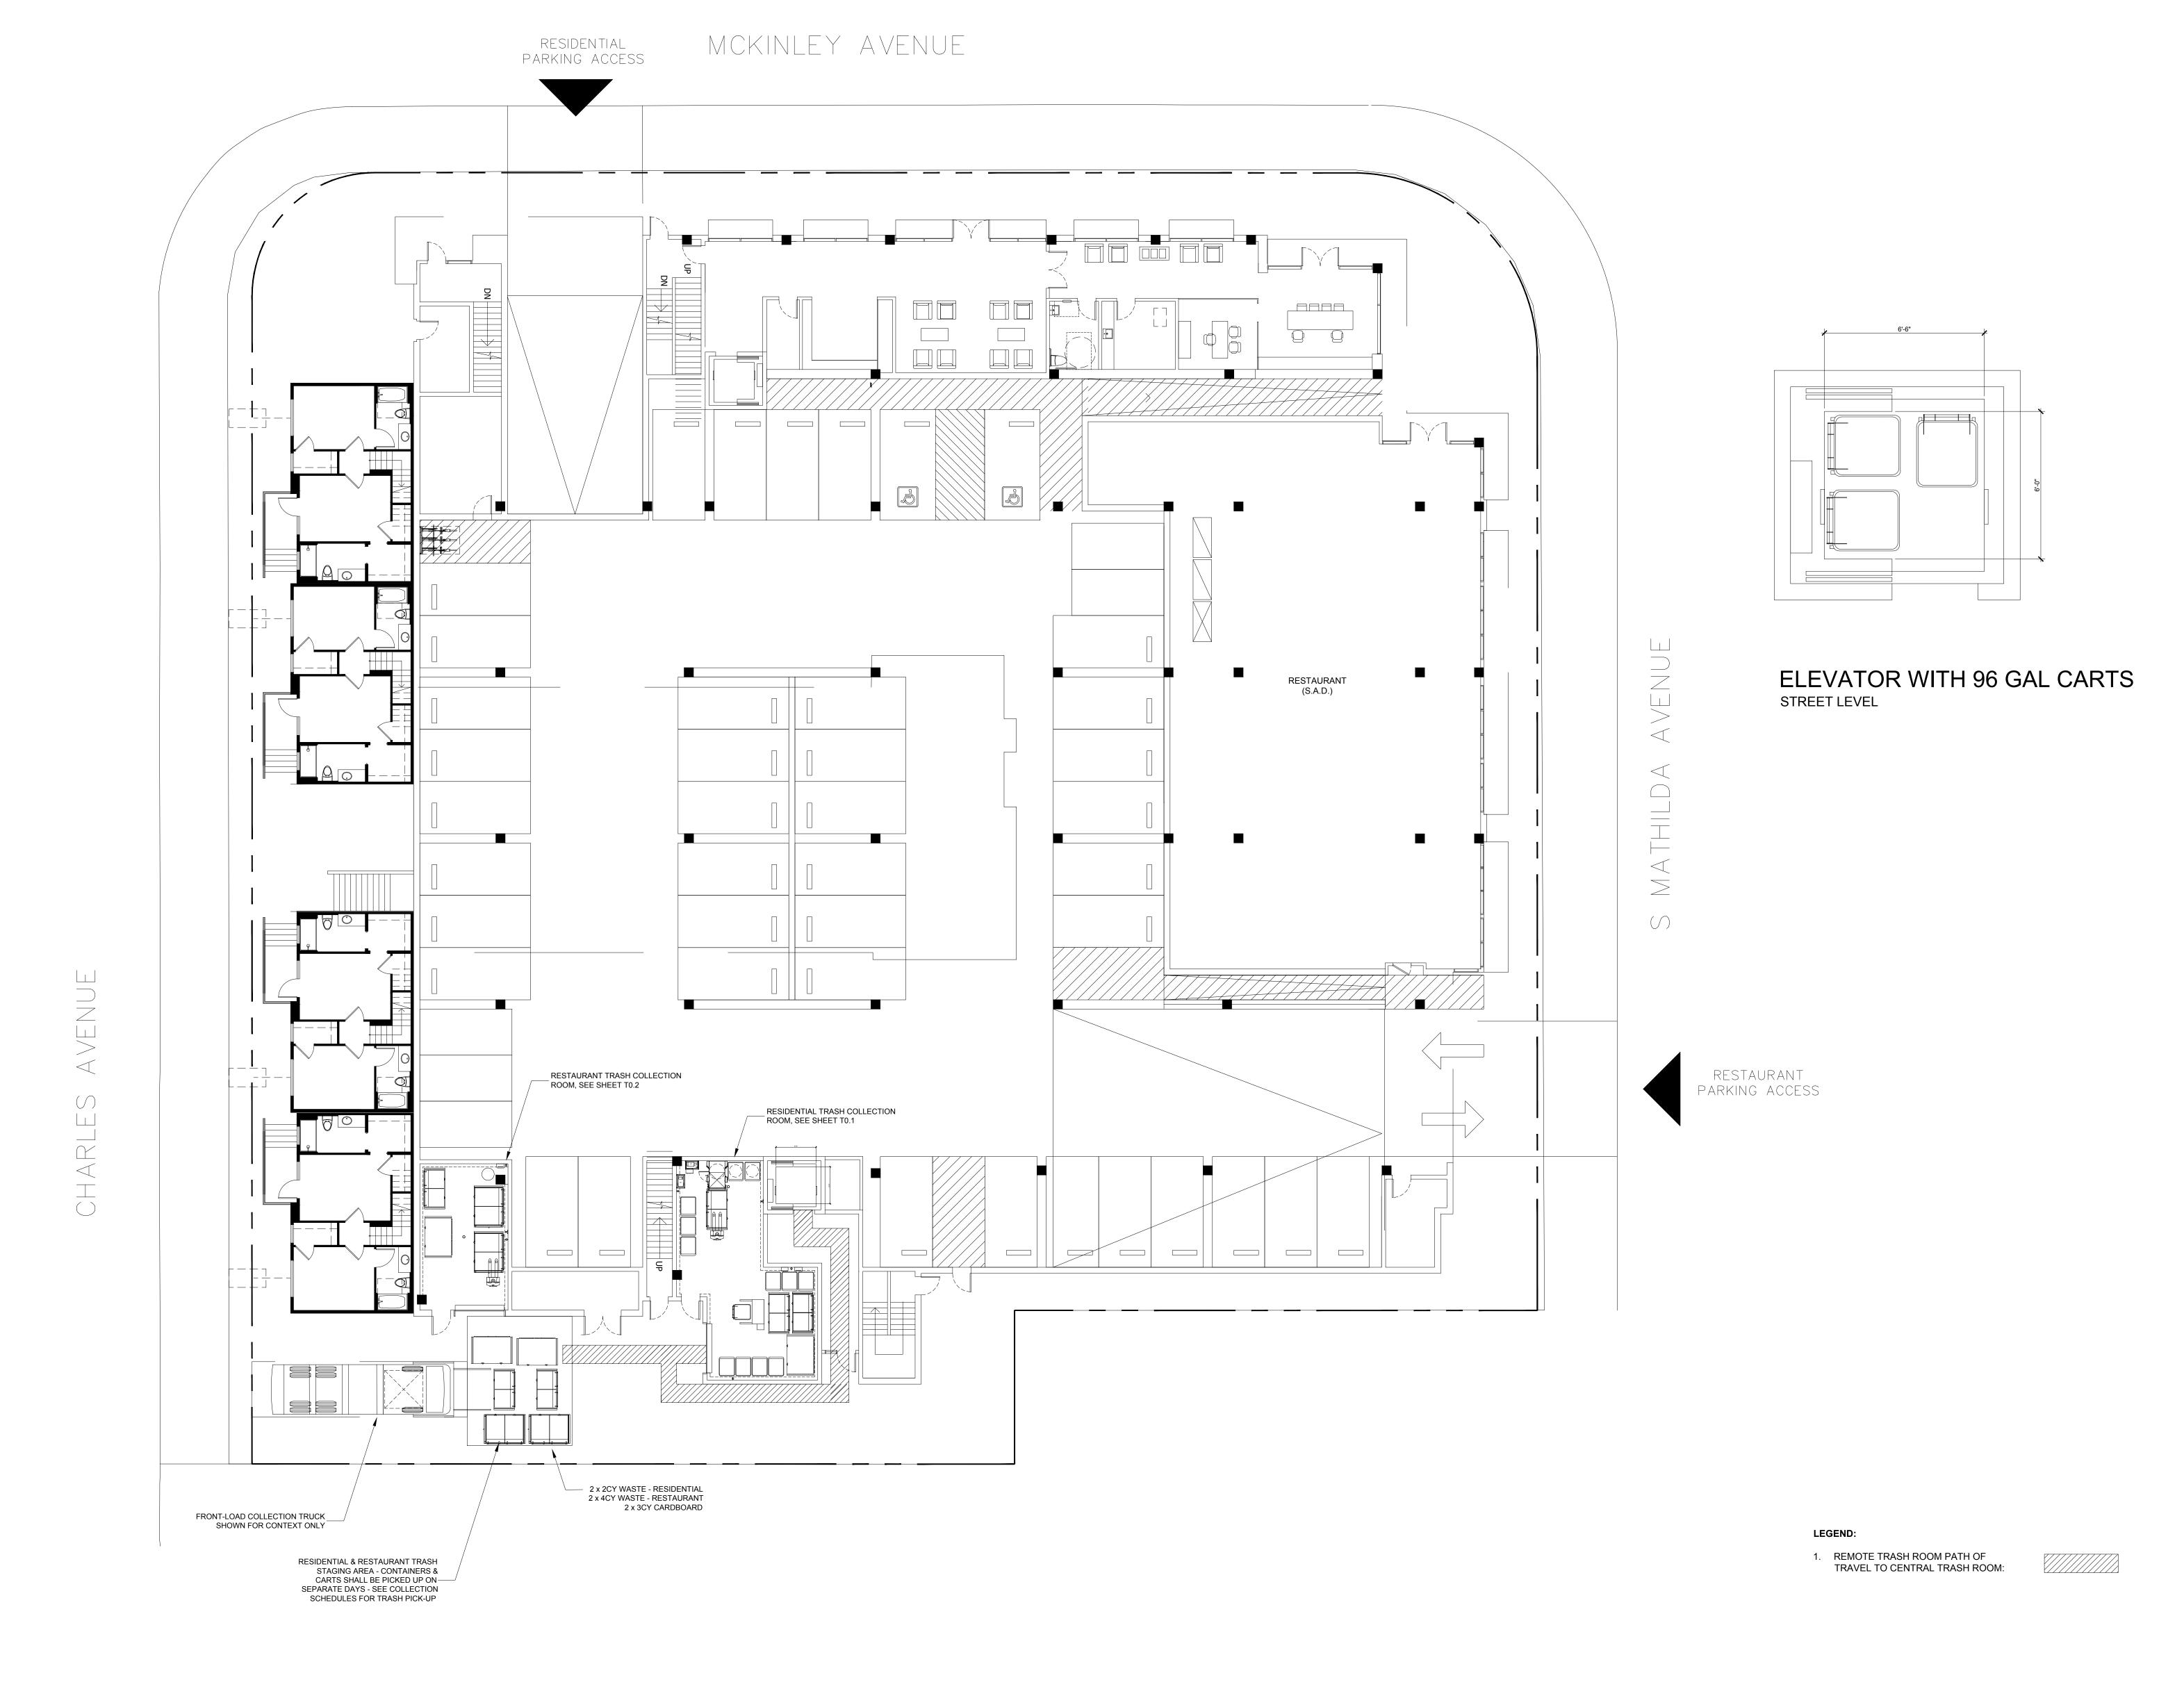

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PATH OF TRAVEL


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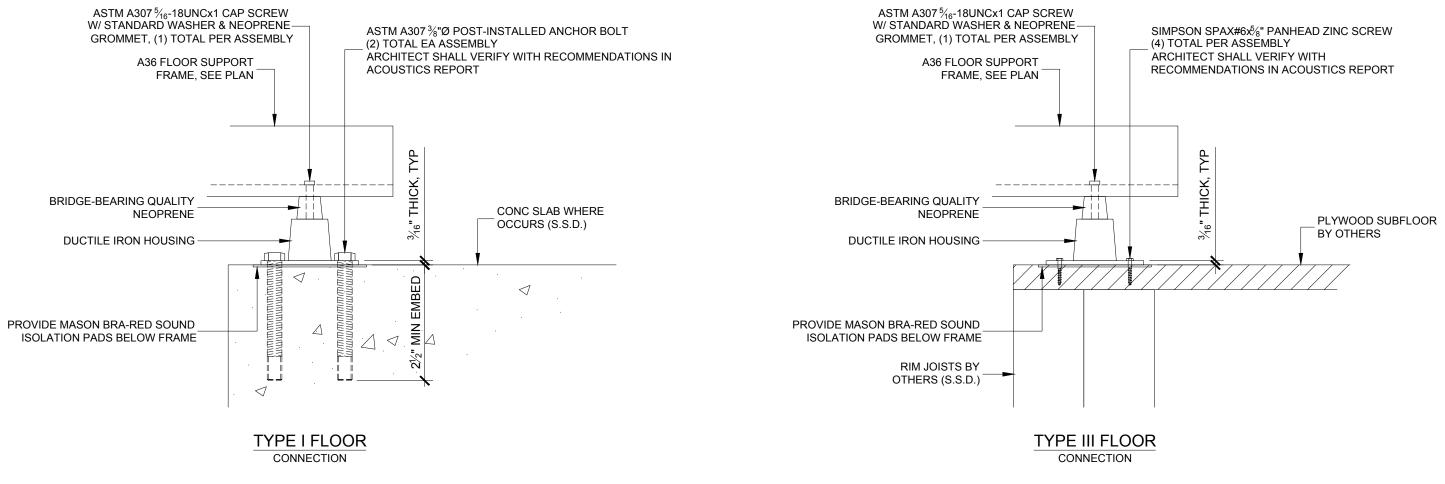
PLAN ELEVATOR TO CENTRAL TRASH ROOM

Job No. 16044 Date: 03/16/2018 Scale: AS INDICATED

Sheet No:

SCALE: 3/32" = 1'-0"



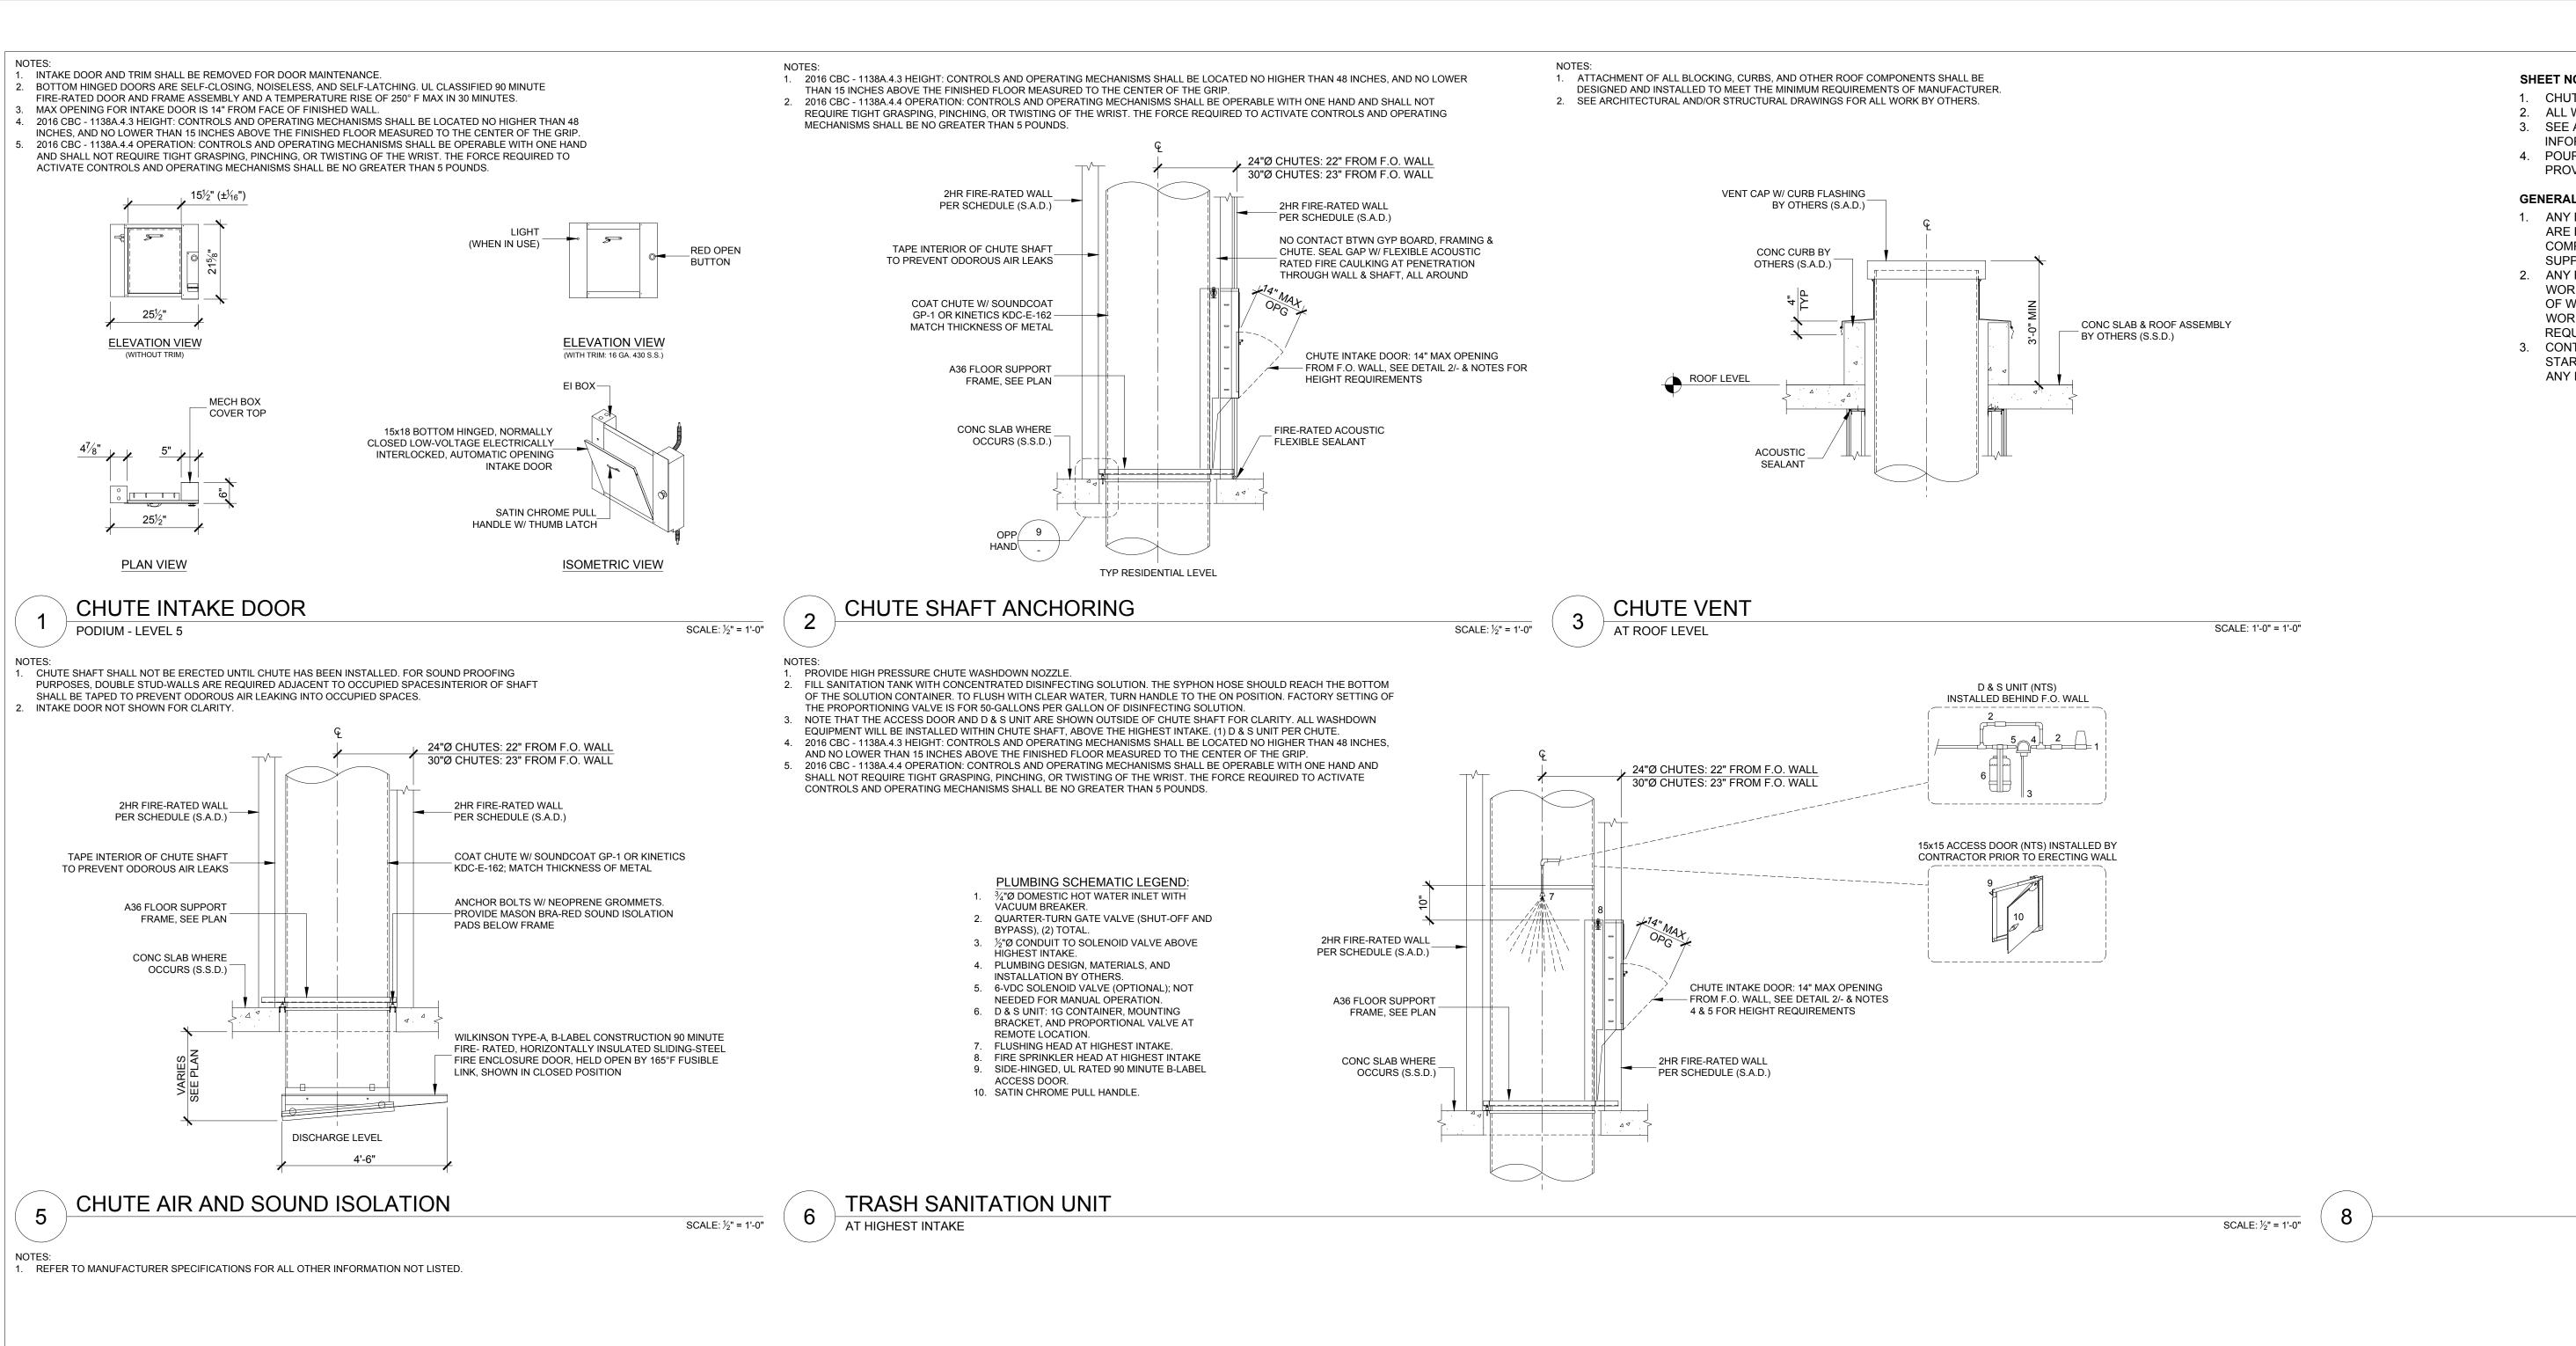

FLOOR SUPPORT FRAME ANCHORING

SCALE: ½" = 1'-0"

#### SHEET NOTES: 24"Ø AND 30"Ø CHUTE DETAILS

- 1. CHUTE MATERIAL: GALVANIZED STEEL 2. ALL WALL ASSEMBLIES ENCASING THE CHUTE SHAFT SHALL BE 2HR FIRE-RATED.
  - 3. SEE ARCHITECTURAL AND/OR STRUCTURAL DRAWINGS TO VERIFY ALL INFORMATION NOT RELATED TO ATM'S SCOPE OF WORK PER AGREEMENT.
  - 4. POUR RINGS WILL VARY BASED ON THICKNESS OF FLOOR SLAB AND SHALL BE PROVIDED BY MANUFACTURER.

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SCALE: ½" = 1'-0"

Mathilda 311

Description

BUILDING PERMIT SUBMITTAL 09/06/2017 PLAN CHECK RESPONSE 03/16/2018



CHUTE DETAILS 24"Ø AND 30"Ø

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