SURVEY PLAN: SURVEY PLAN

LANDSCAPE: L-1 PLANTING PLAN L-2 PARKING SHADING L-3 HYDROZONE PLAN L-4 IRRIGATION PLAN

MEP: E-1.1 PHOTOMETRIC STUDY

CIVIL:
C-01 DEMOLITION PLAN
C-11 GRADING AND DRAINAGE PLAN
C-12 IMPERVIOUS SURFACE DATA

351 SOUTH BAYWOOD AVE SUITE-B SAN JOSE, CA 95128 408 260 6896 W 925 368 7270 C

MARK DATE DESCRIPTION SCALE: PROJECT NO: 17-025 JINYING-2.VWX MODEL FILE:

DRAWN BY: REVIEWED BY:


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> DRAWING TITLE: **DESIGN DATA**


NOT FOR CONSTRUCTION

LIST OF DRAWINGS: ARCHITECTURE: A-001 COVER SHEET DESIGN DATA A-101 SITE PLAN A-102 SITE AREA A-103 SITE AREAS A-104 SITE AREAS AND PLAYGROUND A-105 CIRCULATION PLAN A-106 EXISTING LANDSCAPE AREA A-201 EXISTING FLOOR PLAN A-301 NEW FLOOR PLAN A-302 PLAY AREA A-303 ROOF PLAN A-304 ROOM AREAS A-401 TRASH ENCLOSURE A-501 ELEVATIONS A-502 ELEVATIONS A-601 GATE AND FENCE DETAILS A-602 DETAILS



LOCATION PLAN

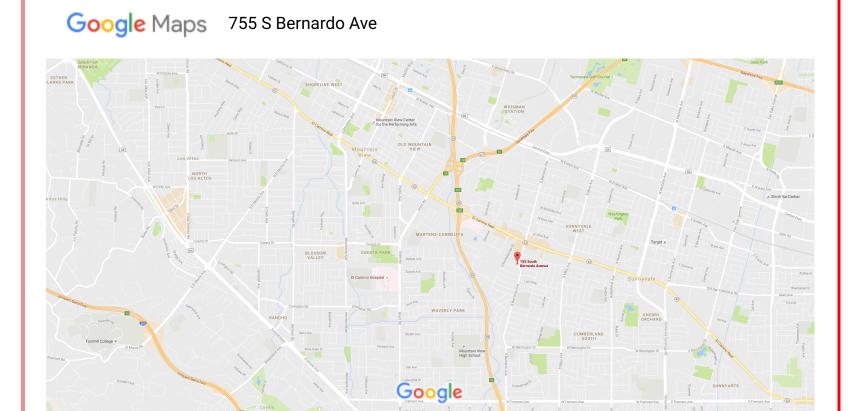Google Maps 755 S Bernardo Ave

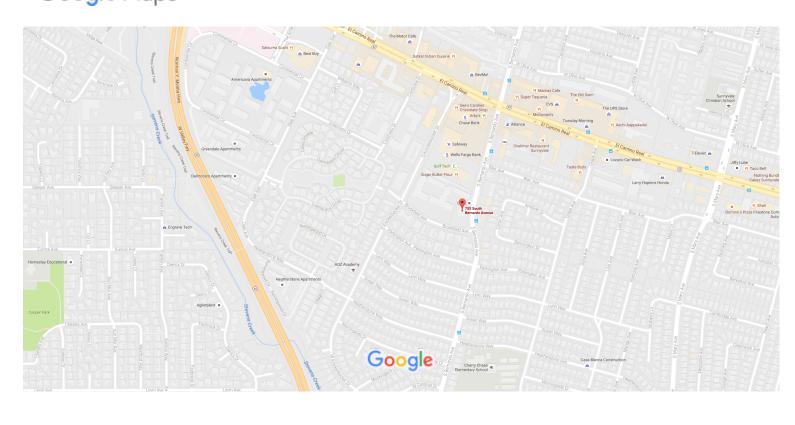

VICINITY PLAN

OWNER:
JY INTERNATIONAL GROUP, INC
660 SOUTH BERNARDO AVE
SUNNYVALE, CA 94087

37,887 SQ.FT. 6920.3 SQ.FT.

6920.3 / 37,887 = 0.182= 18%

0.18 = 18%

31 STALLS PROVIDED REQUIRED PARKING IS 0.25 STALL PER CHILD = 120 X 0.25 = **30** ELECTRIC VEHICLE PARKING: 3% OF TOTAL PARKING. 3% OF 31 STALLS = 0.93 = 1 STALL

RIDESHARE PARKING: 5% OF TOTAL PARKING. 5% OF 31 STALLS = 1.6 = 2 STALLS

LANDSCAPING: PROVIDED 9,292.00 SQ.FT. (REQUIRED: 20% OF PARKING AREA = 20% OF 15,397.5 SQ.FT. = **3,079.5 SQ.FT.**) LANDSCAPE - WALKWAY AREA:

LANDSCAPE TOTAL WITH PLAYGROUND = 9292 + 4687.4 = 13,979.4 SQ.FT.

PLAYGROUND AREA: 4687.4 SQ.FT. **EXISTING LANDSCAPING:** 3049.1 SQ.FT

EXISTING IMPERVIOUS AREA: 34,837.9 SQ.FT. (BUILDING DRIVEWAYS, WALKWAYS) **EXISTING PARKING:** 49 (TWO FOR DISABLED PERSONS)

DESIGN DATA

BICYCLE PARKING:5% OF TOTAL PARKING. 5% OF 31 STALLS = 1.6 = 2 STALLS

PRESCHOOL-STUDENTS: 120 STUDENTS AGES 2 TO 6

TOTAL OF ALL LANDSCPE =9,292.00 SQ.FT.20% OF SITE AREA = 37,887 X 20% = **7577.4 SQ.FT**.
IN RELATION TO SITE:

PARKING AREA: 15,397.5 SQ.FT.

DEVELOPER IS RESPONSIBLE FOR RESTORING AND REPLACING ANY DAMAGE IN THE PUBLIC RIGHT OF WAY OR ANY DAMAGE TO THE TRAFFIC CONTROL DEVICES CAUSED DUE TO CONSTRUCTION ACTIVITIES.

DEVELOPER IS RESPONSIBLE FOR RESEARCH ON ALL EXISTING UTILITY LINES TO ENSURE THAT THERE ARE NO CONFLICTS WITH THE PROJECT.

ALL EXISTING UTILITY LINES (PUBLIC OR PRIVATE) AND/OR THEIR APPURTENANCES NOT SERVING THE PROJECT SHALL BE CAPPED, ABANDONED, REMOVED, RELOCATED AND / OR DISPOSED OF TO THE SATISFACTION OF THE CITY. EXISTING PUBLIC FACILITIES WITHIN THE STREET RIGHT OF WAY, SHALL BE ABANDONED PER CITY'S ABANDONMENT NOTES, INCLUDING ABANDONMENT BY OTHER UTILITY OWNERS.

C.
THIS PROJECT IS REQUIRED TO FOLLOW THE EXISTING SANITARY SEWER AND STORM DRAIN TRIBUTARY PATTERN. ANY DEVIATIONS WOULD
REQUIRE ADDITIONAL ANALYSIS AND SUBJECT APPROVAL BY DIRECTOR OF PUBLIC WORKS AS PART OF THE OFF SITE IMPROVEMENT PLAN
REVIEW PROCESS. THIS PROJECT SHALL NOT CAUSE ANY NEGATIVE IMACT ON THE DRAINAGE PATTERN FOR ADJACENT PROPERTIES.

SCOPE OF WORK: TENANT IMPROVEMENT, FOR PROPOSED PRE-SCHOOL FACILITY WITHIN EXISTING BUILDING.

NO ALTERATIONS TO EXISTING BUILDING, EXCEPT INSTALLATION OF NEW EXIT DOORS IN PLACE OF EXISTING AND REPLACEMENT OF DOORS BY WINDOWS OF SAME SIZE. INSTALLATION OF NEW EXIT DOOR IN FRONT WALL LEADING FROM A CLASSROOM REPLACEMENT/RECONFIGURATION OF EXISTING FRONT STAIR, SIDEWALK AT THE BUILDING SIDE AND FRONT OF THE BUILDING

FOR COMPLIANCE TO ACCESSIBILITY STANDARDS MODIFICATION TO EXISITING PARKING FOR ACCESSIBILITY STANDARDS.

INSTALLATION OF NEW PLAYGROUND PERIMETER FENCING AT BUILDING REAR AND SIDE, INCLUDING GATES AND EMERGENCY VEHICLE ACCESS GATE.


NEW ACCESSIBLE PARKING AND SITE SIGNAGE WITHIN SIGNAGE PROGRAM OF THE PRE-SCHOOL.

INSTALLATION OF NEW PLAYGROUND AT REAR WITHIN EXISTING OPEN SPACE. EXISTING DRAINAGE WILL BE MAINTAINED

PLAYGROUND WILL HAVE ARTIFICIAL TURF WITH BIKE ROUTE IN ASPHALT-CONCRETE.
RECONFIGURE / ENHANCE LANDSCAPING IN AREA AROUND PROPOSED PLAYGROUND, PARKING AND FRONT ENTRANCE.

PLANNING APPROVALS

BUILDING DEPARTMENT APPROVALS

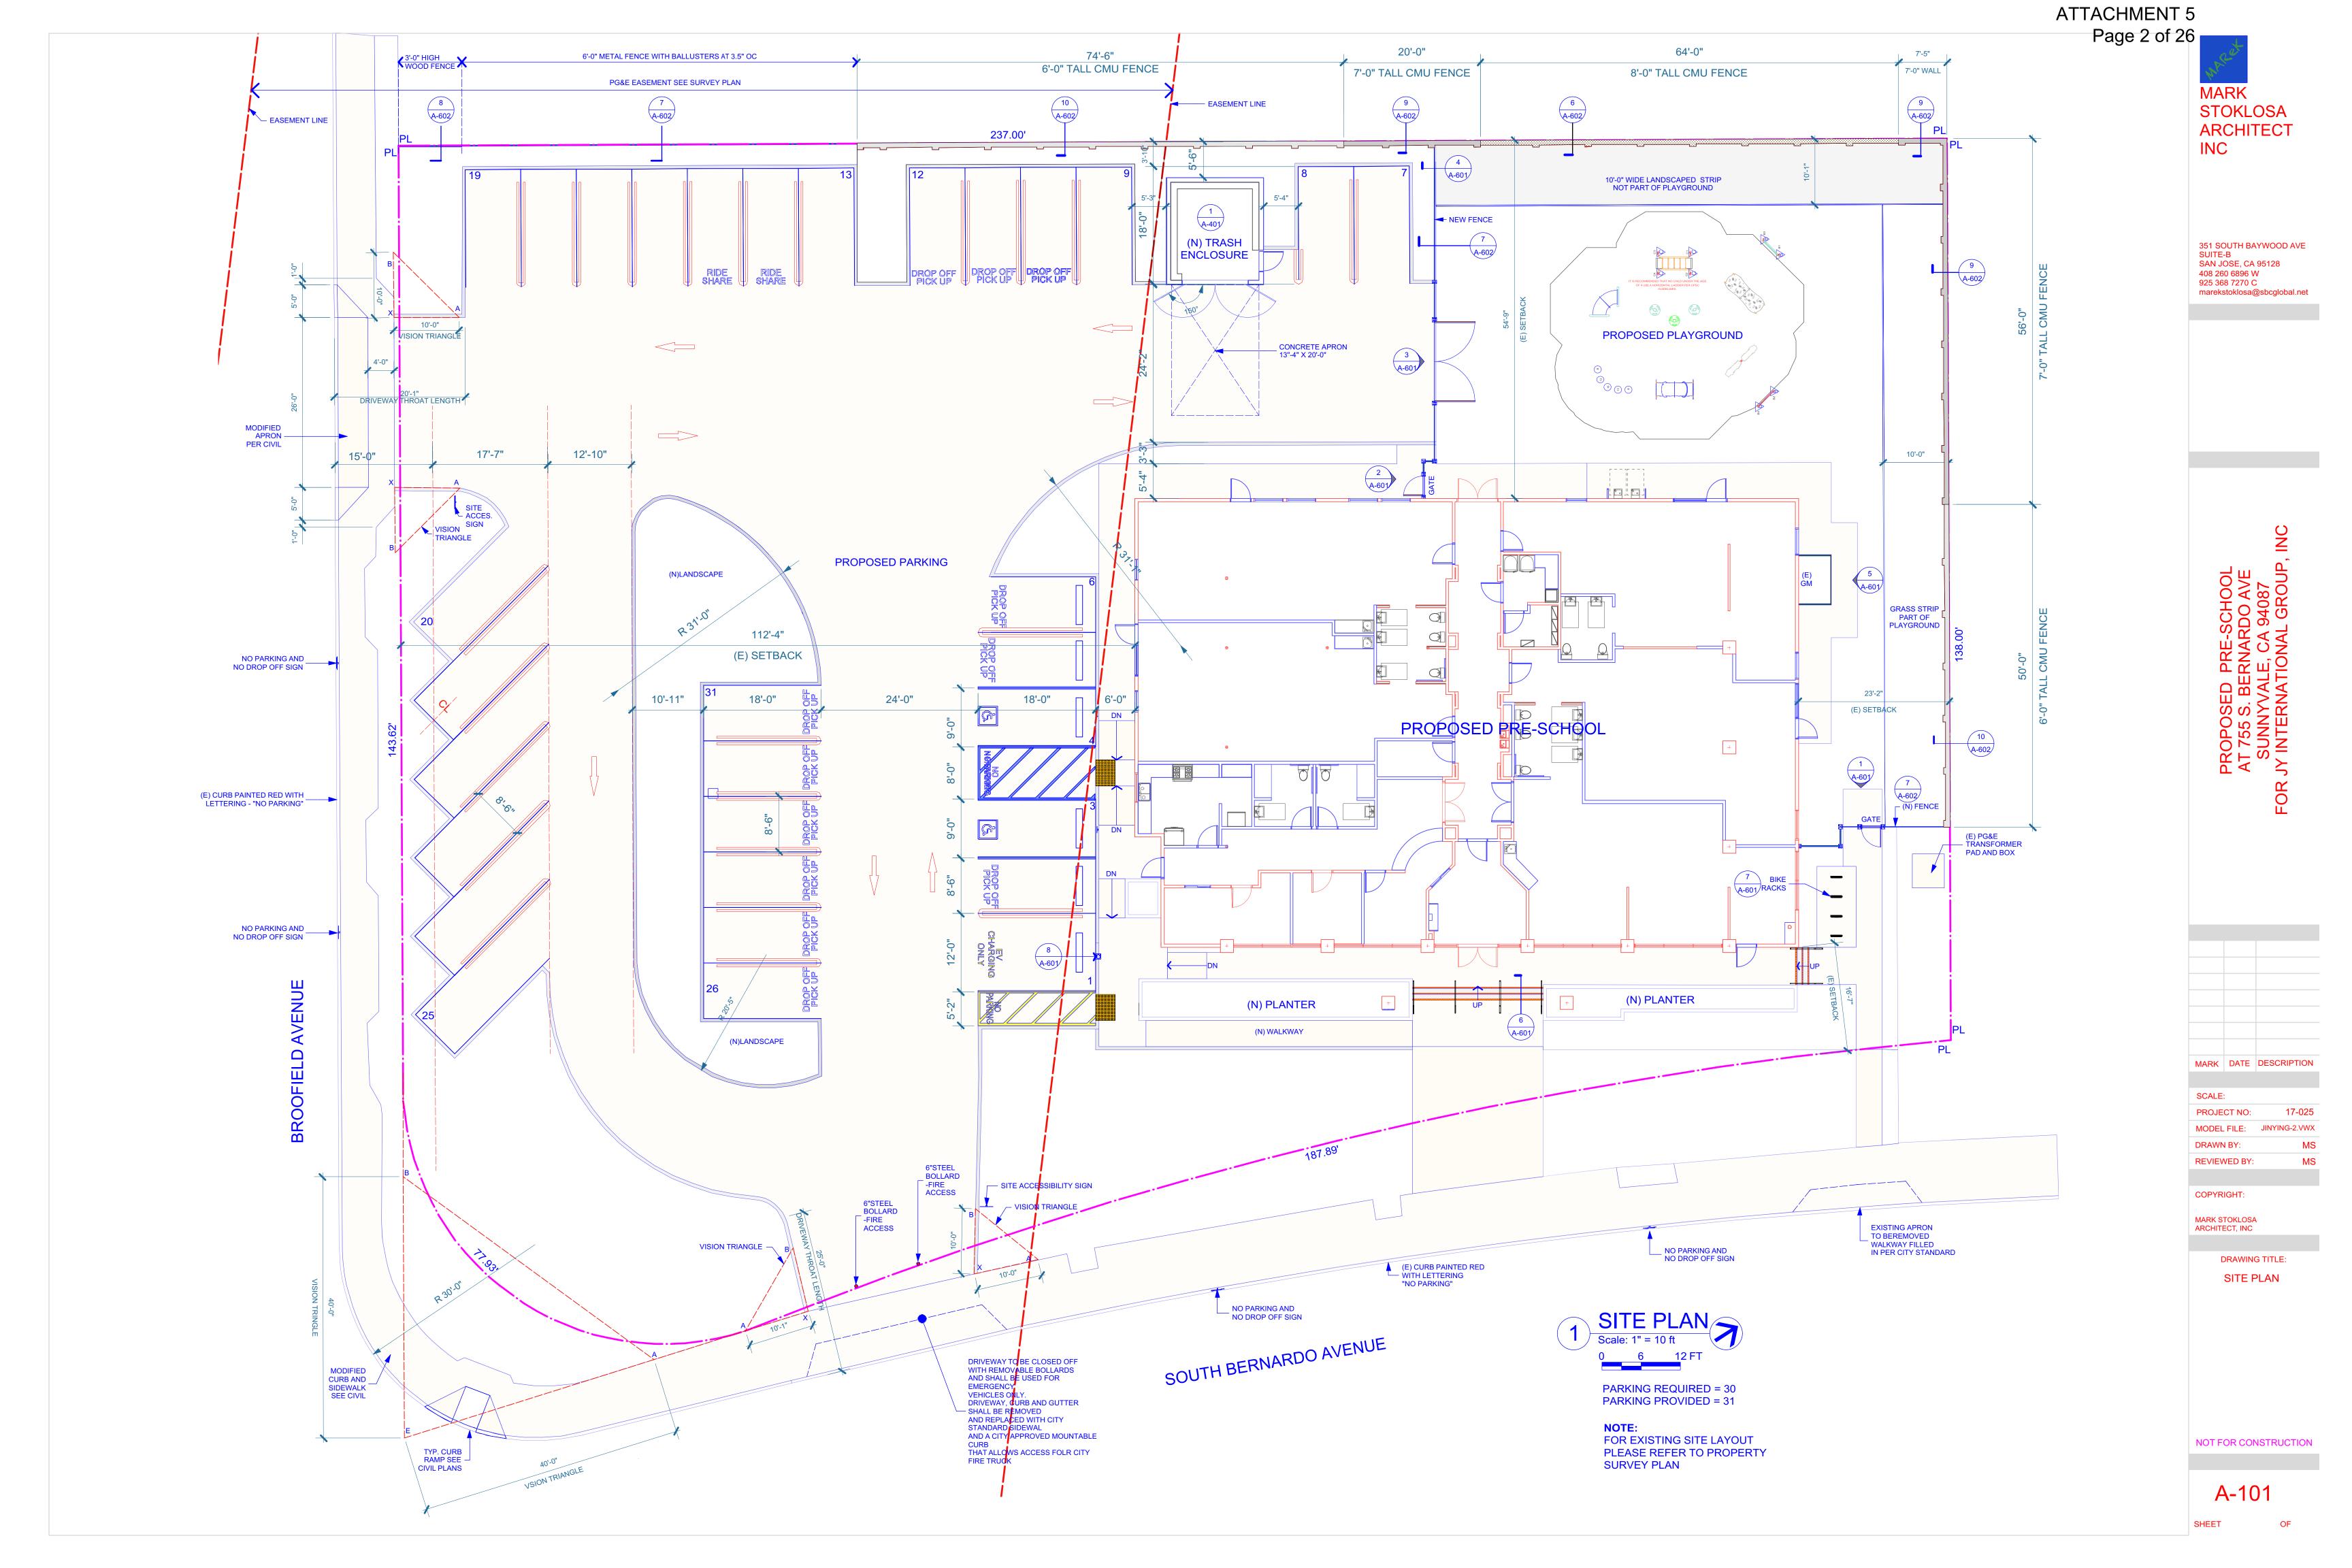

351 SOUTH BAYWOOD AVE SUITE-B SAN JOSE, CA 95128 408 260 6896 W 925 368 7270 C marekstoklosa@sbcglobal.net

MARK DATE DESCRIPTION

SCALE: PROJECT NO: 17-025 MODEL FILE: JINYING-2.VWX DRAWN BY: MS REVIEWED BY: MS


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DRAWING TITLE: SITE AREA

NOT FOR CONSTRUCTION

A-102




SITE AREA

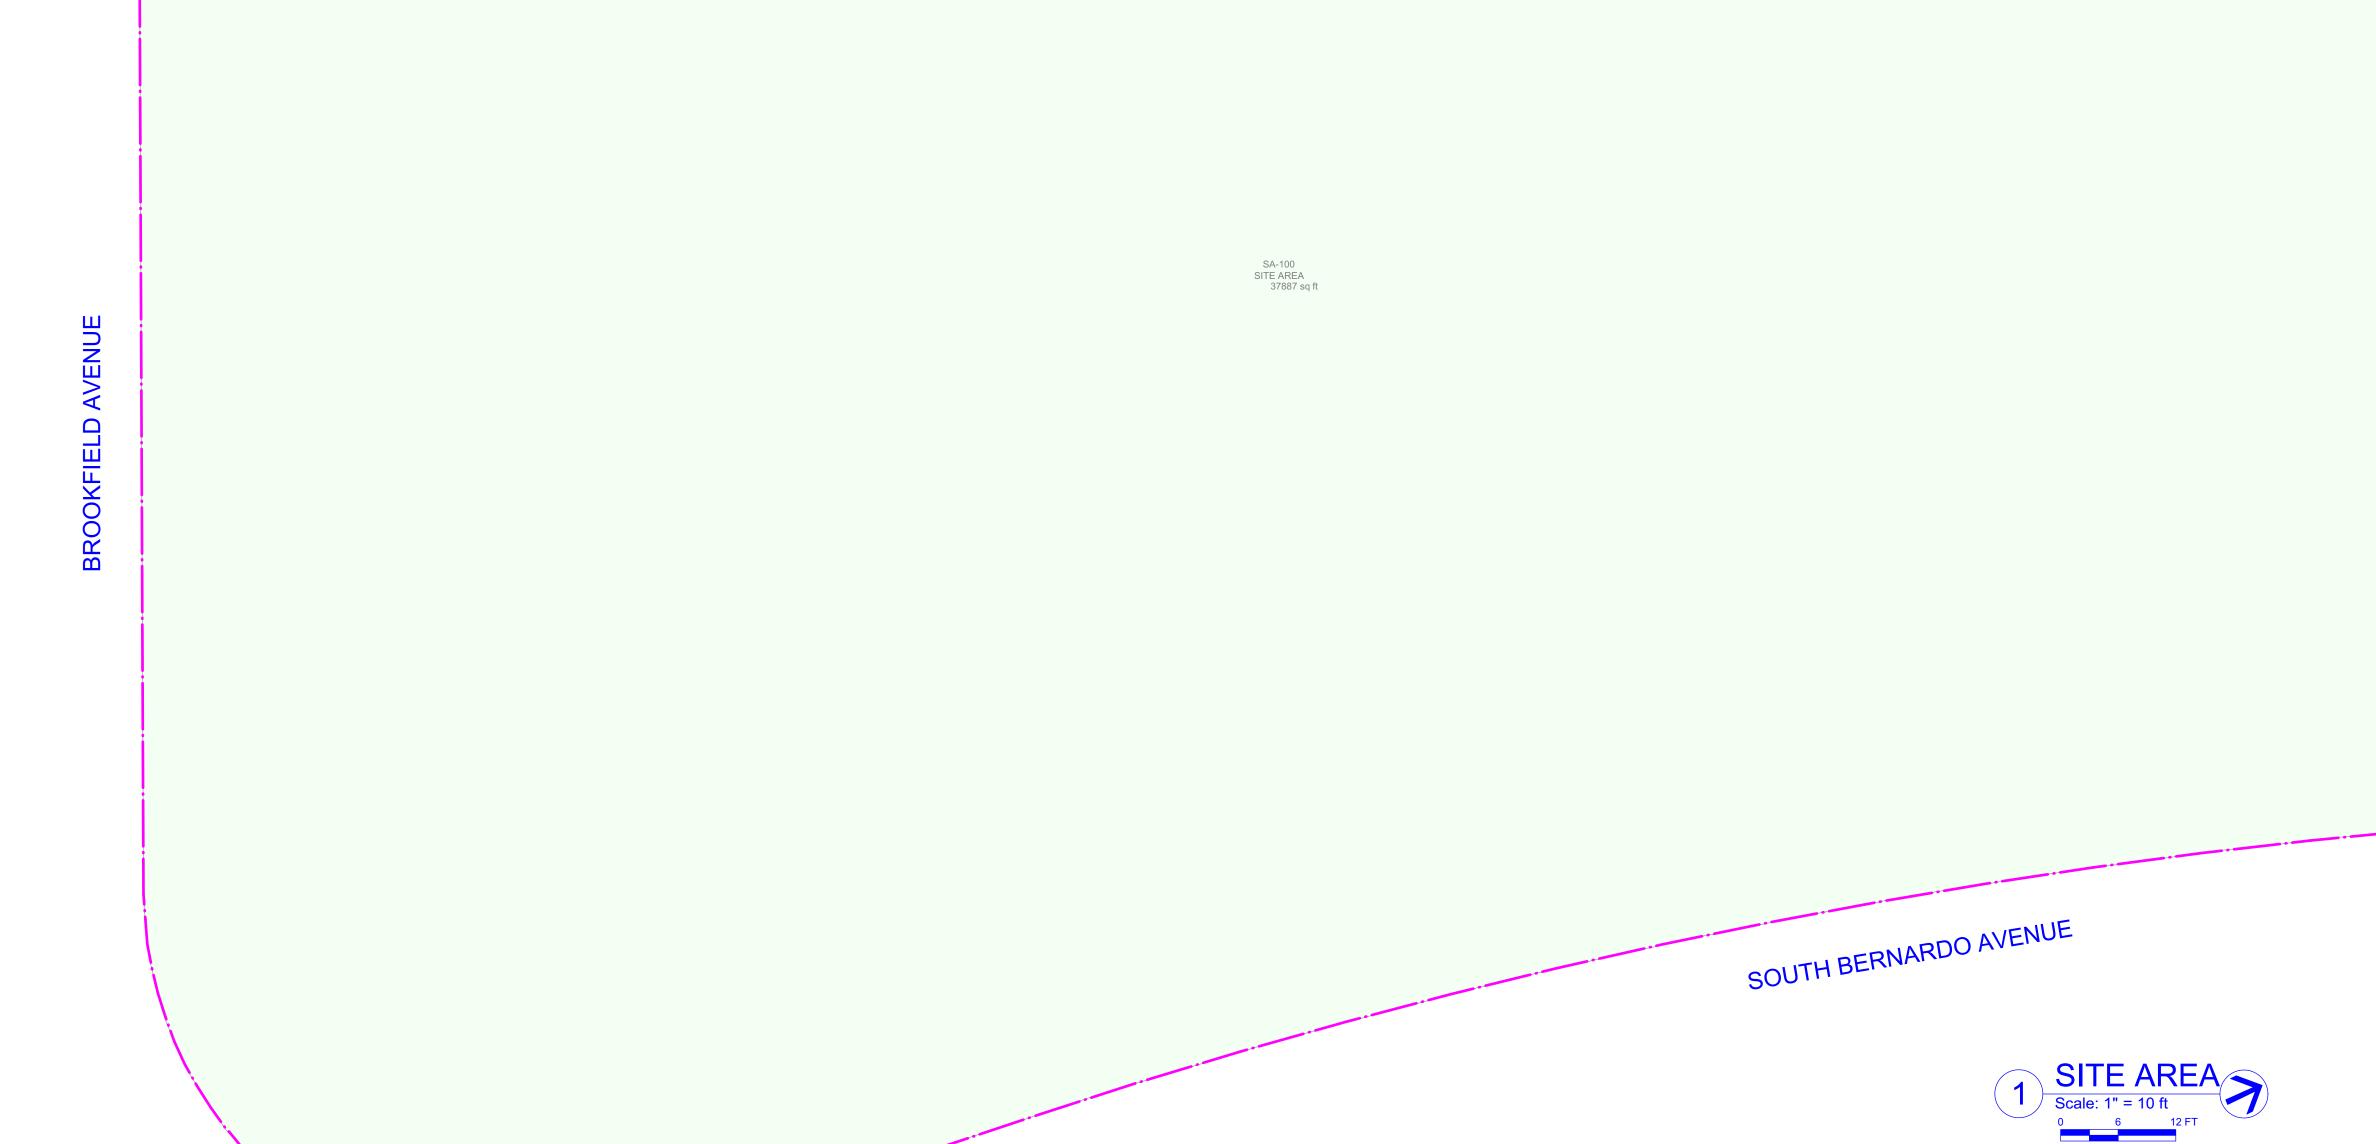
SPACE NUMBER SA-100

SPACE NAME SITE AREA


NET AREA NUMBER
3788

37887

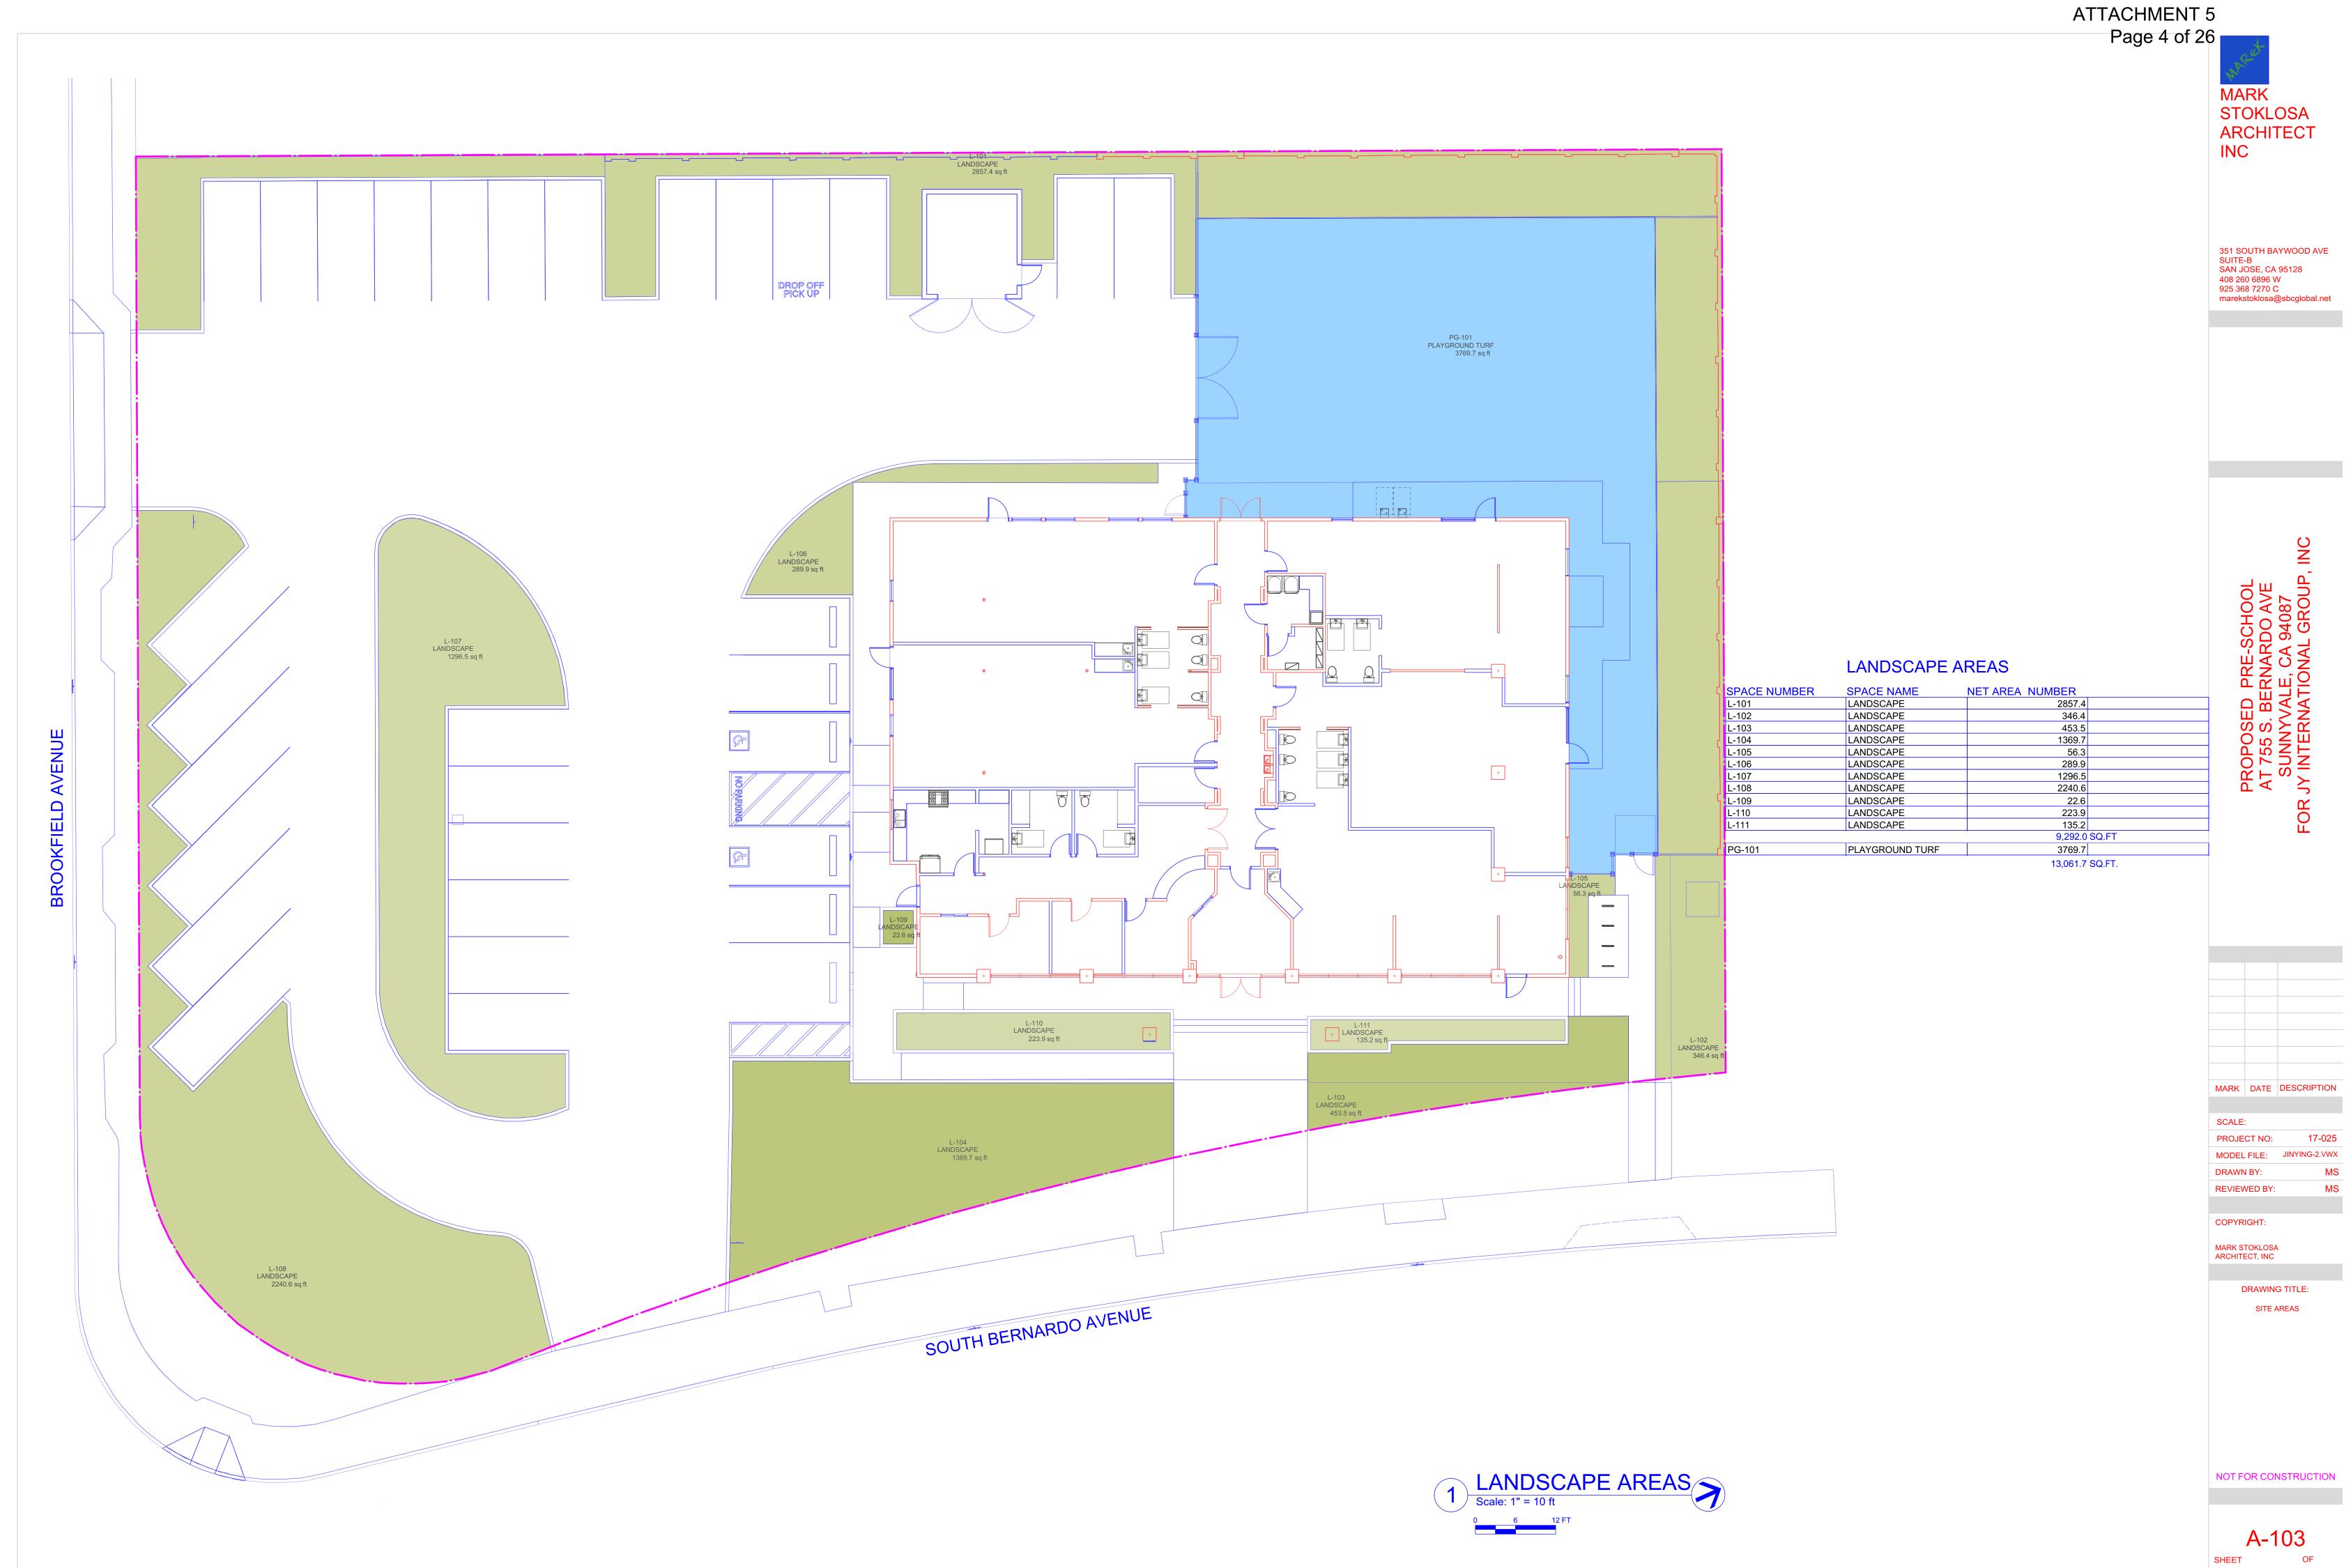

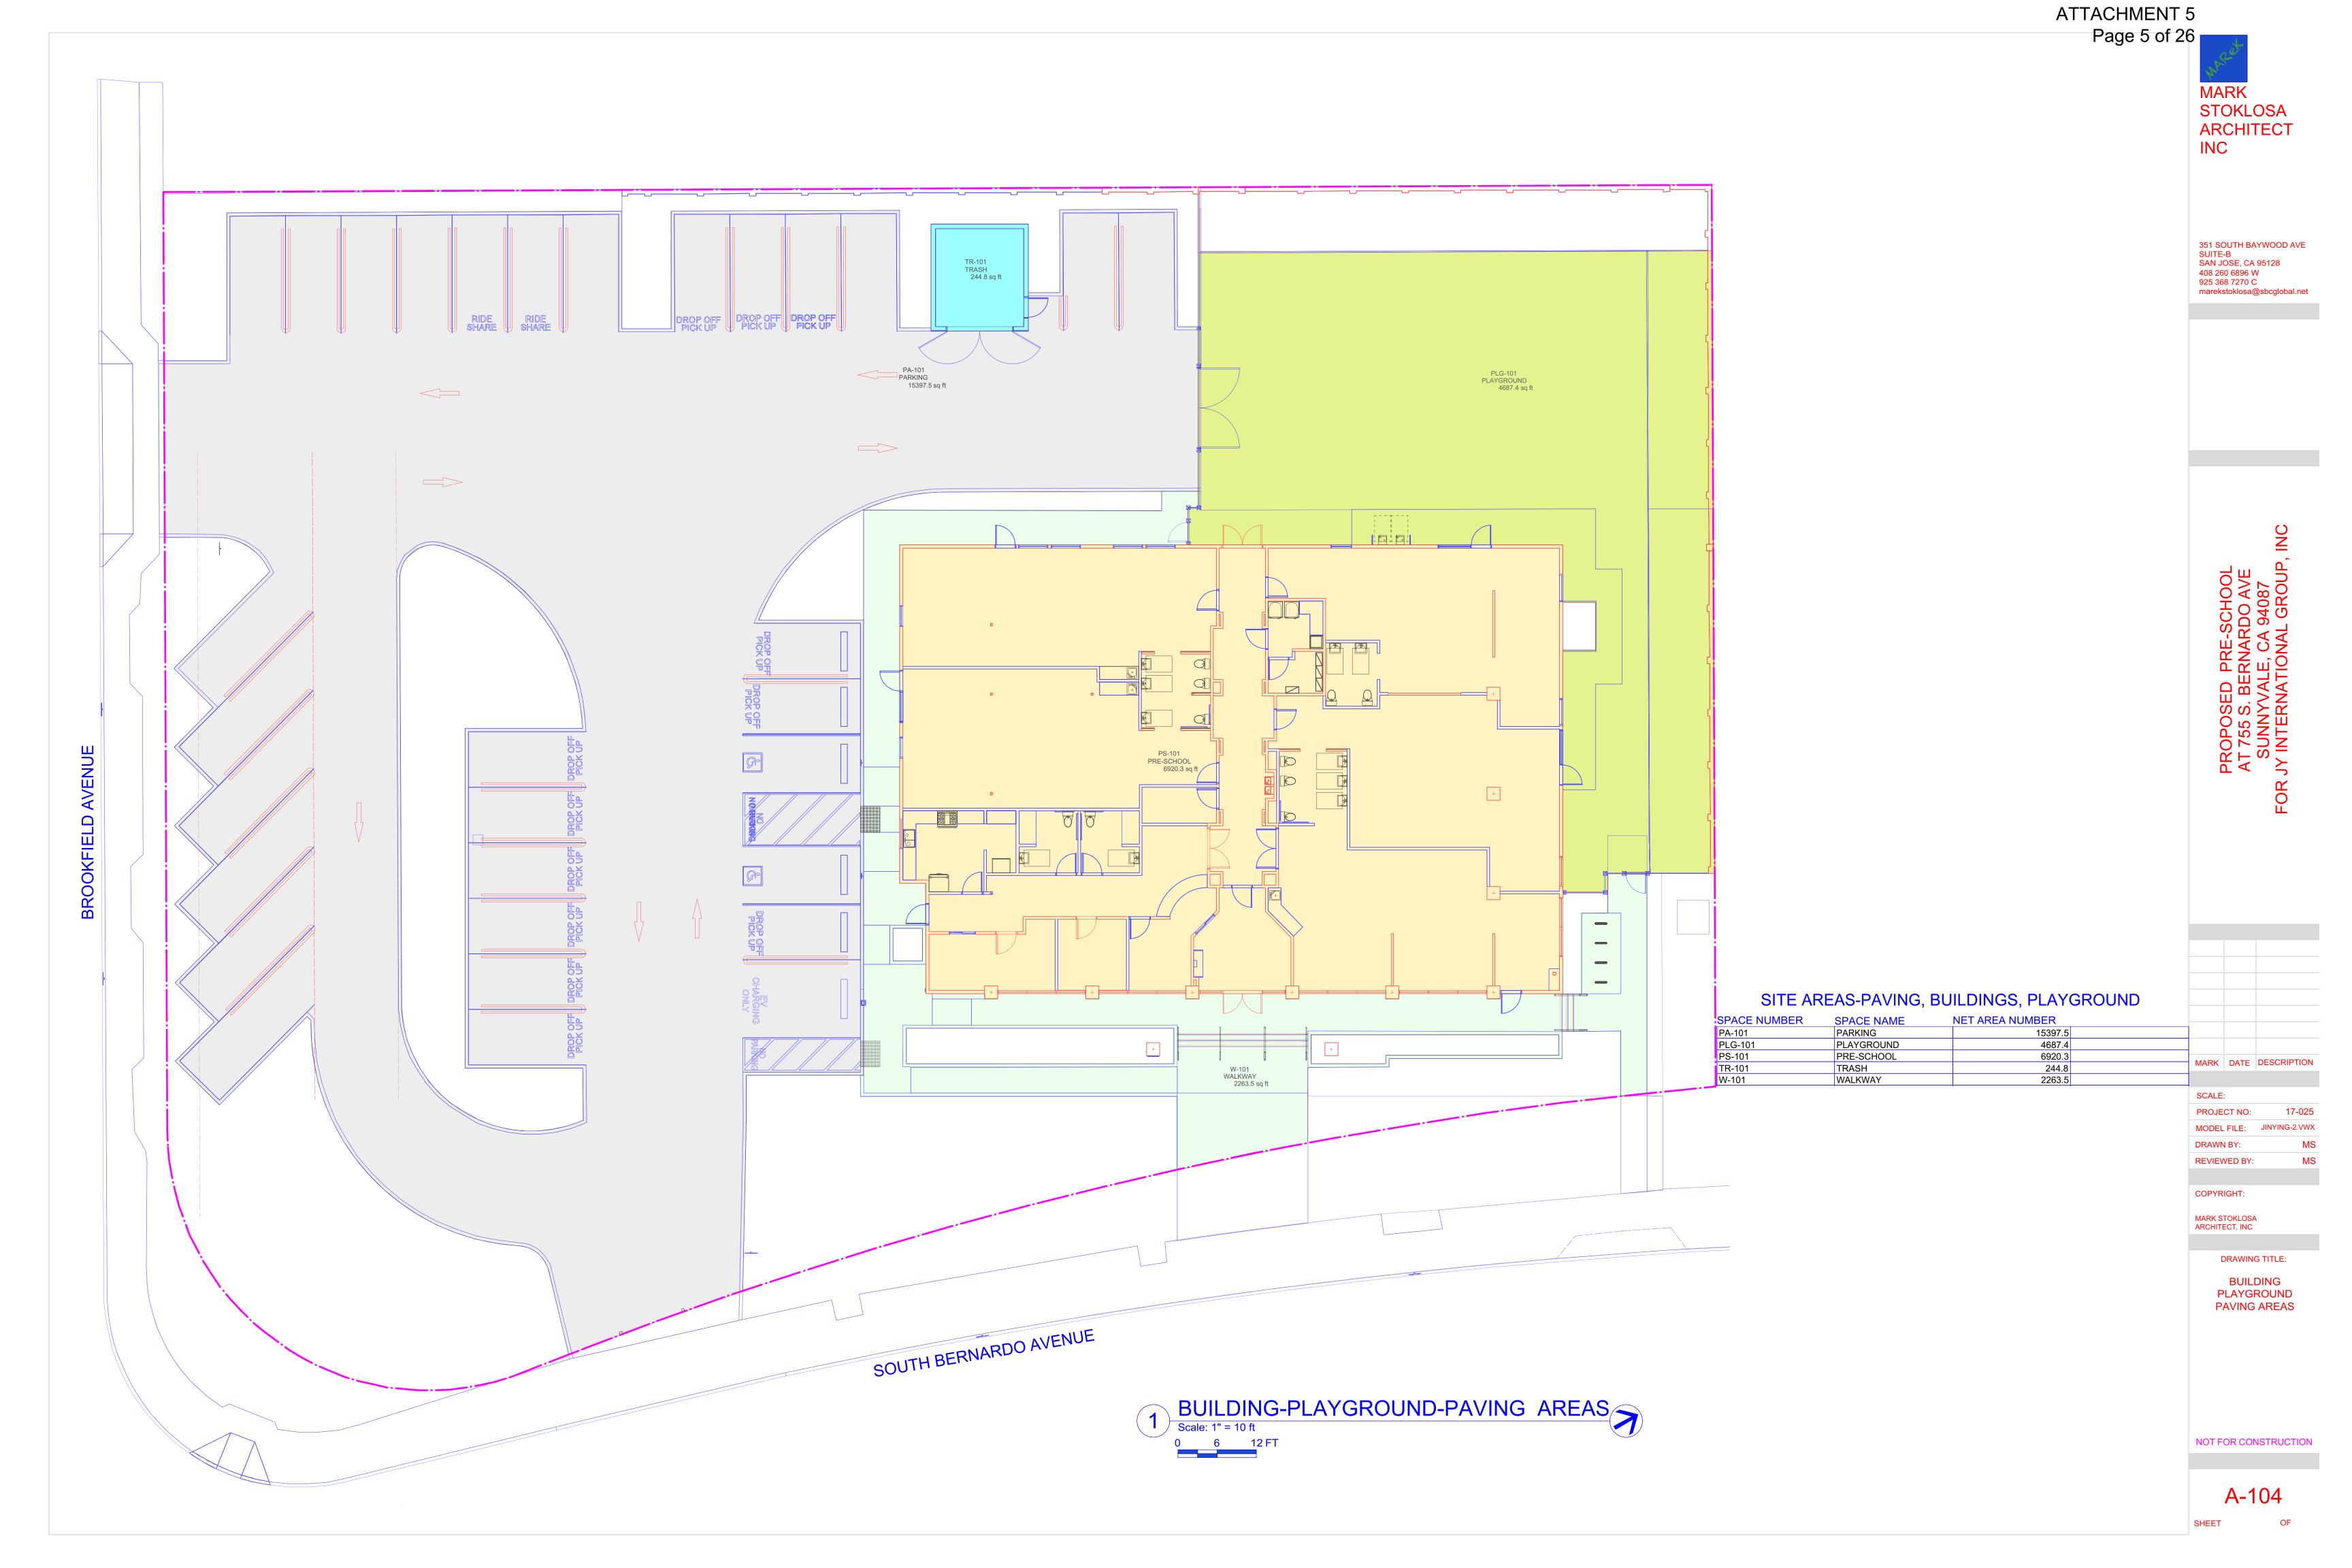

17-025

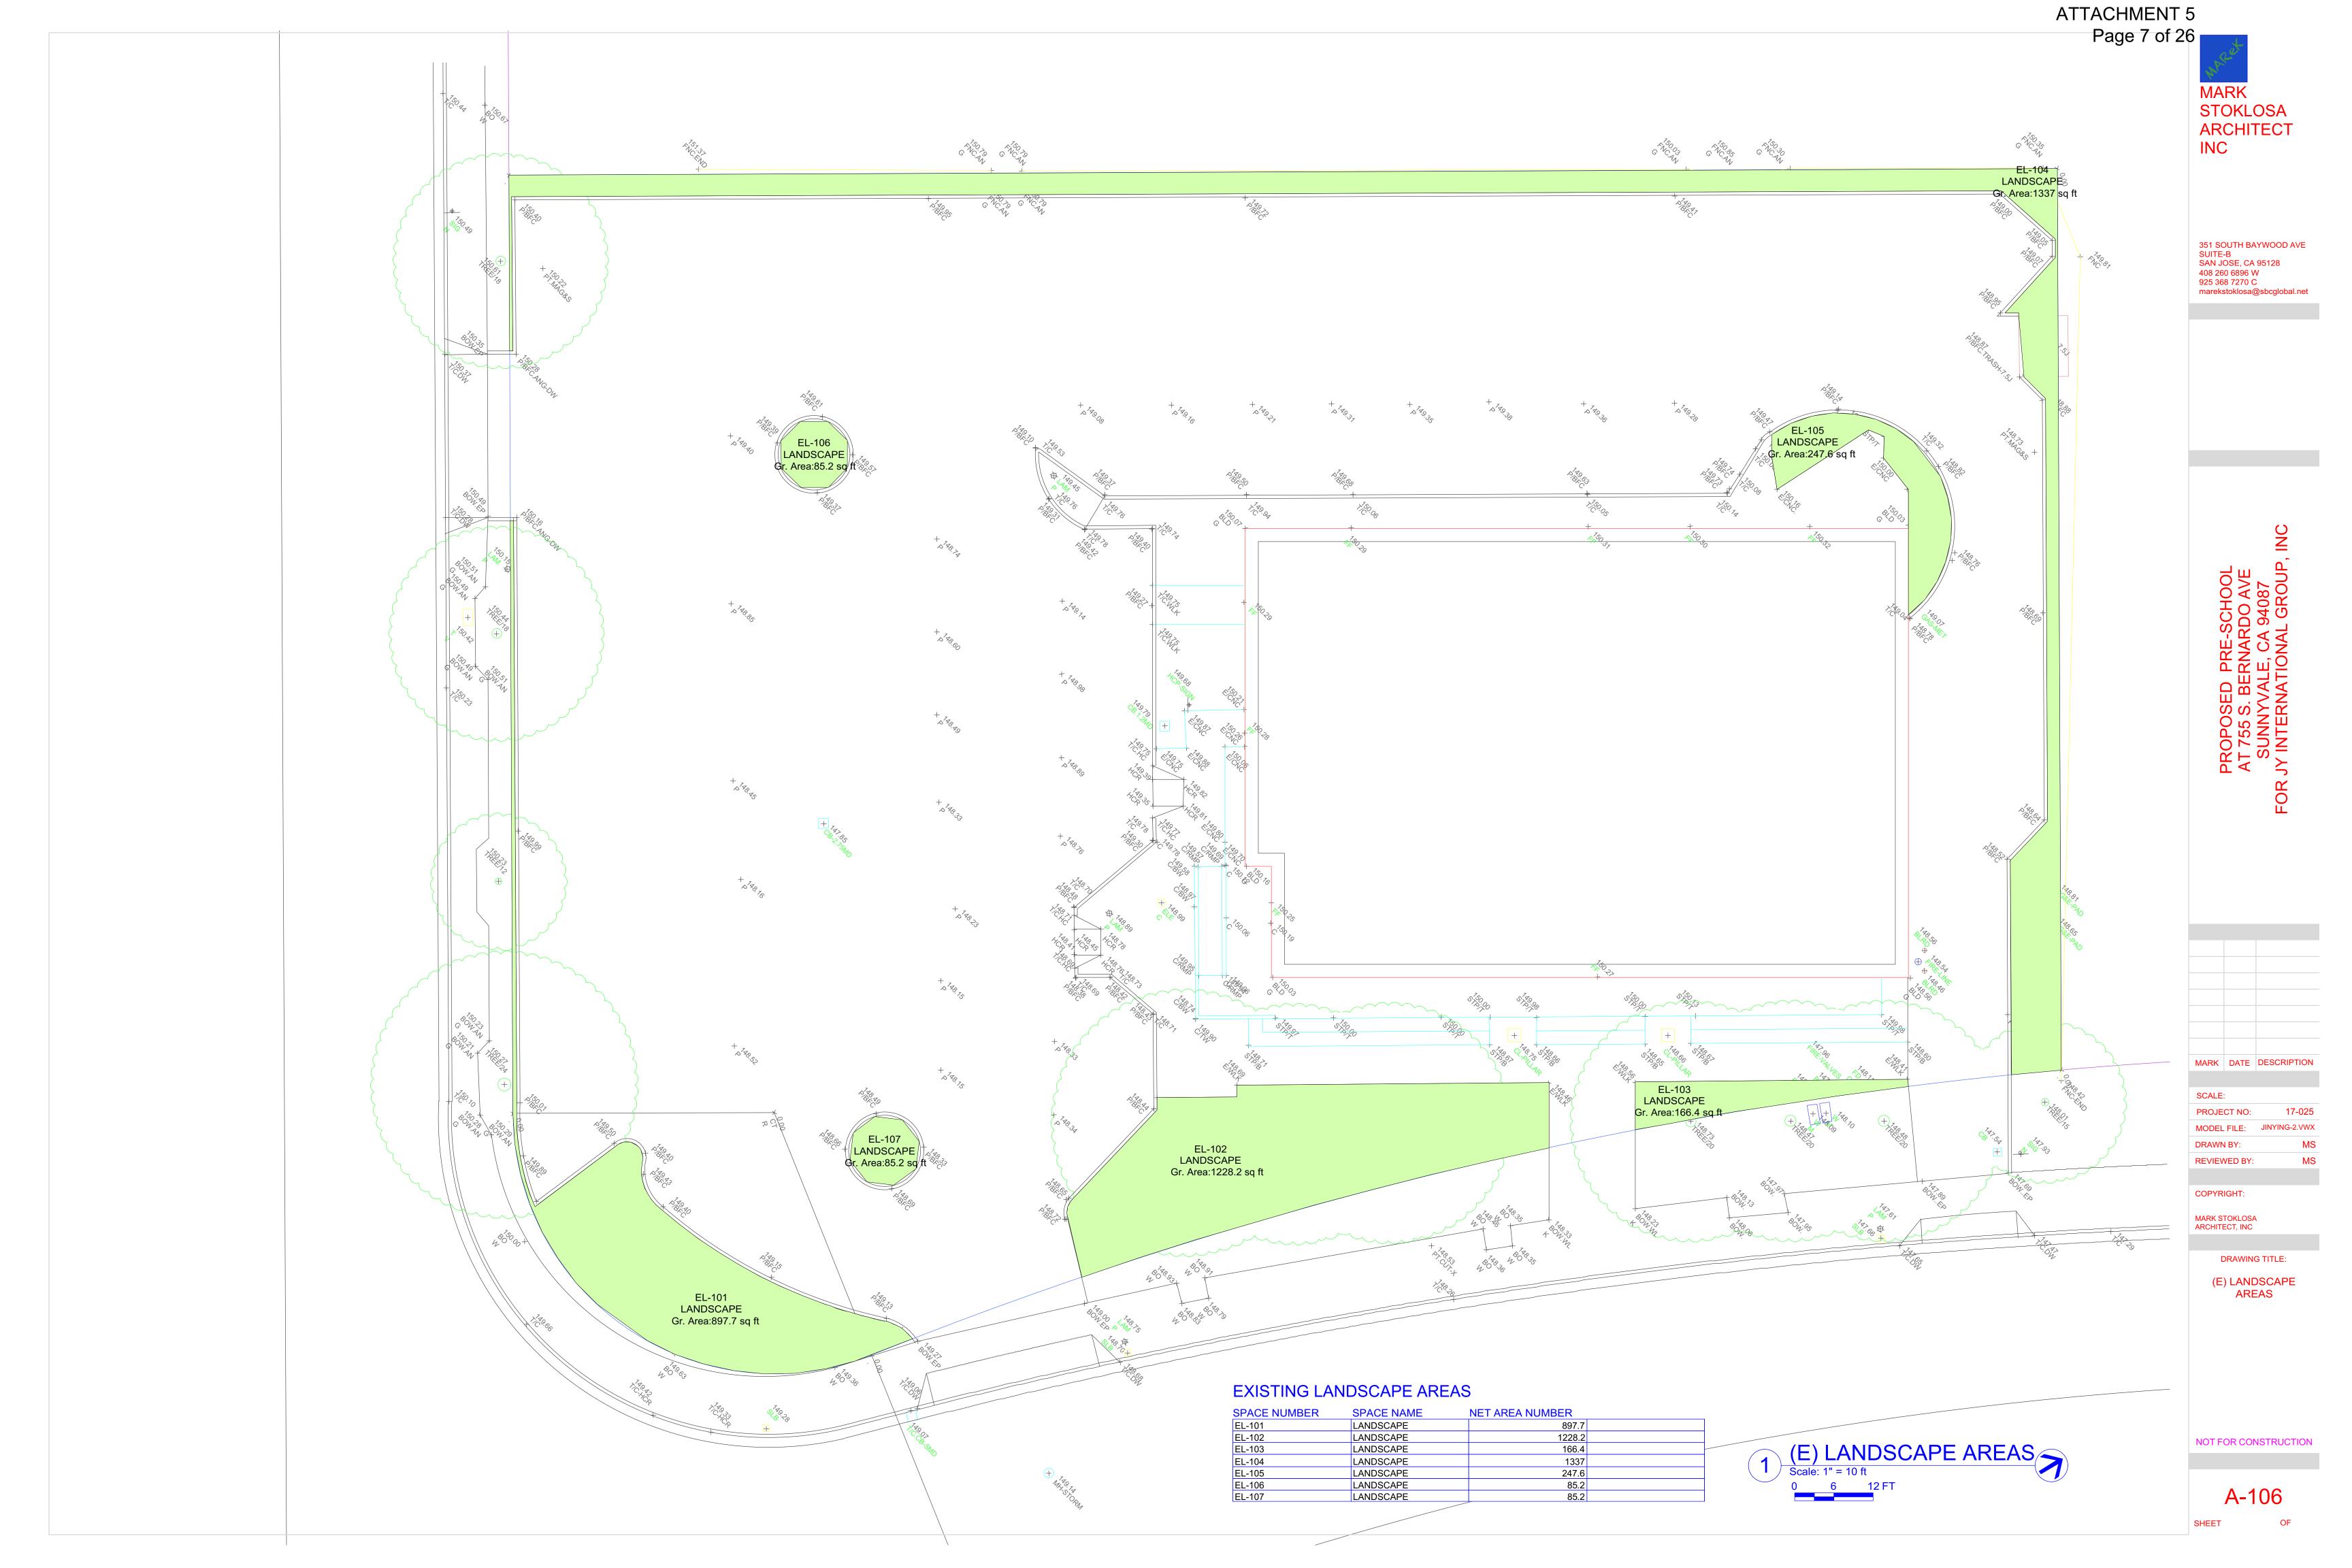


17-025 MODEL FILE: JINYING-2.VWX

NOT FOR CONSTRUCTION

SHEET

ATTACHMENT 5

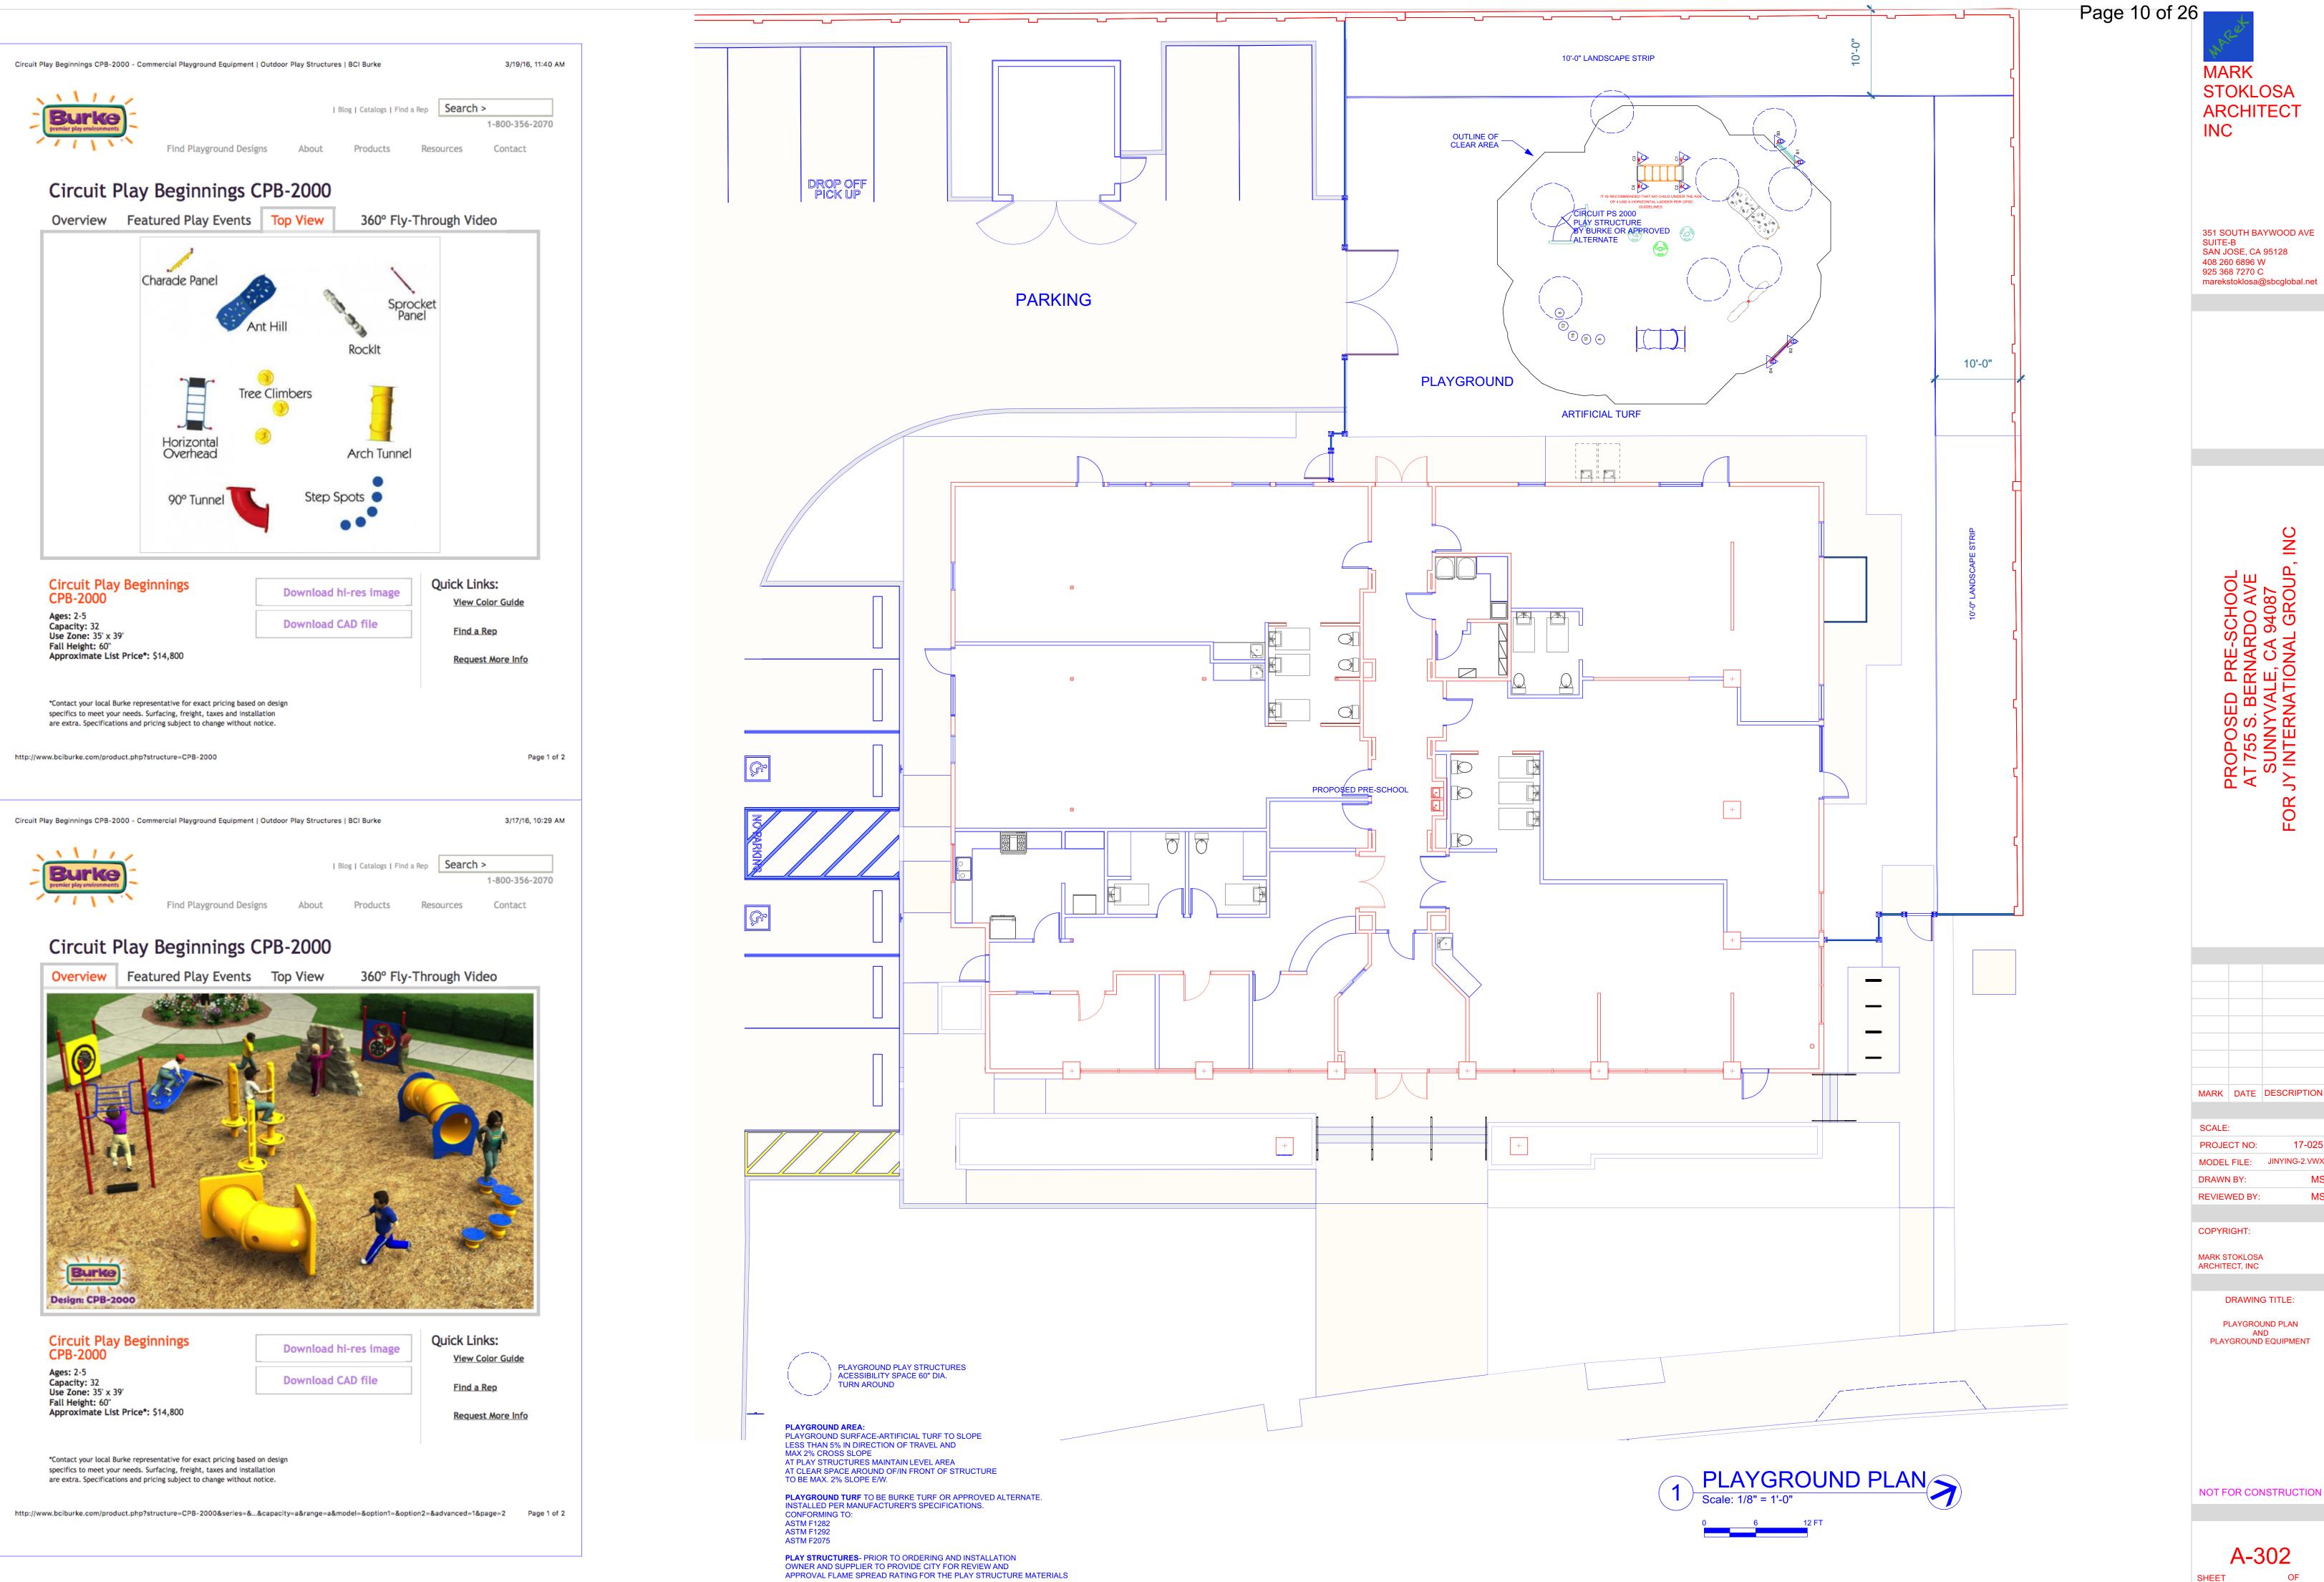

STOKLOSA **ARCHITECT**


ATTACHMENT 5


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MARK DATE DESCRIPTION PROJECT NO: JINYING-2.VWX

MARK STOKLOSA ARCHITECT, INC

> DRAWING TITLE: PLAYGROUND PLAN PLAYGROUND EQUIPMENT



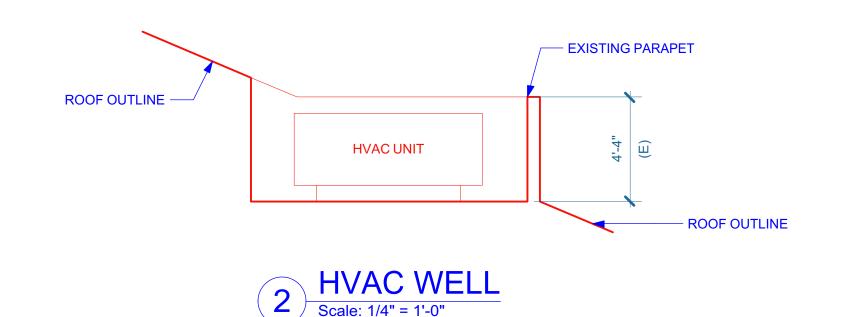
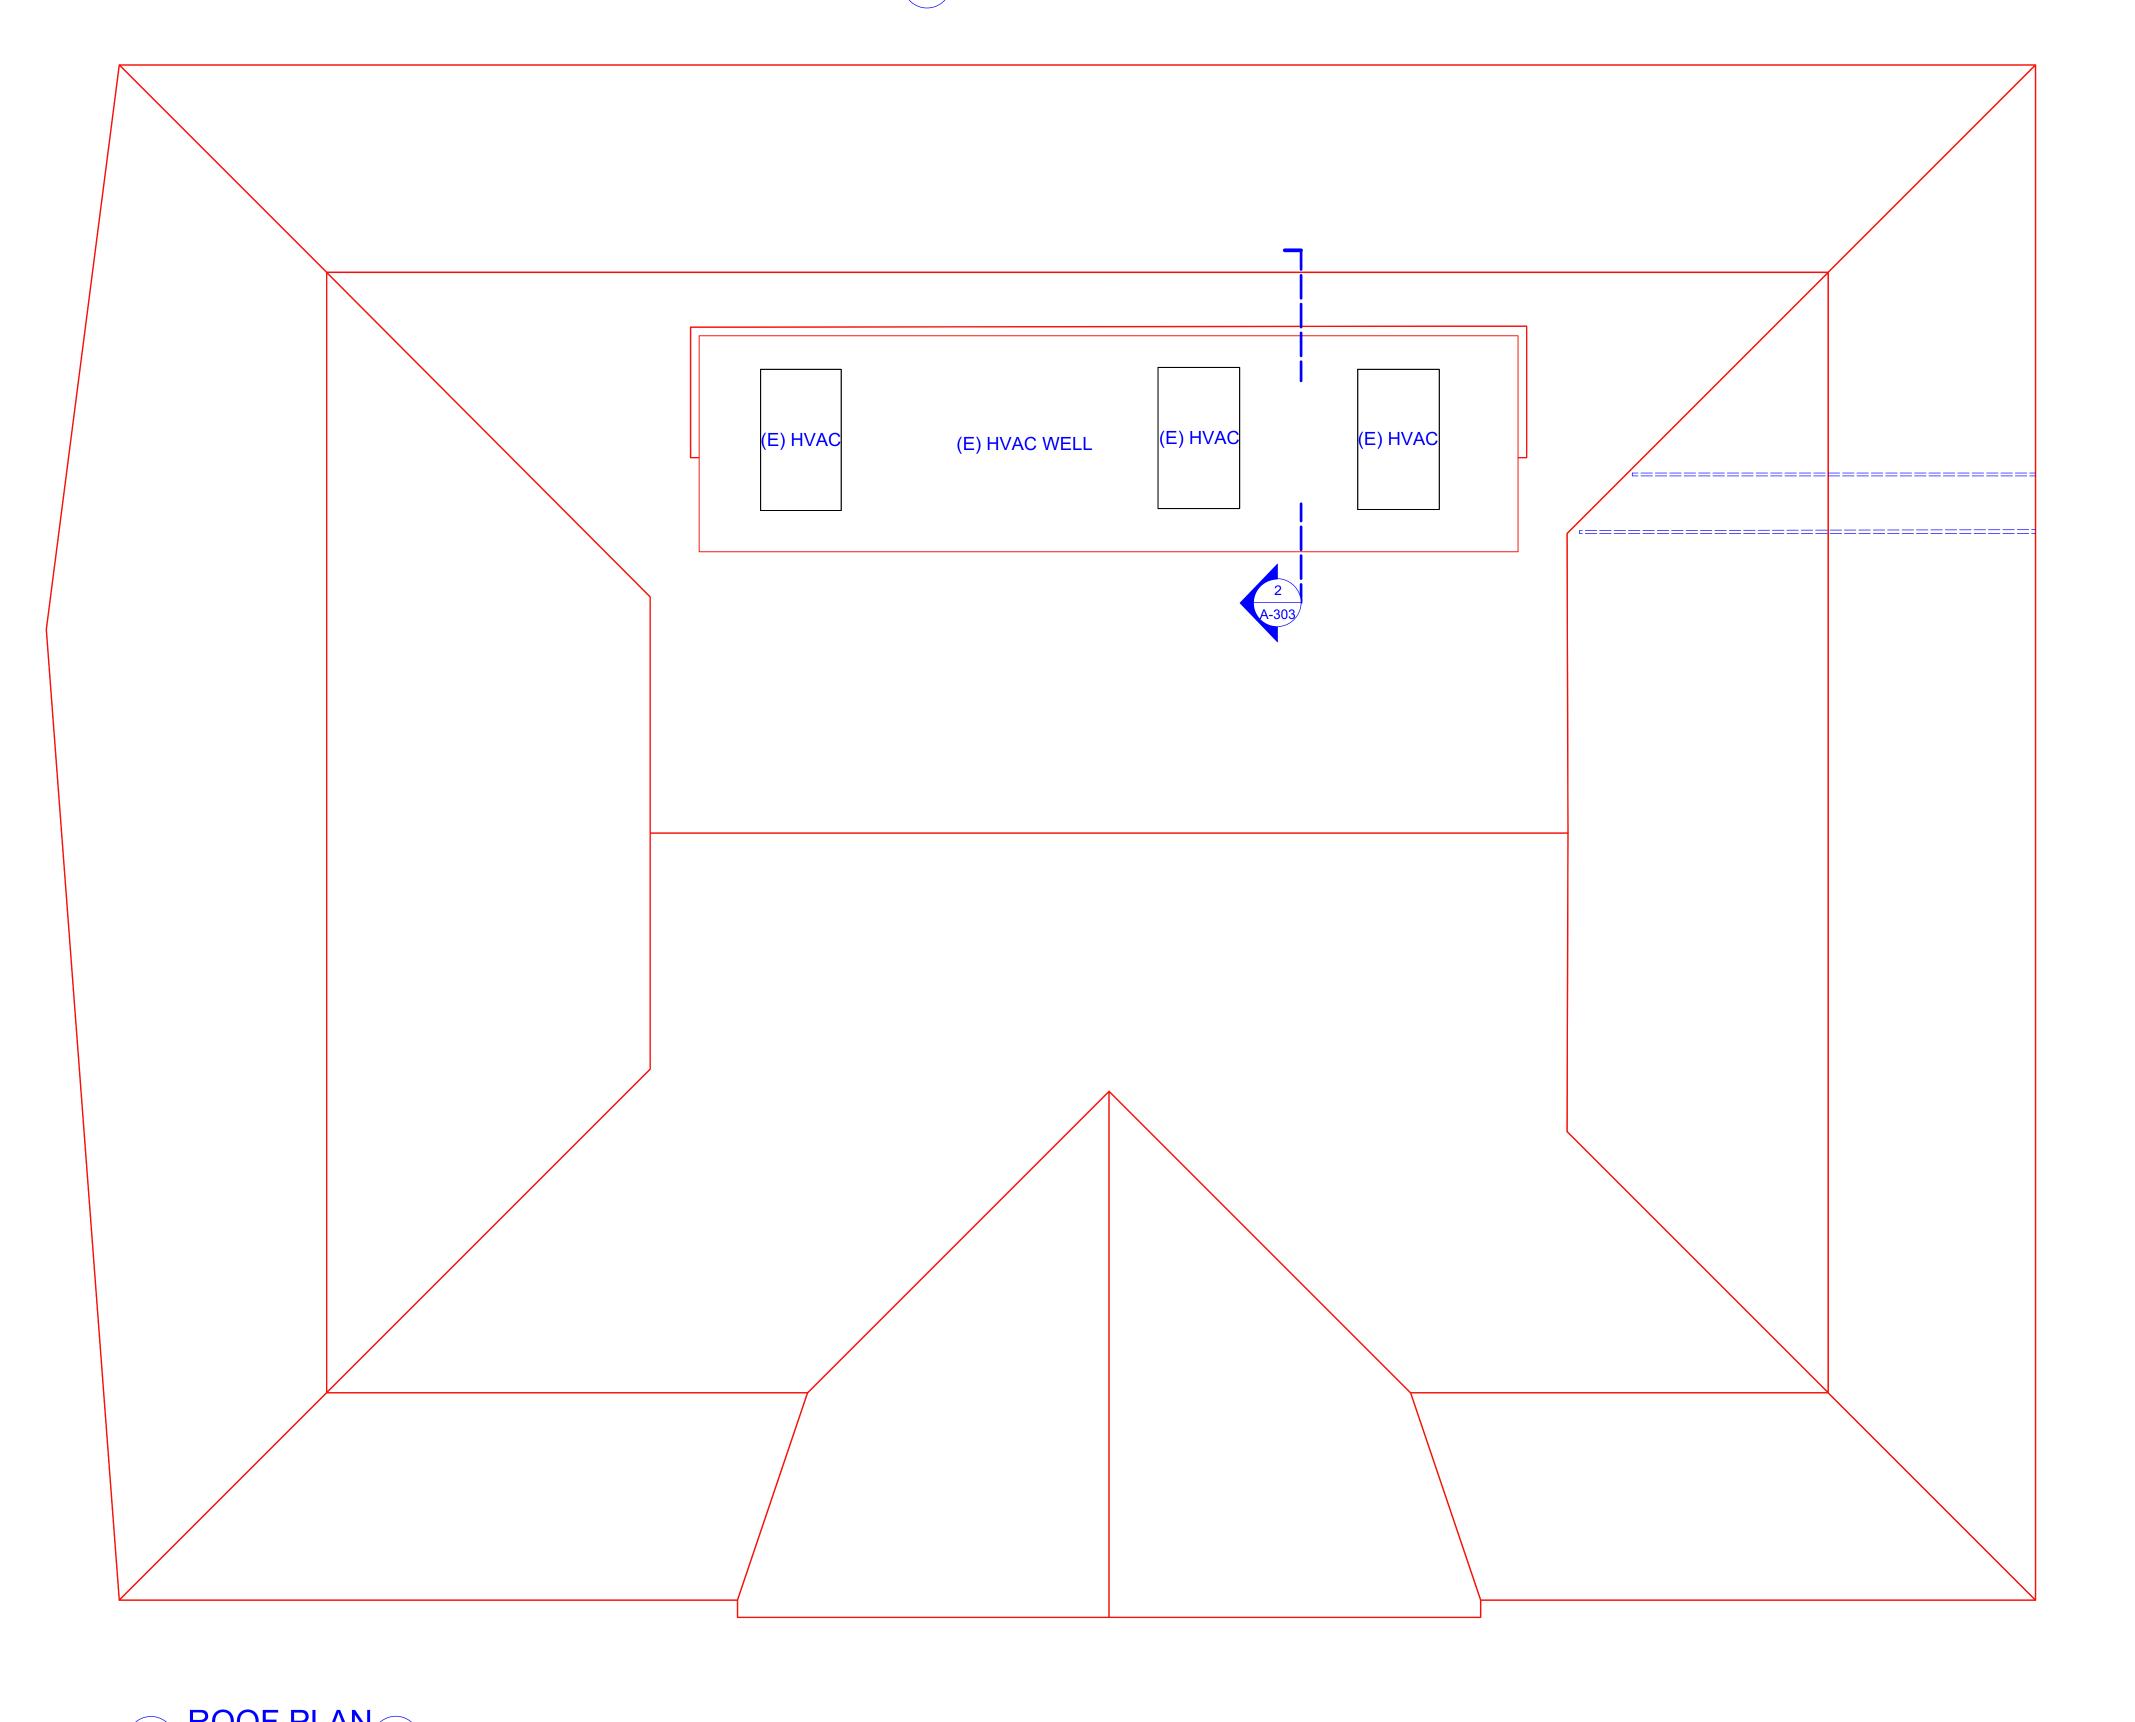
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> AT 755 S. BERNARDO AVE SUNNYVALE, CA 94087 FOR JY INTERNATIONAL GROUP, INC

MARK DATE DESCRIPTION

SCALE:

PROJECT NO: 17-025

MODEL FILE: JINYING-2.VWX

DRAWN BY: MS


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REVIEWED BY:

DRAWING TITLE:

NOT FOR CONSTRUCTION





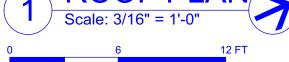

ROOM AREAS Space Name RECEPTION OFFICE Net Area Number Space Number B-101
B-102
B-103
B-104
B-105
B-106
B-107
B-108
B-109
E-101
E-102
E-103
E-104
E-105
E-106
E-107
E-108
E-109
E-110
E-111
E-112
E-113
E-114
E-115 OFFICE 113.8 STAFF-RECEPTION-2 KITCHENETTE 175.1 192.1 BATHROOM BATHROOM FOYER RECEPTION 156.1 845.3 839.4 842.8 CLASSROOM CLASSROOM CLASSROOM 840.1 842.9 CLASSROOM CLASSROOM BATHROOM 119.6 ART SINK ART SINK LAUNDRY 66.4 UTILITIES 48.6 BATHROOM BATHROOM 114.5 16.4 400.2 62.4 ART SINK CORRIDOR STORAGE

SCALE: 17-025 PROJECT NO: MODEL FILE: JINYING-2.VWX DRAWN BY: REVIEWED BY: MS

MARK DATE DESCRIPTION


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DRAWING TITLE: **ROOM AREAS**

NOT FOR CONSTRUCTION

A-304



E-109 LAUNDRY

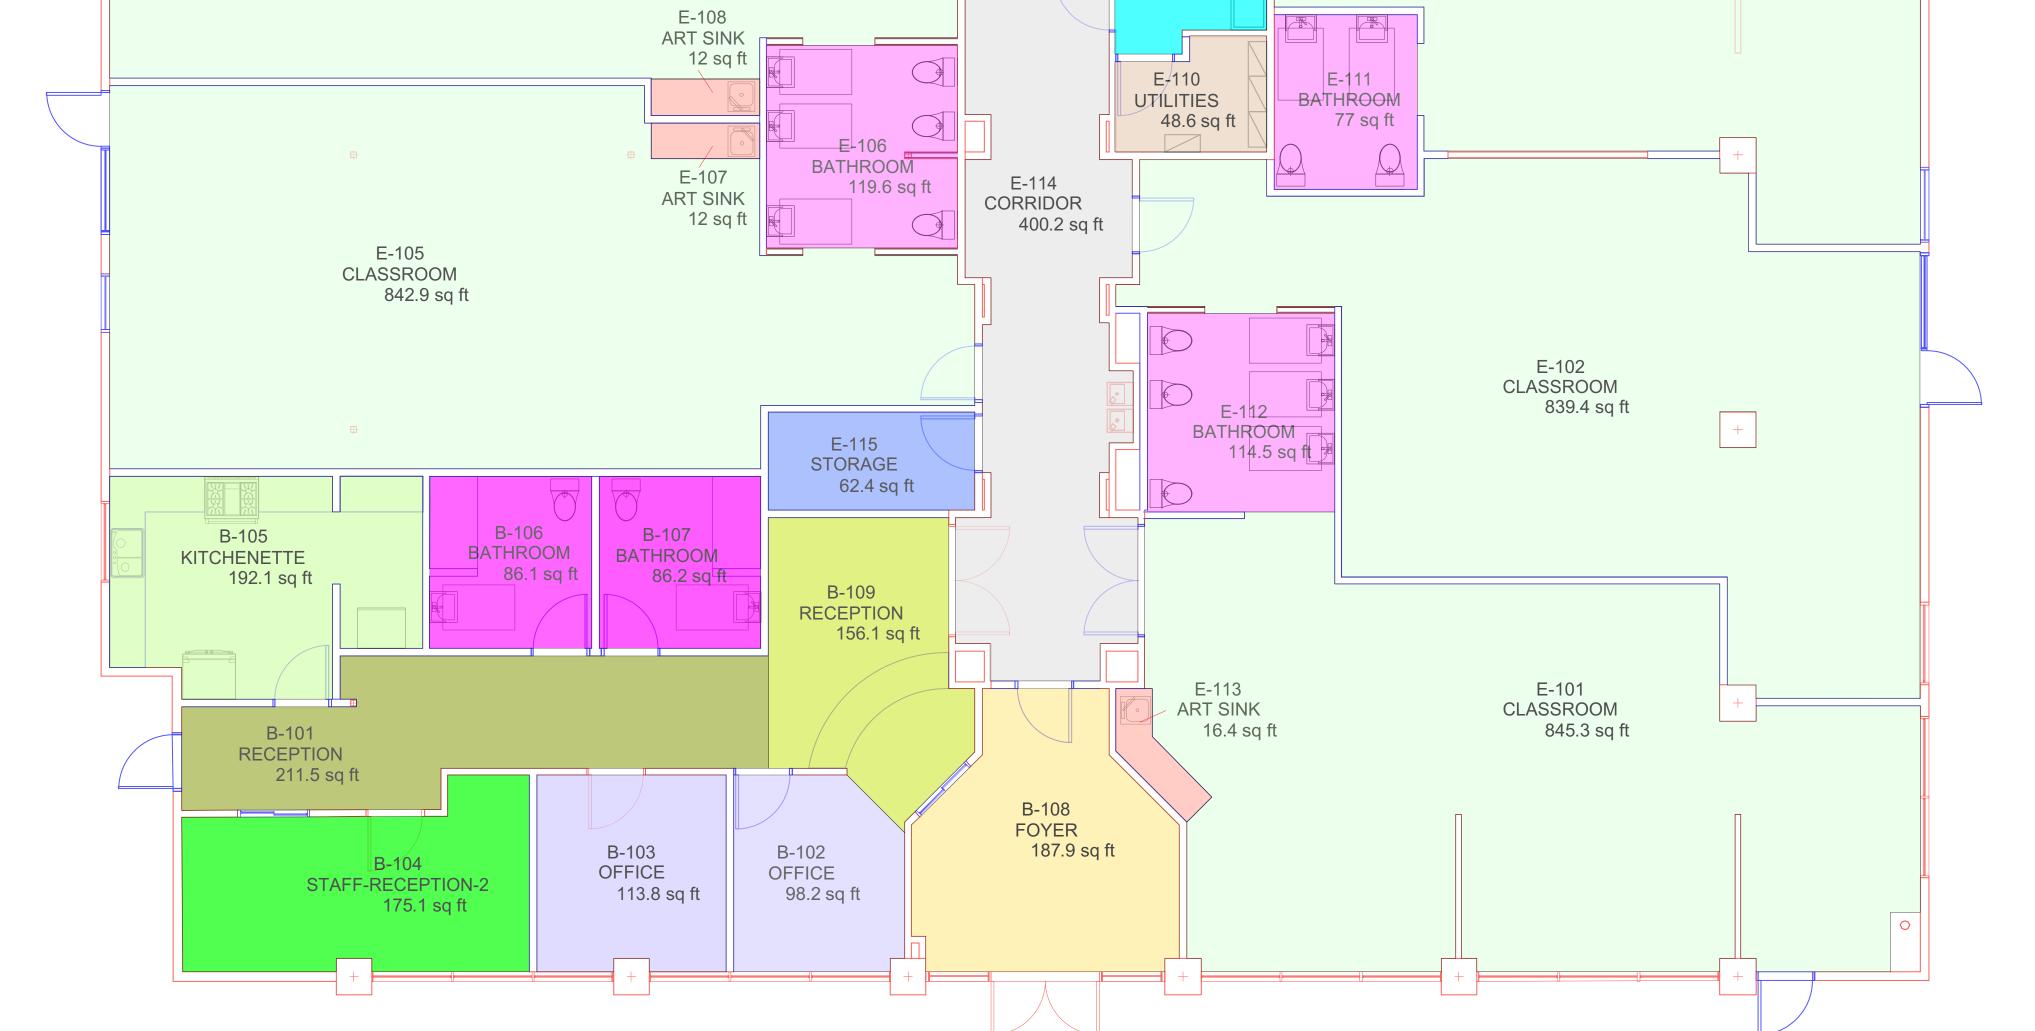66.4 sq ft

E-104 CLASSROOM 840.1 sq ft


E-103 CLASSROOM 842.8 sq ft




TRASH ENCLOSURE DATA:

ONE 3 CUBIC YARD BIN FOR TRASH
ONE 1 CUBIC YARD FOR COMPOST/FOOD SCRAPS
FOUR 96 GAL CARTS FOR RECYCLING


TRASH ENCLOSURE SIZE = 15'-0" X 13'-6"

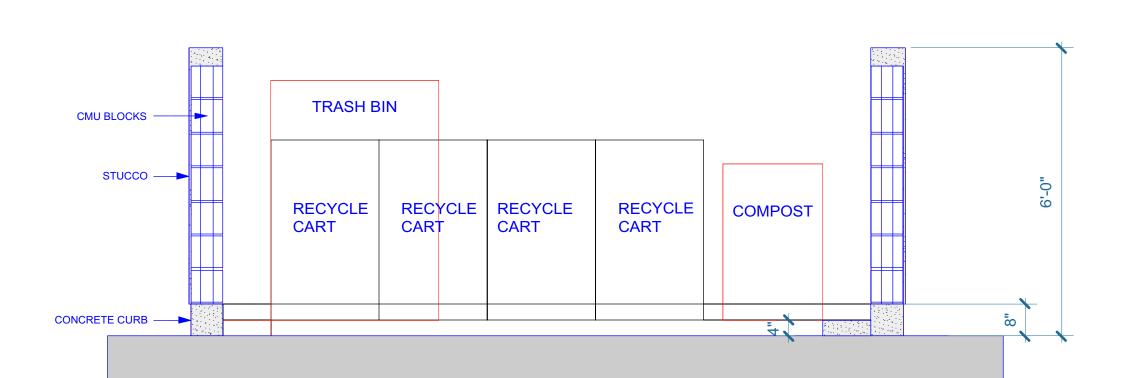




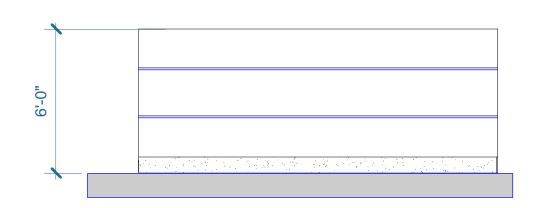




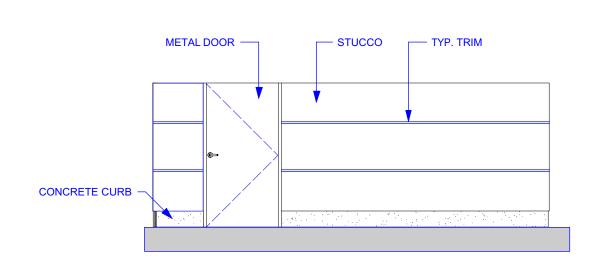




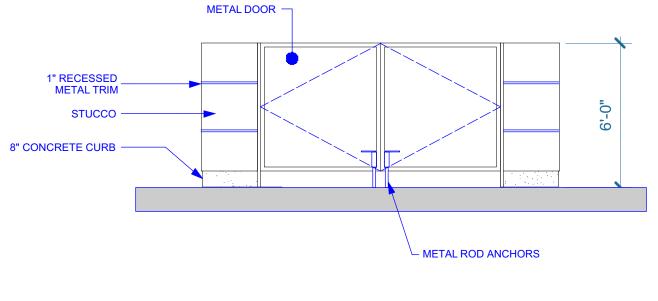



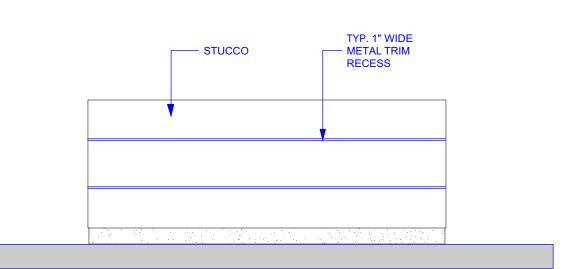



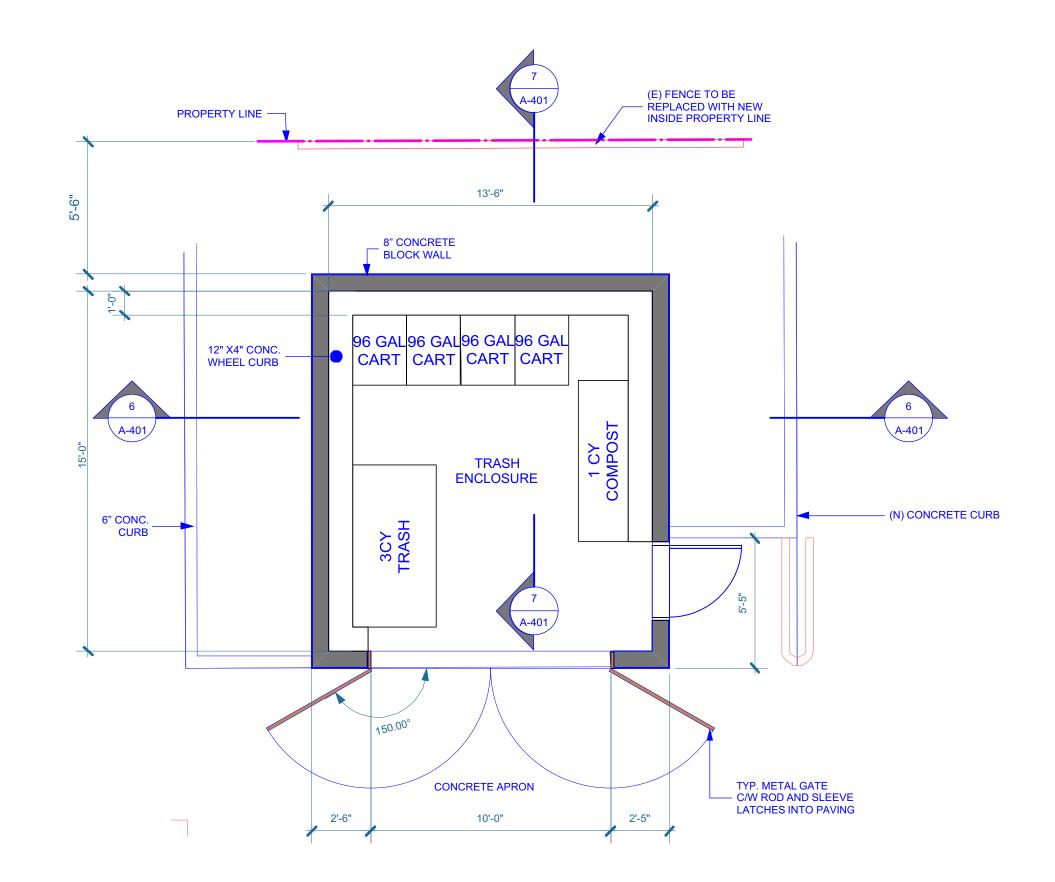



MARK STOKLOSA ARCHITECT INC

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> AT 755 S. BERNARDO AVE SUNNYVALE, CA 94087 FOR JY INTERNATIONAL GROUP, INC

MARK DATE DESCRIPTION

SCALE:

PROJECT NO: 17-025

PROJECT NO: 17-025

MODEL FILE: JINYING-2.VWX

DRAWN BY: MS

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ARCHITECT, INC

DRAWING TITLE:
TRASH DETAILS

NOT FOR CONSTRUCTION

A-401

SHEET

351 SOUTH BAYWOOD AVE SUITE-B SAN JOSE, CA 95128 408 260 6896 W 925 368 7270 C marekstoklosa@sbcglobal.net

PROPUSED PRE-SCHOOL
AT 755 S. BERNARDO AVE
SUNNYVALE, CA 94087
FOR JY INTERNATIONAL GROUP, INC

MARK DATE DESCRIPTION

SCALE:

PROJECT NO: 17-025

MODEL FILE: JINYING-2.VWX

DRAWN BY: MS


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COPYRIGHT:


MARK STOKLOSA ARCHITECT, INC


DRAWING TITLE:

NOT FOR CONSTRUCTION



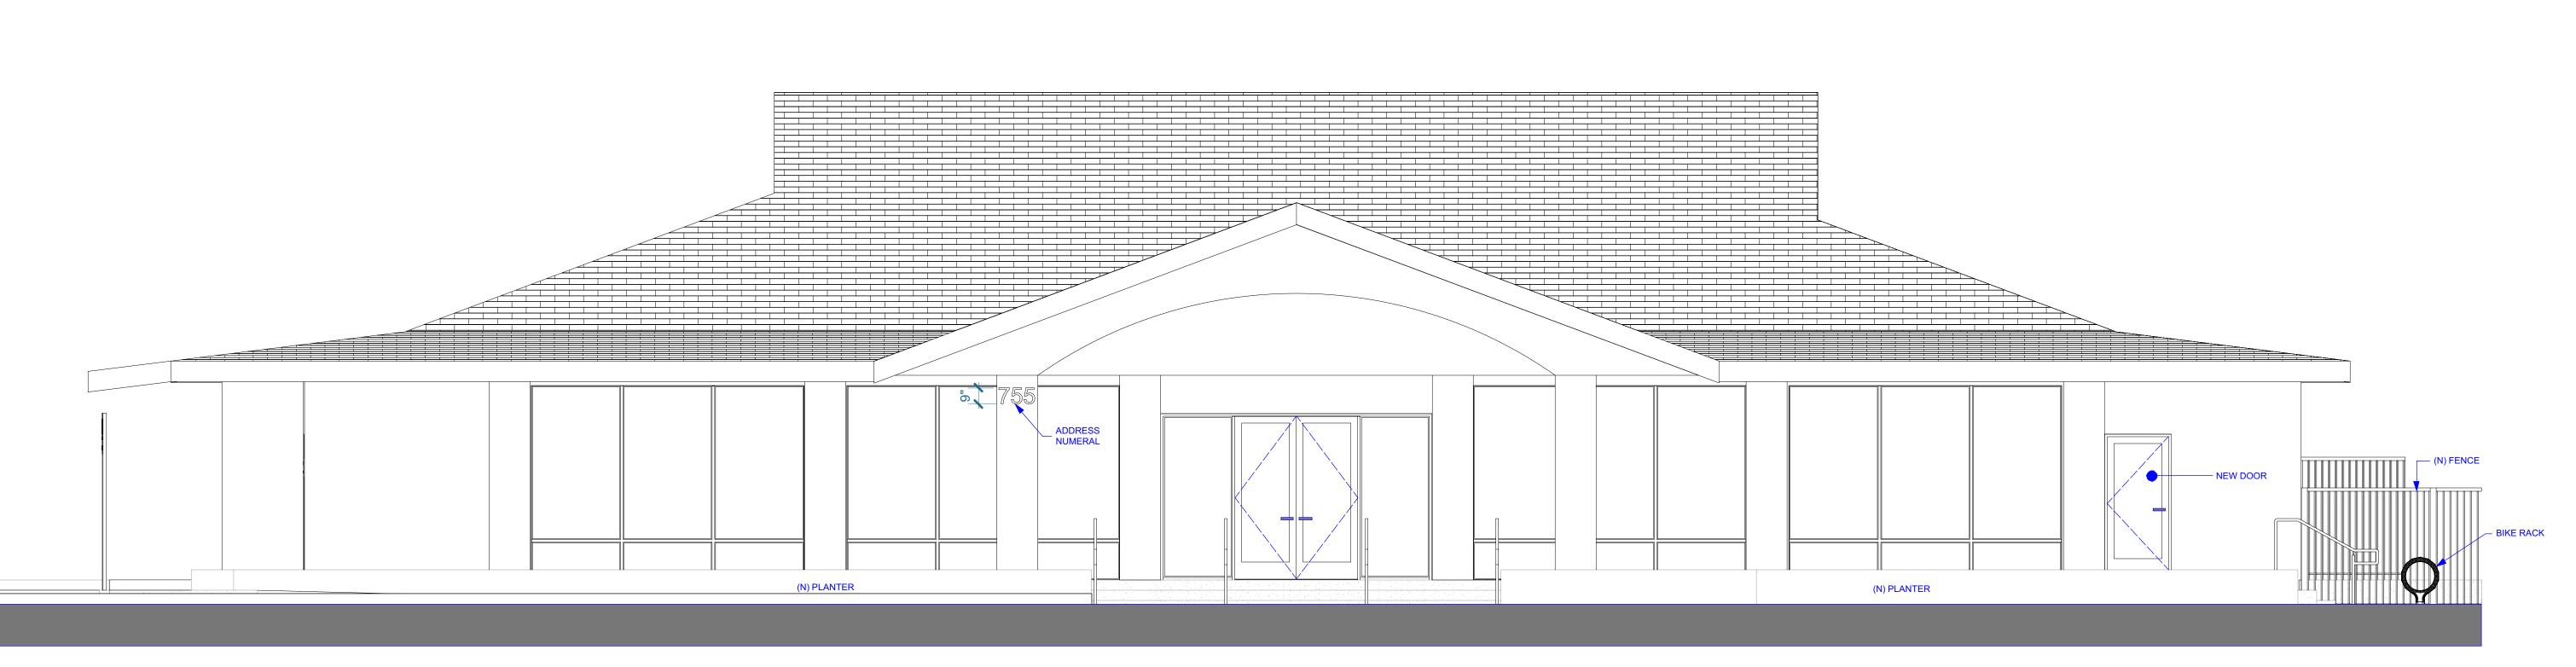

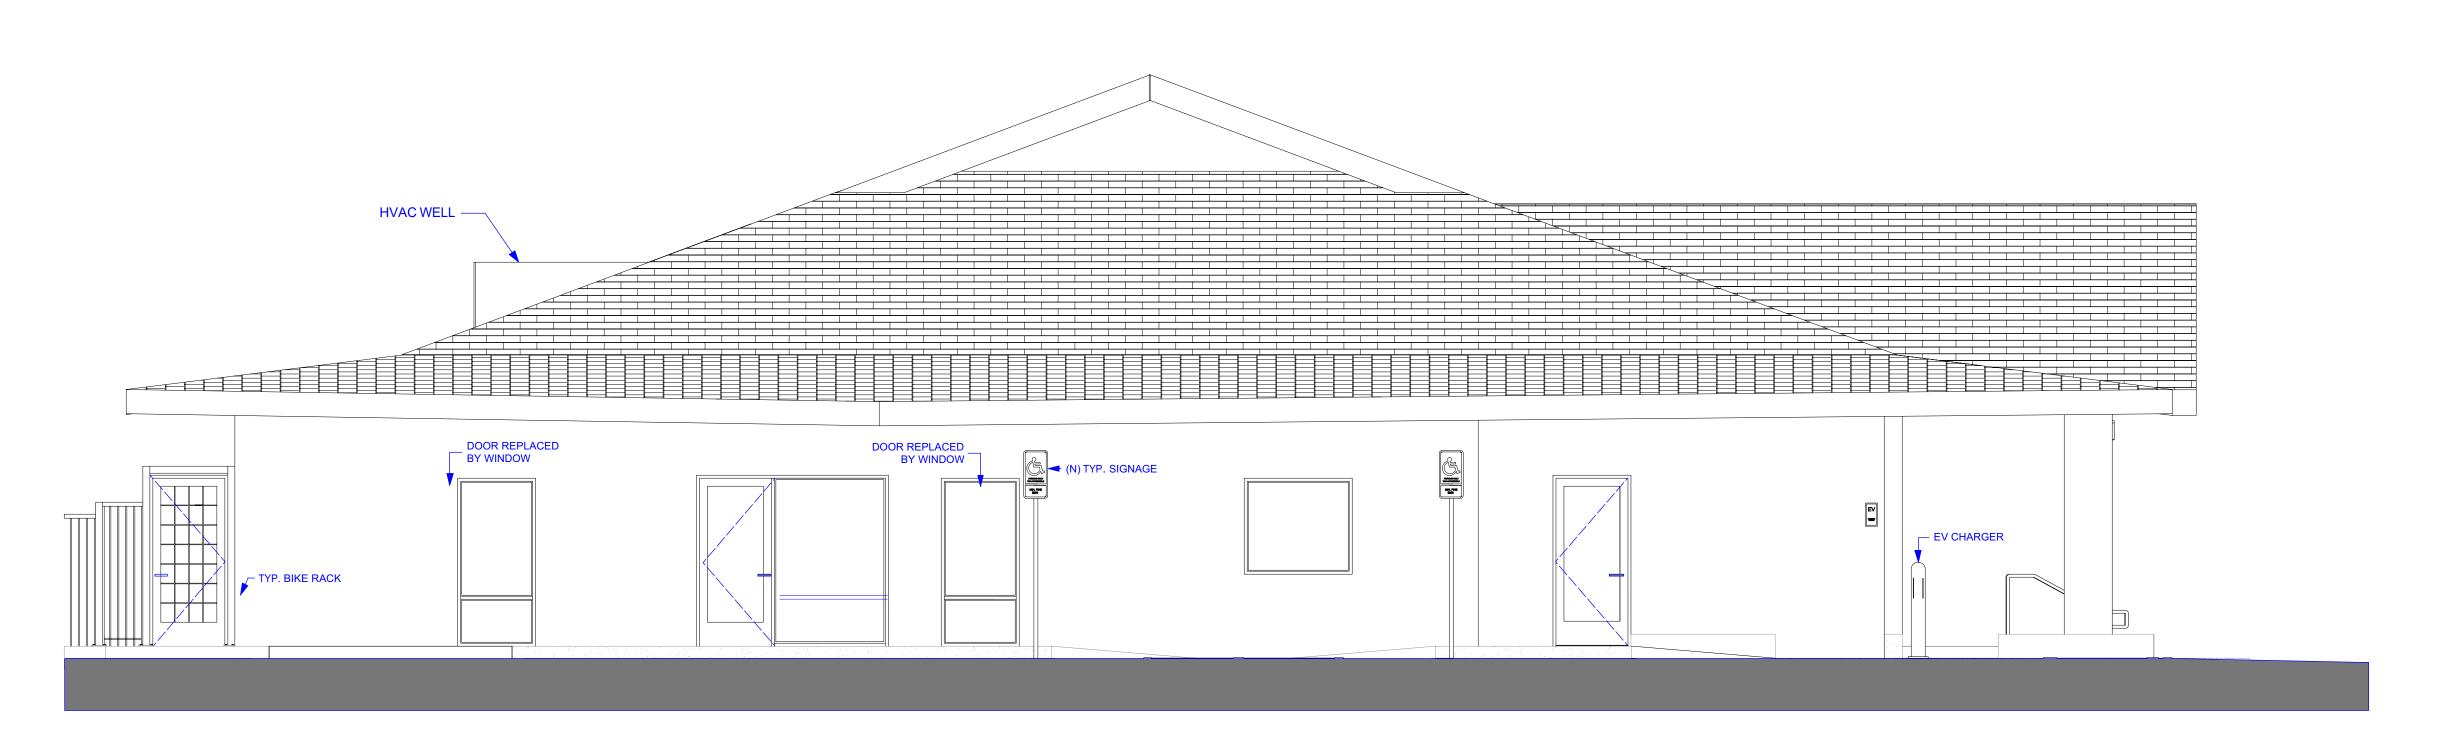

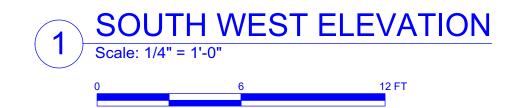

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MARK DATE DESCRIPTION SCALE:


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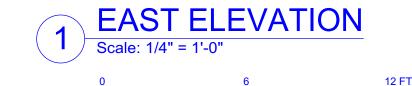
DRAWING TITLE: **ELEVATIONS**

NOT FOR CONSTRUCTION







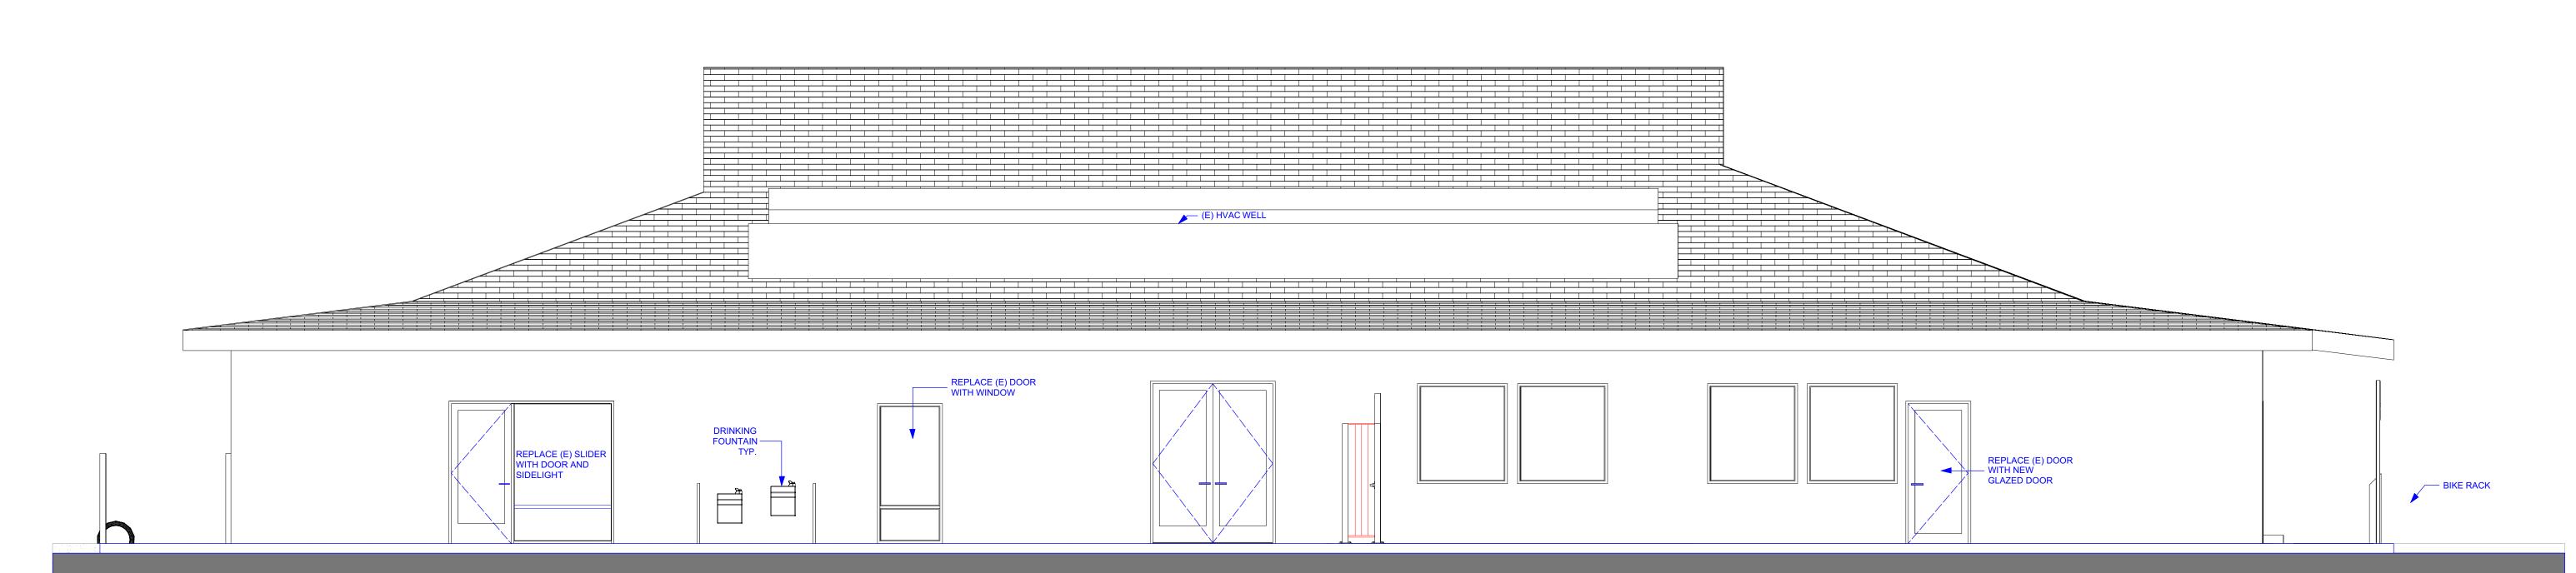

Power **Xpress Bollard**

Weatherproof, durable design for outdoor installations

The original

The weatherproof Bosch Power Xpress uses a fullysealed enclosure to provide reliable charging in any condition. An adjustable power output ranges from 12 -32 amps to help you find the most efficient charge for your

https://www.boschevsolutions.com/charging-stations/power-xpress-bollard

Power Xpress Install Charger | Bosch Electric Vehicle Charging

electric vehicle and existing wiring. A convient plug-in option and wall mounting plate allows for the Power Xpress to be easily moved.

The Level 2 240V American made Power Xpress lets you choose between 12 - 32 amps of power, and can charge compatible EVs up 5 times faster than a standard 110V outlet. The compact and durable design of the Power Xpress will withstand nearly any environment while taking up minimal space. Inside and out, the Power Xpress is versatile, reliable, and efficient.


Installation


Power Xpress is built to exceed NEMA 4X standards, making it weatherproof and ideal for indoor or outdoor installation, charging safely in any environment. Bosch recommends working with an experienced electrician to install your new charging station. Looking for an electrician? Visit the Bosch installer map for a

https://www.boschevsolutions.com/charging-stations/power-xpress-bollard




Will it be compatible? Yes, your charging station will charge any vehicle meeting the SAE J1772 standard, used by most electric vehicles in North America.

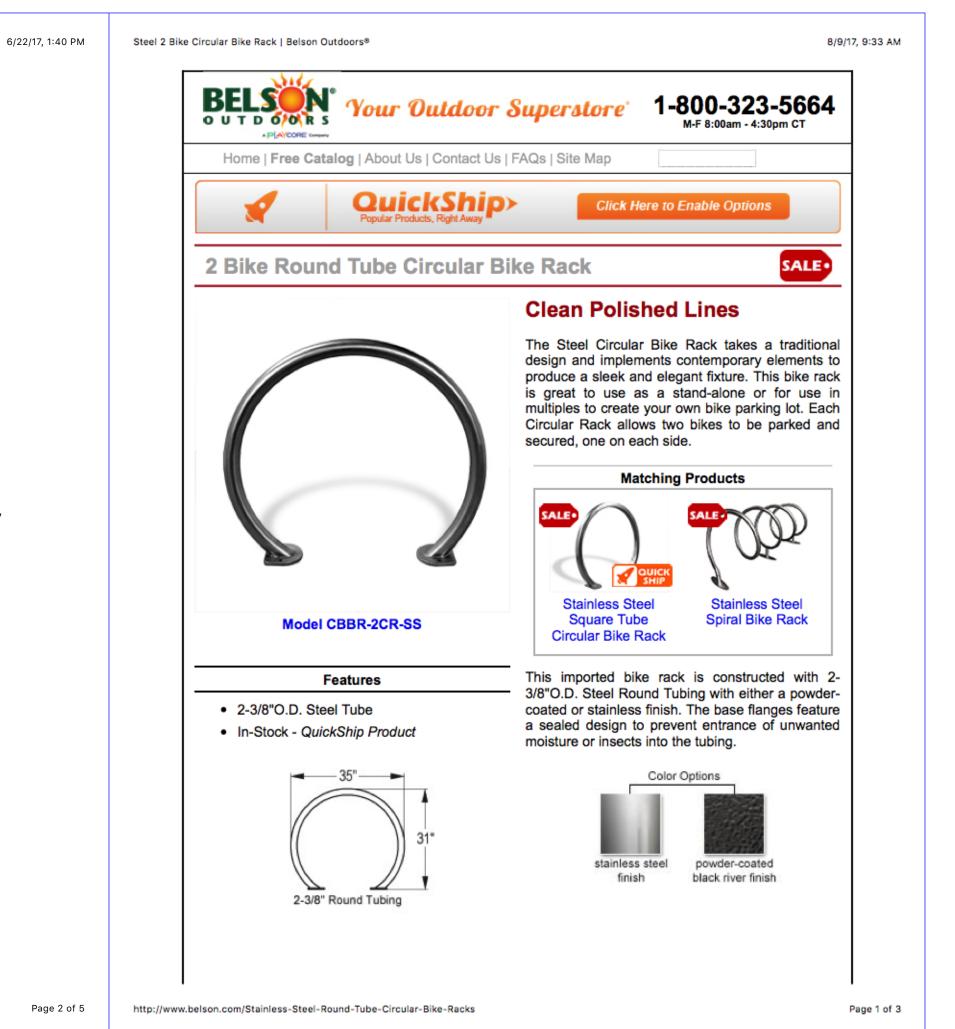

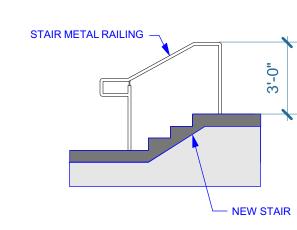

FRONT STAIR DETAIL
Scale: 1/4" = 1'-0"

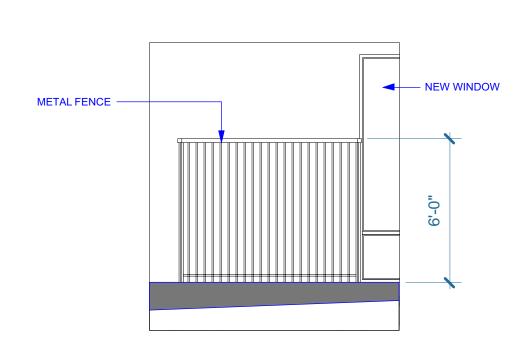

GAS METER FENCE


8 CHARGER
Scale: Actual Size

1 PLAYGROUND GATE
Scale: 1/4" = 1'-0"









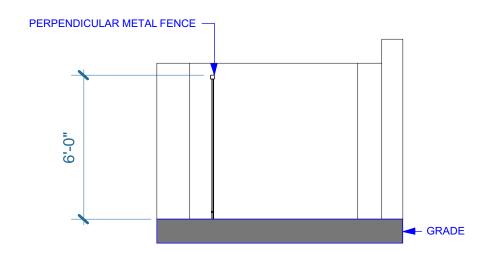


TYPICAL FENCE ELEVATION

Scale: 1/4" = 1'-0"

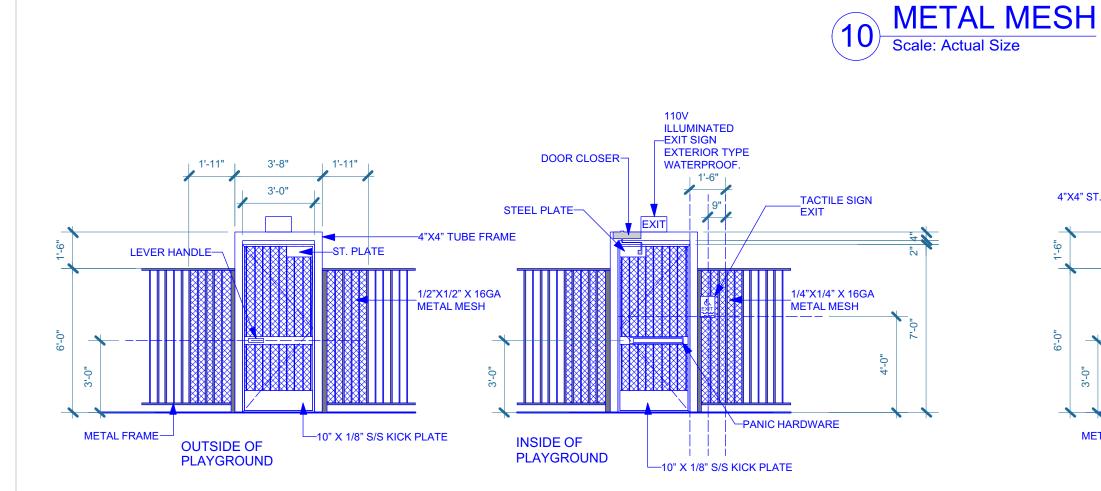

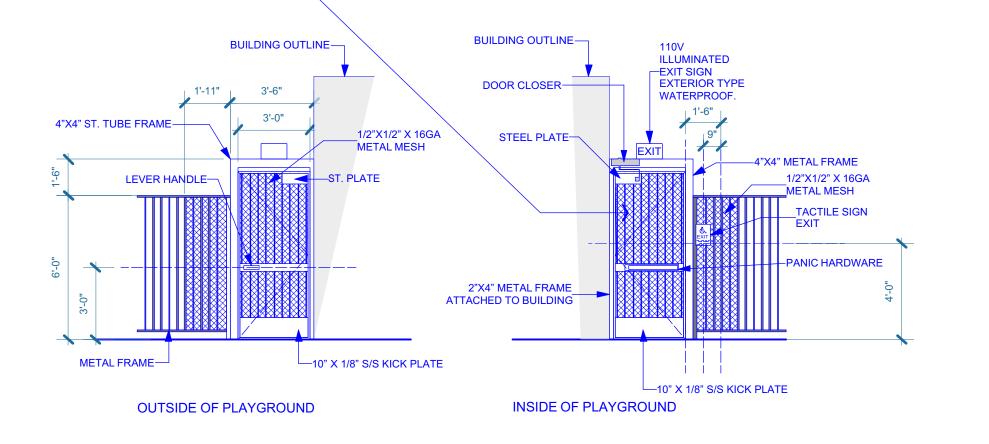

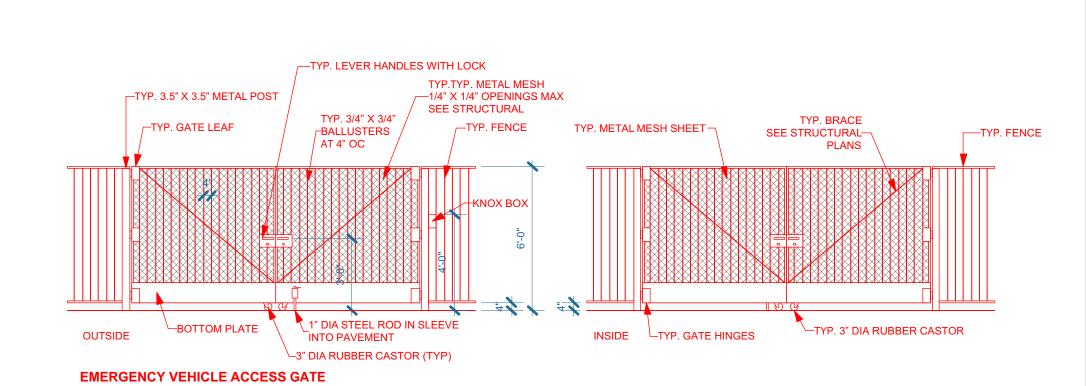

PLAYGROUND GATE-2
Scale: 1/4" = 1'-0"



STOKLOSA **ARCHITECT** INC

MARK

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MARK DATE DESCRIPTION SCALE: 17-025 PROJECT NO: MODEL FILE: JINYING-2.VWX DRAWN BY:


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> DRAWING TITLE: **DETAILS**

NOT FOR CONSTRUCTION

MARK DATE DESCRIPTION 17-025 JINYING-2.VWX

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Page 20 of 26

PRESCH00L

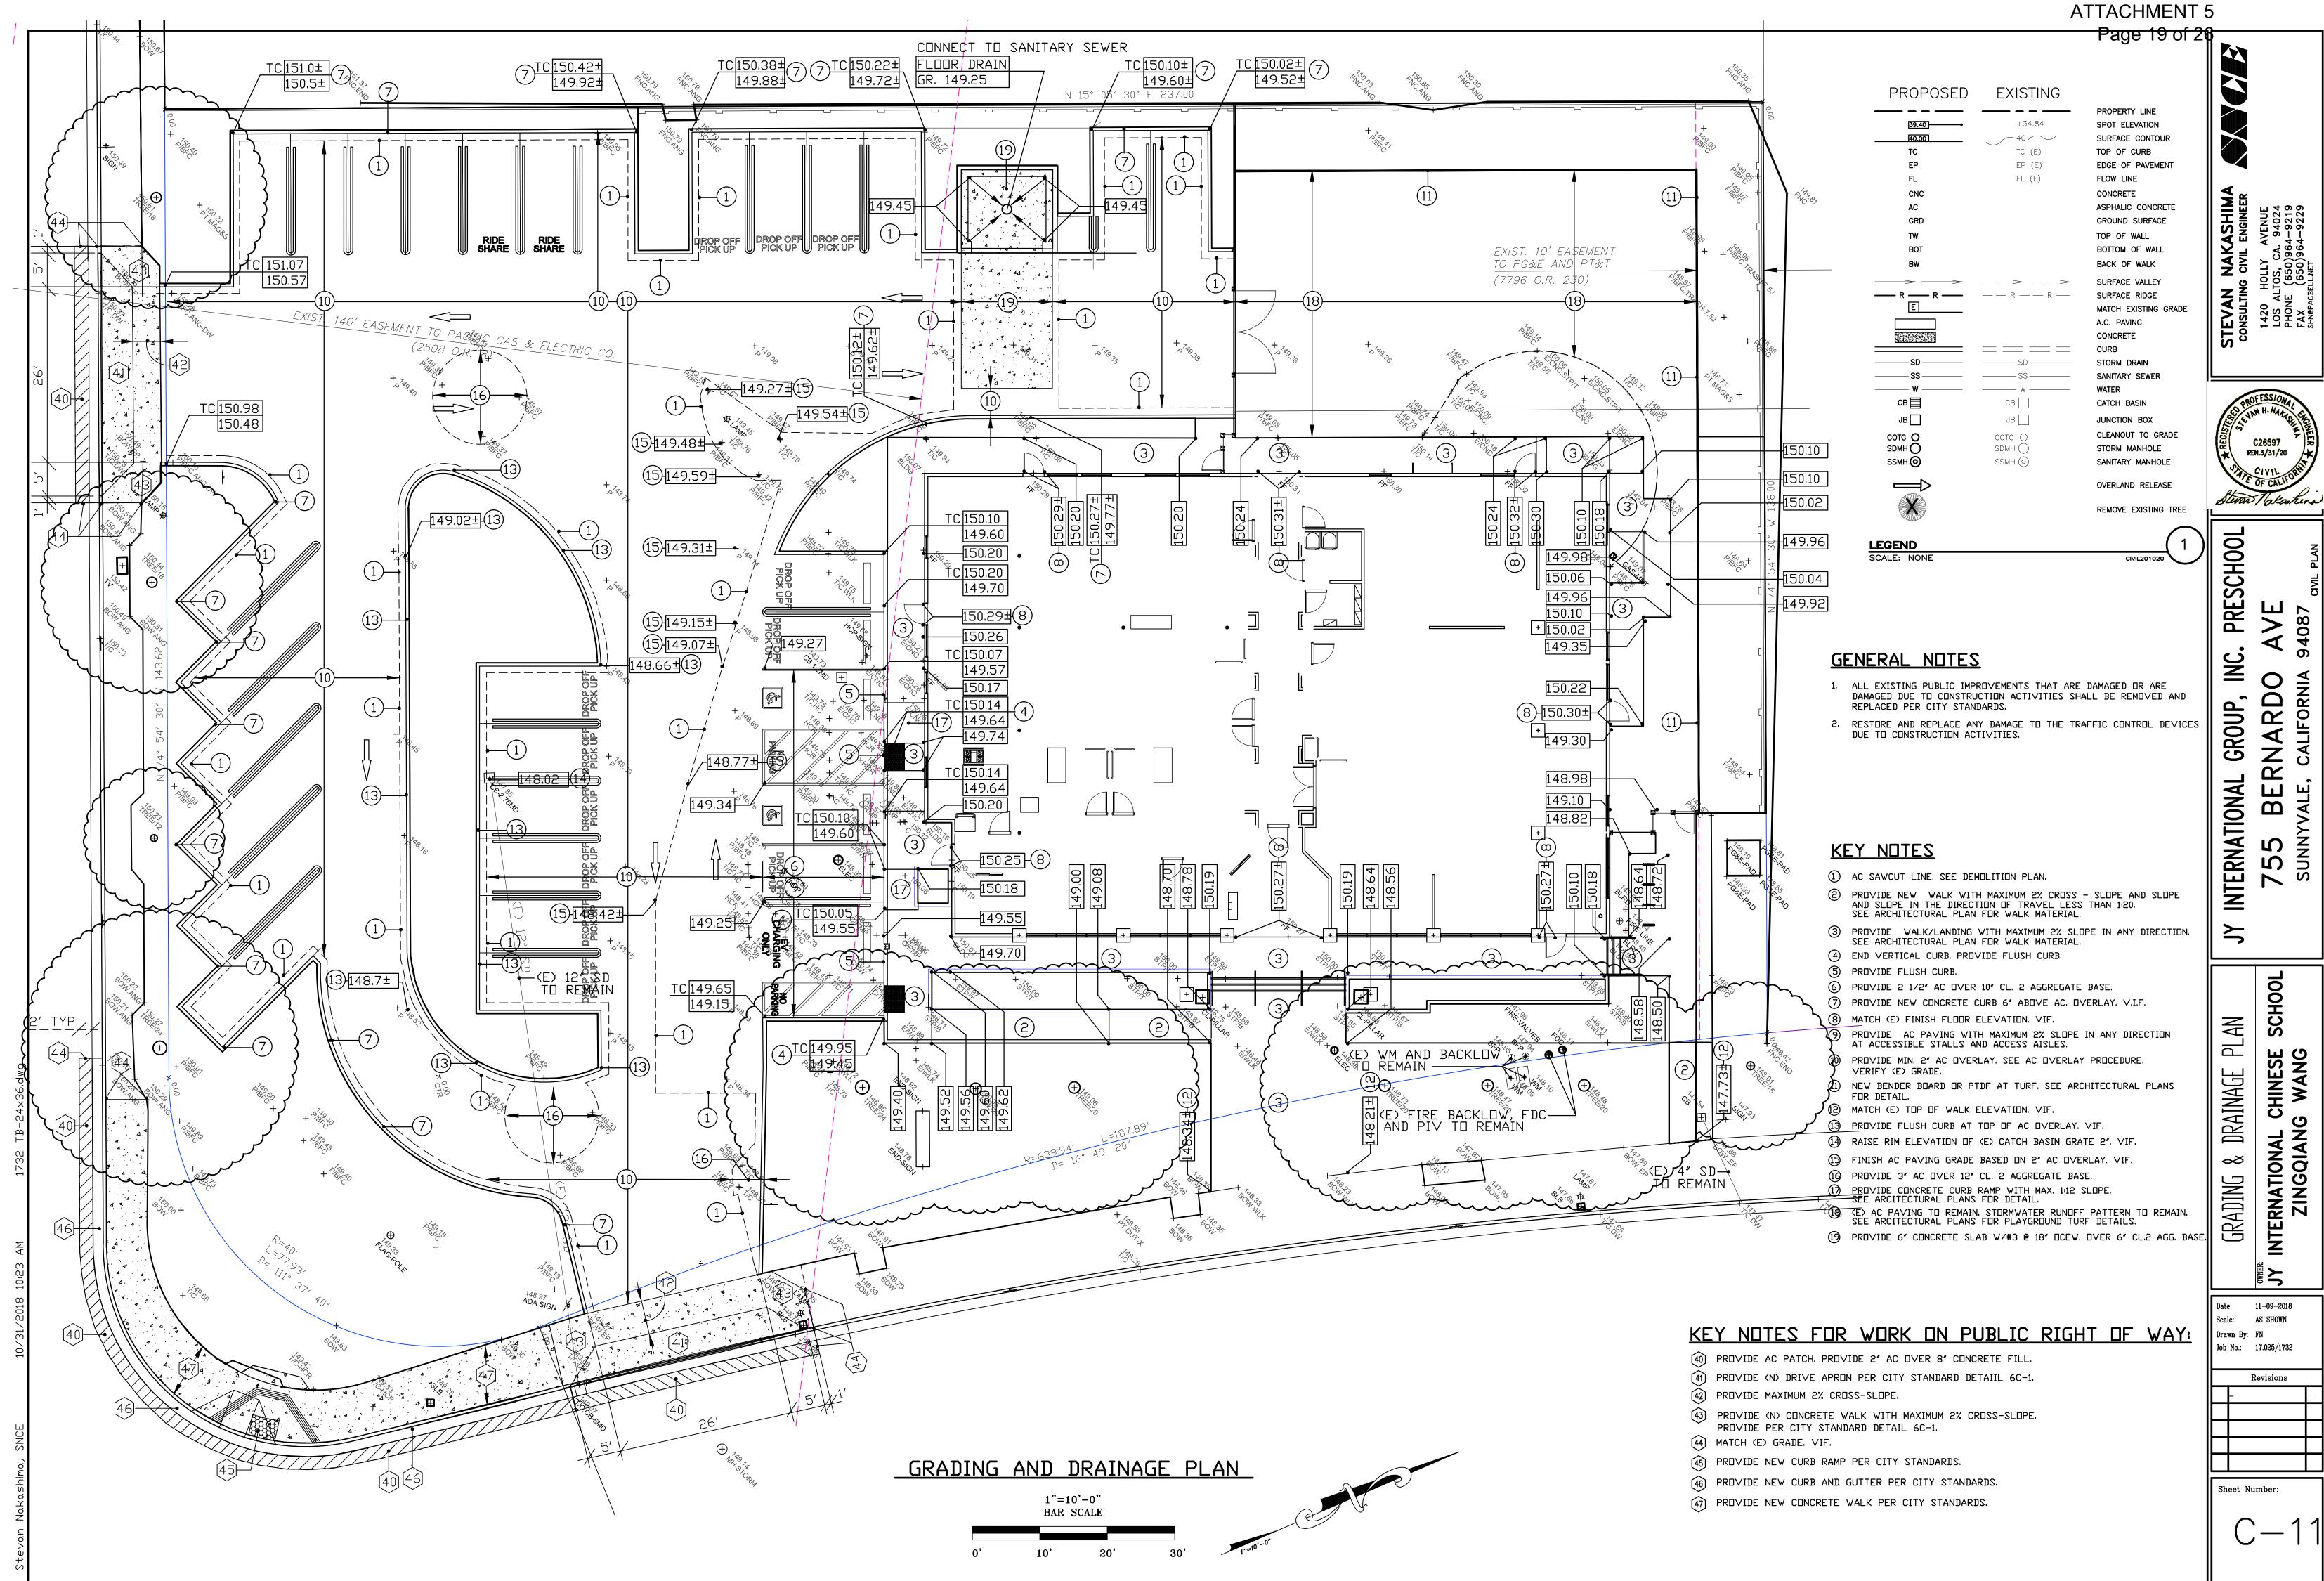INTERNATIONAL GROUP, INC 755 BERNARDO SUNNYVALE, CALIFORNIA 8

IMPERVIOUS SURFACE DATA INTERNATIONAL CHINESE ZINGQIANG WANG

SCHOOL

11-09-2018 Job No.: 17.025/1732

Revisions	
-	-

2 PRUIECT DATA:

	A PRUJECT DATA:			
	PERVIOUS AND IMPER	RVIDUS SURFACES COMP	ARISON TABLE	
	N/A, 1, 2, 3, ETC.):	N/A	B. TOTAL SITE (AREA):	.87
C	TOTAL SITE EXISTING IMPERVIOUS SURFACES (SQUARE FEET):	33,193	D. TOTAL AREA OF SITE DISTURBED (ACRES):	.38

	EXISTING CONDITION OF SITE AREA DISTURBED (SQUARE FEET):	PROPOSED CONDITION DISTURBED (SQUAR		
E. IMPERVIOUS SURFACES	COMONNE PEELY	REPLACED	CREATED	
ROOF AREA(S)	6,910	-	-	
PARKING	23,195	3,950	444	
SIDEWALKS, PATIOS, PATHS	3,808	3,121	258	
STREETS (PUBLIC)	-		-	
STREETS (PRIVATE)	-		_	
TOTAL IMPERVIOUS SURFACES:	E.1: 33,193	E.2: 7,071	E.3: 702	
F. PERVIOUS SURFACES				
LANDSCAPED AREAS	4,694	3,461	5,686	
PERVIOUS PAVING	-			
OTHER PERVIOUS SURFACES (GREEN ROOF, ETC)	-			
TOTAL PERVIOUS SURFACES:	F.1: 4,694	F.2: 3,461	F.3: 5,686	

G.	TOTAL	PROPOSED	REPLACED	+ NEW	IMPERVIOUS SURFACES (E.2+E.3):	7,773
H.	TOTAL	PROPOSED	REPLACED	+ NEW	PERVIOUS SURFACES (F.2+F.3):	9,147

I. PERCENT OF REPLACEMENT OF IMPERVIOUS AREA IN REDEVELOPMENT	21.30%
PROJECTS (E.2÷C X 100):	

J. PRE-CONSTRUCTION IMPERVIOUS AREA	33,193 SQ FT
POST-CONSTRUCTION IMPERVIOUS AREA	27,507 SQ FT


TOTAL MPERVIOUS SURFACE CREATED AND/OR REPLACED FOR PARKING AREA 444 SF (CREATED) + 3,950 (REPLACED) = 4,394 SF IS LESS THAN 5,000 SF

STORMWATER CONTROL MEASURES USED

- SITE DESIGN MEASURES
- 1. DISCONNECT DOWNSPOUTS
- 2. MINIMIZE CHANGE IN RUNDFF HYDROGRAPH
- 3. MINIMIZE LAND DISTURBANCE 4. MINIMIZE IMPERVIOUS SURFACES
- BENEFICIAL LANDSCAPING (MINIMIZES IRRIGATION, RUNDFF, PESTICIDES & FERTILLIZERS; PROMOTES TREATMENT)
 - 2. MAINTENANCE (STREET SWEEPING, CATCH BASIN CLEANING)

SOURCE CONTROL MEASURE

- 3. COVERED DUMPSTER AREA, DRAIN TO SANITARY SEWER
- 4. STORM DRAIN LABELING

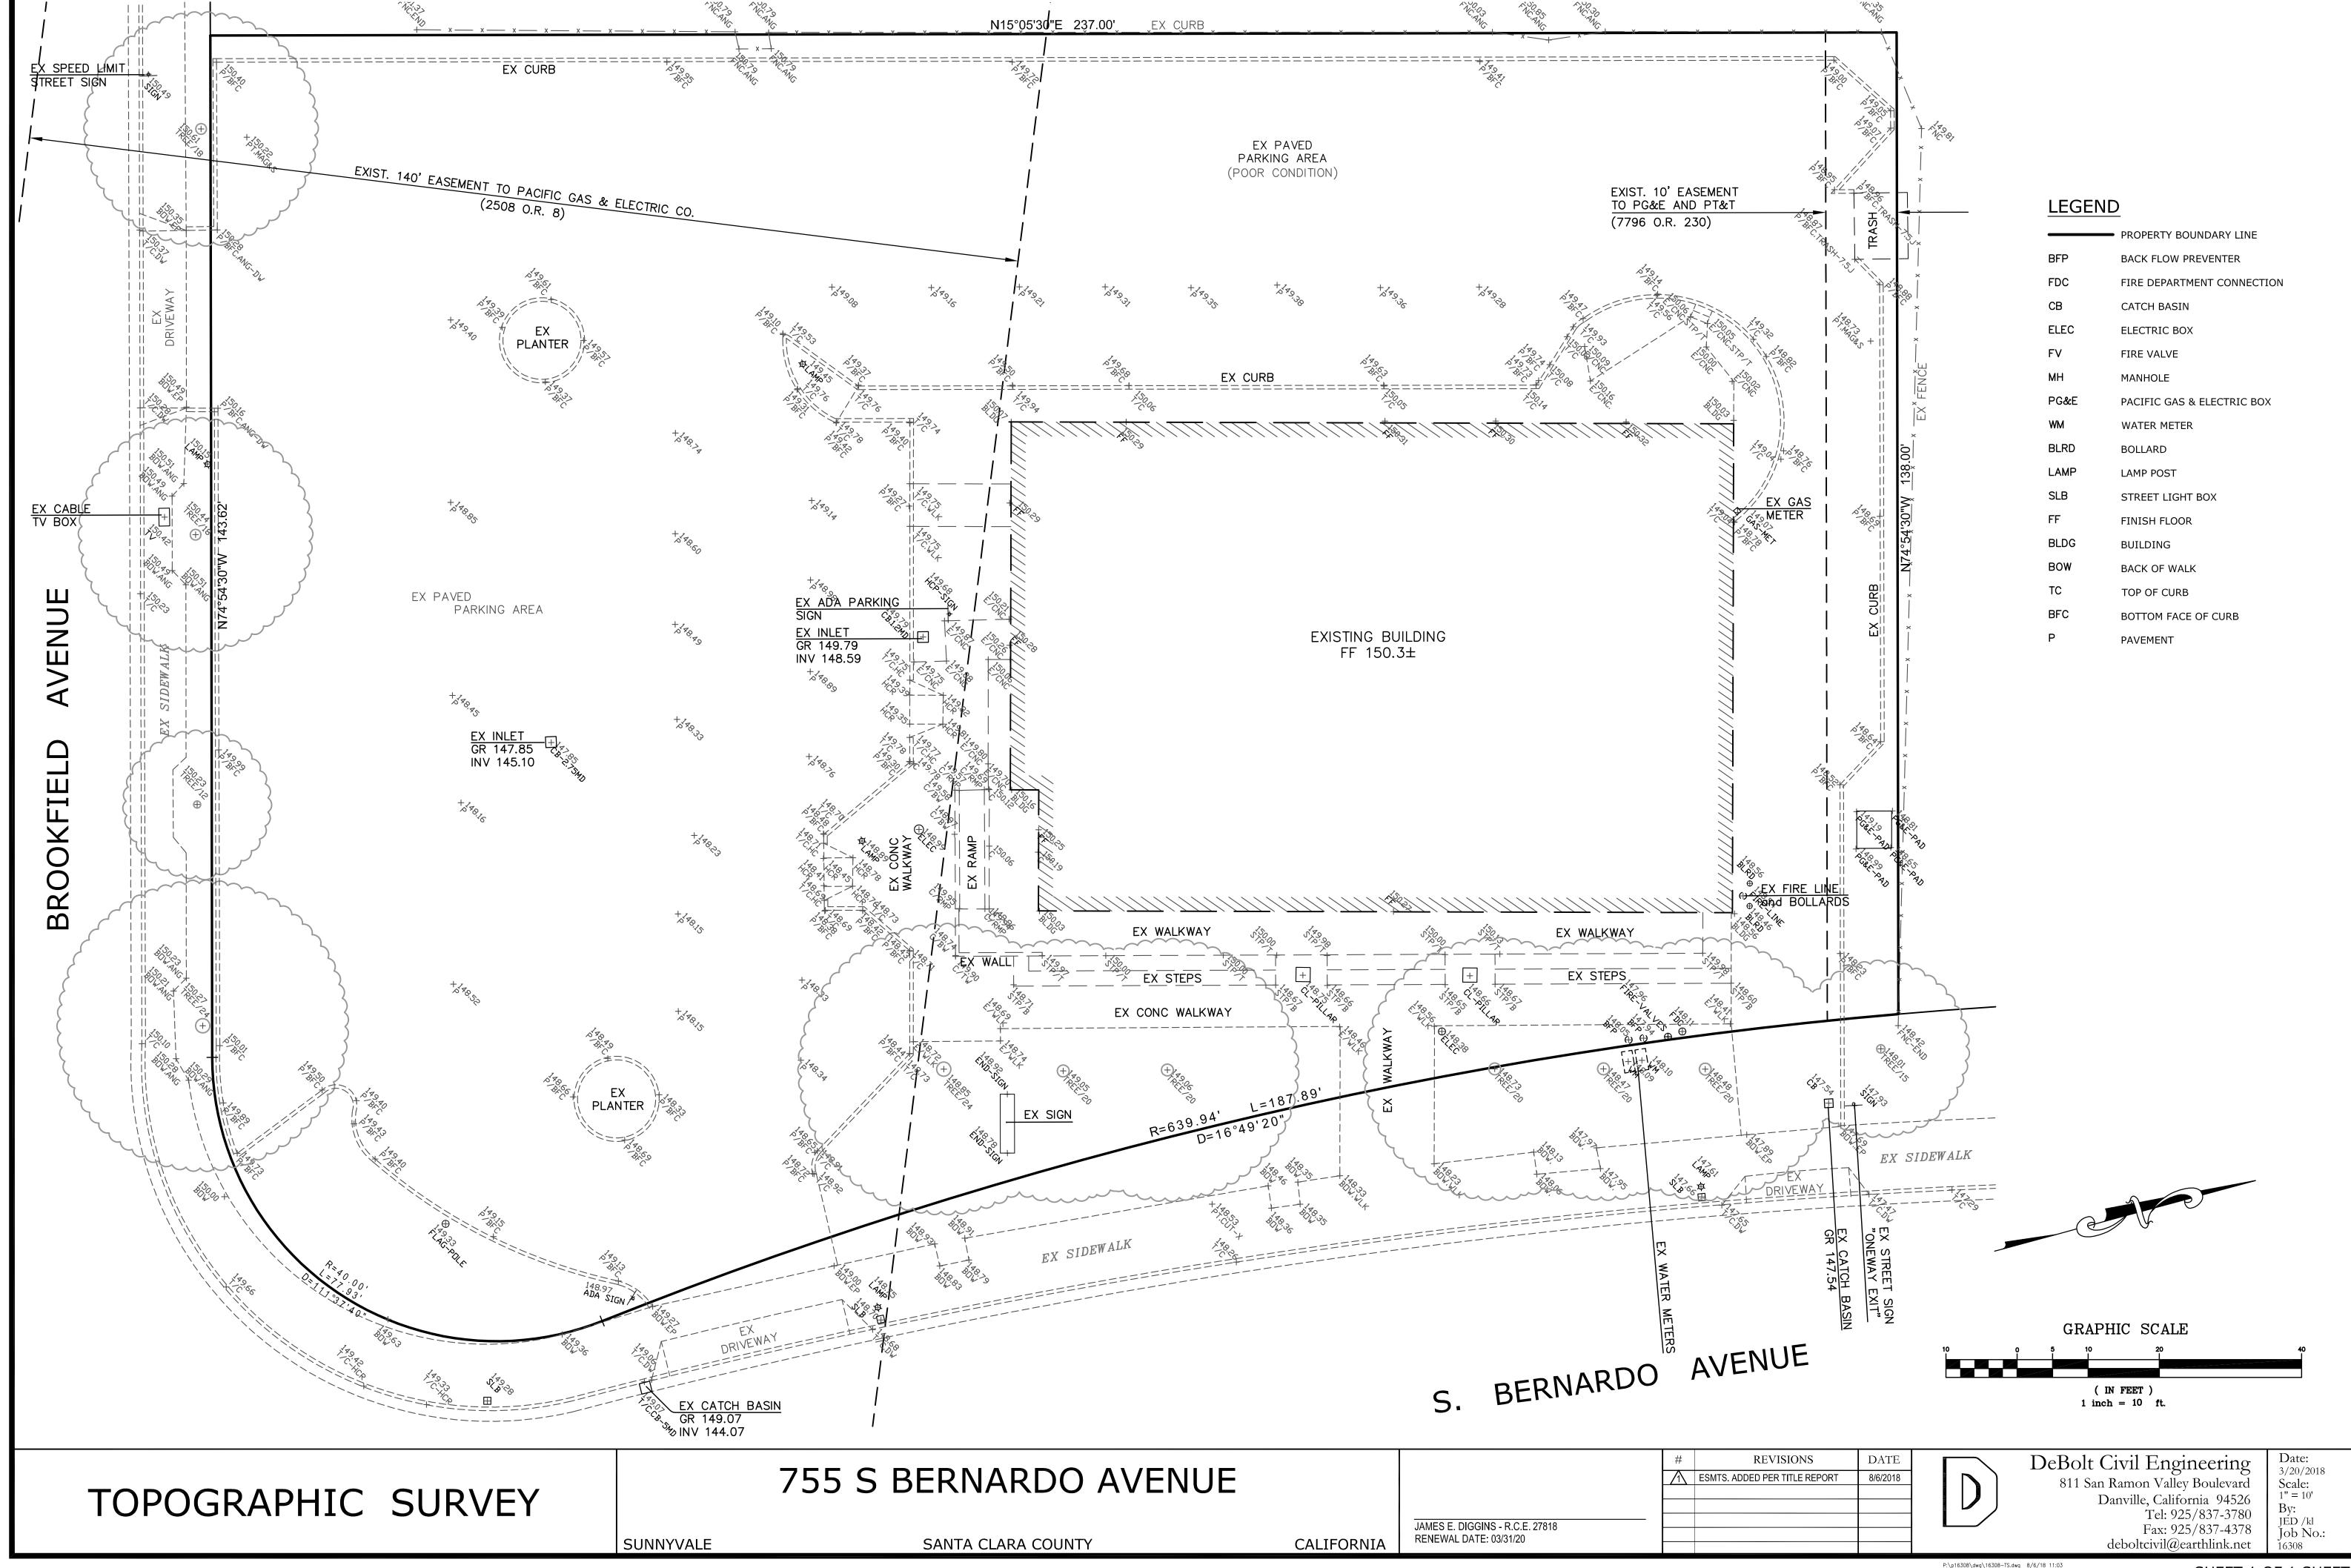

CHK'D BY:


MR ENGINEERING

DRAWING TITLE:

ELECTRICAL SITE PLAN

NOT FOR CONSTRUCTION

E1.1

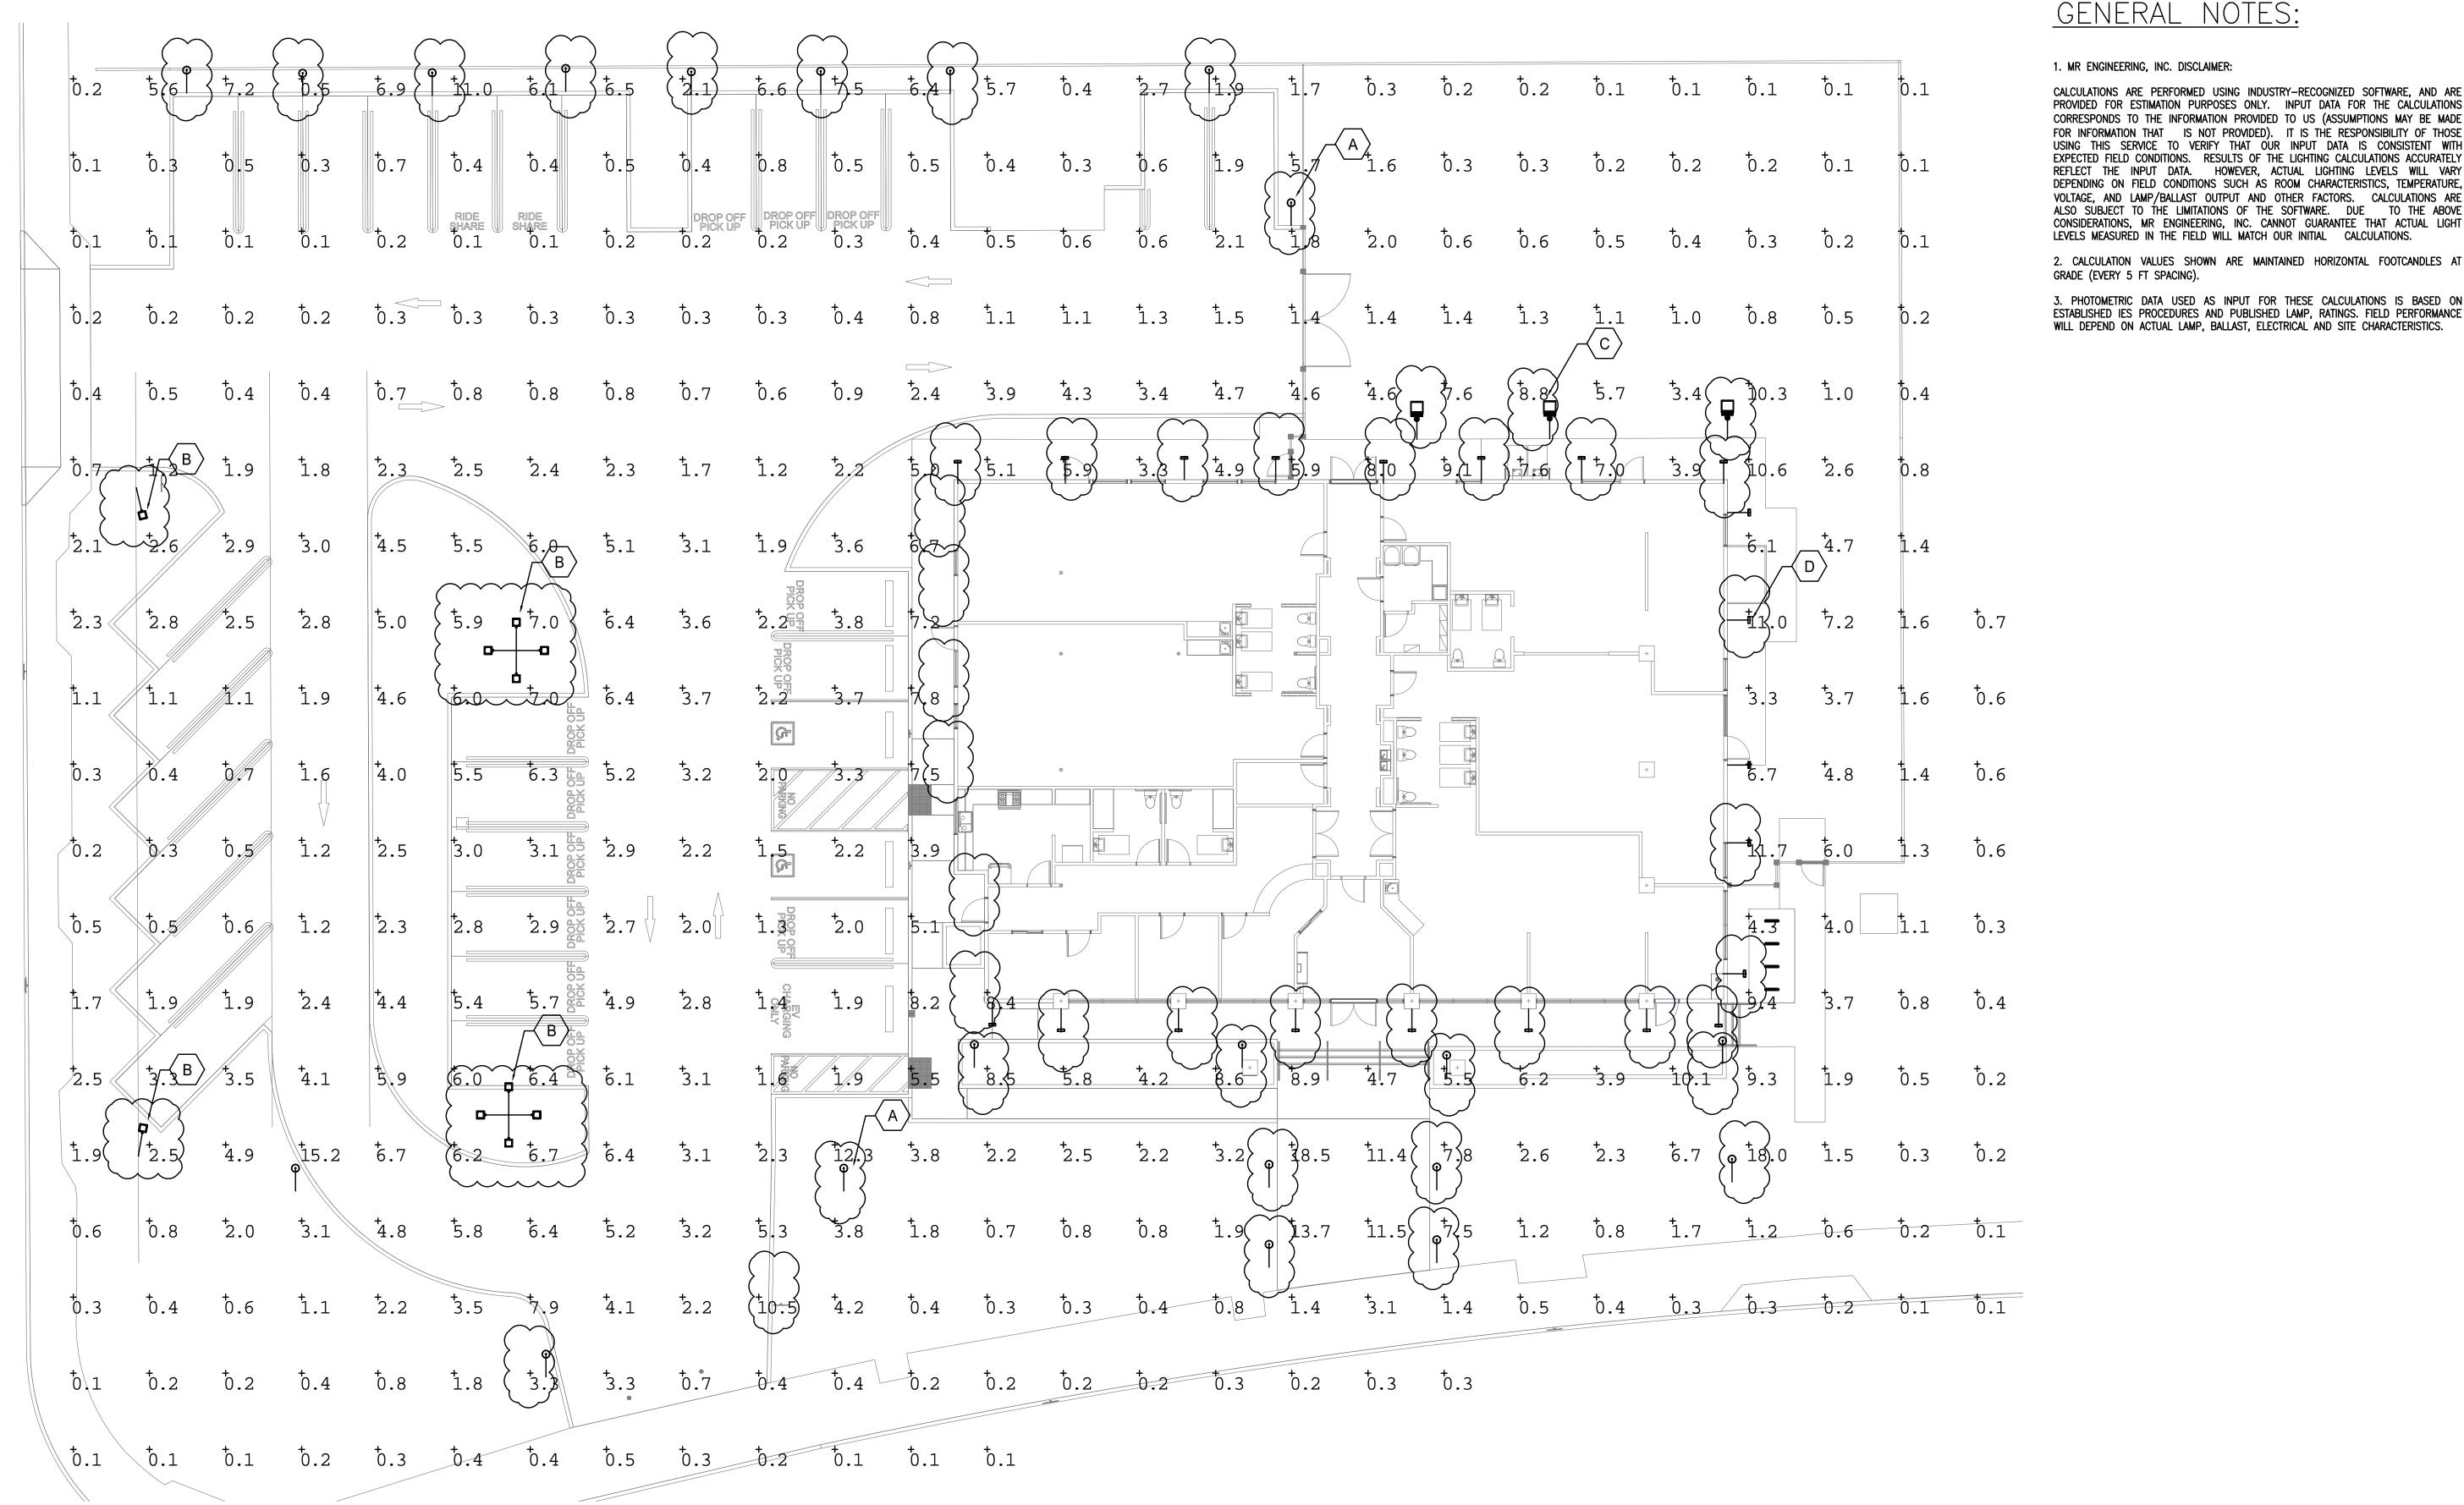

ELECTRICAL PHOTOMETRIC PLAN

CalcType

Illuminance

SCALE: 3/32"=1'-0"

Label

CalcPts_2

Symbol	Qty	Label	Description	Lum. Watts
—(→ 23	DSXB_LED_12C_530_40K_ASY	DSXB LED 12C 530 40K ASY	22
	10	AST1_LED_42C_350_30K_SR2_MVOL	AST1 LED 42C 350 30K SR2 MVOLT	49
—• [3	OLMF_P1_40K_120_DDB_HP17_M4	OLMF P1 40K 120 DDB HP17 M4	27.7
	28	TWR1_LED_1_50K_MVOLT	TWR1 LED 1 50K MVOLT	34.4

64.0


Avg/Min

32.60

Units

Fc

FIXTURE SYMBOL	FIXTURE TYPE	DESCRIPTION	MANUFACTURER'S CATALOG NO.	LAMPS	VOLT	WATTS	MOUNTING
	A	LED BOLLARD	REF: LITHONIA LIGHTING DSXB_LED_12C_530_40K_ASY OR APPROVED EQUAL	LED	120	22	FLOOR MOUNTED
	В	15' LED POLE LUMINAIRE	REF: LITHONIA LIGHTING AST1 LED 42C 350 30K SR2 MVOLT OR APPROVED EQUAL	LED	120	49	POLE MOUNTED
	©	EXTERIOR WALL MOUNTED LED LIGHT DOWN LIGHT AT 8'-0" AFF TO BOT. OF FIXTURE	REF: LITHONIA LIGHTING OLMF P1 40K 120 DDB HP17 M4 OR APPROVED EQUAL	LED	120	27.7	WALL MOUNTED
$\langle \nabla \rangle$	D	LED WALL LUMINAIRE	REF: LITHONIA LIGHTING TWR1_LED_1_50K_MVOLT APPROVED EQUAL	LED	120	34.4	WALL MOUNTED

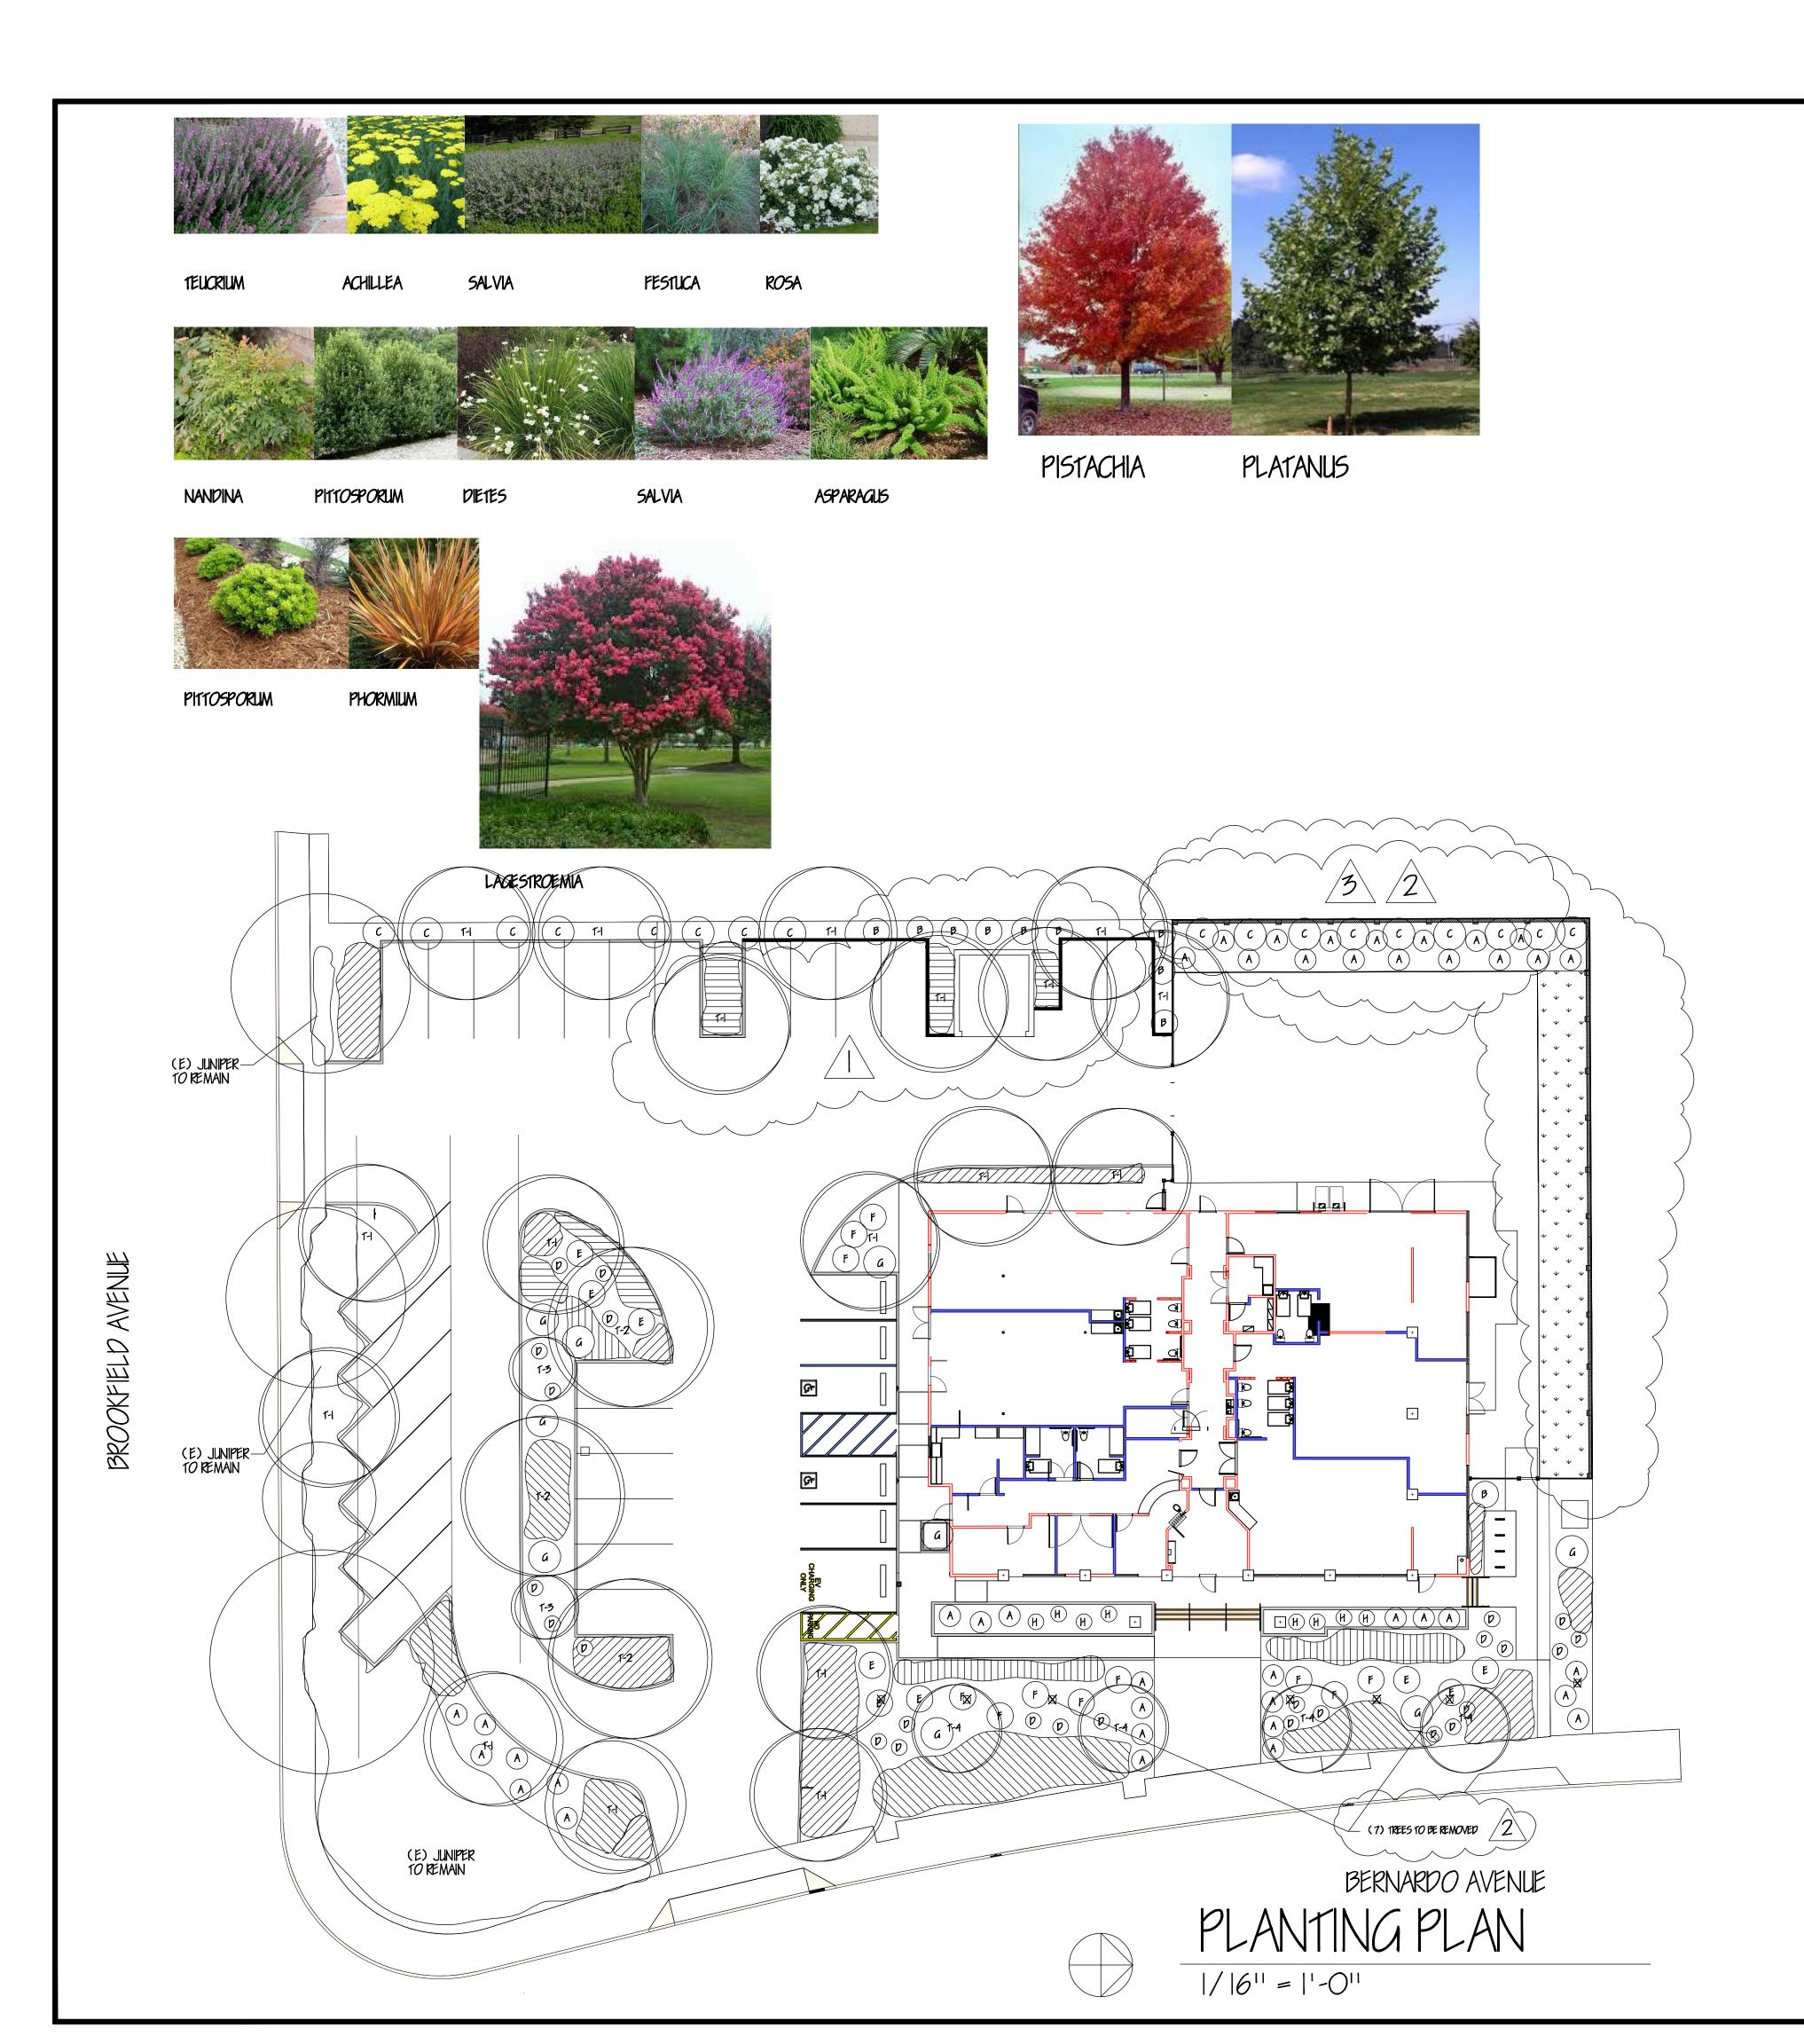

LANT	LEGEND	AND	NOTES	
	Bakania	مرم ا ۸ ا م	-	

Sym	Botanical Name/ Common Name	Size	Water	WUCC
	Teucrium chamraedys/Germander @ 5' oc	l gallon	low	3
	Achillea Moonshine/Yellow Yarrow @ 5' oc	l qallon	low	.2
	Salvia Bee's Bliss @ 4' oc	l gallon	l <i>o</i> w	3
	Carex divulsa/Berkeley Sedge @ 3' oc	l gallon	low	3
* * * * * * * * * * * * * * * * * * *	Sod lawn - 100% dwarf fescue		hiqh	.7
Α	Rosa/White Carpet Rose	5 qallon	low	3
В	Nandina domestica	5 qallon	low	3
С	Pittosporum tenufolium	5 qallon	low	3
D	Dietes vegeta/Fortnight Lily	5 qallon	l <i>o</i> w	3
E	Salvia leucantha/Sage	5 qallon	l <i>o</i> w	3
F	Pittosporum tobira Wheelers Dwarf	5 qallon	low	3
G	Phormium tenax Apricot Queen/Flax	5 qallon	low	3
Н	Asparagus / Asparagus Fern	5 qallon	med	5
T-I	Pistachia chinense Keith Davey/Chinese Pistache	24" box	low	3
T-2	Platanus acerifolia Yarwood/Sycamore	24" box	low	3
T-3	Lagestroemia Muskogee/Crape Myrtle	15 qallon	l <i>o</i> w	3
T-4	Lagestroemia Tuscorora/Crape Myrtle	15 qallon	low	3

- 1) Verify placement of all proposed plant material and protect existing trees and plants to remain.
- 2) All existing tree stumps to be ground and removed.
- 3) For existing site soil, break up and amend thoroughly prior to planting. Recommend soil fertility analysis for soil preparation recommendations.
- 4) For new parking lot planters, all asphalt and existing gravel base to be removed. Thoroughly break up subsoil and place import clay loam topsoil. Thoroughly mix import soil into native and amend.
- 5) Incorporate 3" of approved compost at all planting areas as an alternative to the soil preparation recommendations.
- 6) Spread 3'' of approved earth tone wood chip mulch at all planting areas after planting installation is complete.
- 7) I have complied with the criteria of the ordinance and applied them for the efficient use of water in the landscape design plan.

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JY INTERNATIONAL GROUP, INC.

for:

JY INTERNATIONAL GROUP, INC. 755 BERNARDO AVE. SUNNYVALE, CA. 94087

PLANTING PLAN

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PISTACHIA

PLATANUS

SHADED CALCULATION TABLE
Sym Botanical Name/Common Name Full sf 3/4 1/2 1/4 Total sf

T-I Pistachia chinensis Keith Davey/Chinese Pistache 3 @ 368 sf 14 @ 245 sf 1 @ 123 sf 4657 sf

T-2 Platanus acerifolia Yarwood/Yarwood Sycamore 3 @ 706 sf 1 @ 368 2486 sf

(E) Existing Tree Varieties 830 sf

Total Tree Shade: 7973

Total Paved Area: 15,584 sf (50% = 7792)

Percent Shaded: 51%

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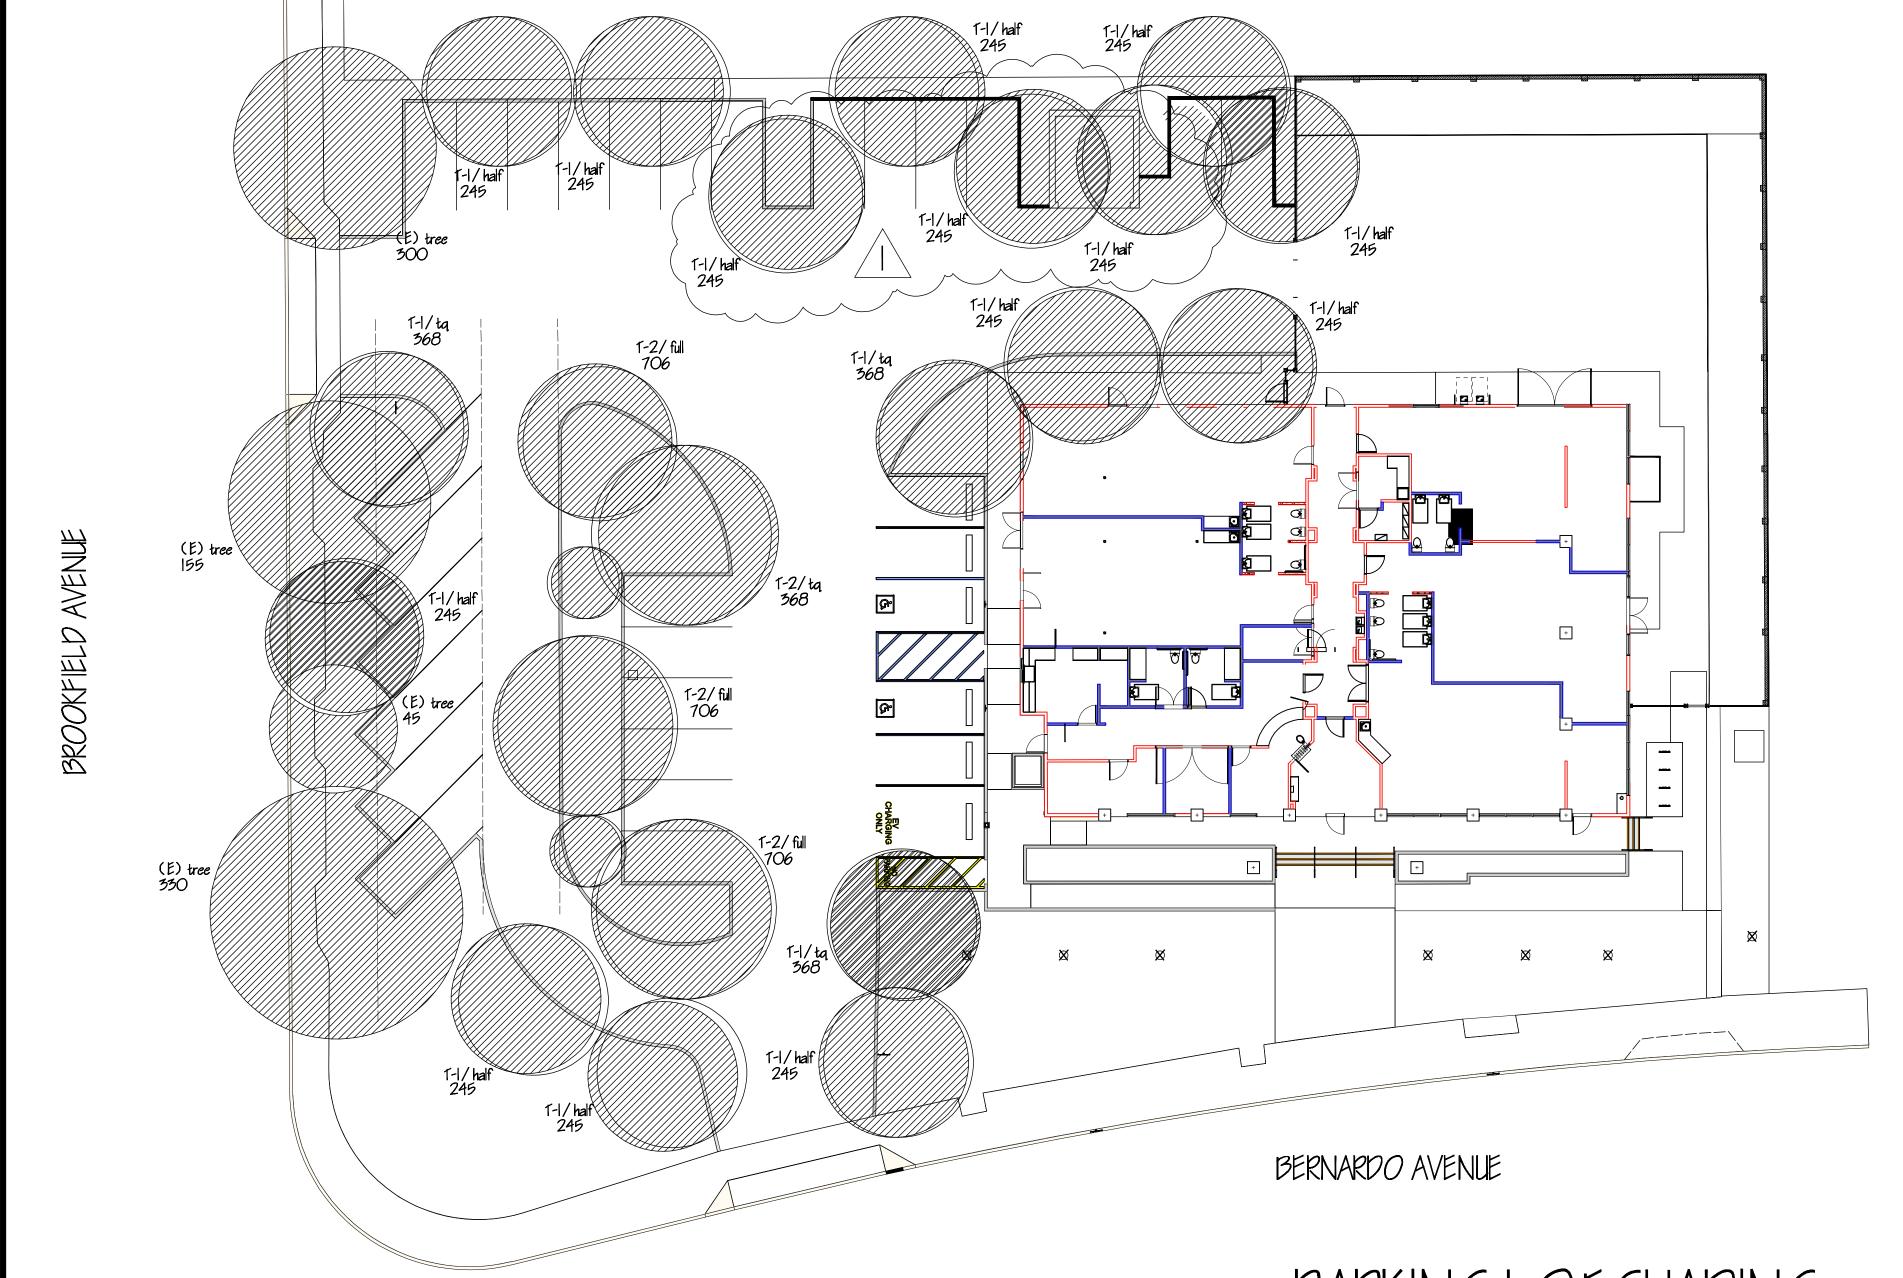
PARKING LOT SHADING

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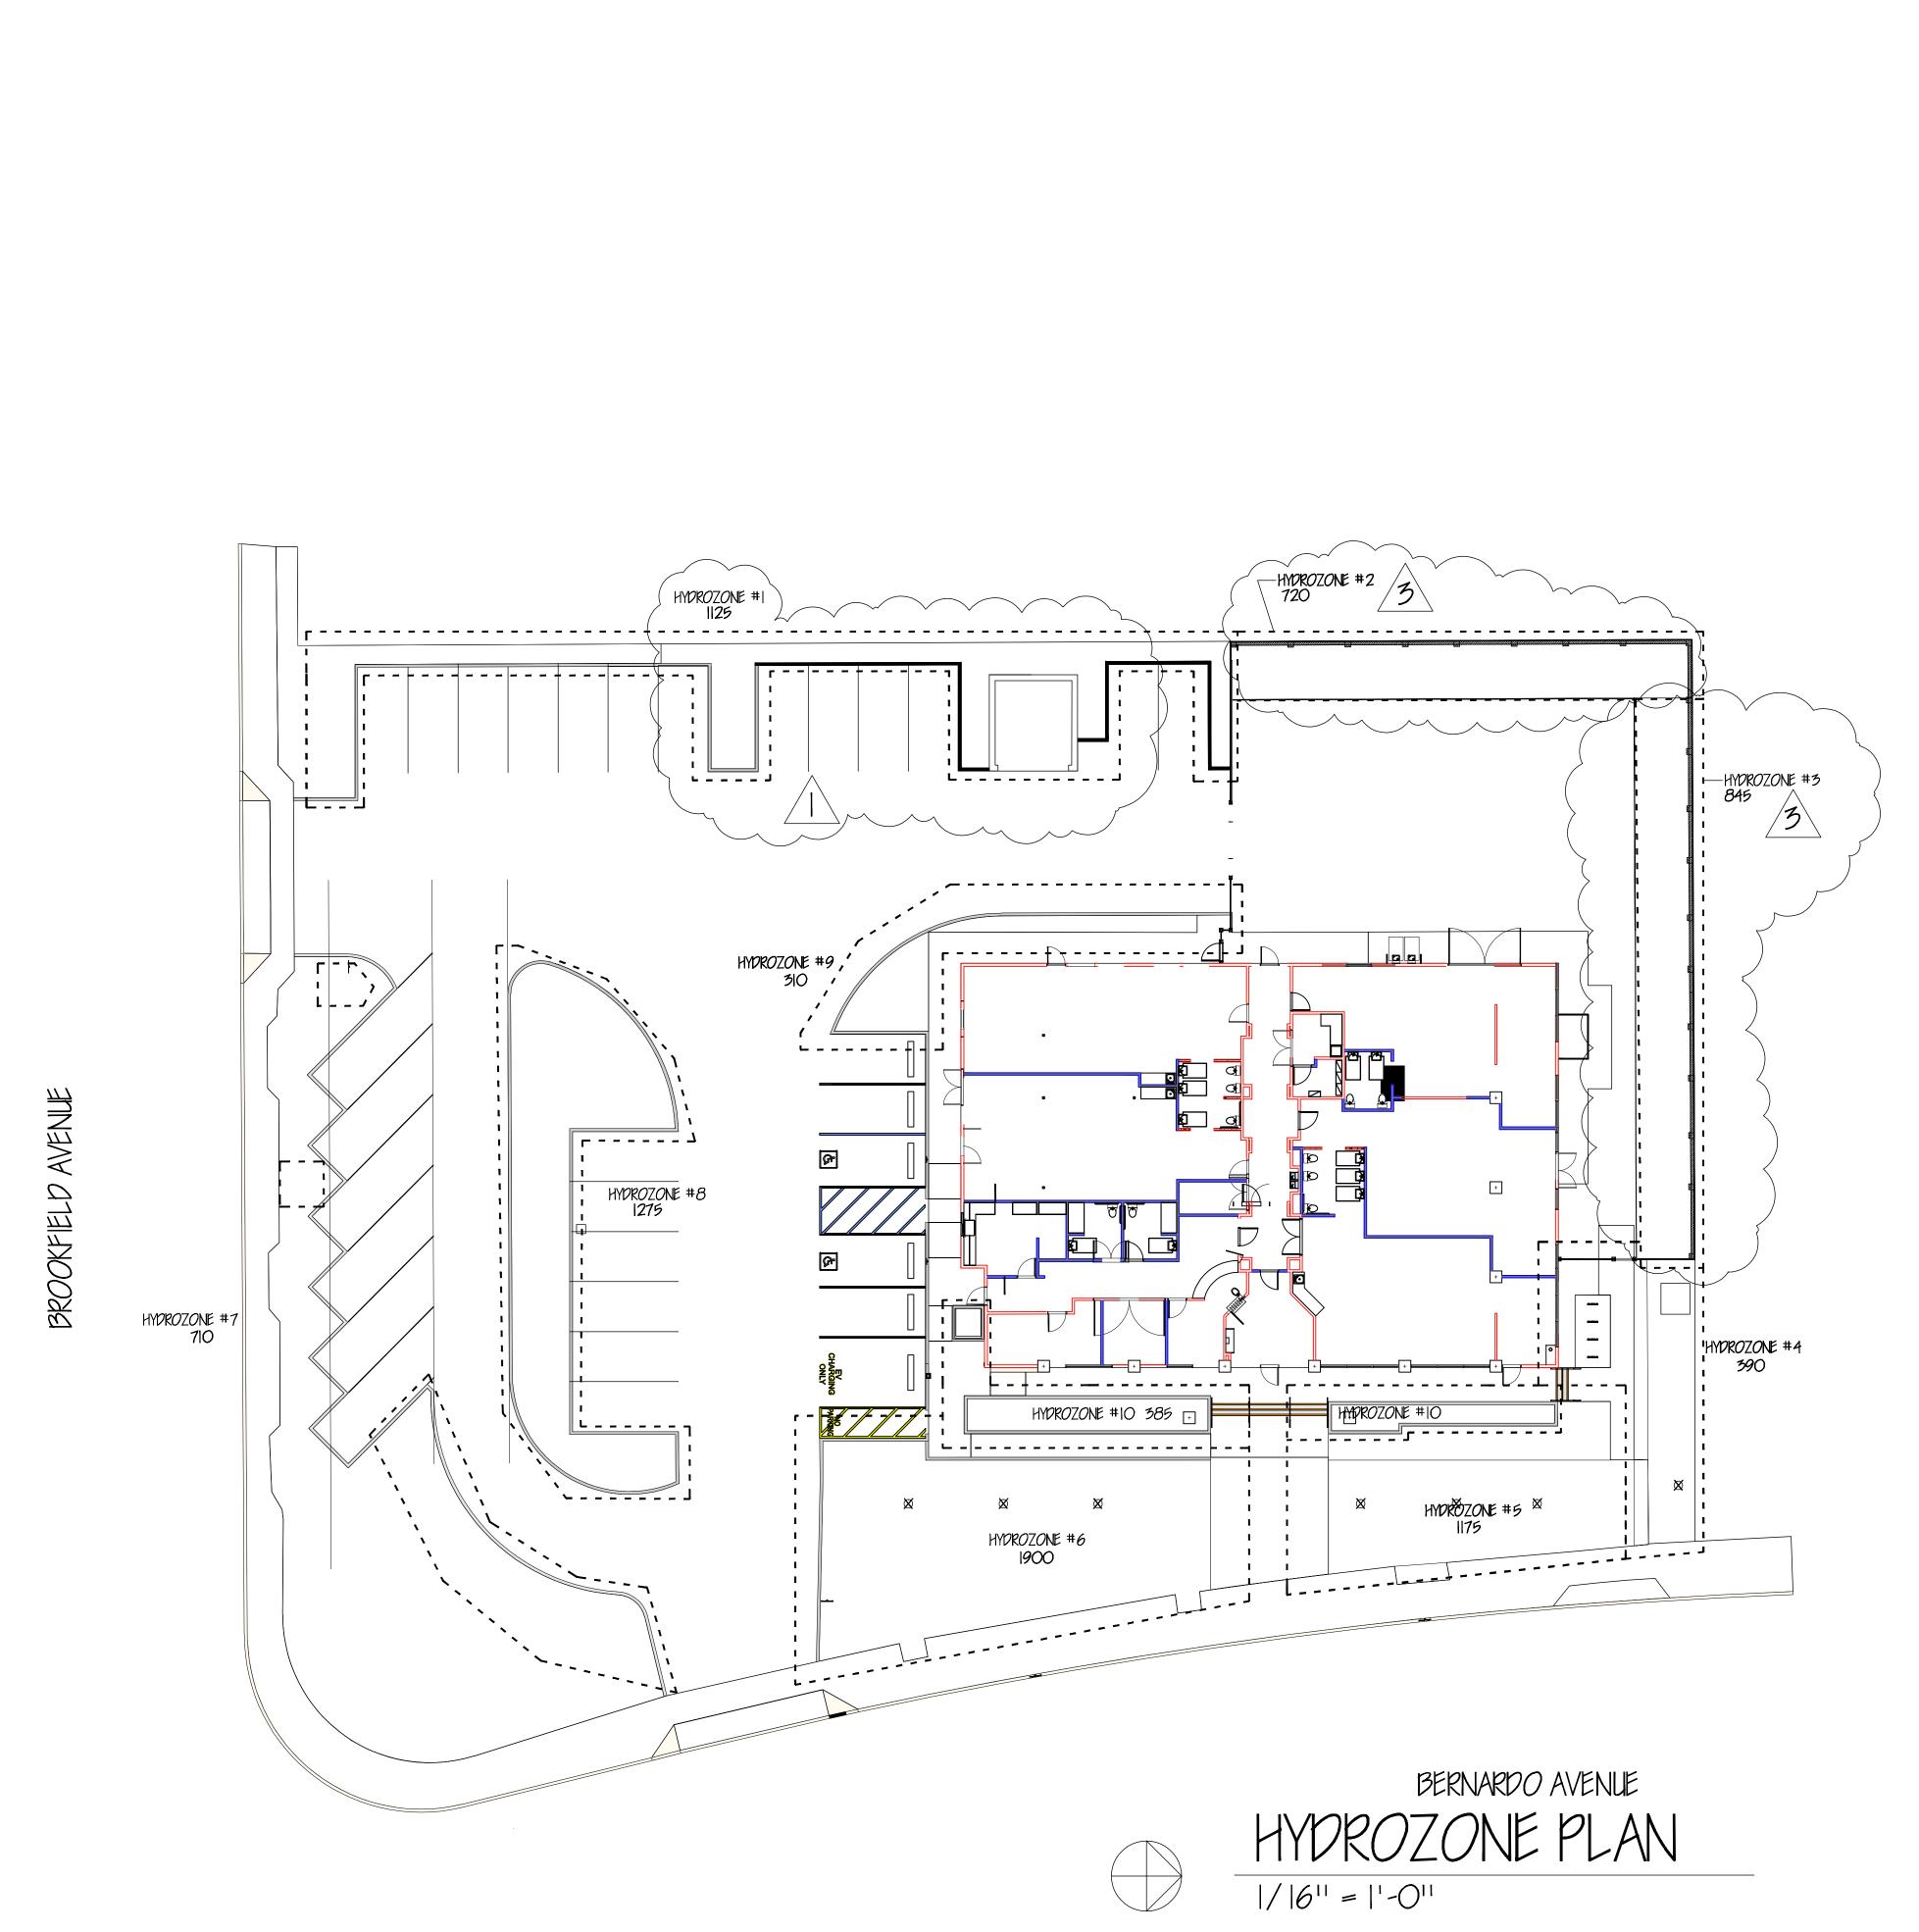
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Reference Evapotranspir	ration (ET _o)	45.3	Proj	ect Type	Non-Resid	lential	0.45
Hydrozone # / Planting Description ^a	Plant Factor (PF)		Irrigation Efficiency (IE) ^c	ETAF (PF/IE)	Landscape Area (Sq. Ft.)		Estimated Total Water Use (ETWU) ^d
Regular Landscape	Areas						
#1 low	0.3	Drip	0.81	0.37	1125	417	11703
#2 low	0.3	Drip	0.81	0.37	720	267	7490
#3 high		Overhead	0.75	0.93	505	471	13238
#4 low	0.3	Drip	0.81	0.37	845	313	8790
#5 low	0.3	Drip	0.81	0.37	1175	435	12223
#6 low	0.3	Drip	0.81	0.37	1900	704	19764
#7 low		Drip	0.81	0.37	710	263	7386
#8 low	0.3	Drip	0.81	0.37	1295	480	13471
#9 low	0.3	Drip	0.81	0.37	310	115	3225
#10 medium	0.5	Drip	0.81	0.62	385	238	6675
		•	0.75	0.00		0	C
			0.75	0.00		0	(
			0.75	0.00		0	C
			0.75	0.00		О	(
			0.75	0.00		0	(
			0.75	0.00		0	(
			0.75	0.00		0	C
			0.75	0.00		o	(
			0.75	0.00		0	(
			0.75	0.00		0	(
				Totals	8970	3702	103963
Special Landscape	Areas						
				1		0	C
				1		0	(
				1		0	C
				1	_	0	C
				Totals	0	0	(
					EIV\	/U Total	103963

Maximum Allowed Water Allowance (MAWA)^e ETAF Calculations Average ETAF for Regular Regular Landscape Areas Landscape Areas must be 0.55 or Total ETAF x Area below for residential areas, and Total Area 0.45 or below for non-residential Average ETAF

All Landscape Areas Total ETAF x Area Total Area Average ETAF

^a Hydrozone # / Planting Description e.g.

- 1.) Front lawn 2.) Low water use planting 3.) Medium water use planting
- b Irrigation Method 1.) Overhead Spray

2.) Drip

^c Irrigation Efficiency 1.) 0.75 for Overhead Spray 2.) 0.81 for Drip

d ETWU (Annual Gallons Required) =

Eto x 0.62 x ETAF x Area Where 0.62 is a conversion factor to change acre-inches per acre per year to gallons per square foot per year

^e MAWA (Annual Gallons Allowed) = (Eto) (0.62) [(ETAF x LA) + ((1-ETAF) x SLA)] Where 0.62 is a conversion factor to change acre-inches per acre per year to gallons per square foot per year, LA is the total regular landscape area in square feet, SLA is the total special landscape area in square feet, and ETAF is 0.55 for residential areas and 0.45 for non-residential areas

0.45 Non-Residential 0.55 Residential 0.81 Drip 0.75 Overhead

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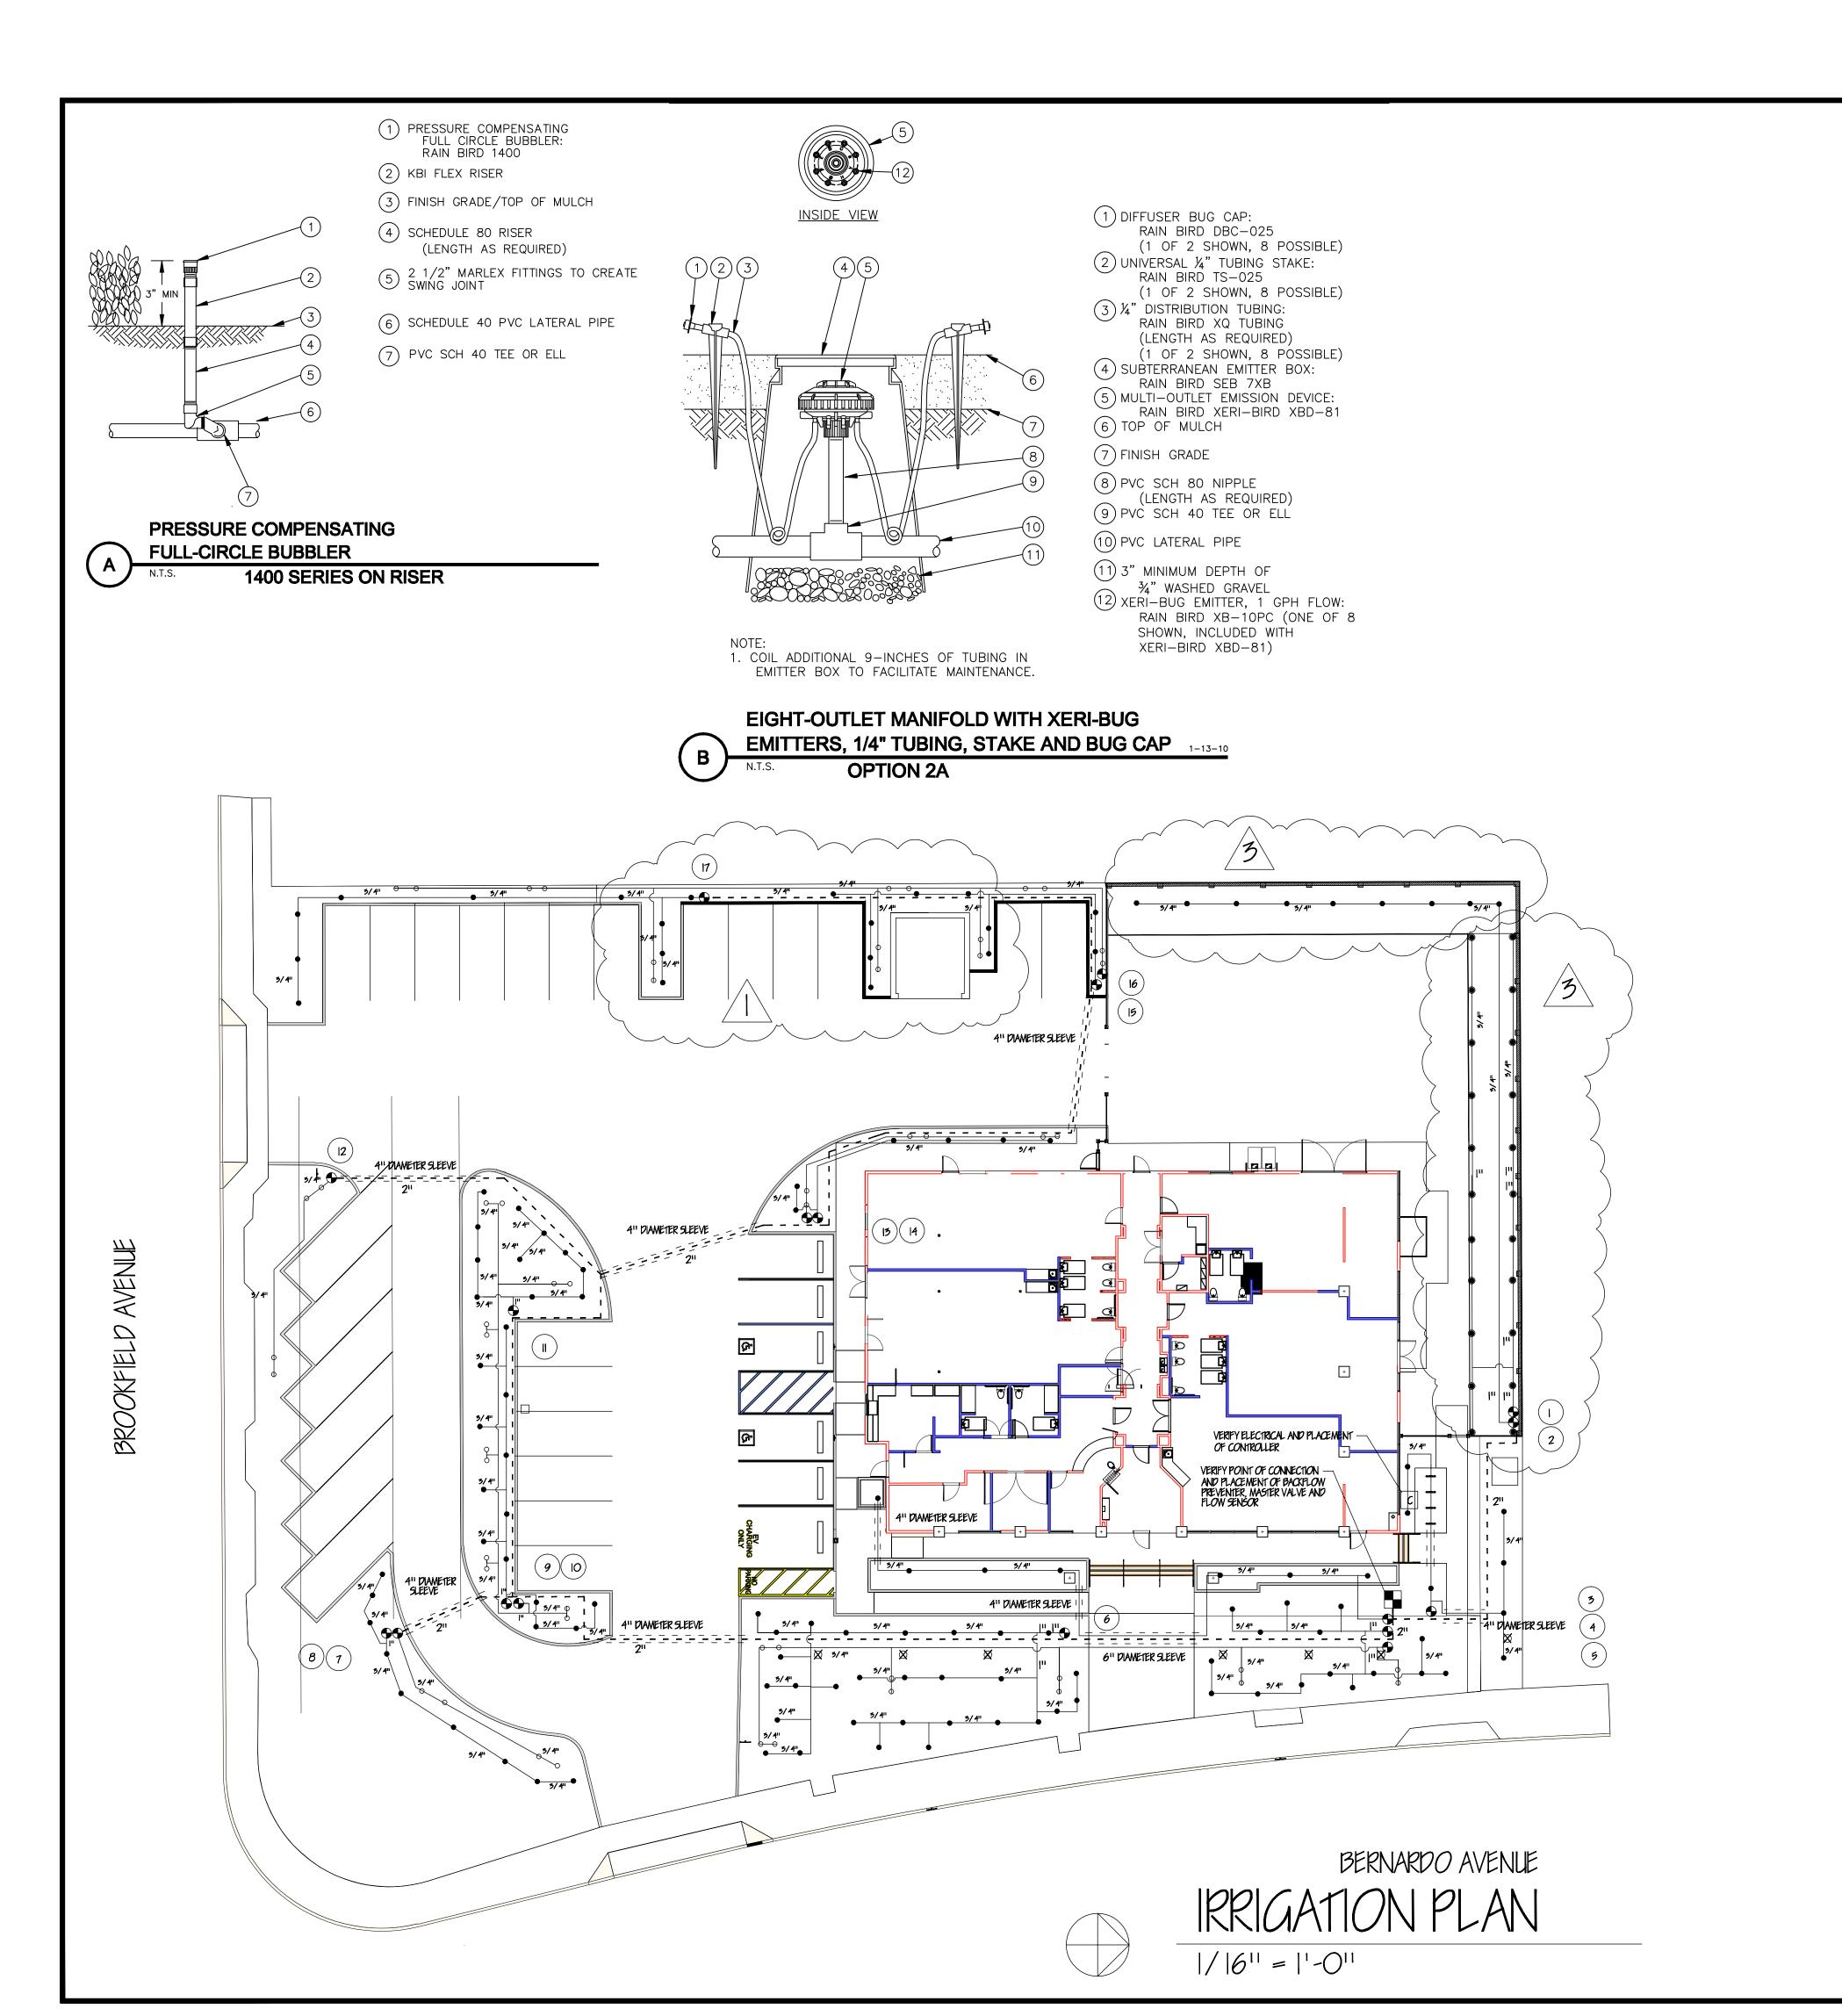
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HYDROZONE PLAN

date: |/||/|8 NOTED drawn by: WJH

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IRRIGATION LEGEND

Hunter Pro with Solar Sync and rain sensor - verify electrical source and placement

" Water Meter - verify size and location

Febco #825Y- | " reduced pressure backflow preventer - provide lockable cover with Watts Master Valve with Flow Sensor sized per point of connection/verify manufacturer with city

— Schedule 40 pvc mainline - $\frac{1}{2}$ " - min. depth 18"

=== Schedule 40 pvc sleeving

Rainbird PEB series control valves with in line pressure reducer set to 35 psi and Y filter for drip circuits and without for bubbler and rotor circuits

Schedule 40 pvc lateral lines $-\frac{3}{4}$ " unless noted-min. depth 12"

Rainbird Xeri-Bug Octa Bubbler

Rainbird #1400 series bubbler for trees - two per tree on separate circuits

Hunter MP Rotator on 6" pop up for lawn areas only

Control valve number

1) Verify water and electrical services for point of connection.

2) Verify site water pressure of 65 psi at point of connection - notify architect prior to construction if found to be different.

3) Verify electrical source and placement of controller. Follow all grounding instructions per controller installation quide and flow meter specifications quide.

4) Contractor shall provide all necessary safety precautions throughout construction. This shall include signage and barriers.

5) Verify operation of system before backfilling trenches. Drip line to be secured to grade with stakes at base of each plant.

6) System layout is diagrammatic, actual field conditions will dictate final layout, addition of drip line, etc.

7) Verify control wire placement and access under pavement and extension of additional wires for future expansion.

8) Verify rain sensor in field.

9) Contractor shall be responsible for setting and monitoring irrigation system to apply adequate water for establishment, but to eliminate runoff and soil saturation.

10) Contractor to submit maintenance and irrigation schedule to Owner at completion of installation and maintenance/warrantee period.

11) Contractor shall verify location of all underground utilities prior to any trenching or excavation.

12) Verify and coordinate installation of sleeving and/or mainline and control wire conduit access under all pavement. Verify with paving contractor. Piping under road shall be installed a minimum of 24" deep with piping surrounded by a 6^{11} sand envelope.

13) Trees shall be irrigated on separate circuits and with two $\frac{1}{2}$ apm bubblers, one at the surface, the other in a perforated vertical tube set adjacent to the root ball.

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IRRIGATION PLAN

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