

(2) NEW TWO STORY DETACHED HOMES

E. HOMESTEAD RD. (APN: 309-46-053) SUNNYVALE, CA 94086

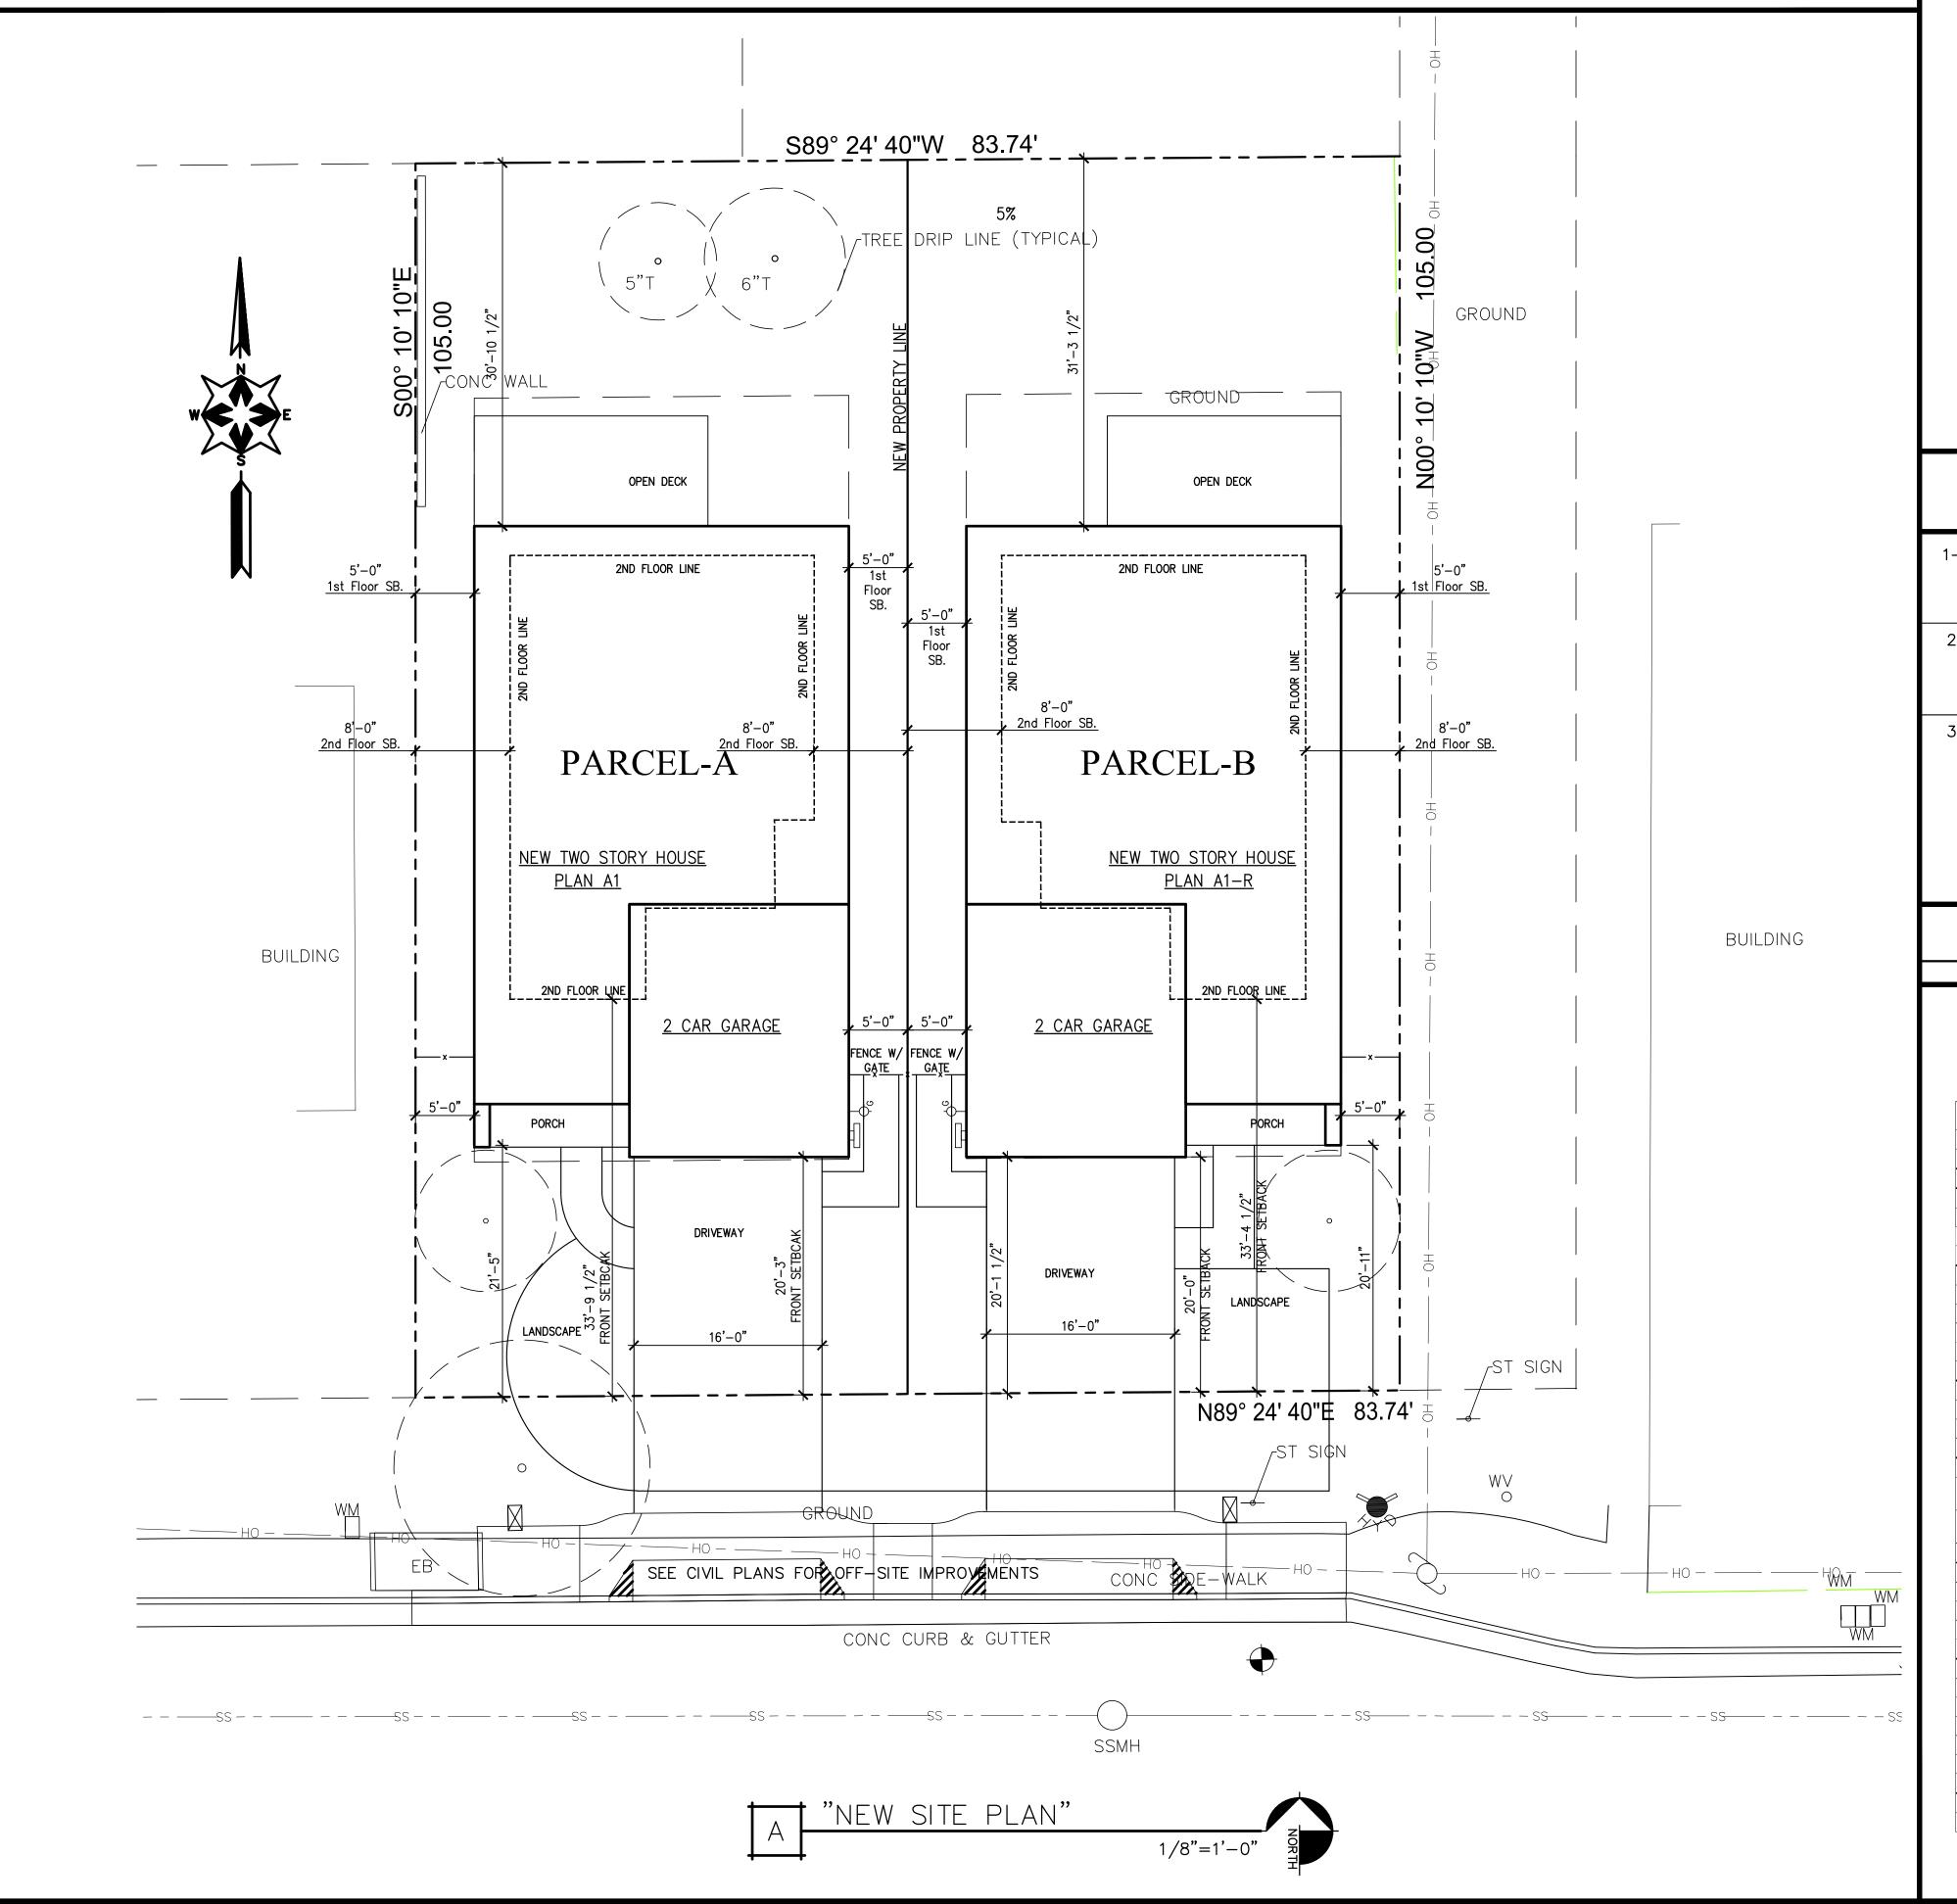

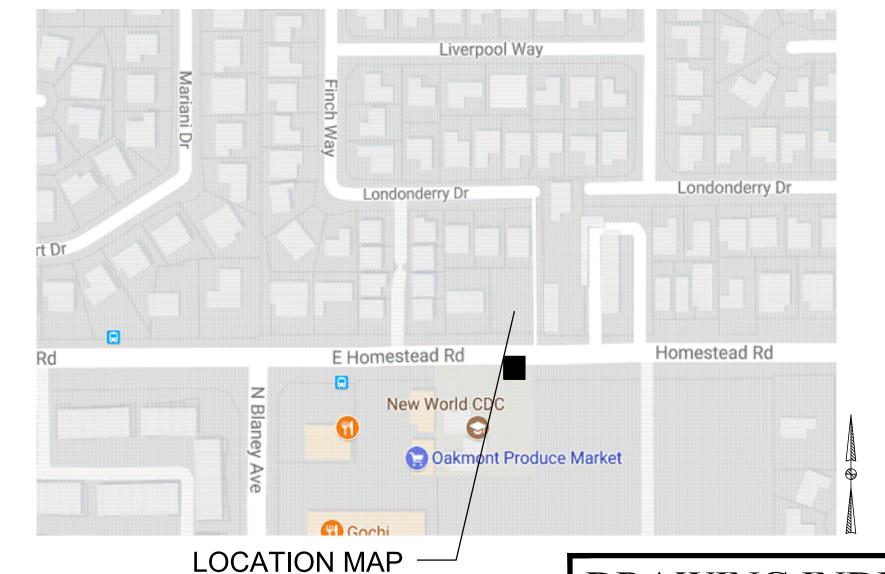

CONSULTANTS

1- DESIGNER	AKS BUILDING DESIGN Designer: Aman Dulay 18010 Harvest Lane SARATOGA, CA 95070	(408) 375-8351	
2- CIVIL	SMP ENGINEERS 1534 CAROB LANE LOS ALTOS, CA 94024	(650) 941-8055 (650) 941-8755	
3- LANDSCAPE	REED ASSOCIATES 477 S. TAAFFE ST.	(408) 481-9020	

SUNNYVALE, CA 94086

DRAWING INDEX

A-1 COVER SHEET/ NEW SITE PLAN

A-1.1 AREA CALCULATIONS-PLAN A-1

A-1.2 AREA CALCULATIONS-PLAN A-2

A-1.0 EXISTING SITE CONDITIONS

A-1.3 RENDERINGS A-1.4 STREET SCAPE-PICTURES A-1.5 SOLAR STUDY TENTATIVE MAP CIVIL COVER SHEET GRADING & DRAINAGE PLAN C-3 OFF-SITE IMPROVEMENT PLAN CIVIL DETAILS EROSION CONTROL PLAN NEW FIRST FLOOR PLANS NEW SECOND FLOOR PLANS NEW ROOF PLANS A-5 NEW ELEVATIONS-PLAN A-1 NEW ELEVATIONS-PLAN A-2 A-7 SECTIONS- PLAN A-1 & A-2

CG-1 CALGREEN CHEKLIST

GB-1 GREEN BUILDING CHEKLIST

L1.0 LANDSCAPE PLANTING PLAN

L2.0 LANDSCAPE HYDROZONE PLAN

PROJECT DATA

RESIDENTIAL PROJECT DATA Applicant should refer to the Sunnyvale Municipal Code for current requirements.

	EXISTING CONDITIONS	PROPOSED PROJECT	REQUIRED/ PERMITTED
General Plan Category			
Zoning District	R 2	R2	
Use (If vacant, how long has it been vacant?)			N/A
Lot Size (sq. ft.)	8,792	2 x 4,396 sf	
Gross Floor Area (sq. ft.)	0 (Vacant Lot)	2 x 2,421 sf	
Floor Area Ratio (%)	n/a	55.0%	
Lot Coverage (%)	n/a	29.5%	
Number of Units	0	2 Single Family	
Density (units/acre)	n/a	n/a	
Meets 75% min?	n/a	n/a	
Bedrooms / Unit	n/a	3	
Unit Sizes (sq. ft.)	n/a	2,421 sf (each)	
Lockable Storage / Unit (cu. ft.)	n/a	n/a	
Number of Buildings On-Site	0	2	
Distance Between Buildings	n/a	8'	
Building Height (ft.)	n/a	27'-10.5"	
No. of Stories	n/a	2	
Front Setbacks (1st Story/2nd Story)	n/a	20'/32'	
Left Side Setbacks(1 st Story/2 nd Story facing property)	n/a	Lot-1: 5'/5' Lot-2: 4'/5'-10.5"	
Right Side Setbacks(1 st Story/2 nd Story facing property)	n/a	Lot-1: 4'/5'10.5" Lot-2: 5'/5'	
Rear Setback	n/a	30'-10.5" /31'-3.5"	
Landscaping (total sq. ft.)	n/a	4,400 sf	
Landscaping (sq. ft./unit)	n/a	2,200 sf	
Useable Open Space (sq. ft./unit)	n/a	2,200 sf	15 ft.
Parking Lot Area Shading (%)	n/a		50% min. in 1
Water Conserving Plants (%)	n/a		70%
Total No. of Parking Spaces	n/a	2 Car Garage (each)	
Standards	n/a	2	
Compacts / % of total	n/a		
Accessible Spaces	n/a		
Covered Spaces	n/a	2 (each)	
Aisle Width (ft.)	n/a		
Bicycle Parking	n/a		
Impervious Surface Area (sq. ft.)	0	4,000 sf (Total)	
Impervious Surface (%)	1005	45.5%	



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(2) NEW TWO STORY HOME E. HOMESTEAD RD. SUNNYVALE, CA 94087 APN: 309-46-053


12561 PASEO CERRO GROUP 2088 E ELENDA DR. CUPERTINO, CA 95014

No.	Submittals	Date
1	PLANNING	3/21/2018
2	PLANNING	6/20/2018
3	PLANNING	9/19/2018
4	PLANNING	11/14/2018

Revision/Issue	Date
	Revision/Issue

Project:	E HOMESTEAD RE
Scale:	As Shown
Date:	11/14/18

"COVER SHEET/ SITE PLAN"

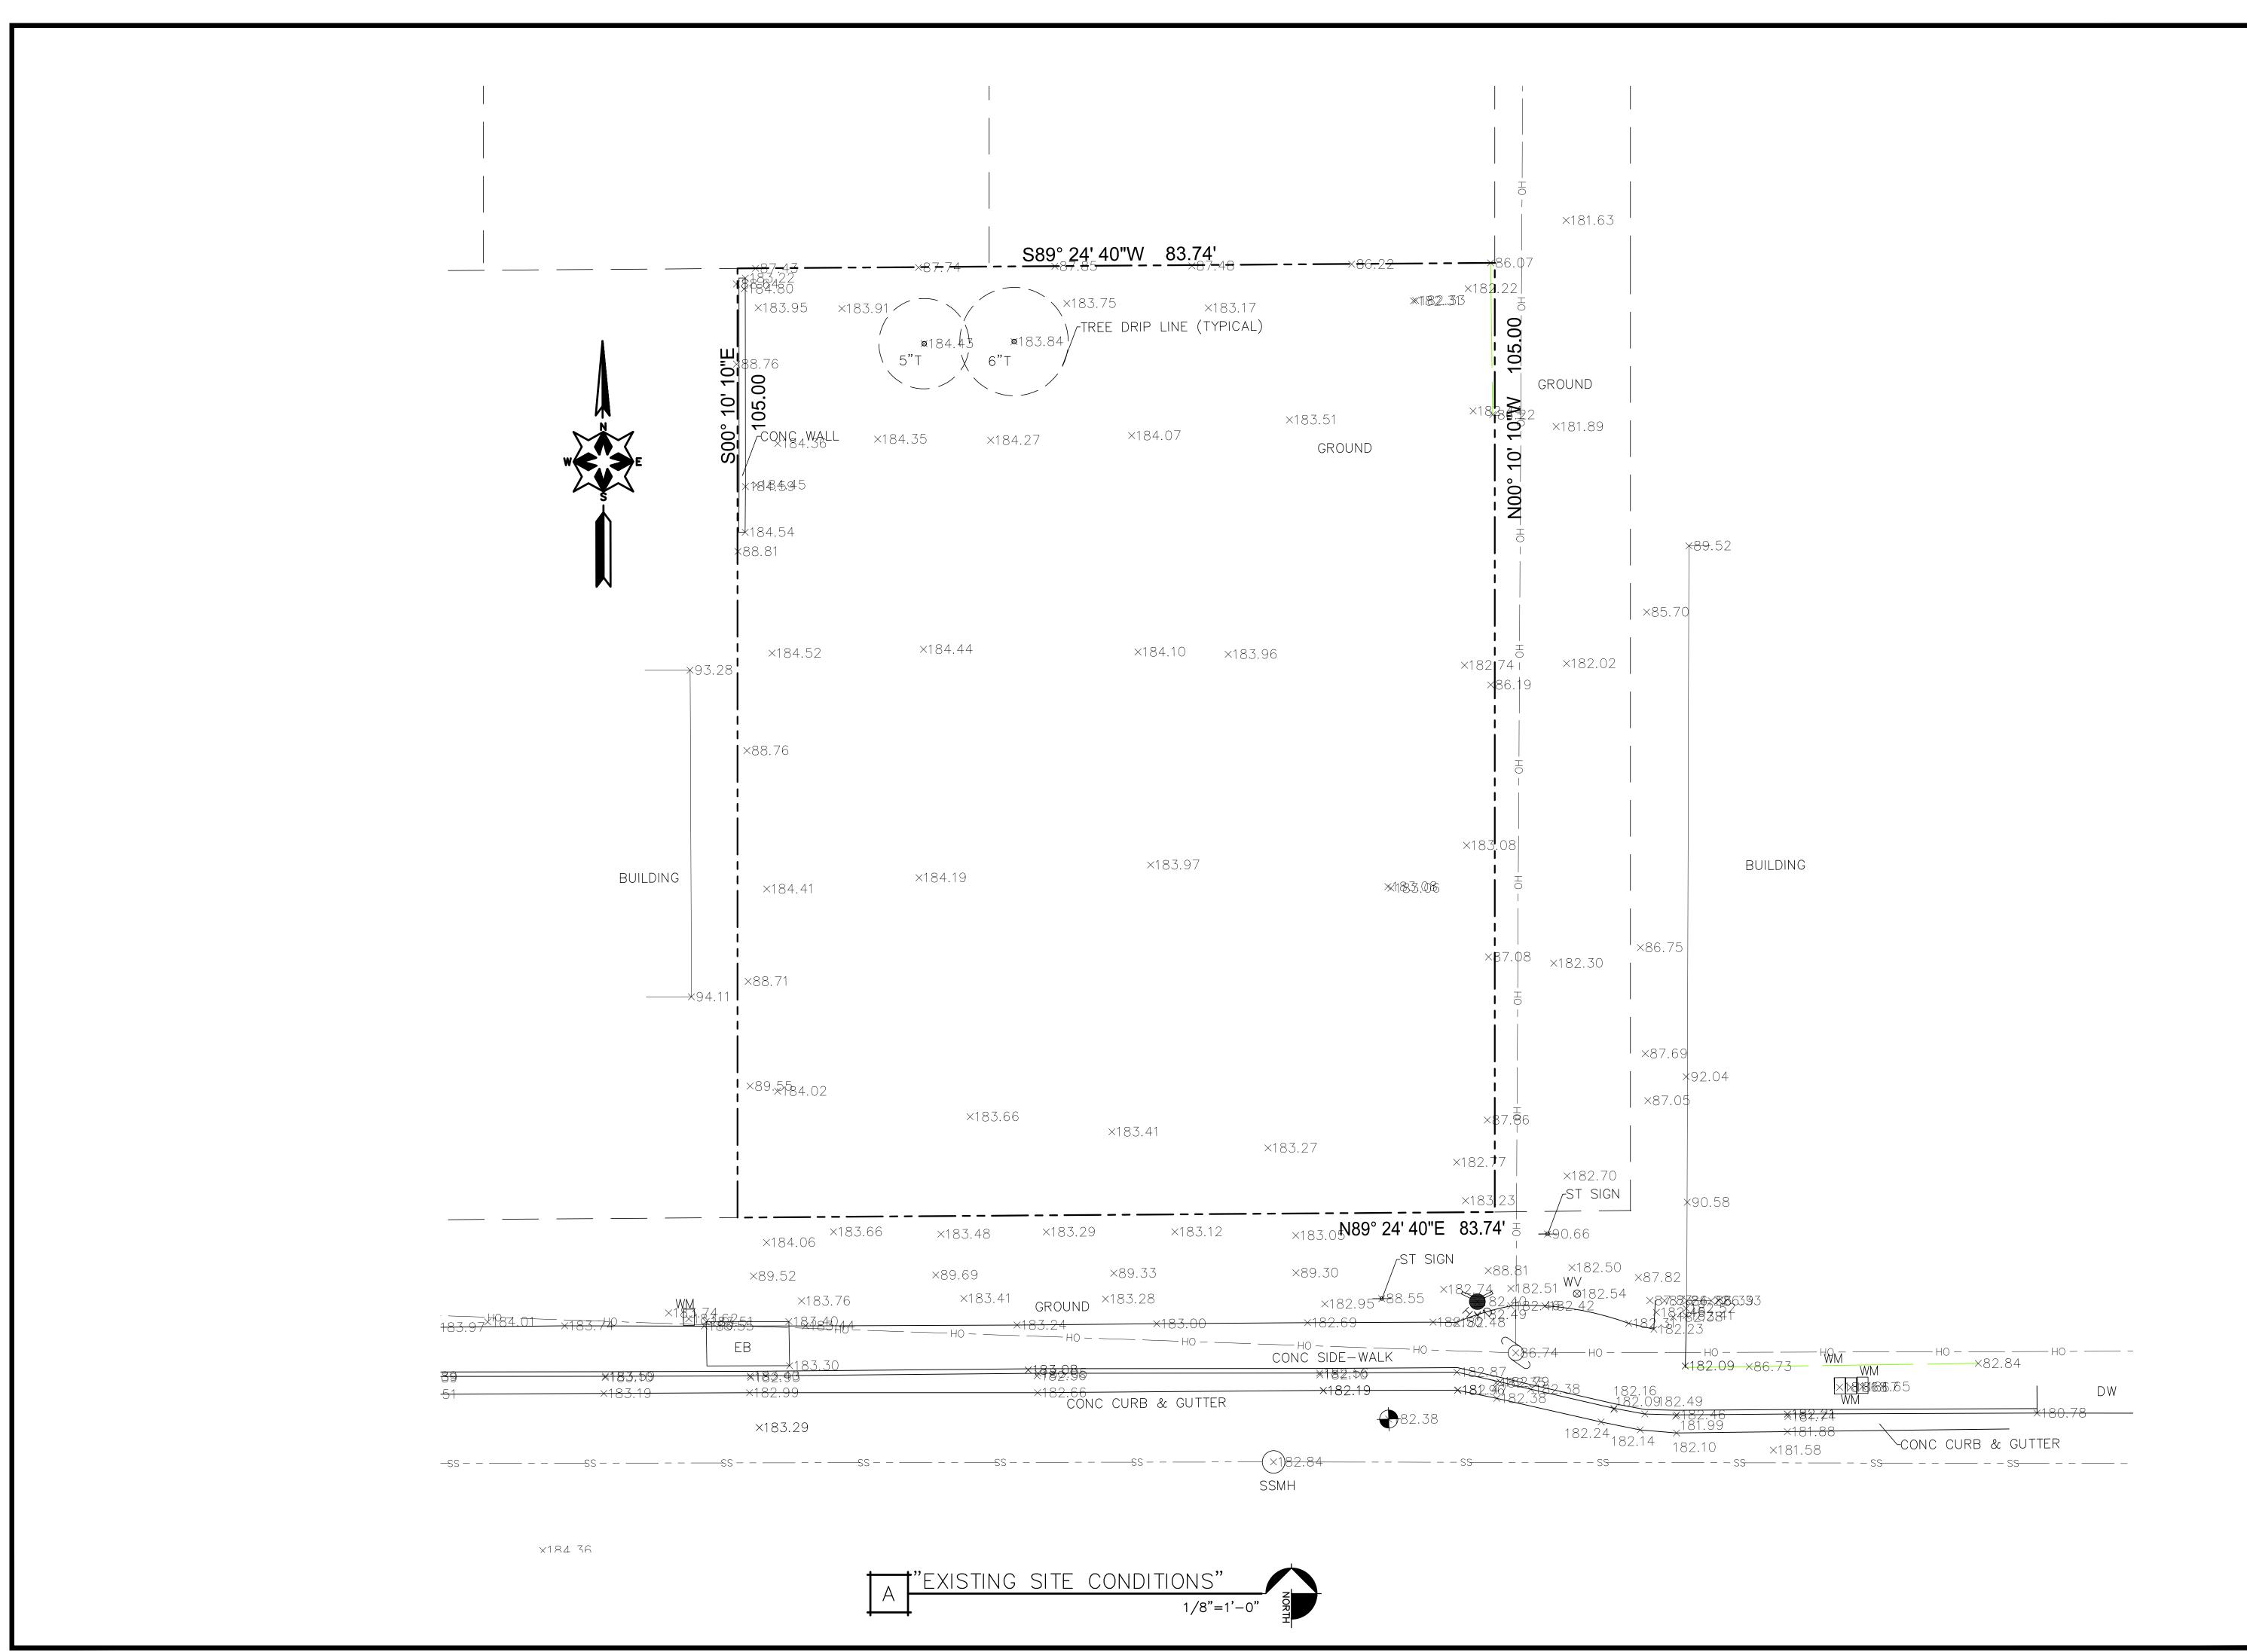

Desi



AKS BUILDING DESIGN

AMAN DULAY
(Principal Designer)

Tel: 408.375.8351

Fax: 650.941.8755

aksdesign@gmail.com

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Project:
(2) NEW TWO STORY HOME

E. HOMESTEAD RD.
SUNNYVALE, CA 94087
APN: 309-46-053

Owner:

12561 PASEO CERRO GROUP 2088 E ELENDA DR. CUPERTINO, CA 95014


No.	Submittals	Date
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3	PLANNING	9/19/2018
4	PLANNING	11/14/2018

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Project:	E HOMESTEAD RD.
Scale:	As Shown
Date:	11/14/18
Sheet Title:	

"EXISTING SITE CONDITIONS"

Sheet N

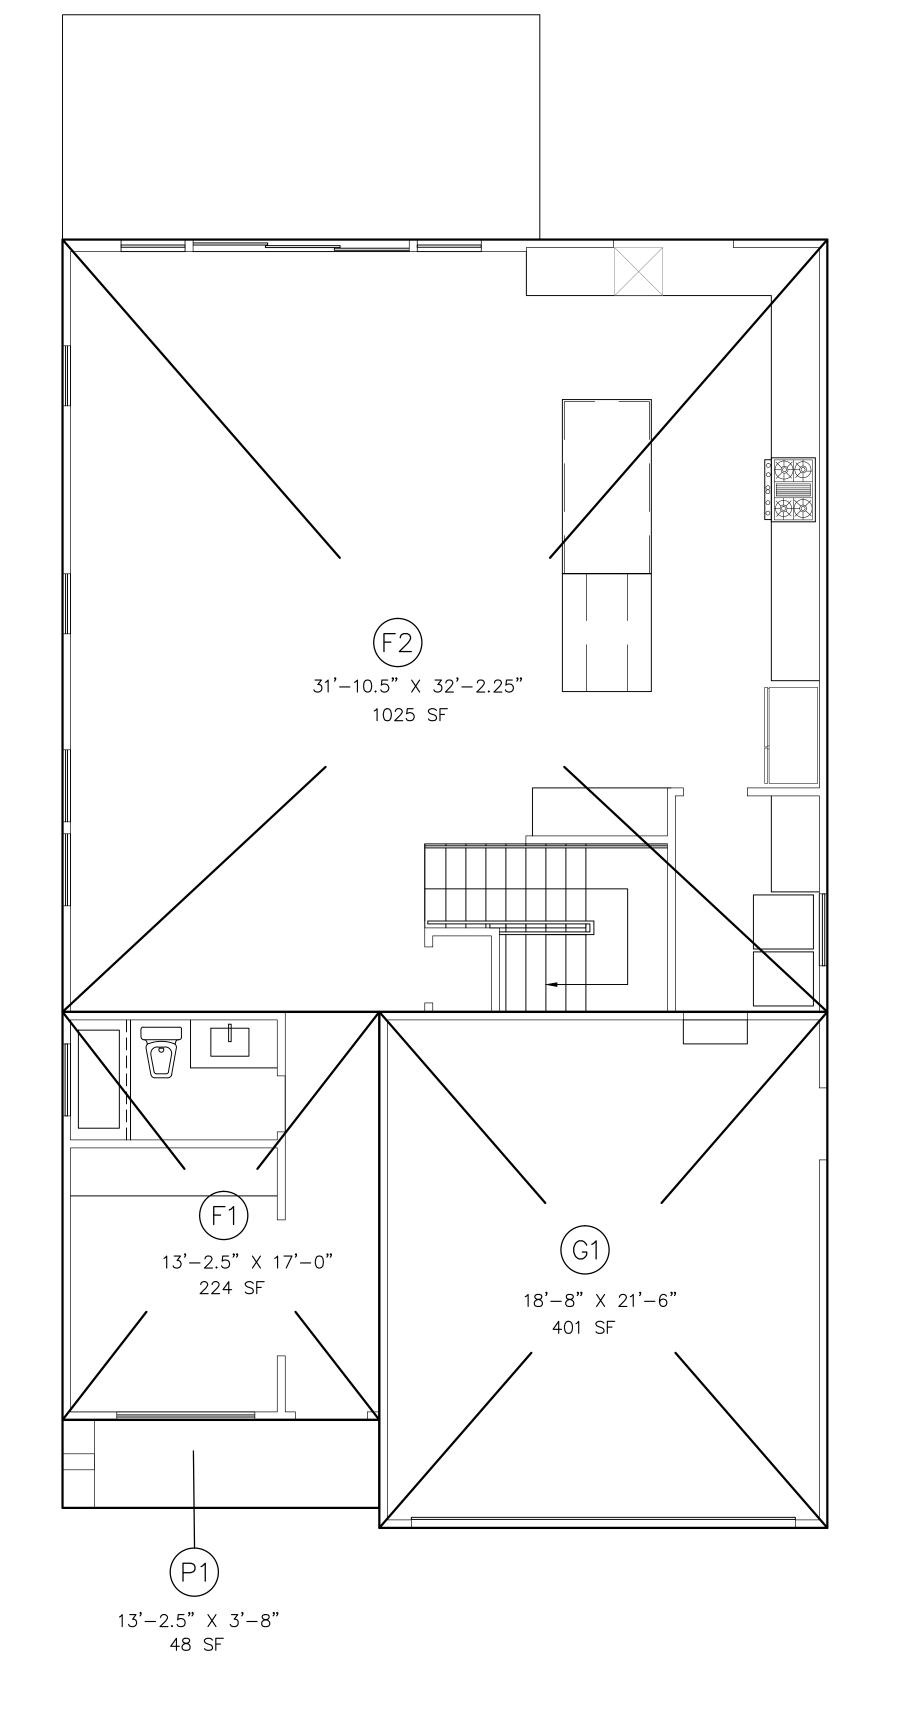


"FIRST FLOOR AREA CALCS."

PLAN A-1

G1	18'-8" X 21'-6"	401 SF
ТО	TAL GARAGE AREA	401 SF
FIRST FLOOR LIVING A	REA	
F1	13'-2.5" X 17'-0"	224 SF
F2	31'-10.5" X 32'-2.25"	1025 SF
TOTAL IST FLR. LIVING AREA 1,249 SI		
SECOND FLOOR LIVING AREA		
S1	25'-10.5" X 22'-8"	586 SF
S2	11'-6.5" X 15'-1"	174 SF
S3	3'-0" X 3'-8"	11 SF
TOTAL 2ND	FLR. LIVING AREA	771 SF

2,421 SF TOTAL AREA: 48 SF

FRONT PORCH:

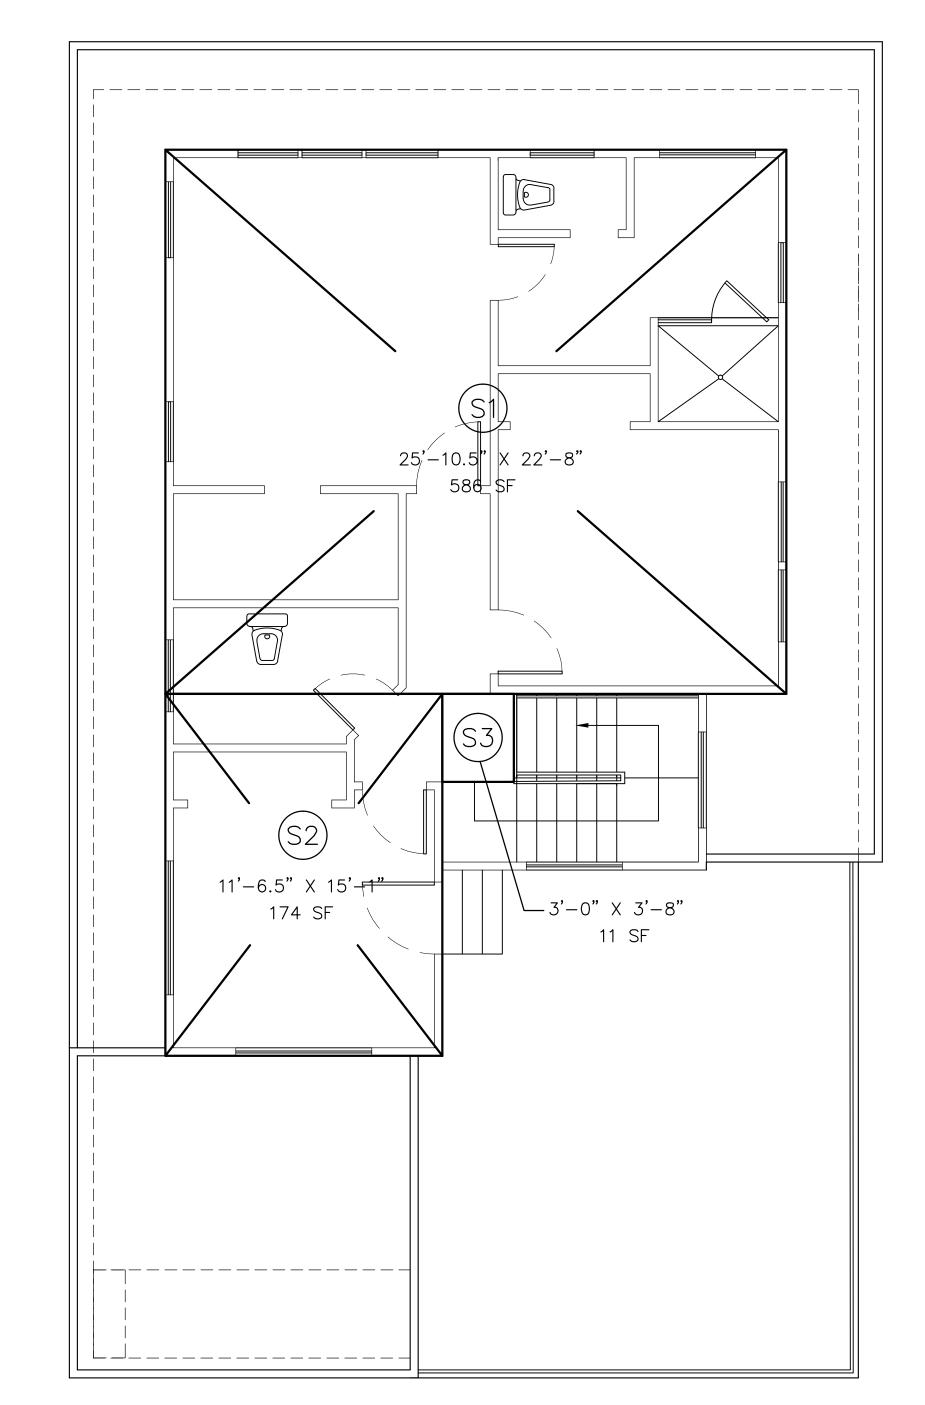

"SECOND FLOOR AREA CALCS." PLAN A-1

S BUILDING DESIGN

AMAN DULAY (Principal Designer) Tel: 408.375.8351 Fax: 650.941.8755 aksdesign@gmail.com

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Owner:

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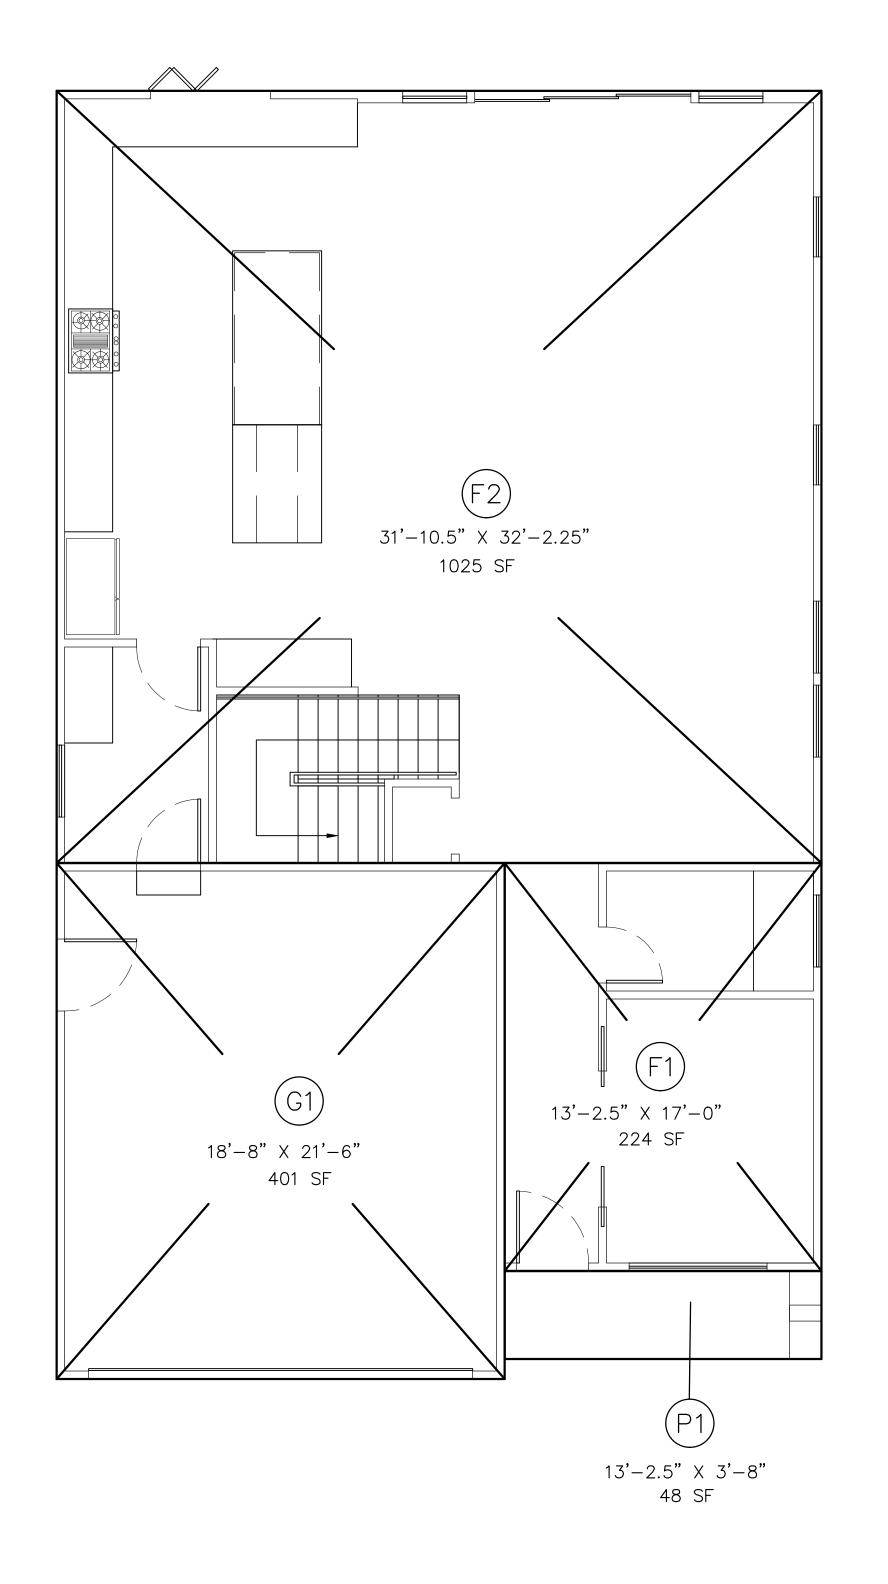
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Project:	E HOMESTEAD RD.
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Date:	11/14/18
Sheet Title	


"FLOOR AREA CALCULATIONS" PLAN A1

Sheet No:



G1	18'-8" X 21'-6"	401 SF
G1	10 0 % 21 0	101 01
ТО	TAL GARAGE AREA	401 SF
FIRST FLOOR LIVING A	REA	
F1	13'-2.5" X 17'-0"	224 SF
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S2	11'-6.5" X 15'-1"	174 SF
S3	3'-0" X 3'-8"	11 SF
	FLR. LIVING AREA	771 SF

TOTAL AREA:	2,421 SF
FRONT PORCH:	48 SF

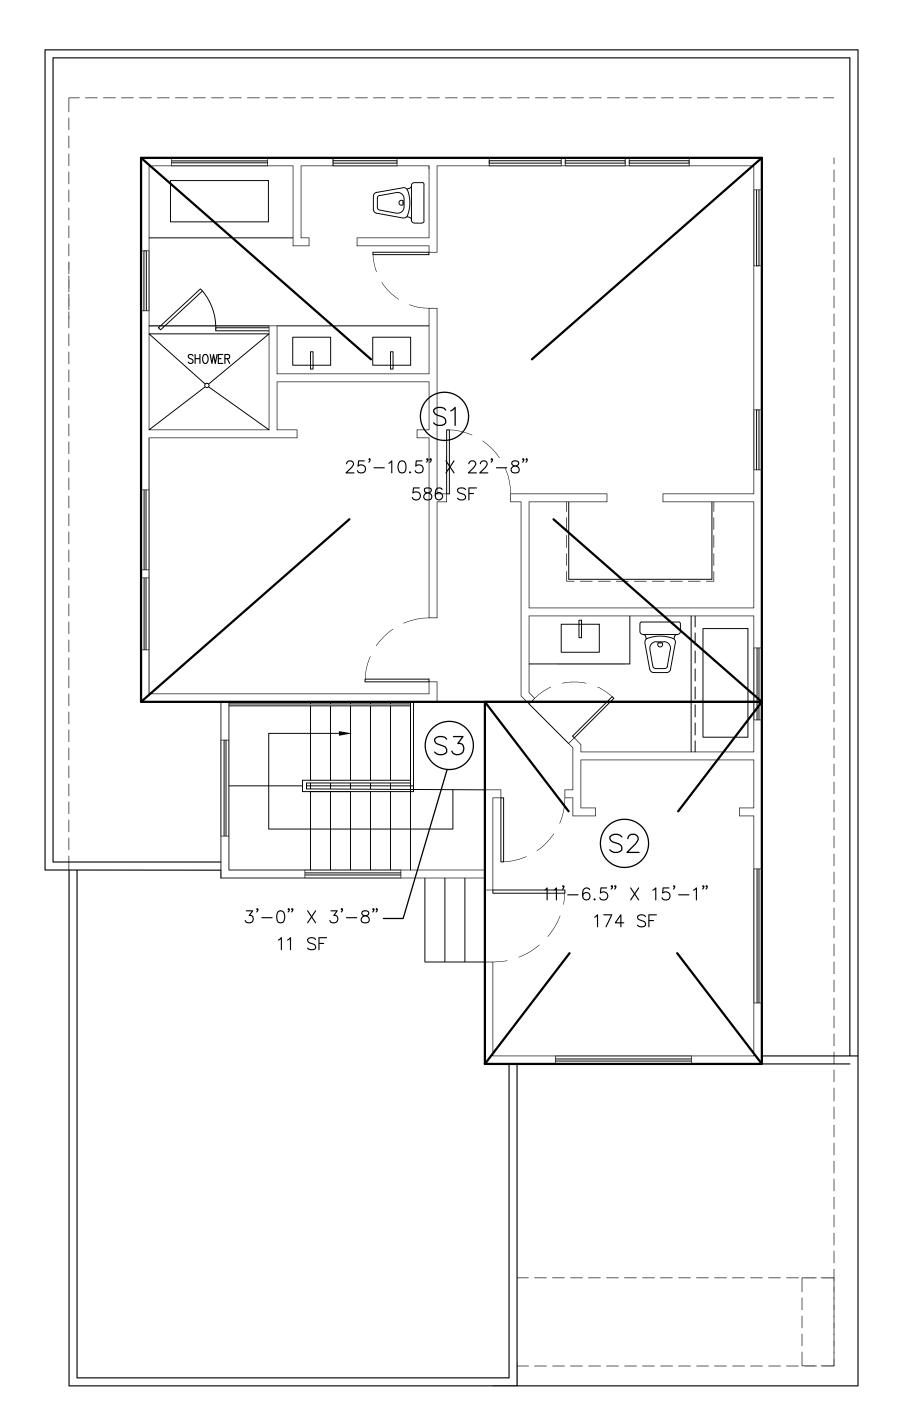



"SECOND FLOOR AREA CALCS."

PLAN A-2

1/4"=1'-0"

Designer:

AKS BUILDING DESIGN

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(Principal Designer)
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SUNNYVALE, CA 94087
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12561 PASEO CERRO GROUP

2088 E ELENDA DR.

CUPERTINO, CA 95014

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4	PLANNING	11/14/2018

	No.	Revision/Issue	Date
	1		
1			

Project:	E HOMESTEAD RD.
Scale:	As Shown
Date:	11/14/18
Sheet Title:	

"FLOOR AREA CALCULATIONS" PLAN A-2

Sheet No:



"FRONT VIEW"



"LEFT SIDE VIEW"



"RIGHT SIDE VIEW"

Designer:



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Project:

(2) NEW TWO STORY HOME

E. HOMESTEAD RD.

SUNNYVALE, CA 94087

APN: 309-46-053

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No.	Revision/Issue	Date
1		

Project:	E HOMESTEAD RD.
Scale:	As Shown
Date:	11/14/18
Sheet Title:	

"RENDERINGS"

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(2) NEW TWO STORY HOME


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2088 E ELENDA DR. CUPERTINO, CA 95014

SUNNYVALE, CA 94087

E. HOMESTEAD RD.

APN: 309-46-053

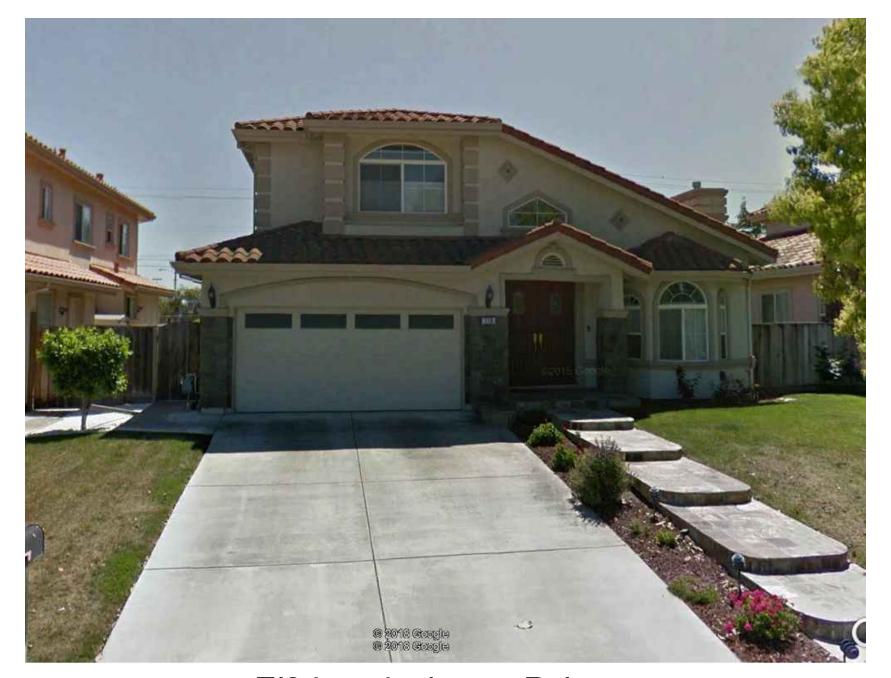

718 Londonberry Drive (Single Family Home) FAR: 49.6% BUILT AREA: 2,777 SF



SITE SURROUNDINGS

ARRESTRA

(Single Family Home)

722 Londonberry Drive

FAR: 55.4% BUILT AREA: 2,847 SF


724 E. Homestead Road


(Multi-Family)



315 E. Homestead Road

(Single Family Home)

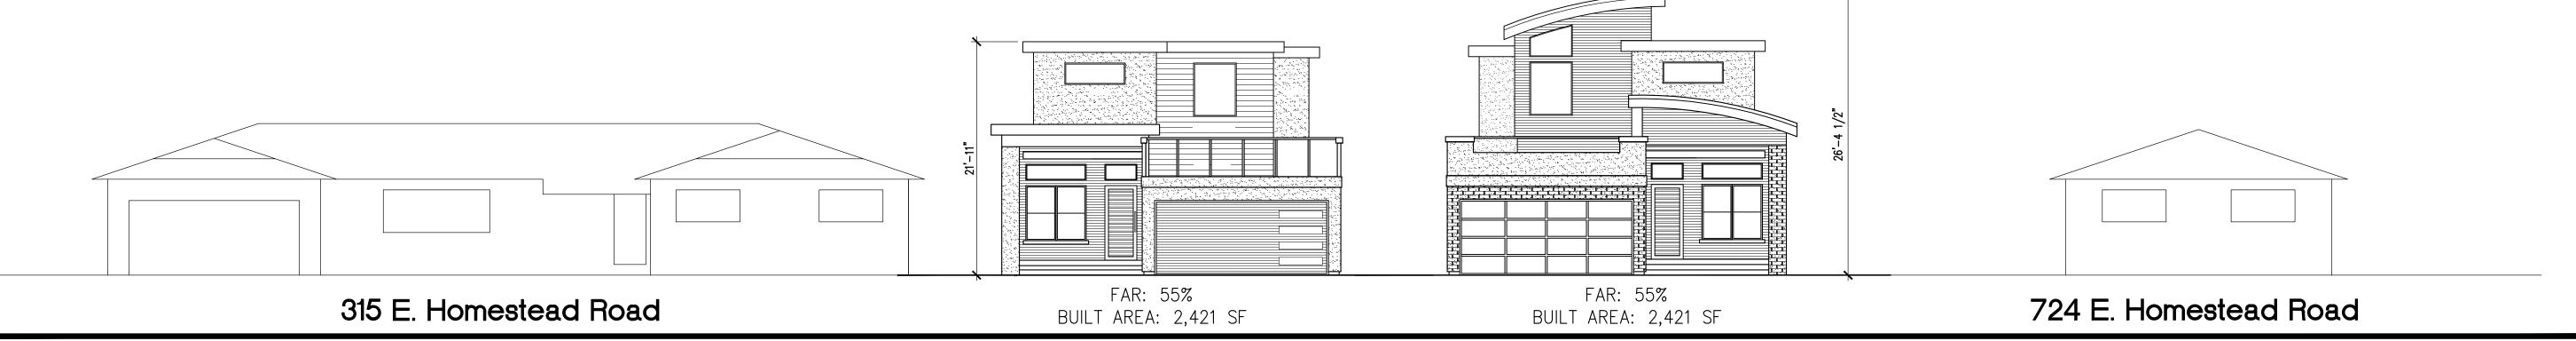

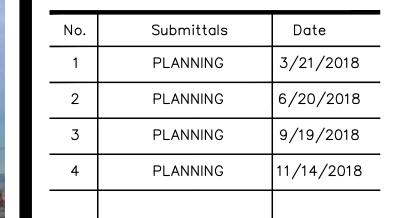


!	No.	Revision/Issue	Date
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Project:	E HOMESTEAD RD.
Scale:	As Shown
Date:	11/14/18

Sheet Title:

"STREET SCAPE"

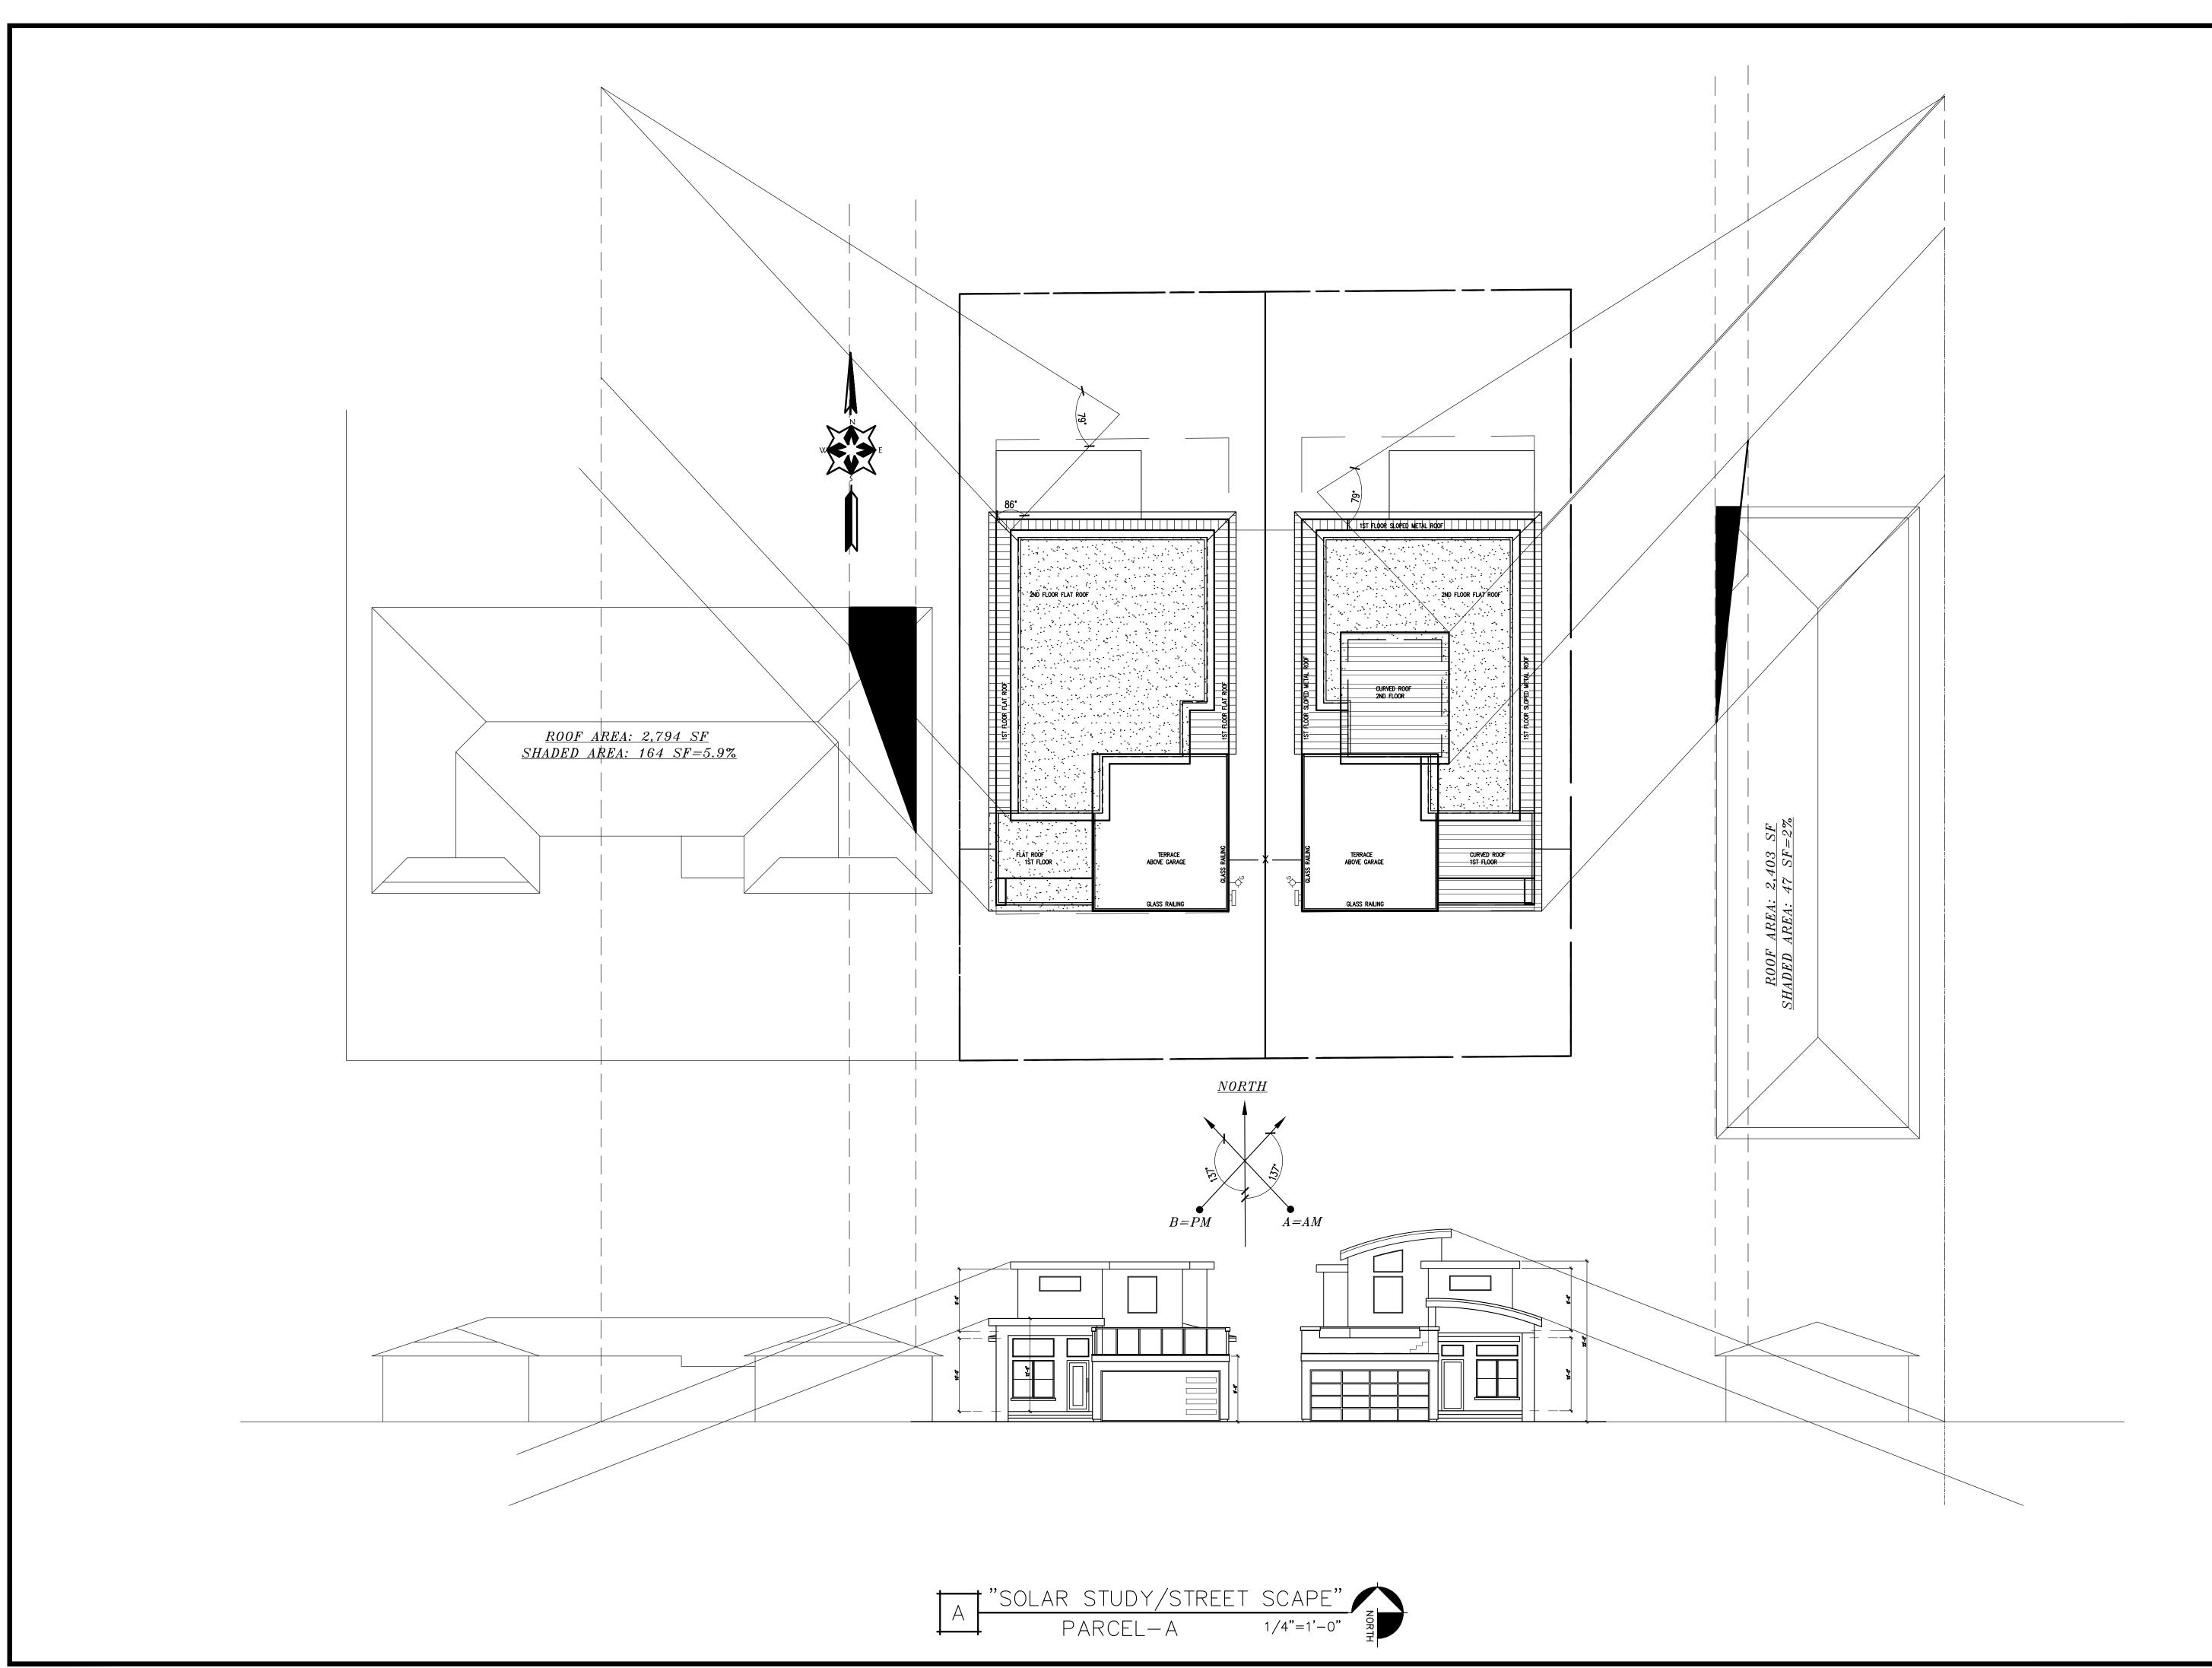

D - -:



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SUNNYVALE, CA 94087
APN: 309-46-053

Owner:

12561 PASEO CERRO GROUP 2088 E ELENDA DR. CUPERTINO, CA 95014

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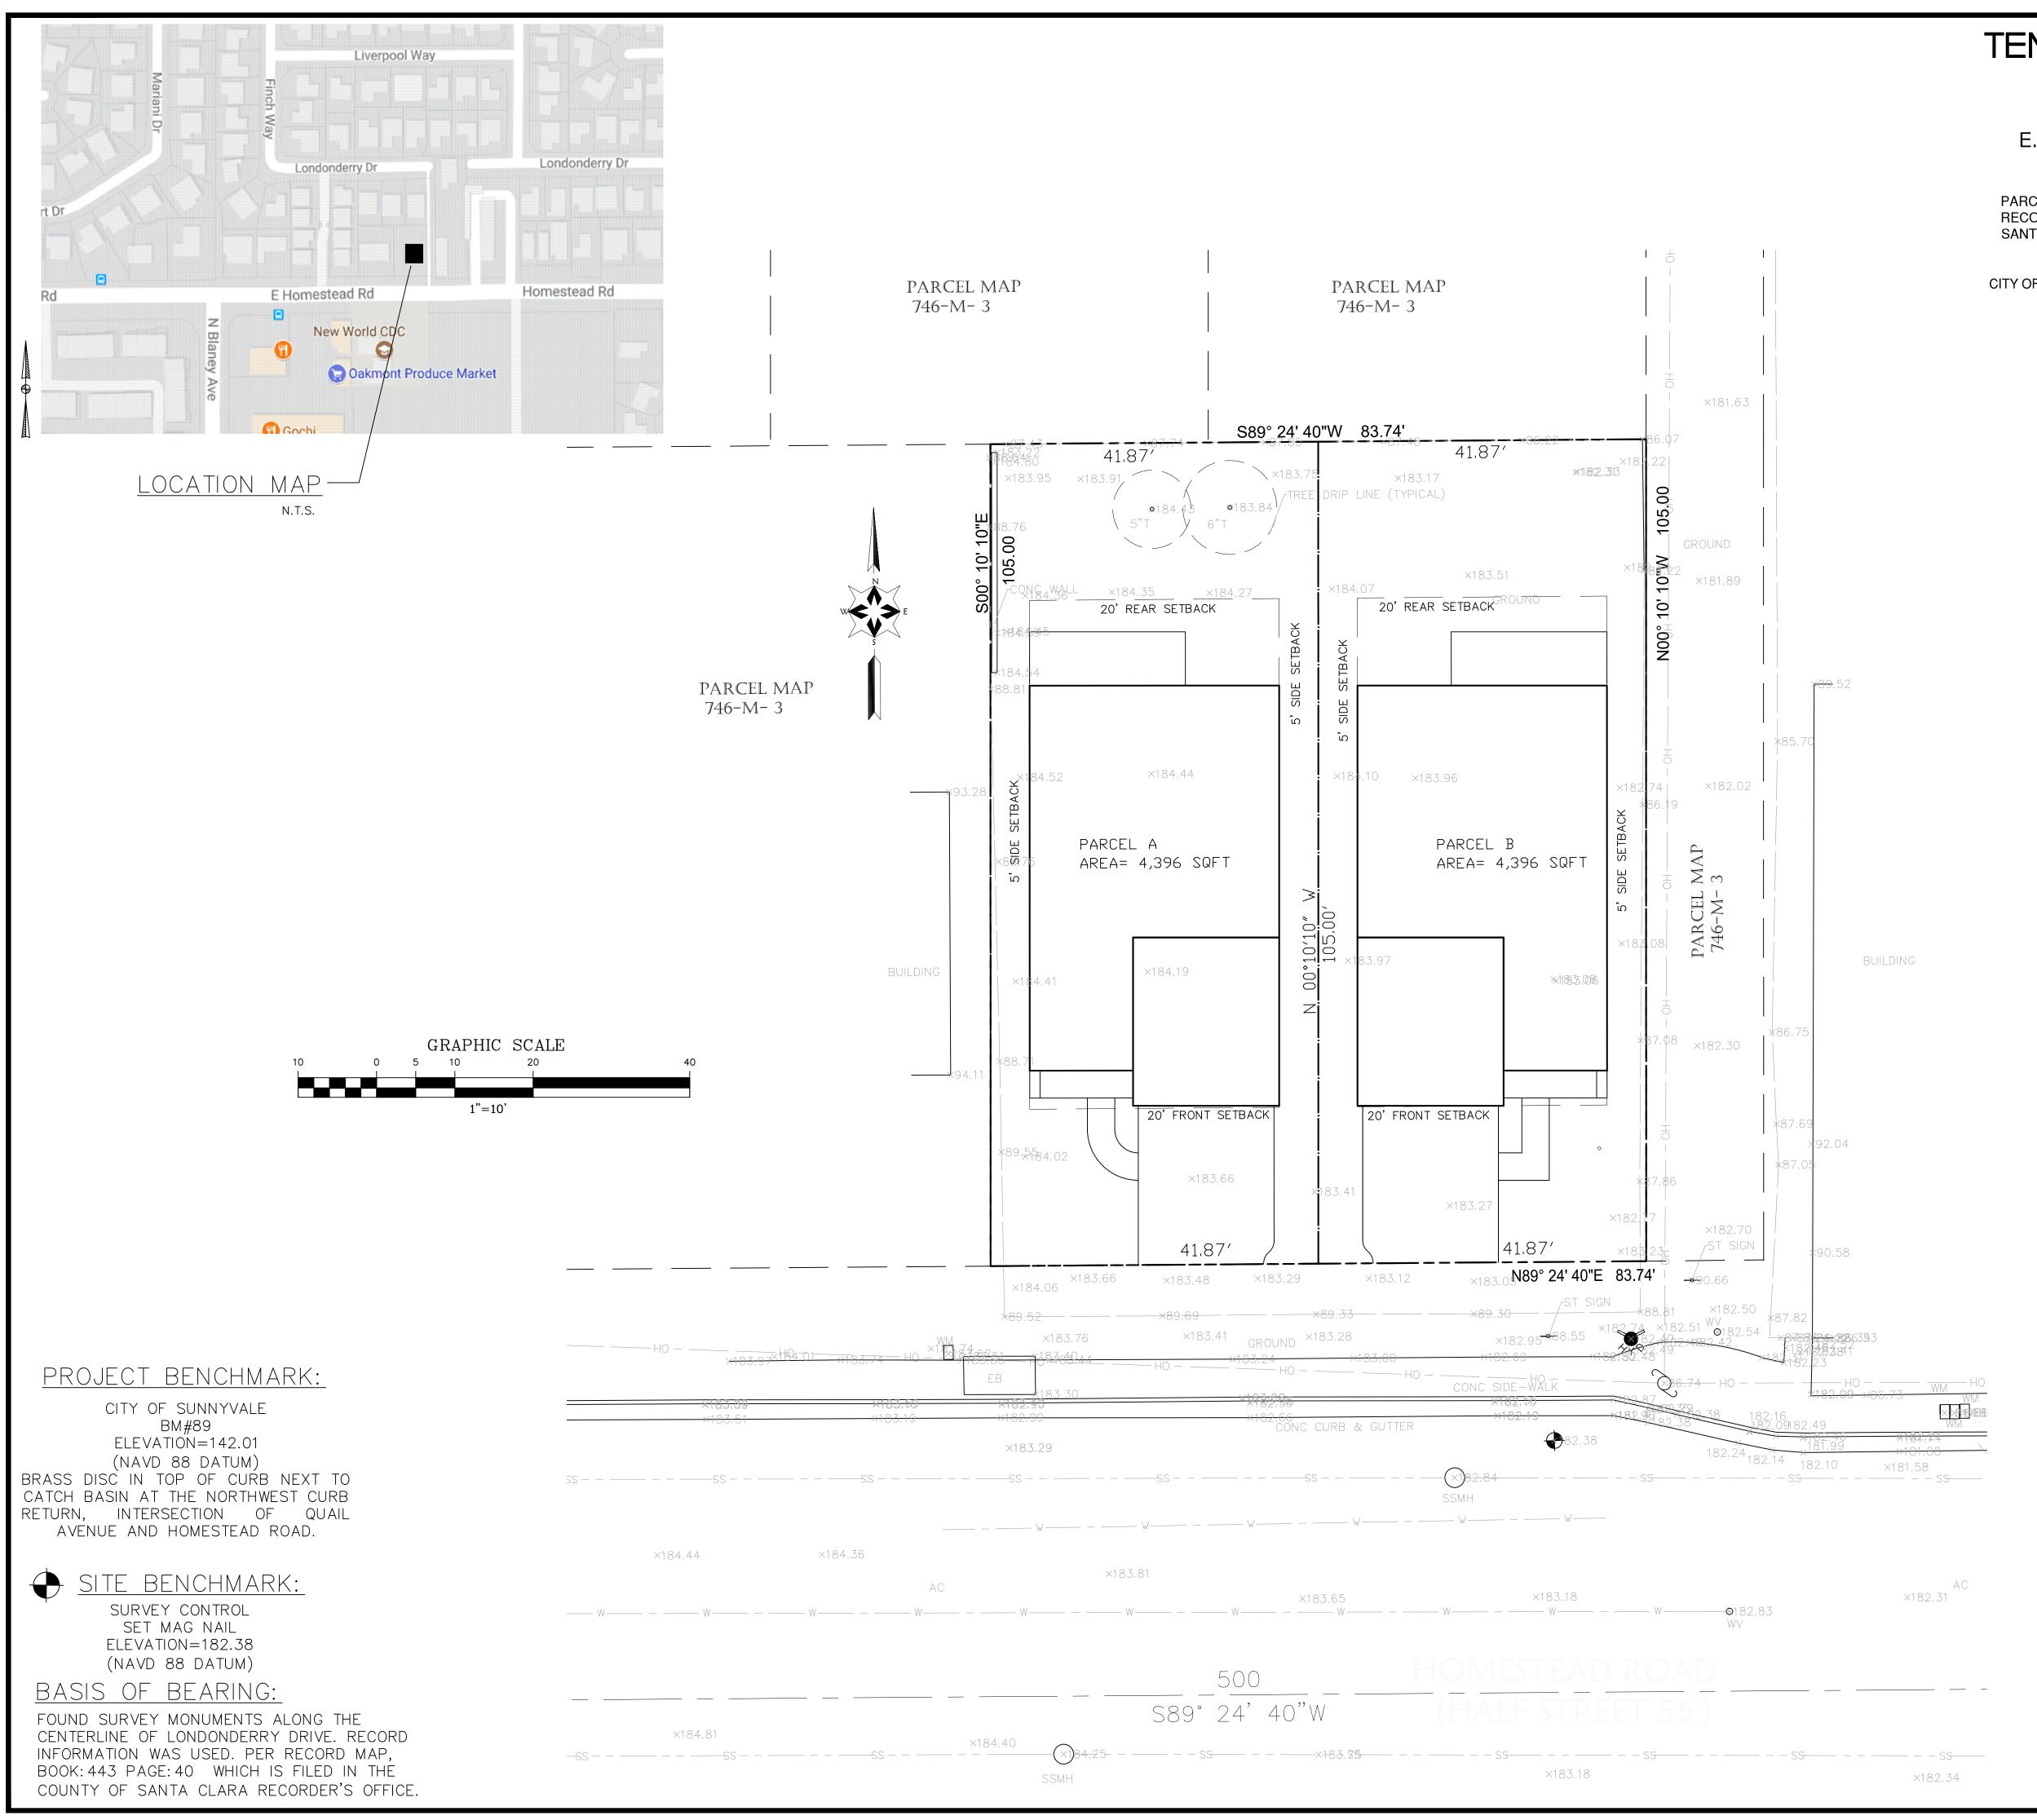
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Project:	E HOMESTEAD RD.
Scale:	As Shown
Date:	11/14/18

Sheet Title:

"SOLAR STUDY"

Sheet No:



TENTATIVE PARCEL MAP

TWO (2) LOT SUBDIVISION
CONSISTING OF ONE (1) SHEET
E. HOMESTEAD RD., SUNNYVALE, CA
APN 309-46-053

PARCEL"B", AS SHOWN ON THAT CERTAIN PARCEL MAP, RECORDED IN BOOK "443" OF MAPS, AT PAGE 40, RECORDS OF SANTA CLARA COUNTY

LYING ENTIRELY WITHIN THE

CITY OF SUNNYVALE, COUNTY OF SANTA CLARA, CALIFORNIA

NOVEMBER 2018

SMP ENGINEERS

1534 CAROB LANE LOS ALTOS, CA 94024

LOT AREA TABLE

PROPOSED PARCELS	SQ. FT.	ACRES
PARCEL A	4⊠9□	0.101
PARCEL B	4⊠9□	0.101
TOTAL (EXISTING LOT)	8,792	0.202

LEGEND AND ABBREVIATIONS

	STREET CENTER LINE
	DISTINCTIVE BORDER LINE
	PROPOSED LOT LINE
	OTHER PROPERTY LINES
	OTHER PROPERTY LINES

GENERAL NOTES & STATEMENTS

1. OWNERS AND DEVELOPERS:

12561 PASEO CERRO GROUP 2088E ELENDA DR. CUPERTINO, CA 95014

2. APPLICANT: SAME AS ABOVE.

3. EXISTING ZONING: R2

4. EXISTING APN: 309-46-053

5. EXISTING USE: VACANT LOT

6. PROPOSED USE: 2 SINGLE FAMILY HOMES

7. EXISTING BUILDING: NONE

8. GENERAL PLAN: LOW-MEDIUM DENSITY

9. STREETS: ALL PROPOSED STREET MODIFICATIONS WILL BE DONE TO THE SATISFACTION OF THE DIRECTOR OF PUBLIC WORKS

10. EXISTING USE OF ADJACENT PROPERTIES: RESIDENTIAL, SINGLE FAMILY

11. GAS: PACIFIC GAS AND ELECTRIC

12. WATER: CITY OF SUNNYVALE

13. FIRE PROTECTION: CITY OF SUNNYVALE

14. STORM/SANITARY SEWER: CITY OF SUNNYVALE

15. POWER AND GAS: PACIFIC GAS AND ELECTRIC

16. TELEPHONE/CABLE: AT&T/COMCAST

17. STREET TREES: STREET TREE(S) TO BE PLANTED PER CITY OF SUNNYVALE DIRECTION.

18. BUILDING FOOTPRINTS SHOWN ARE CONCEPTUAL AND ARE SUBJECT TO CHANGE IN FINAL CONSTRUCTION PLANS.

19. EXISTING WELL: NONE

SMP

ENGINEERS CIVIL ENGINEERS

1534 CAROB LANE LOS ALTOS, CA 94024 TEL: (650) 941–8055 FAX: (650) 941–8755

OWNER/APPLICANT:
12561 PASEO CERRO GROUP
20883 ELENDA DR
CUPERTINO CA 95014

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APN: 309-46-053 HOMESTEAD RD. SUNNYVALE, CA 94

Revisions:

Date: 11/14/2018 Scale: 1"=10"

Prepared by:
A.D.
Checked by:

Job #: 217157


> 1 TM-1

	ABBREVIATIONS				
	DESCRIPTION		DESCRIPTION		
AB AD BBW LGCCCDDDELCEU, FGHLCCBUPDN JB	CENTERLINE SWALE CLEANOUT CONTROL POINT DRIVEWAY DROP INLET DETAIL ELECTRIC EDGE OF PAVEMENT ELEVATION EUCALYPTUS TREE	LP NOOB GEPPS VON HOS SS CHESS PY CONSTRUCTION OF SS SS CHESS PY CHESS PY CONSTRUCTION OF ST SS SS CHESS PY CH	LIP OF GUTTER LOW POINT MONUMENT NEW ORIGINAL GROUND PULL BOX PG&E VAULT PROPERTY LINE POWER POLE PLASTIC PERFORATED PIPE PUBLIC SERVICE EASEMENT POLYVINYL CHLORIDE RIGHT OF WAY REINFORCED CONCRETE PIPE STORM DRAIN STORM D		


GRADING AND DRAINAGE PLANS

TWO (2) LOT SUBDIVISION

TWO (2) NEW SINGLE FAMILY HOMES DEVELOPMENT E HOMESTEAD ROAD, SUNNYVALE, CA APN: 309-46-053

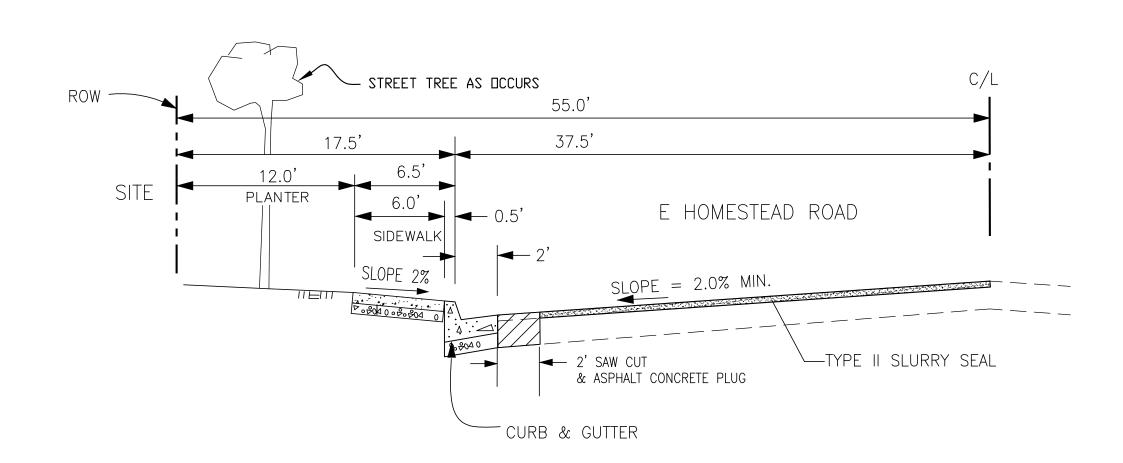

TYPICAL E HOMESTEAD ROAD HALF STREET CROSS SECTION

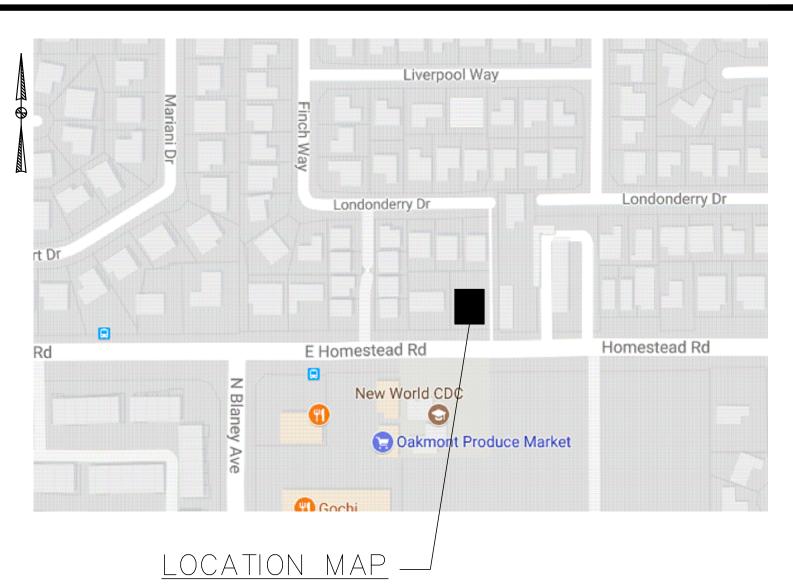

SHEET INDEX:

C-1	COVER SHEET/ NOTES
C-2	GRADING AND DRAINAGE PLAN
C-3	OFF-SITE IMPROVEMENT PLAN
C-4	DETAILS

EROSION CONTROL PLAN

PROJECT BENCHMARK:

CITY OF SUNNYVALE ELEVATION=142.01 AVENUE AND HOMESTEAD ROAD.

SITE BENCHMARK:

SURVEY CONTROL SET MAG NAIL ELEVATION=182.38 (NAVD 88 DATUM)

BASIS OF BEARING:

FOUND SURVEY MONUMENTS ALONG THE CENTERLINE OF LONDONDERRY DRIVE. RECORD INFORMATION WAS USED. PER RECORD MAP, BOOK: 443 PAGE: 40 WHICH IS FILED IN THE COUNTY OF SANTA CLARA RECORDER'S OFFICE.

DRAINAGE NOTES:

- 1. Surface water shall be directed away from all buildings into drainage swales, storm drain inlets.
- 2. All roof down spouts shall discharge onto splash blocks and directed away from
- 3. On site storm drain lines shall consist of solid PVC—SCH 40 minimum or better.
- 4. Storm drain inlets shall be precast concrete, Christy U23 type or equivalent.

SMP

CIVIL ENGINEERS

1534 CAROB LANE LOS ALTOS, CA 94024 TEL: (650) 941–8055 FAX: (650) 941–8755

OWNER/APPLICANT: 12561 PASEO CERRO GROUP 20883 ELENDA DR CUPERTINO CA 95014

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CIVIL ENGINEERS


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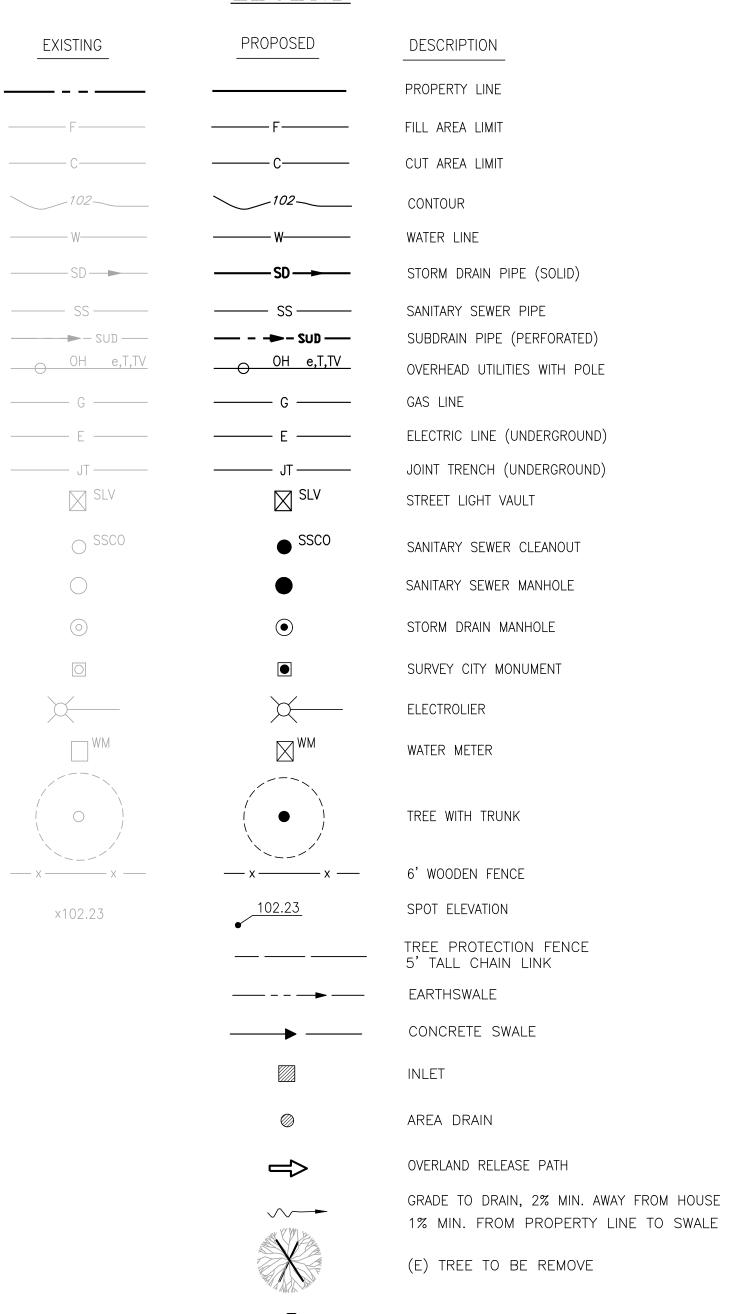
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Prepared by: Checked by: Job #:


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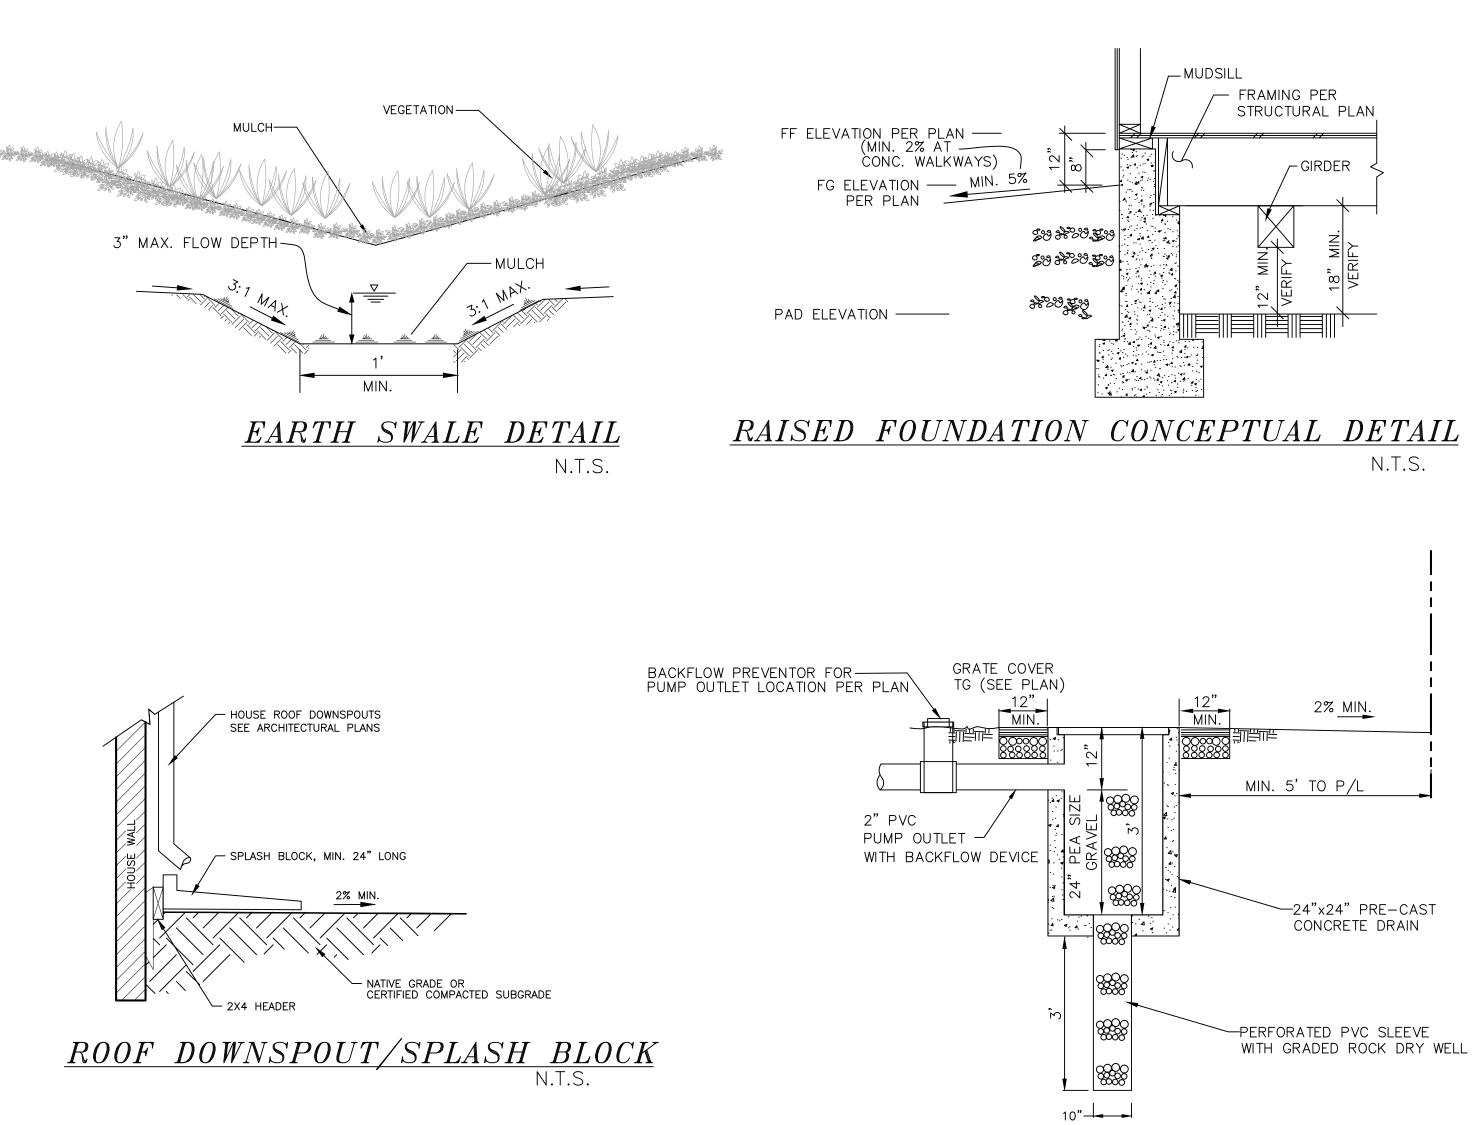
1 OF 5 C-1






DOWN-SPOUT

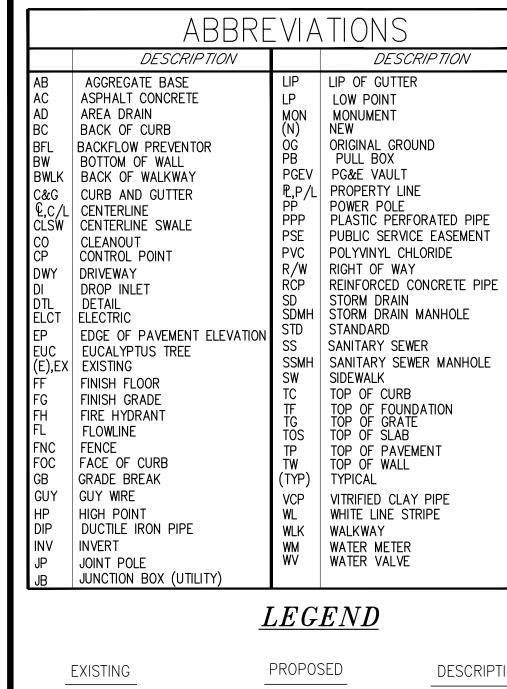

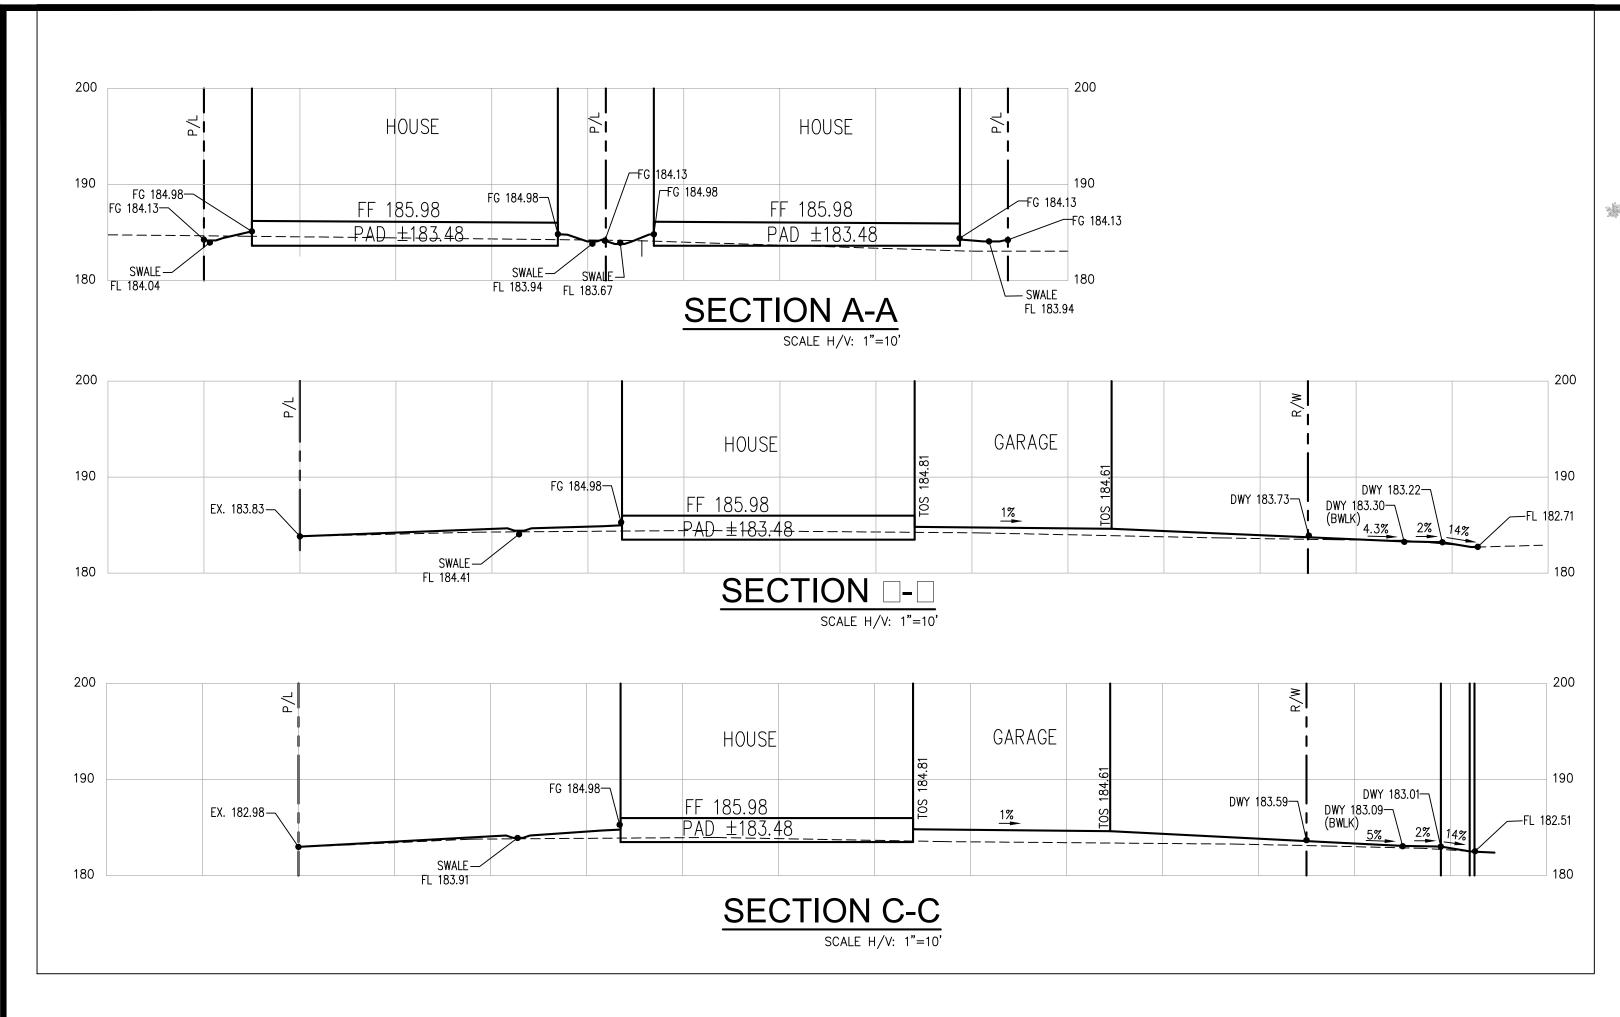

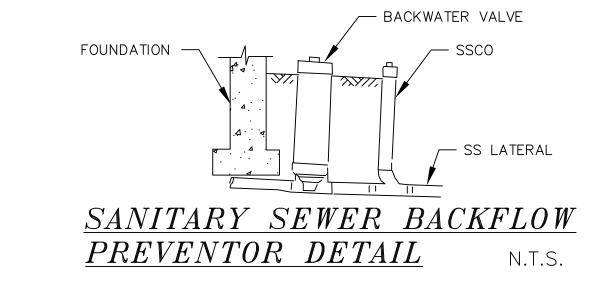

INLET WITH DRY WELL/ BUBBLIER
N.T.S.



ENGINEERS CIVIL ENGINEERS

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OWNER/APPLICANT: 12561 PASEO CERRO GROUP 20883 ELENDA DR CUPERTINO CA 95014

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WO (2) LOT SUBDIVISION

IEW SINGLE FAMILY HOMES DEVELOPMENT

TEAD RD. SUNNYVALE, CA 9408


APN: 309-46-053

Revisions:



Prepared by:
S.P.
Checked by:
S.R.
Job #:
217157

4 OF 5 C-4

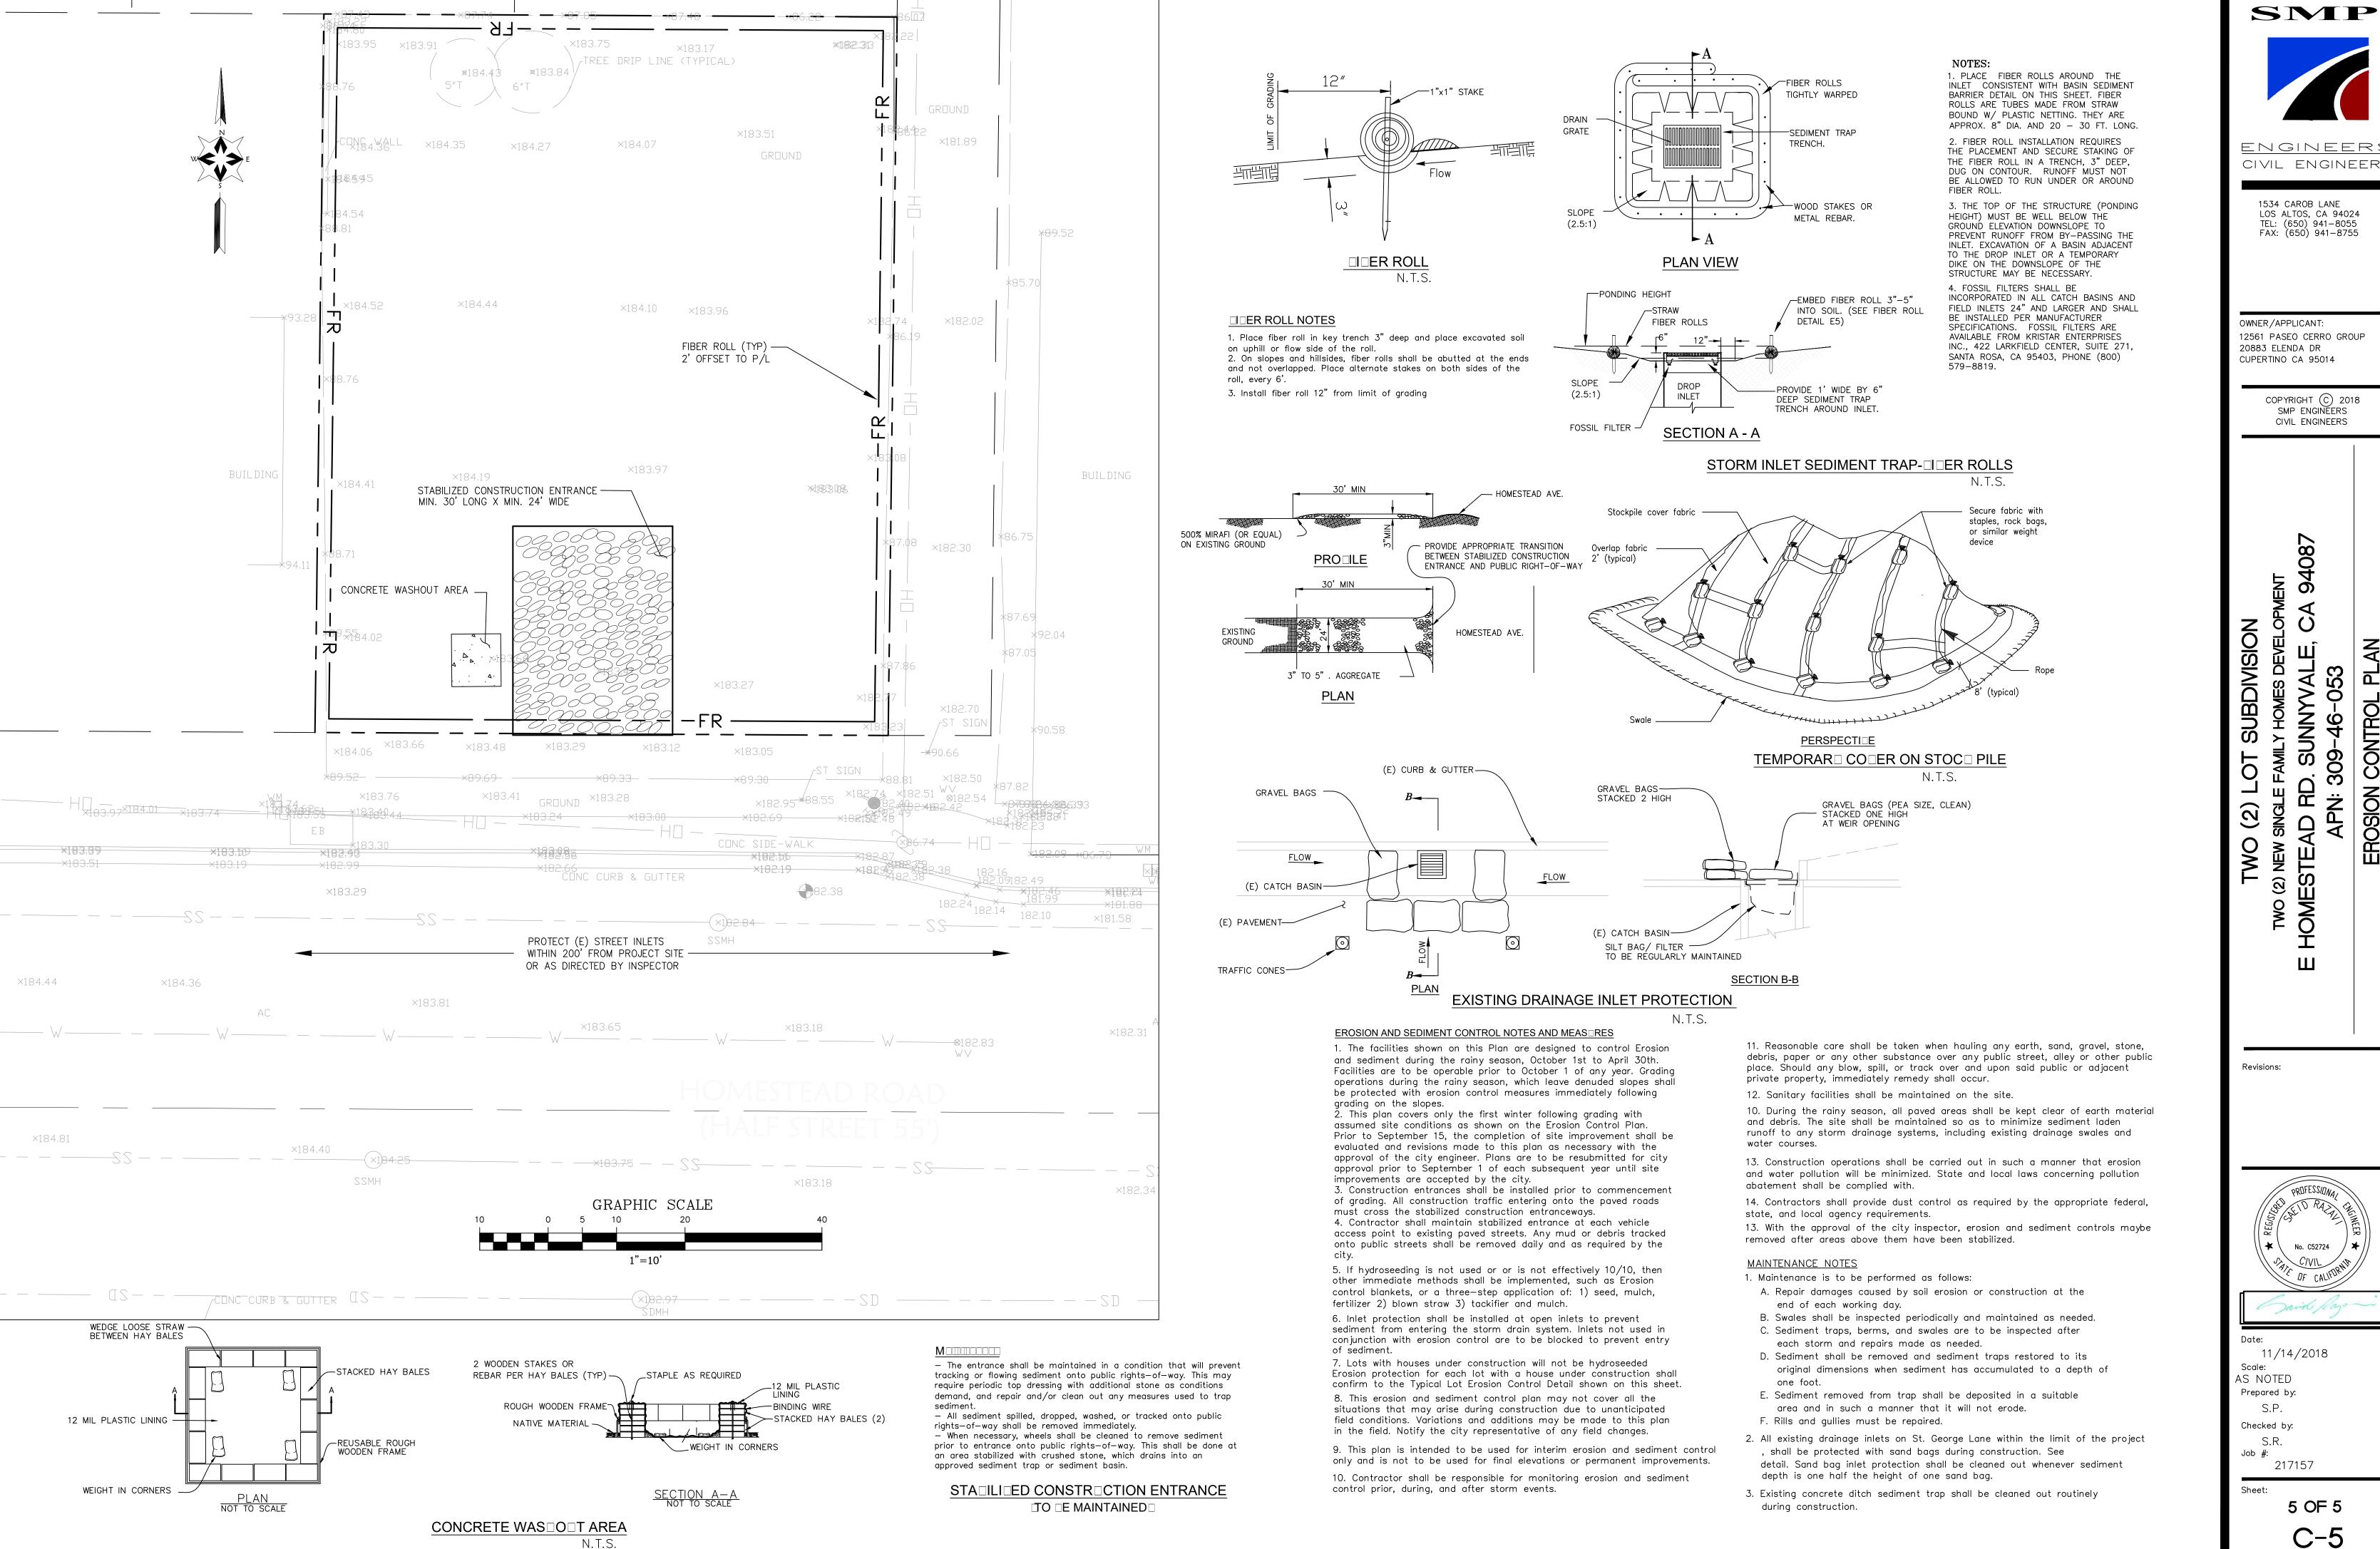


ENGINEERS CIVIL ENGINEERS

LOS ALTOS, CA 94024 TEL: (650) 941-8055 FAX: (650) 941-8755

12561 PASEO CERRO GROUP

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CIVIL ENGINEERS

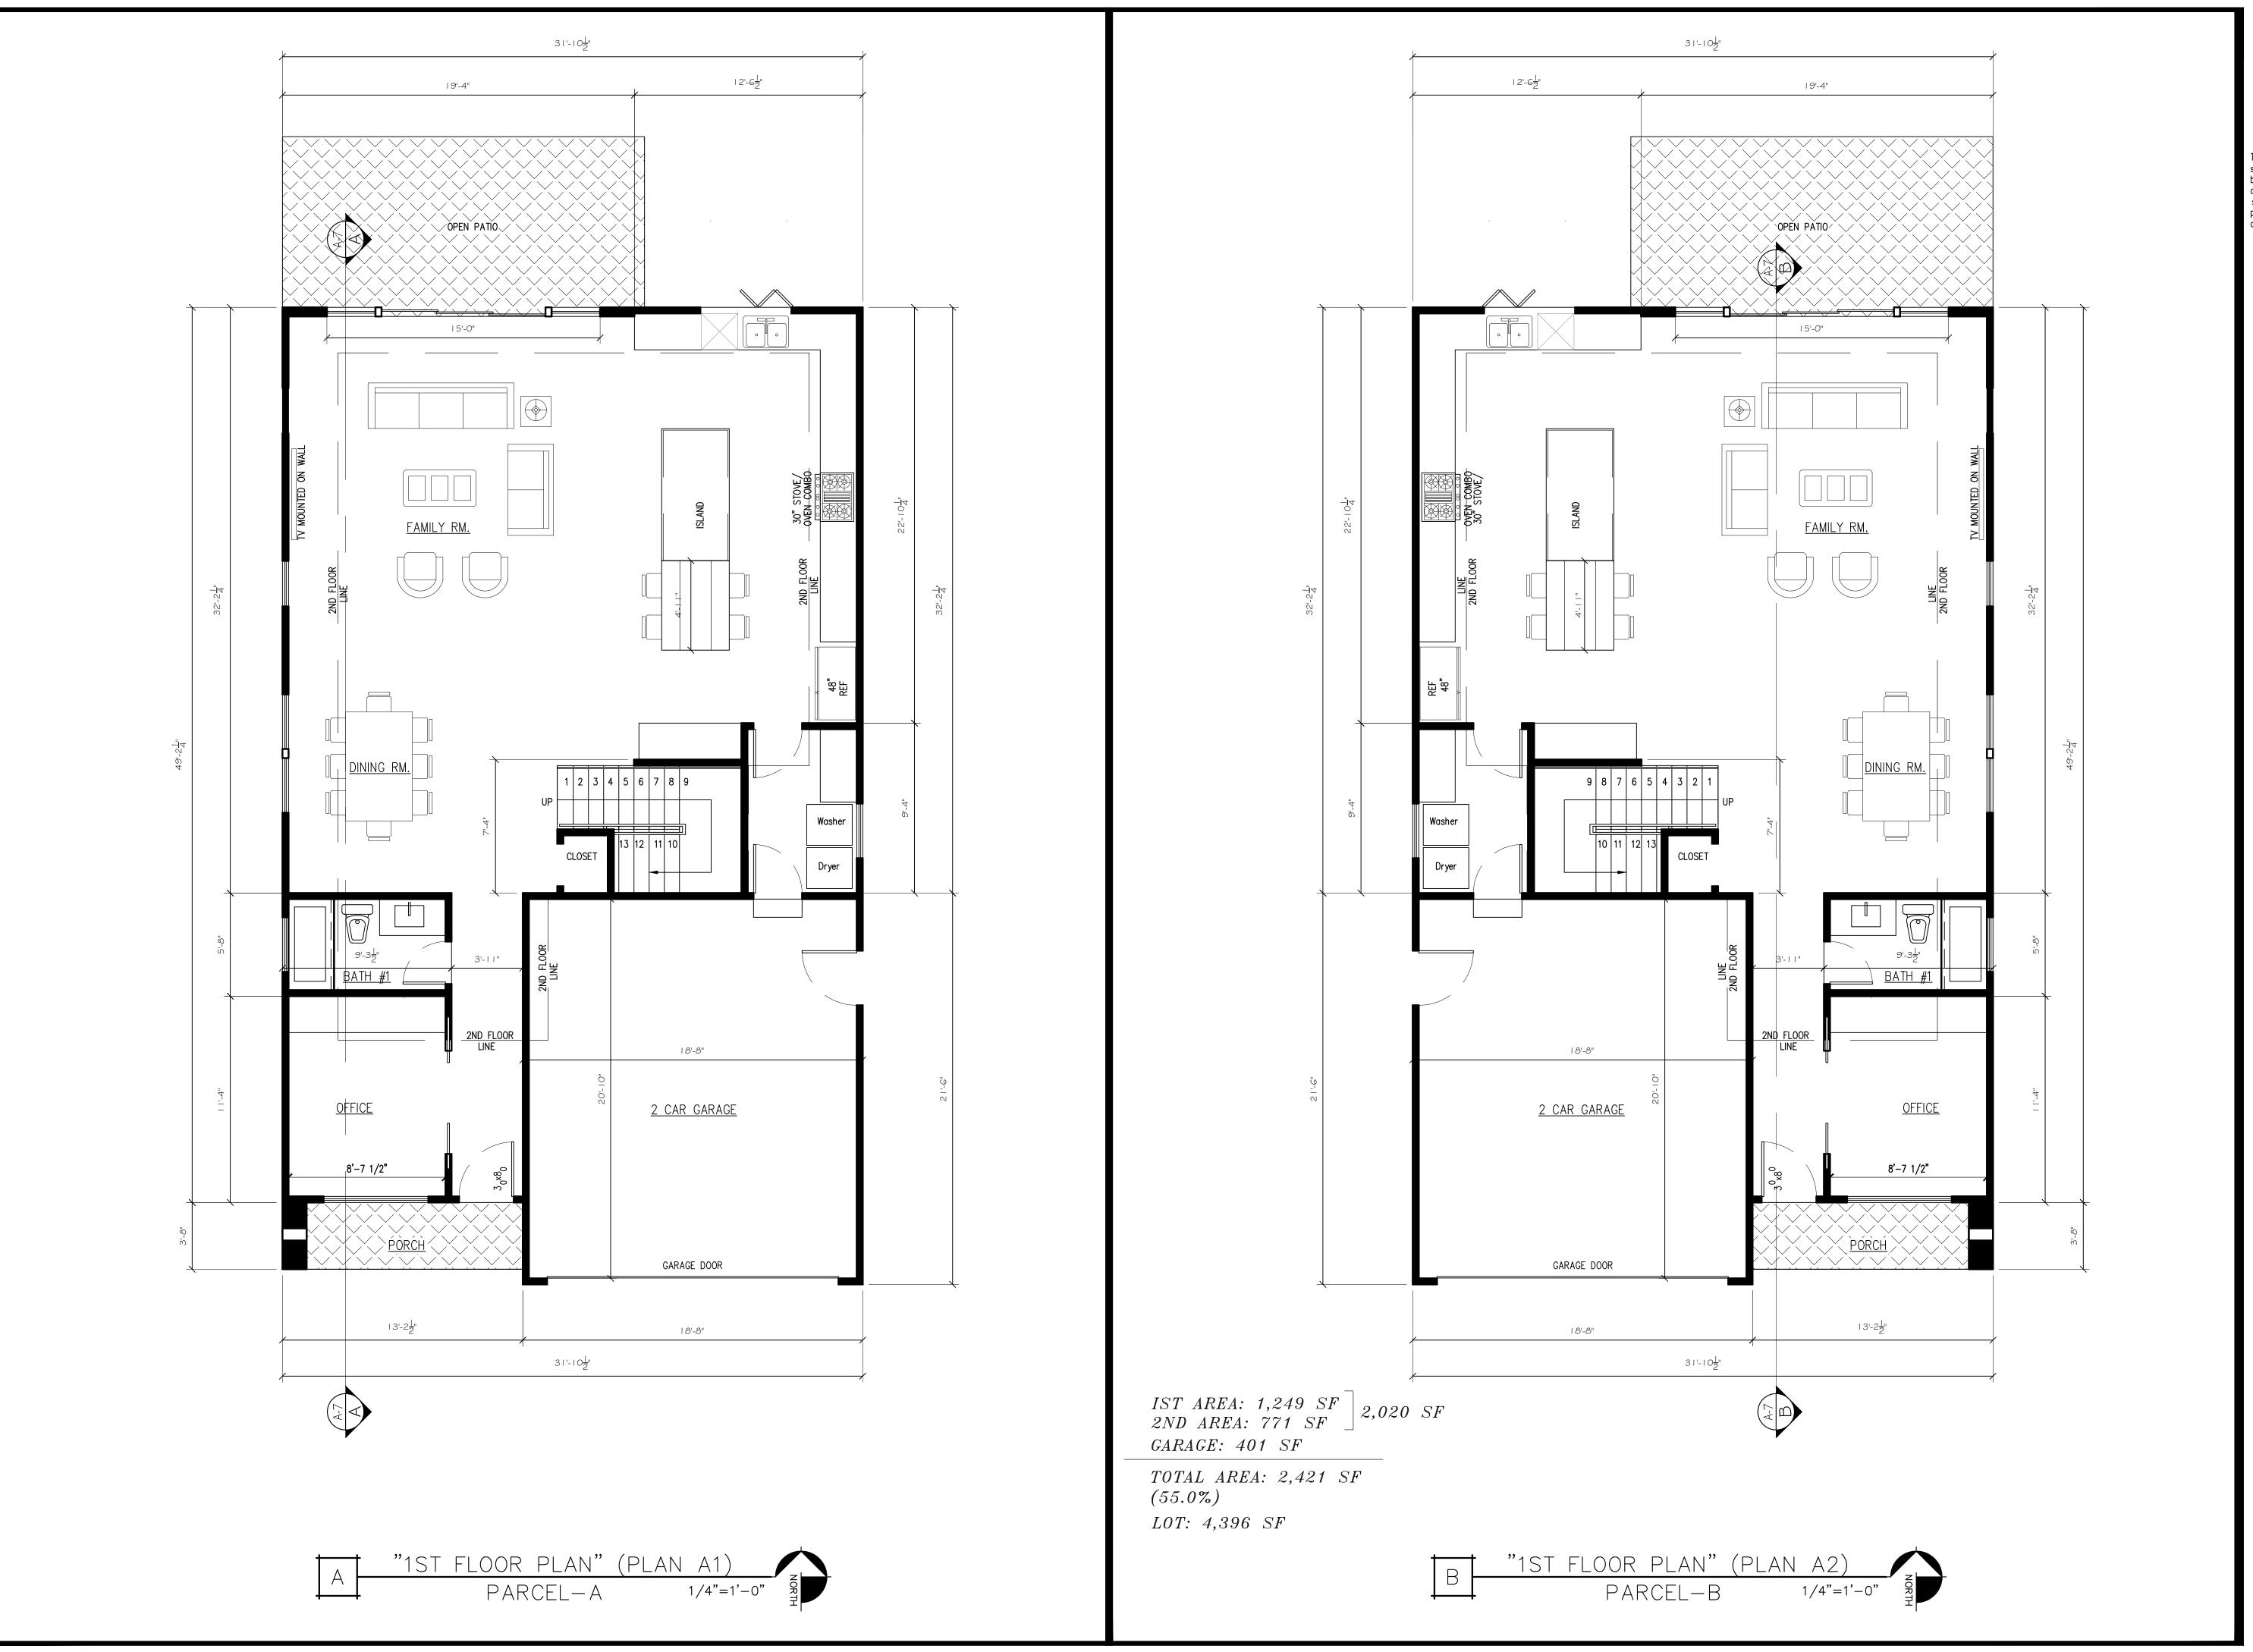

Desid

aks

BUILDING

DESIGN

AKS BUILDING DESIGN

AMAN DULAY
(Principal Designer)

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Fax: 650.941.8755

aksdesign@gmail.com

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Project:

(2) NEW TWO STORY HOME

E. HOMESTEAD RD.

SUNNYVALE, CA 94087

APN: 309-46-053

Owner:

12561 PASEO CERRO GROUP 2088 E ELENDA DR. CUPERTINO, CA 95014

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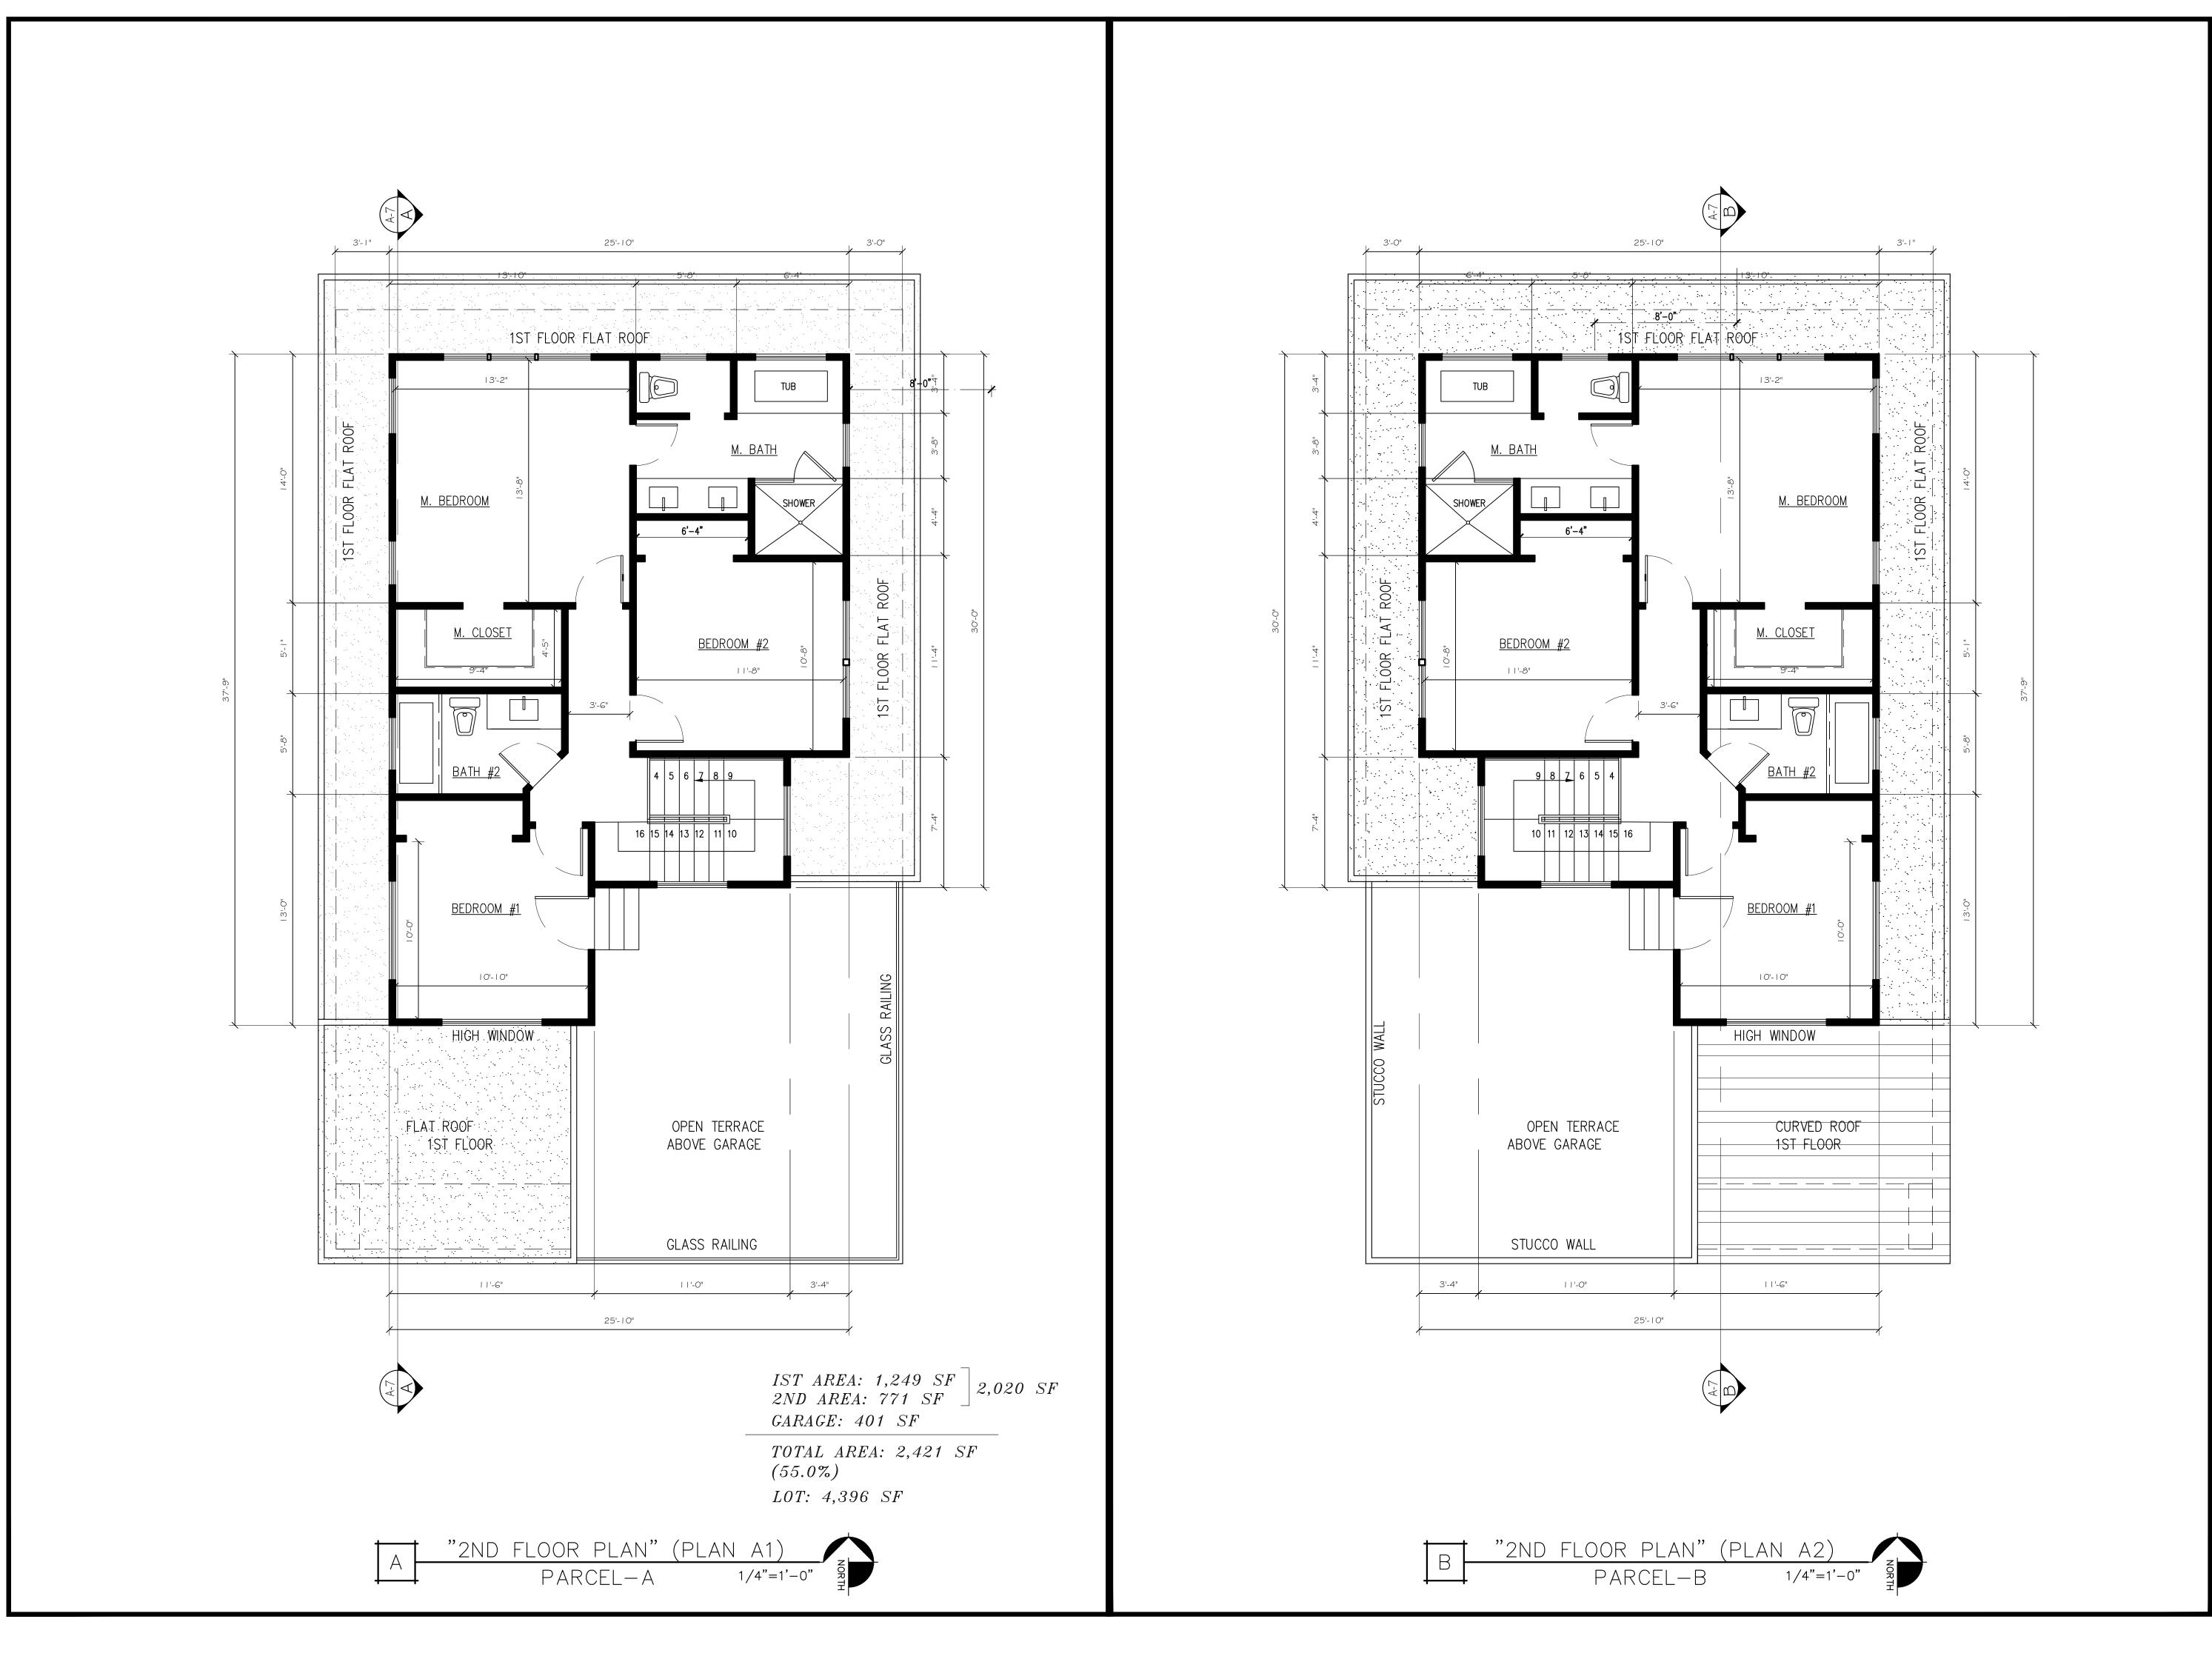
No.	Revision/Issue	Date
1		

Project:	Ε	HOMESTEAD	RD.
Scale:		As Shown	
Date:		11/14/18	
Clarat Title.			

Sheet Title:

"FIRST FLOOR PLANS"

Sheet No:



Design



AKS BUILDING DESIGN

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(Principal Designer)
Tel: 408.375.8351
Fax: 650.941.8755
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12561 PASEO CERRO GROUP 2088 E ELENDA DR. CUPERTINO, CA 95014

No.	Submittals	Date
1	PLANNING	3/21/2018
2	PLANNING	6/20/2018
3	PLANNING	9/19/2018
4	PLANNING	11/14/2018


No.	Revision/Issue	Date
1		

	Project:	Ε	HOMESTEAD	RD.
	Scale:		As Shown	
	Date:	·	11/14/18	
•				

Sheet Title:

"SECOND FLOOR PLANS"

Sheet No:

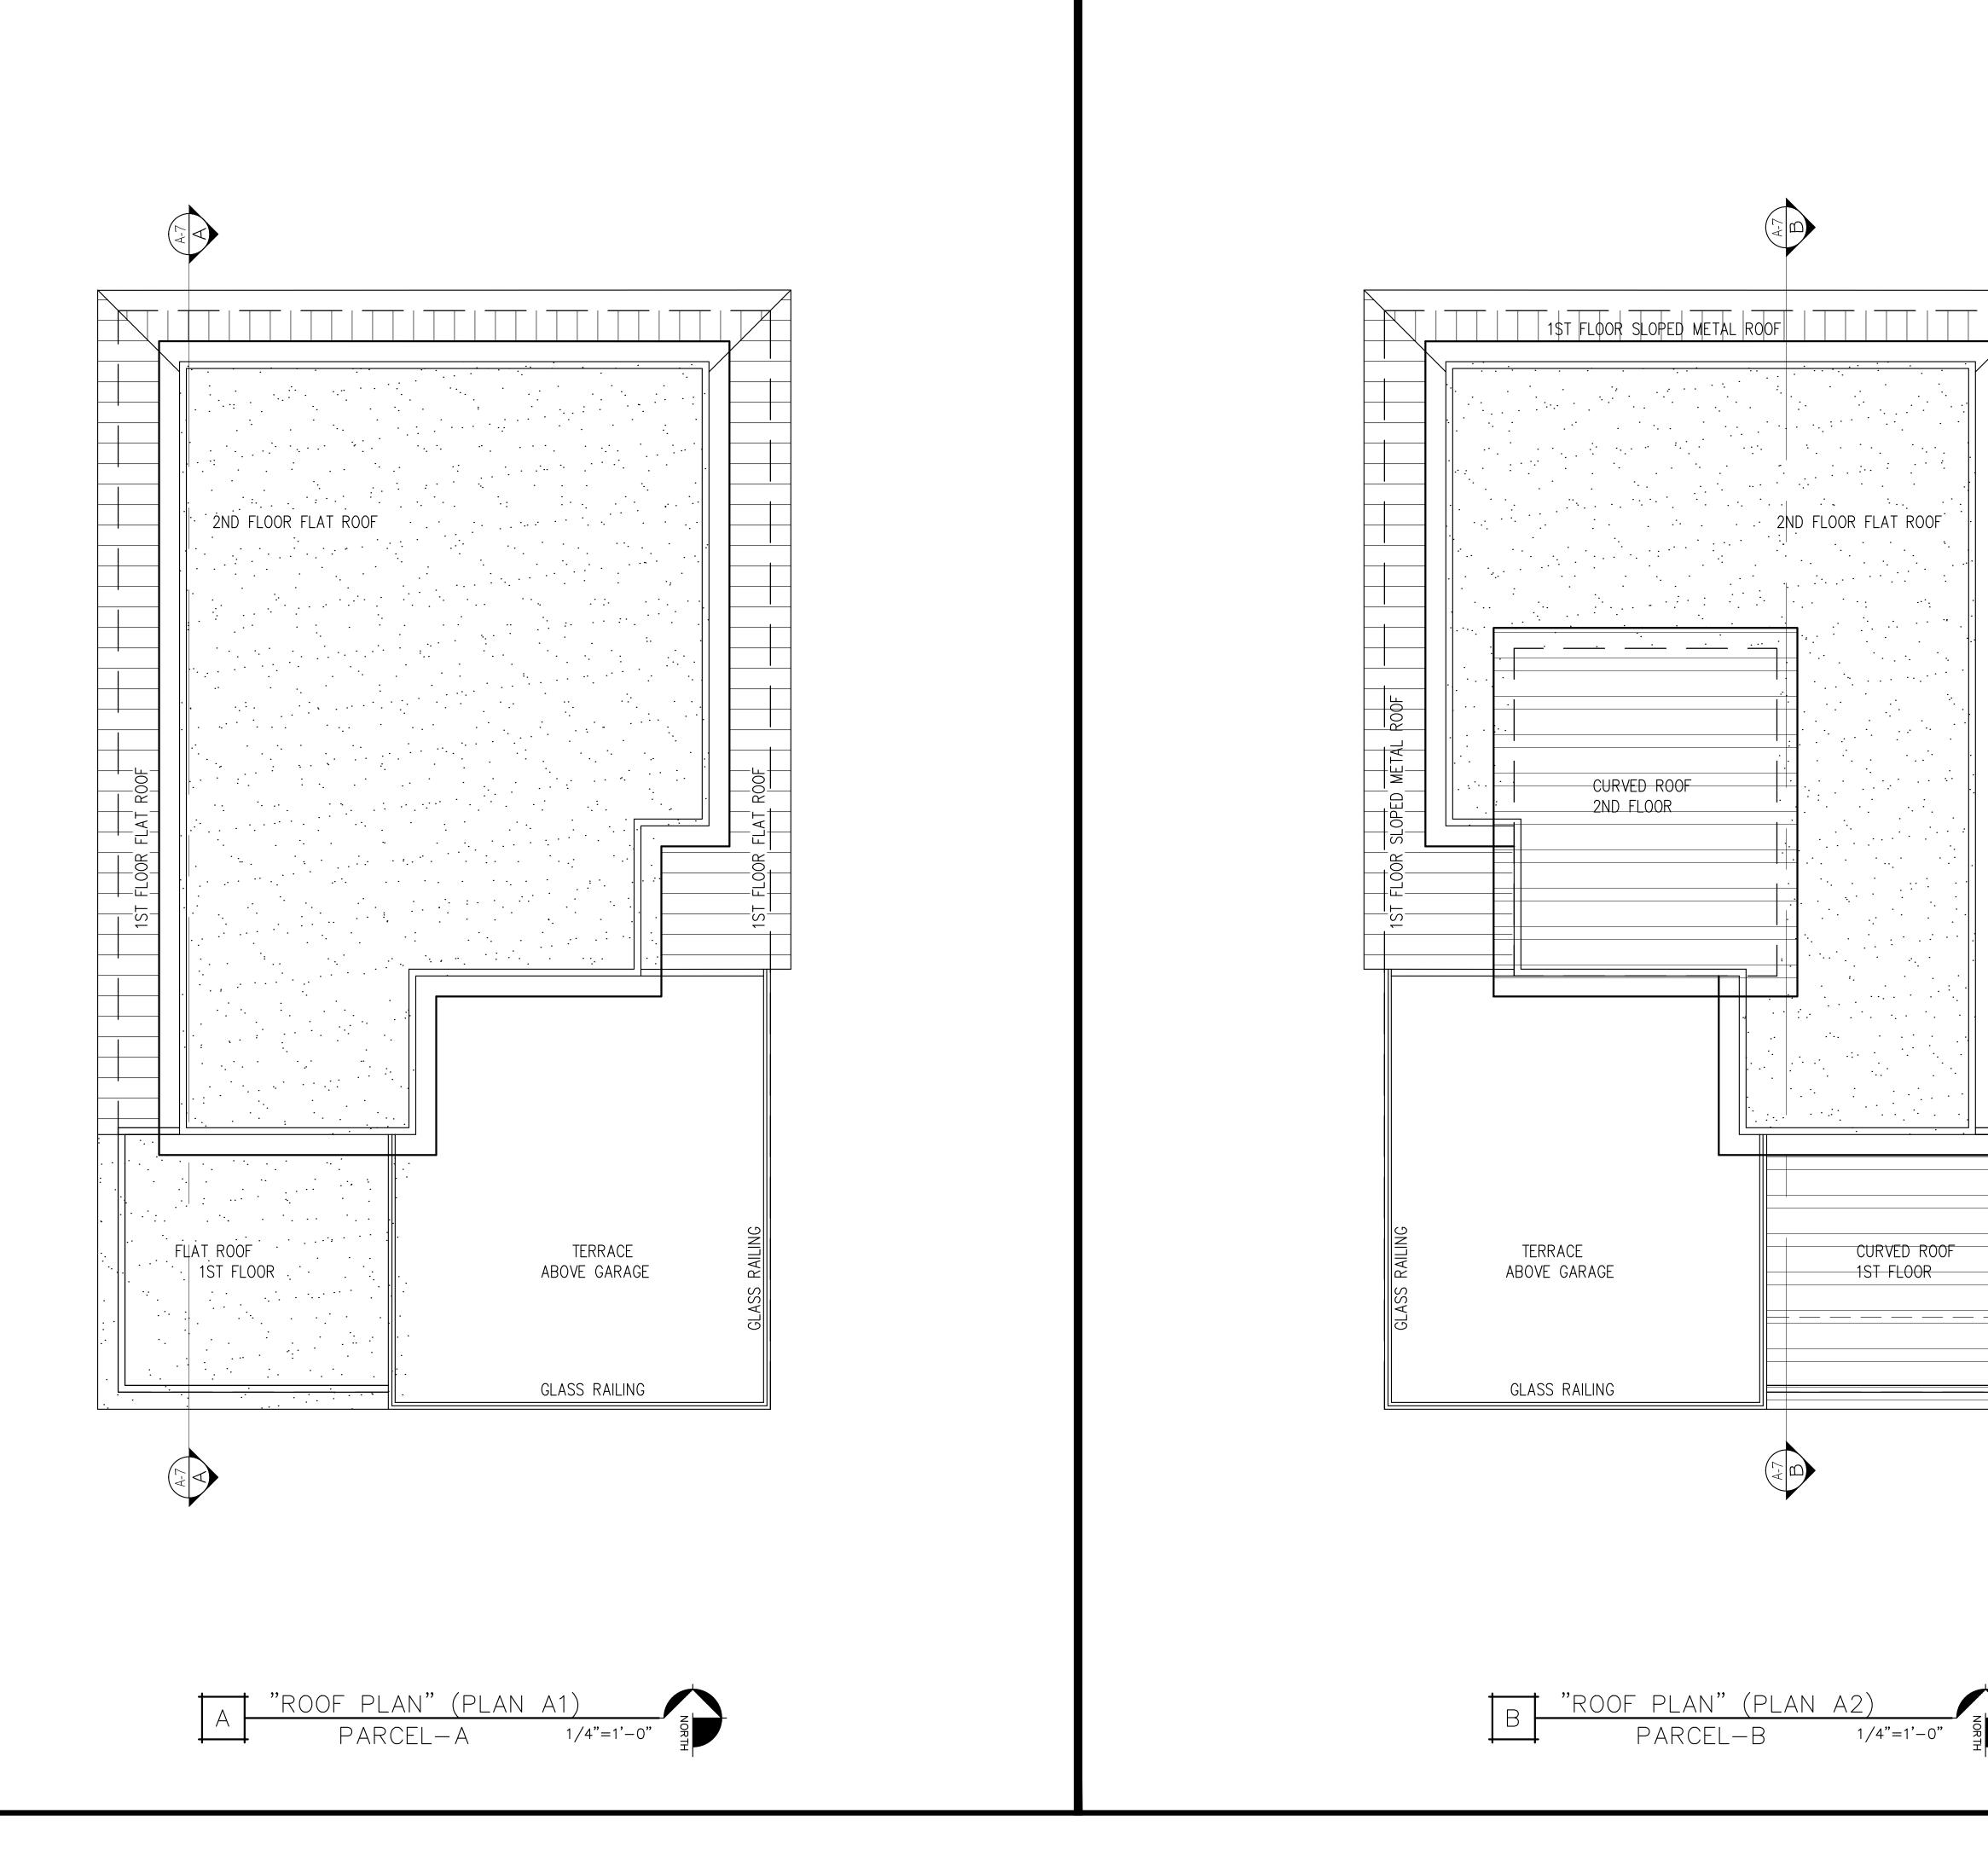

Design



AKS BUILDING DESIGN

AMAN DULAY
(Principal Designer)

Tel: 408.375.8351

Fax: 650.941.8755

aksdesign@gmail.com

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Project:
(2) NEW TWO STORY HOME
E. HOMESTEAD RD.
SUNNYVALE, CA 94087
APN: 309-46-053

Owner:

12561 PASEO CERRO GROUP 2088 E ELENDA DR. CUPERTINO, CA 95014

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Revision/Issue	Date
	Revision/Issue

Project:	E HOMESTEAD RD.
Scale:	As Shown
Date:	11/14/18
Sheet Title:	

••

"ROOF PLANS"

Sheet No:



Doois



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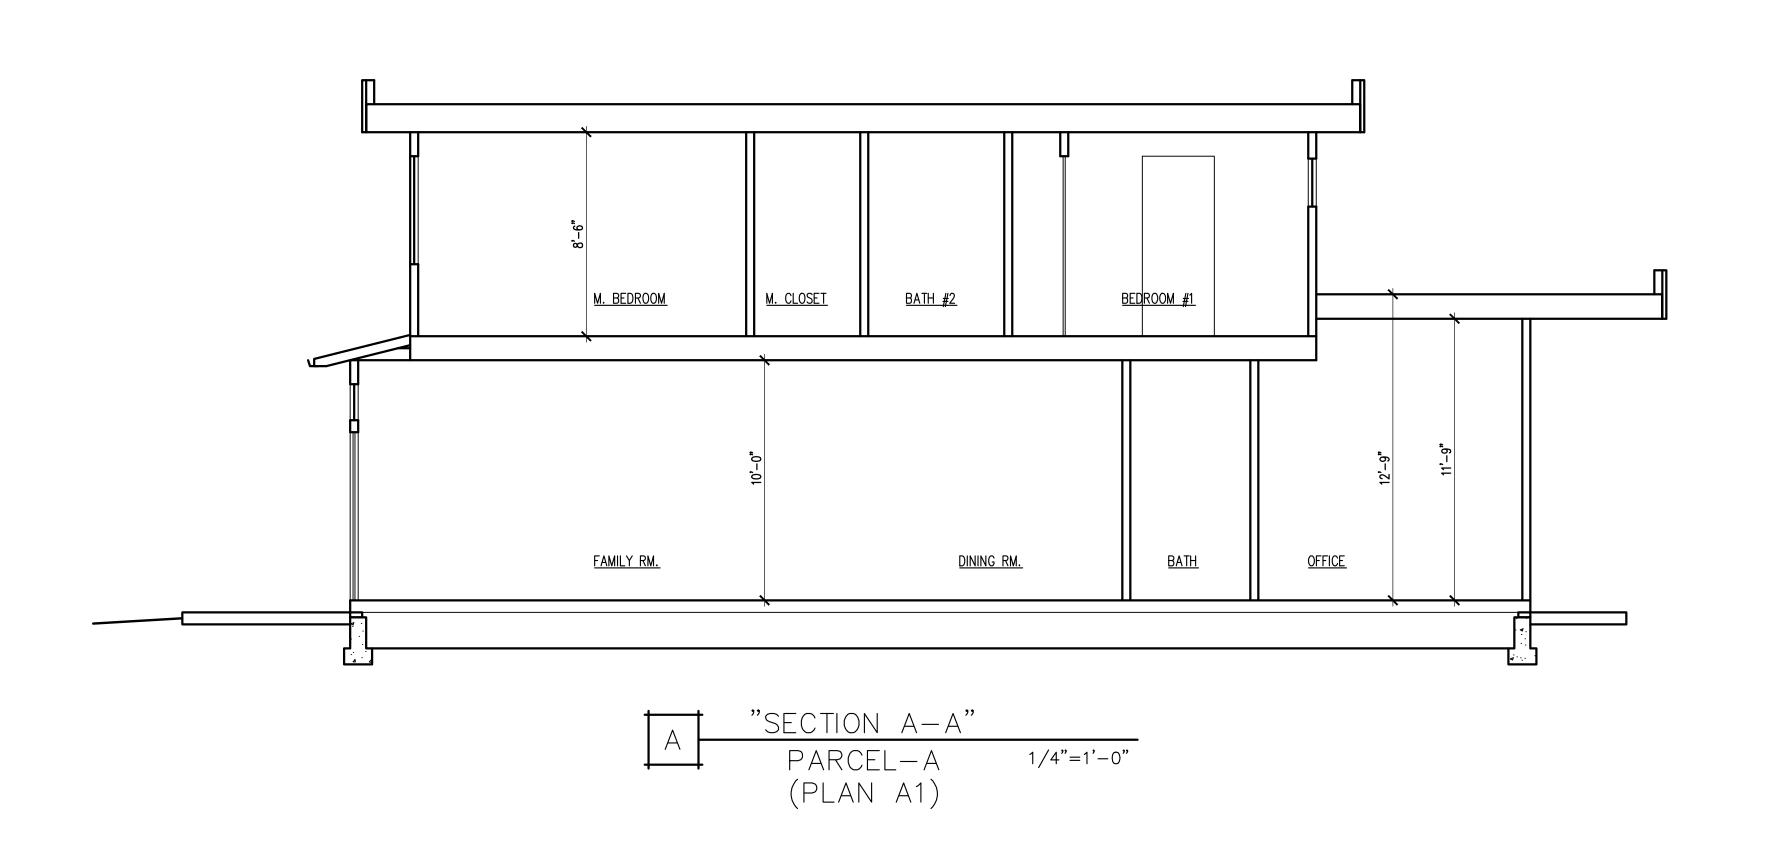
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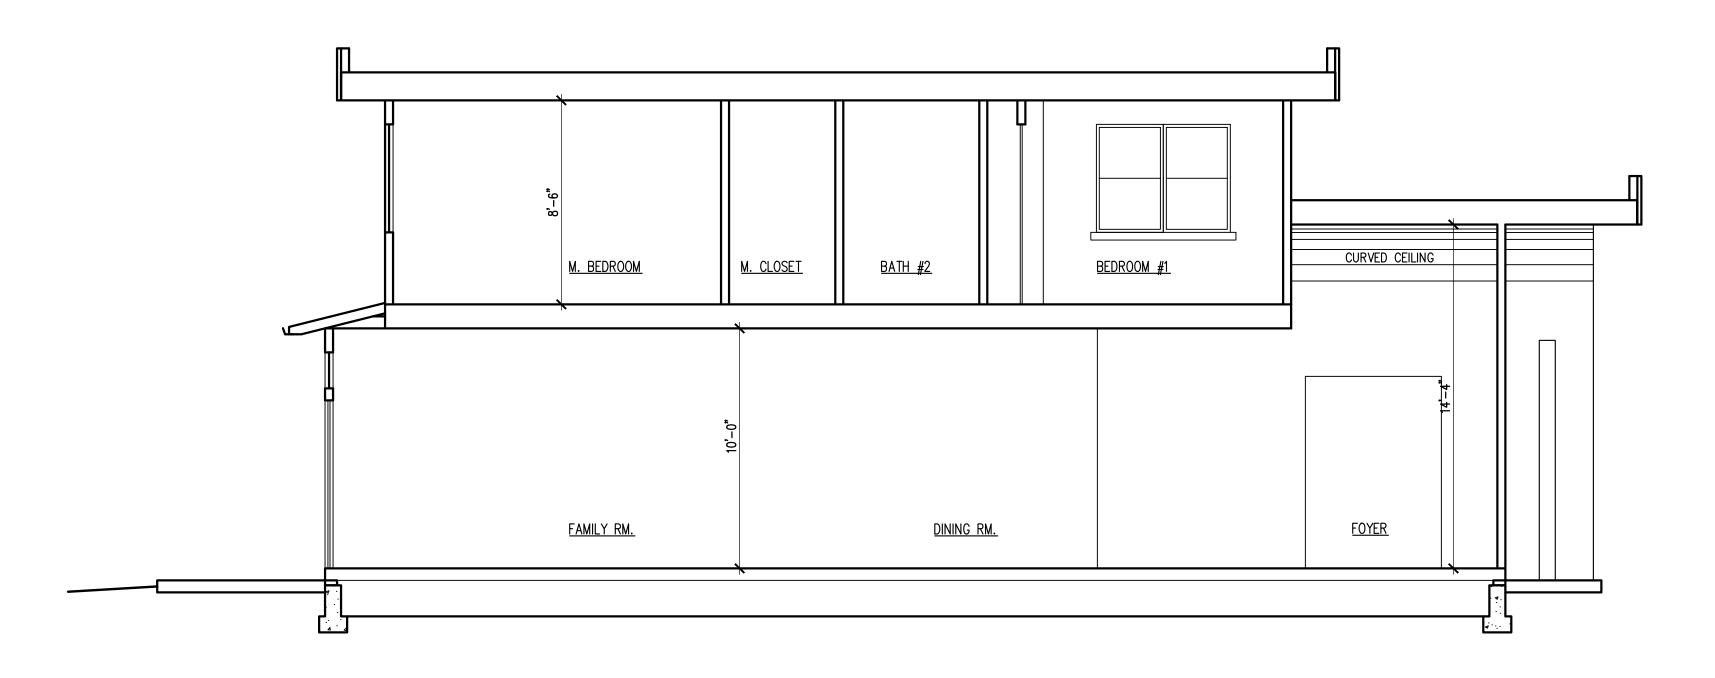
Sheet Title:

"EXTERIOR ELEVATIONS—PLAN A1"

Sheet No







"SECTION B-B"
PARCEL-B
(PLAN A2)

Desid



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Project:	E HOMESTEAD RD
Scale:	As Shown
Date:	11/14/18

Sheet Title

"SECTIONS-PLAN A1 & A2"

Sheet N

Designer:



CALGREEN MANDATORY CHECKLIST

RESIDENTIAL PROJECTS

THESE REQUIREMENTS APPLY TO BUILDING PERMITS SUBMITTED ON OR AFTER JANUARY 1, 2017

Following is a standardized checklist of the 2016 California Green Building Standards Code (CalGreen) requirements that may be used to demonstrate compliance with the CalGreen Mandatory Measures (chapter 4). This checklist is required for all new buildings and additions/alterations that increase the building's conditioned area. The requirements shall apply only to and/or within the specific area of the addition or alteration.

CALGreen Reference	Description	Designer's Comments with Plan Sheet Reference	City Use Only Field Insp. Verification
4.1 Planning and Design	4.106.2 Storm water drainage and retention during construction. A plan is developed and implemented to manage storm water drainage during construction.	Sheet:	Initials: Date:
4.1 Planning and Design	4.106.3 Grading and paving. Construction plans shall indicate how site grading or a drainage system will manage all surface water flows keep water from entering buildings.	Sheet:	Initials: Date:
4.1 Planning and Design	4.106.4 EV Charging. Provide capability for electric vehicle charging in one- and two-family dwellings and in townhouses with attached private garages; and 12.5% of total parking spaces, as specified, for multi-family dwellings.	Sheet:	Initials: Date:
4.2 Energy Efficiency	4.201.1 Scope Building meets or exceeds the requirements of the California Building Energy Efficiency Standards	Sheet:	Initials: Date:

4.3 Water Efficiency and Conservation	prescriptive requirements of Sections 4303.1.1 through 4303.1.4.4. 4.303.1.1 Water closets. The effective flush volume of all water closets shall not exceed 1.28 gallons per flush. Tank-type water closets shall be certified to the performance criteria of the U.S. EPA WaterSense Specification for Tank-type Toilets. Note: The effective flush volume of dual flush toilets is defined as the composite, average t1ush volume of two reduced flushes and one full flush. 4.303.1.2 Urinals. The effective flush volume of wall mounted urinals shall not exceed 0.125 gallons per flush. The effective flush volume of all other urinals shall not exceed 0.5 gallons per flush. 4.303.1.3 Showerheads. 4.303.1.3.1 Single showerhead. Showerheads shall have a maximum flow rate of not more than 2.0 gallons per minute at 80 psi. Showerheads shall be certified to the performance criteria of the U.S. EPA WaterSense Specification for Showerheads. 4.303.1.3.2 Multiple showerheads serving one shower. When a shower is served by more than one showerhead, the combined flow rate of all showerheads and/or other shower outlets controlled by a single valve shall not exceed 2.0 gallons per minute at 80 psi, or the shower shall be designed to allow only one shower outlet to be in operation at a time. Note: A hand-held shower shall be considered a Showerhead. 4.303.1.4 Faucets. 4.303.1.4.1 Residential lavatory faucets. The maximum flow rate of residential lavatory faucets shall not exceed 1.2 gallons per minute at 60 psi. The minimum flow rate of residential lavatory faucets in stalled in common and public use areas (outside of dwellings or sleeping units) in residential buildings shall not exceed 0.5 gallons per minute at 60 psi. 4.303.1.4.3 Metering faucets. Metering faucets when installed in residential buildings shall not deliver more than 0.25 gallons per cycle. 4.303.1.4.4 Kitchen faucets. The maximum flow rate of kitchen faucets shall not exceed 1.8 gallons per minute at 60 psi, Kitchen faucets may temporarily increase the flow above th	Sheet:	Initials: Date:
4.3 Water Efficiency and Conservation	fixtures and fittings required in Section 4.303.1 shall be installed in accordance with the California Plumbing Code, and shall meet the applicable referenced standards.	Sheet:	Initials: ——— Date:

00 p.m. Building ar

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Page 3 of 5

4.304.1 Outdoor potable water use in landscape areas. After

with one of the following options:

Compliance Option.

December 1, 2015, new residential developments with an aggregate

1. A local water efficient landscape ordinance or the current

landscape area equal to or greater than 500 square feet shall comply

feet may comply with the MWELO's Appendix D Prescriptive

California Department of Water Resources' Model Water Efficient Landscape Ordinance (MWELO), whichever is more stringent; or 2. Projects with aggregate landscape areas less than 2,500 square

1. The Model Water Efficient Landscape Ordinance (MWELO) and supporting documents are available at: www.water.ca.gov/wateruseefficiency/landscapeordinance/ 2. A water budget calculator is available at: www.water.ca.gov/wateruseefficiency/landscapeordinance/ Sheet: **4.406.1 Rodent proofing.** Annular spaces around pipes, electric cables, conduits or other openings in sole/bottom plates at exterior walls shall be protected against the passage of rodents by closing such openings with cement mortar, concrete masonry or a similar method acceptable to the enforcing agency. **4.408.1 Construction waste management.** Recycle and/or salvage for reuse a minimum of 65 percent of the nonhazardous construction and demolition waste in accordance with one of the following: 1. Comply with a more stringent local construction and demolition waste management ordinance; or 2. A construction waste management plan, per Section 4.408.2; or 3. A waste management company, per Section 4.408.3; or 4. The waste stream reduction alternative, per Section 4.408.4. **4.410.1 Operation and maintenance manual**. An operation and maintenance manual shall be provided to the building occupant or 4.410.2 Recycling by Occupants. Where 5 or more multifamily dwelling units are constructed on a building site, provide readily accessible area(s) that serves all buildings on the site and is identified for the depositing, storage and collection of non-hazardous materials for recycling, including (at a minimum) paper, corrugated cardboard, glass, plastics, organic waste, and metals, or meet a lawfully enacted local recycling ordinance, if more restrictive. **4.503.1 Fireplace**. Any installed gas fireplace shall be a direct vent sealed-combustion type. Any installed woodstove or pellet stove shall comply with U.S. EPA New Source Performance Standards (NSPS) emission limits as applicable, and shall have a permanent label indicating they are certified to meet the emission limits. Woodstoves, pellet stoves and fireplaces shall also comply with applicable local ordinances.

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504.1 Covering of duct openings and protection of mechanical puipment during construction. Duct openings and other related air stribution component openings shall be covered during construction.
504.2 Finish material pollutant control.

4.504.2.1 Adhesives, sealants and caulks. Adhesives, sealants and caulks shall be compliant with VOC and other toxic compound limits.
4.504.2.2 Paints and coatings. Paints, stains and other coatings

4.504.2.2 Paints and coatings. Paints, stains and other coatings shall be compliant with VOC limits.
4.504.2.3 Aerosol paints and coatings. Aerosol paints and coatings shall be compliant with product weighted MIR limits for ROC and other toxic compounds.

4.504.2.4 Verification. Documentation shall be provided to verify that compliant VOC limit finish materials have been used.

4.504.3 Carpet systems. All carpet installed in the building interior shall meet the testing and product requirements of one of the following:

1. Carpet and Rug Institute's Green Label Plus Program.

California Department of Public Health, "Standard Method for the Testing and Evaluation of Volatile Organic Chemical Emissions from Indoor Sources Using Environmental Chambers," Version 1.1, February 2010 (also known as Specification 01350.)
 NSFI ANSI 140 at the Gold level.
 Scientific Certifications Systems Indoor Advantage™ Gold.

4.504.3.1 Carpet cushion. All carpet cushion installed in the building interior shall meet the requirements of the Carpet and Rug Institute's Green Label program.
4.504.3.2 Carpet adhesive. All carpet adhesive shall meet the requirements of Table 4.504.1.

4.504.4 Resilient flooring systems. Where resilient flooring is installed, at least 80 percent of floor area receiving resilient flooring shall comply with one or more of the following:

1. Products compliant with the California Department of Public

Health, "Standard Method for the Testing and Evaluation of Volatile Organic Chemical Emissions from Indoor Sources Using Environmental Chambers," Version 1.1, February 2010 (also known as Specification 01350), certified as a CHPS Low-Emitting Material in the Collaborative for High Performance Schools (CHPS) High Performance Products Database.

2. Products certified under UL GREENGUARD Gold (formerly the Greenguard Children & Schools program).

Greenguard Children & Schools program).

3. Certification under the Resilient Floor Covering Institute (RFCI) FloorScore program.

4. Meet the California Department of Public Health, "Standard

4. Meet the California Department of Public Health, "Standard Method for the Testing and Evaluation of Volatile Organic Chemical Emissions from Indoor Sources Using Environmental Chambers," Version 1.1, February 201 0 (also known as Specification 01350).

4.504.5 Composite wood products. Hardwood plywood, particleboard and medium density fiberboard composite wood products used on the interior or exterior of the building shall meet the requirements for formaldehyde as specified in ARB's Air Toxics Control Measure for Composite Wood (17 CCR 93J20 et seq.), by or before the dates specified in those sections, as shown in Table 4.504.5.

Page 4 of 5

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4.5 Environmental Quality	 4.505.2 Concrete slab foundations. Vapor retarder and capillary break is installed at slab-on-grade foundations. 4.503.3 Moisture content of building materials. Moisture content of building materials used in wall and floor framing is checked before enclosure. 	Sheet:	Initials: ——— Date:
4.5 Environmental Quality	 4.507.2 Heating and air-conditioning system design. Duct systems are sized, designed, and equipment is selected using the following methods: 1. Establish heat loss and heat gain values according to ANSIIACCA 2 Manual J-2011 or equivalent. 2. Size duct systems according to ANSI! ACCA 1 Manual D-2014 or equivalent. 3. Select heating and cooling equipment according to ANSI/ACCA 3 Manual S-2014 or equivalent. 	Sheet:	Initials: ——— Date:
Chapter 7 Installer and Special Inspector Qualifications	 702.1 Installer Training. HVAC system installers are trained and certified in the proper installation of HVAC systems. 702.2 Special Inspection. Special inspectors employed by the enforcing agency must be qualified and able to demonstrate competence in the discipline they are inspecting. 703.1 Documentation. Verification of compliance with this code may include construction documents, plans, specifications builder or installer certification, inspection reports, or other methods acceptable to the enforcing agency which show substantial conformance. 	Sheet:	Initials: ——— Date:

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Revision/Issue	Date
	Revision/Issue

Project:	E HOMESTEAD RD.
Scale:	As Shown
Date:	11/14/18

Sheet Title:

"CALGREEN CHECKLIST"

Sheet No:

CG-

	sidences - E. Homestead Rd. APN: (309-46-053)	Points Targeted	Community	Energy	AQ/Health	Resources	Water
OUNDATION		<u> </u>		_ ш		<u> </u>	>
No	B1. Fly Ash and/or Slag in Concrete	0		T T		1	
TBD	B2. Radon-Resistant Construction				2	<u> </u>	
TBD	B3. Foundation Drainage System					2	
TBD	B4. Moisture Controlled Crawlspace				1		
	B5. Structural Pest Controls						
TBD	B5.1 Termite Shields and Separated Exterior Wood-to-Concrete Connections					1	
No	B5.2 Plant Trunks, Bases, or Stems at Least 36 Inches from the Foundation	0				1	$\overline{}$
ANDSCAPE							
45.91%	Enter the landscape area percentage						
No	C1. Plants Grouped by Water Needs (Hydrozoning)	0					1
No	C2. Three Inches of Mulch in Planting Beds	0					1
	C3. Resource Efficient Landscapes						
No	C3.1 No Invasive Species Listed by Cal-IPC	0				1	
TBD	C3.2 Plants Chosen and Located to Grow to Natural Size					1	
No	C3.3 Drought Tolerant, California Native, Mediterranean Species, or Other						
INU	Appropriate Species	0					3
	C4. Minimal Turf in Landscape						
Yes	C4.1 No Turf on Slopes Exceeding 10% and No Overhead Sprinklers Installed in						
162	Areas Less Than Eight Feet Wide	2					2
No	C4.2 Turf on a Small Percentage of Landscaped Area	0					2
No	C5. Trees to Moderate Building Temperature	0	1	1			1
No	C6. High-Efficiency Irrigation System	0					2
TBD	C7. One Inch of Compost in the Top Six to Twelve Inches of Soil						2
TBD	C8. Rainwater Harvesting System						3
TBD	C9. Recycled Wastewater Irrigation System						1
TBD	C10. Submeter or Dedicated Meter for Landscape Irrigation						2
TBD	C11. Landscape Meets Water Budget						2
	C12. Environmentally Preferable Materials for Site						
TBD	C12.1 Environmentally Preferable Materials for 70% of Non-Plant Landscape						
NI-	Elements and Fencing	0	1			1	
No	C13. Reduced Light Pollution	0	1				₩
TBD	C14. Large Stature Tree(s)		1				1
TBD	C15. Third Party Landscape Program Certification						1
TBD	C16. Maintenance Contract with Certified Professional AND BUILDING ENVELOPE						1

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wo New Re	sidences - E. Homestead Rd. APN: (309-46-053)	Points Targeted	Community	Energy	IAQ/Health	Resources	Motor
TBD	D1.2 Non-Load Bearing Door and Window Headers Sized for Load					1	
TBD	D1.3 Advanced Framing Measures					2	
TBD	D2. Construction Material Efficiencies					1	
	D3. Engineered Lumber						
TBD	D3.1 Engineered Beams and Headers					1	
Yes	D3.2 Wood I-Joists or Web Trusses for Floors	1				1	
TBD	D3.3 Enginered Lumber for Roof Rafters					1	
TBD	D3.4 Engineered or Finger-Jointed Studs for Vertical Applications					1	
No	D3.5 OSB for Subfloor	0				0.5	
No	D3.6 OSB for Wall and Roof Sheathing	0				0.5	
TBD	D4. Insulated Headers			1			
	D5. FSC-Certified Wood						•
No	D5.1 Dimensional Lumber, Studs, and Timber	0				6	
No	D5.2 Panel Products	0				3	
	D6. Solid Wall Systems						
TBD	D6.1 At Least 90% of Floors					1	
TBD	D6.2 At Least 90% of Exterior Walls			1		1	
TBD	D6.3 At Least 90% of Roofs			1		1	
TBD	D7. Energy Heels on Roof Trusses			1			
No	D8. Overhangs and Gutters	0		1		1	
	D9. Reduced Pollution Entering the Home from the Garage						
No	D9.1 Detached Garage	0			2		П
No	D9.2 Mitigation Strategies for Attached Garage	0			1		
	D10. Structural Pest and Rot Controls						
TBD	D10.1 All Wood Located At Least 12 Inches Above the Soil					1	П
	D10.2 Wood Framing Treated With Borates or Factory-Impregnated, or Wall						
TBD	Materials Other Than Wood					1	
	D11. Moisture-Resistant Materials in Wet Areas (such as Kitchen, Bathrooms,						\vdash
No	Utility Rooms, and Basements)	0			1	1	
EXTERIOR							
TBD	E1. Environmentally Preferable Decking					1	
TBD	E2. Flashing Installation Third-Party Verified					2	
TBD	E3. Rain Screen Wall System					2	
Yes	E4. Durable and Non-Combustible Cladding Materials	1				1	
. 33	E5. Durable Roofing Materials						
Yes	E5.1 Durable and Fire Resistant Roofing Materials or Assembly	1				1	Т
	,		2	2			_

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Two New Re	sidences - E. Homestead Rd. APN: (309-46-053)	Points Targeted	Community	Energy	AQ/Health	Resources	Water
	F1. Insulation with 30% Post-Consumer or 60% Post-Industrial Recycled Content						
Yes	F1.1 Walls and Floors	1				1	
Yes	F1.2 Ceilings	1				1	
	F2. Insulation that Meets the CDPH Standard Method—Residential for						
	Low Emissions						
TBD	F2.1 Walls and Floors				1		-
TBD	F2.2 Ceilings				1		
	F3. Insulation That Does Not Contain Fire Retardants						
TBD	F3.1 Cavity Walls and Floors				1		-
TBD	F3.2 Ceilings				1		
TBD	F3.3 Interior and Exterior				1		
. PLUMBING	G1. Efficient Distribution of Domestic Hot Water						
V	G1. Efficient Distribution of Domestic Hot Water G1.1 Insulated Hot Water Pipes	1		1			
Yes TBD	G1.2 WaterSense Volume Limit for Hot Water Distribution	1		1			1
TBD	G1.2 Water Serise Volume Limit for Hot Water Distribution G1.3 Increased Efficiency in Hot Water Distribution						2
IBD	G2. Install Water-Efficient Fixtures						
Yes	G2.1 WaterSense Showerheads with Matching Compensation Valve	2					2
Yes	G2.2 WaterSense Bathroom Faucets	1					1
res	G2.3 WaterSense Toilets with a Maximum Performance (MaP) Threshold of No	-					 '
Yes	Less Than 500 Grams	1					1
TBD	G3. Pre-Plumbing for Graywater System	-					1
TBD	G4. Operational Graywater System						3
	DN, AND AIR CONDITIONING						
TILATINO, VENTILATIO	H1. Sealed Combustion Units						
Yes	H1.1 Sealed Combustion Furnace	1			1		П
Yes	H1.2 Sealed Combustion Water Heater	2			2		_
TBD	H2. High Performing Zoned Hydronic Radiant Heating System			1	1		\vdash
	H3. Effective Ductwork						
Yes	H3.1 Duct Mastic on Duct Joints and Seams	1		1			
TBD	H3.2 Pressure Balance the Ductwork System			1			
Yes	H4. ENERGY STAR® Bathroom Fans Per HVI Standards with Air Flow Verified	1			1		
	H5. Advanced Practices for Cooling						
TBD	H5.1 ENERGY STAR Ceiling Fans in Living Areas and Bedrooms			1			
	H6. Whole House Mechanical Ventilation Practices to Improve Indoor Air Quality			-	-	-	
Yes	H6.1 Meet ASHRAE 62.2-2010 Ventilation Residential Standards	Υ	R	R	R	R	R
Yes	H6.2 Advanced Ventilation Standards	1			1		
TBD	H6.3 Outdoor Air Ducted to Bedroom and Living Areas				2		

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wo New Res	sidences - E. Homestead Rd. APN: (309-46-053)	Points Targeted	Community	Energy	AQ/Health	Resources	
	H7. Effective Range Hood Design and Installation						\top
Yes	H7.1 Effective Range Hood Ducting and Design	1			1		
Yes	H7.2 Automatic Range Hood Control	1			1		П
Yes	H8. No Fireplace or Sealed Gas Fireplace	1			1		П
TBD	H9. Humidity Control Systems				1		П
TBD	H10. Register Design Per ACCA Manual T			1			П
Yes	H11. High Efficiency HVAC Filter (MERV 8+)	1			1		
ENEWABLE ENERGY				•			
TBD	I1. Pre-Plumbing for Solar Water Heating			1			
Yes	I2. Preparation for Future Photovoltaic Installation	1		1			
	I3. Onsite Renewable Generation (Solar PV, Solar Thermal, and Wind)			25			
	I4. Net Zero Energy Home						
TBD	I4.1 Near Zero Energy Home			2			
TBD	I4.2 Net Zero Electric			4			
BUILDING PERFORMA							
TBD	J1. Third-Party Verification of Quality of Insulation Installation				1		
Yes	J2. Supply and Return Air Flow Testing	2		1	1		
TBD	J3. Mechanical Ventilation Testing and Low Leakage				1		
TBD	J4. Combustion Appliance Safety Testing				1		
	J5. Building Performance Exceeds Title 24 Part 6						
15.00%	J5.1 Home Outperforms Title 24 Part 6	25		60			
Yes	J6. Title 24 Prepared and Signed by a CABEC Certified Energy Analyst	1		1			
TBD	J7. Participation in Utility Program with Third-Party Plan Review			1			
TBD	J8. ENERGY STAR for Homes			1			
No	J9. EPA Indoor airPlus Certification	0			1		
TBD	J10. Blower Door Testing				2		
FINISHES							
	K1. Entryways Designed to Reduce Tracked-In Contaminants						
Yes	K1.1 Individual Entryways	1			1		
No	K2. Zero-VOC Interior Wall and Ceiling Paints	0			2		
Yes	K3. Low-VOC Caulks and Adhesives	1			1		
	K4. Environmentally Preferable Materials for Interior Finish						
TBD	K4.1 Cabinets					2	L
TBD	K4.2 Interior Trim					2	
TBD	K4.3 Shelving					2	
TBD	K4.4 Doors					2	
TBD	K4.5 Countertops					1	
	K5. Formaldehyde Emissions in Interior Finish Exceed CARB						

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Two New Res	sidences - E. Homestead Rd. APN: (309-46-053)	Points Targeted	Community	Energy	AQ/Health	Resources	Water
No	K5.1 Doors	0			1		
Yes	K5.2 Cabinets and Countertops	2			2		
Yes	K5.3 Interior Trim and Shelving	2			2		
TBD							
160	K6. Products That Comply With the Health Product Declaration Open Standard				2		
No	K7. Indoor Air Formaldehyde Level Less Than 27 Parts Per Billion	0			2		
No	K8. Comprehensive Inclusion of Low Emitting Finishes	0			1		
FLOORING							
≥50%	L1. Environmentally Preferable Flooring	2				3	
TBD	L2. Low-Emitting Flooring Meets CDPH 2010 Standard Method—Residential				3		
TBD	L3. Durable Flooring					1	
Yes	L4. Thermal Mass Flooring	1		1			
I. APPLIANCES AND LIG							
Yes	M1. ENERGY STAR® Dishwasher	1					1
CEE Tier 3	M2. CEE-Rated Clothes Washer	3		1			2
No	M3. Size-Efficient ENERGY STAR Refrigerator	0		2			
	M4. Permanent Centers for Waste Reduction Strategies						
Yes	M4.1 Built-In Recycling Center	1				1	
TBD	M4.2 Built-In Composting Center					1	
	M5. Lighting Efficiency						
Yes	M5.1 High-Efficacy Lighting	2		2			
TBD	M5.2 Lighting System Designed to IESNA Footcandle Standards or Designed by Lighting Consultant			2			
N. COMMUNITY							
	N1. Smart Development						
Yes	N1.1 Infill Site	2	1			1	
TBD	N1.2 Designated Brownfield Site		1		1		
TBD	N1.3 Conserve Resources by Increasing Density			2		2	
TBD	N1.4 Cluster Homes for Land Preservation		1			1	
	N1.5 Home Size Efficiency	0				9	
2800	Enter the area of the home, in square feet						
4	Enter the number of bedrooms						
TBD	N2. Home(s)/Development Located Within 1/2 Mile of a Major Transit Stop		2				
	N3. Pedestrian and Bicycle Access						
	N3.1 Pedestrian Access to Services Within 1/2 Mile of Community Services	0	2				
0	Enter the number of Tier 1 services						
0	Enter the number of Tier 2 services						
Yes	N3.2 Connection to Pedestrian Pathways	1	1				

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o New Re	sidences - E. Homestead Rd. APN: (309-46-053)	Points Targeted	Community	Energy	IAQ/Health	Resources	Water
TBD	N3.3 Traffic Calming Strategies		2				
	N4. Outdoor Gathering Places						
No	N4.1 Public or Semi-Public Outdoor Gathering Places for Residents	0	1				
TBD	N4.2 Public Outdoor Gathering Places with Direct Access to Tier 1 Community Services		1				
	N5. Social Interaction						
No	N5.1 Residence Entries with Views to Callers	0	1				
No	N5.2 Entrances Visible from Street and/or Other Front Doors	0	1				\vdash
No	N5.3 Porches Oriented to Street and Public Space	0	1				\vdash
TBD	N5.4 Social Gathering Space		1				
	N6. Passive Solar Design						
TBD	N6.1 Heating Load			2			
TBD	N6.2 Cooling Load			2			
	N7. Adaptable Building						
TBD	N7.1 Universal Design Principles in Units		1		1		
No	N7.2 Full-Function Independent Rental Unit	0	1				
HER							
Yes	O1. GreenPoint Rated Checklist in Blueprints	Υ	R	R	R	R	R
No	O2. Pre-Construction Kickoff Meeting with Rater and Subcontractors	0		0.5		1	0.5
No	O3. Orientation and Training to Occupants—Conduct Educational Walkthroughs	0		0.5	0.5	0.5	0.5
TBD	O4. Builder's or Developer's Management Staff are Certified Green Building Professionals			0.5	0.5	0.5	0.5
TBD	O5. Home System Monitors			1			1
	O6. Green Building Education						
Yes	O6.1 Marketing Green Building	2	2				
Yes	O6.2 Green Building Signage	1		0.5			0.5
Yes	O7. Green Appraisal Addendum	Υ	R	R	R	R	R
TBD	O8. Detailed Durability Plan and Third-Party Verification of Plan Implementation					1	
/ATIONS							
TBD	Enter Innovation 1 description here. Enter up to four points at right.						
TBD	Enter Innovation 2 description here. Enter up to four points at right.				Ì		
TBD	Enter Innovation 3 description here. Enter up to four points at right.						
TBD	Enter Innovation 4 description here. Enter up to four points at right.						
	Summary						
	Total Available Points in Specific Categories	342	26	131	54	83	48

Draft GreenPoint Rated New Home Single Family Checklist Version 7.0

Designer:

aks
BUILDING
TE
DESIGN

AKS BUILDING DESIGN

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Project:
(2) NEW TWO STORY HOME

E. HOMESTEAD RD.
SUNNYVALE, CA 94087
APN: 309-46-053

Owner:

12561 PASEO CERRO GROUP

2088 E ELENDA DR.

CUPERTINO, CA 95014

No.	Submittals	Date
1	PLANNING	3/21/2018
2	PLANNING	6/20/2018
3	PLANNING	9/19/2018
4	PLANNING	11/14/2018


	No.	Revision/Issue	Date
	1		
-			
_			

Project:	E HOMESTEAD RD.
Scale:	As Shown
Date:	11/14/18
Sheet Title:	

"GREEN BUILDING CHECKLIST"

Sheet No

GB-1

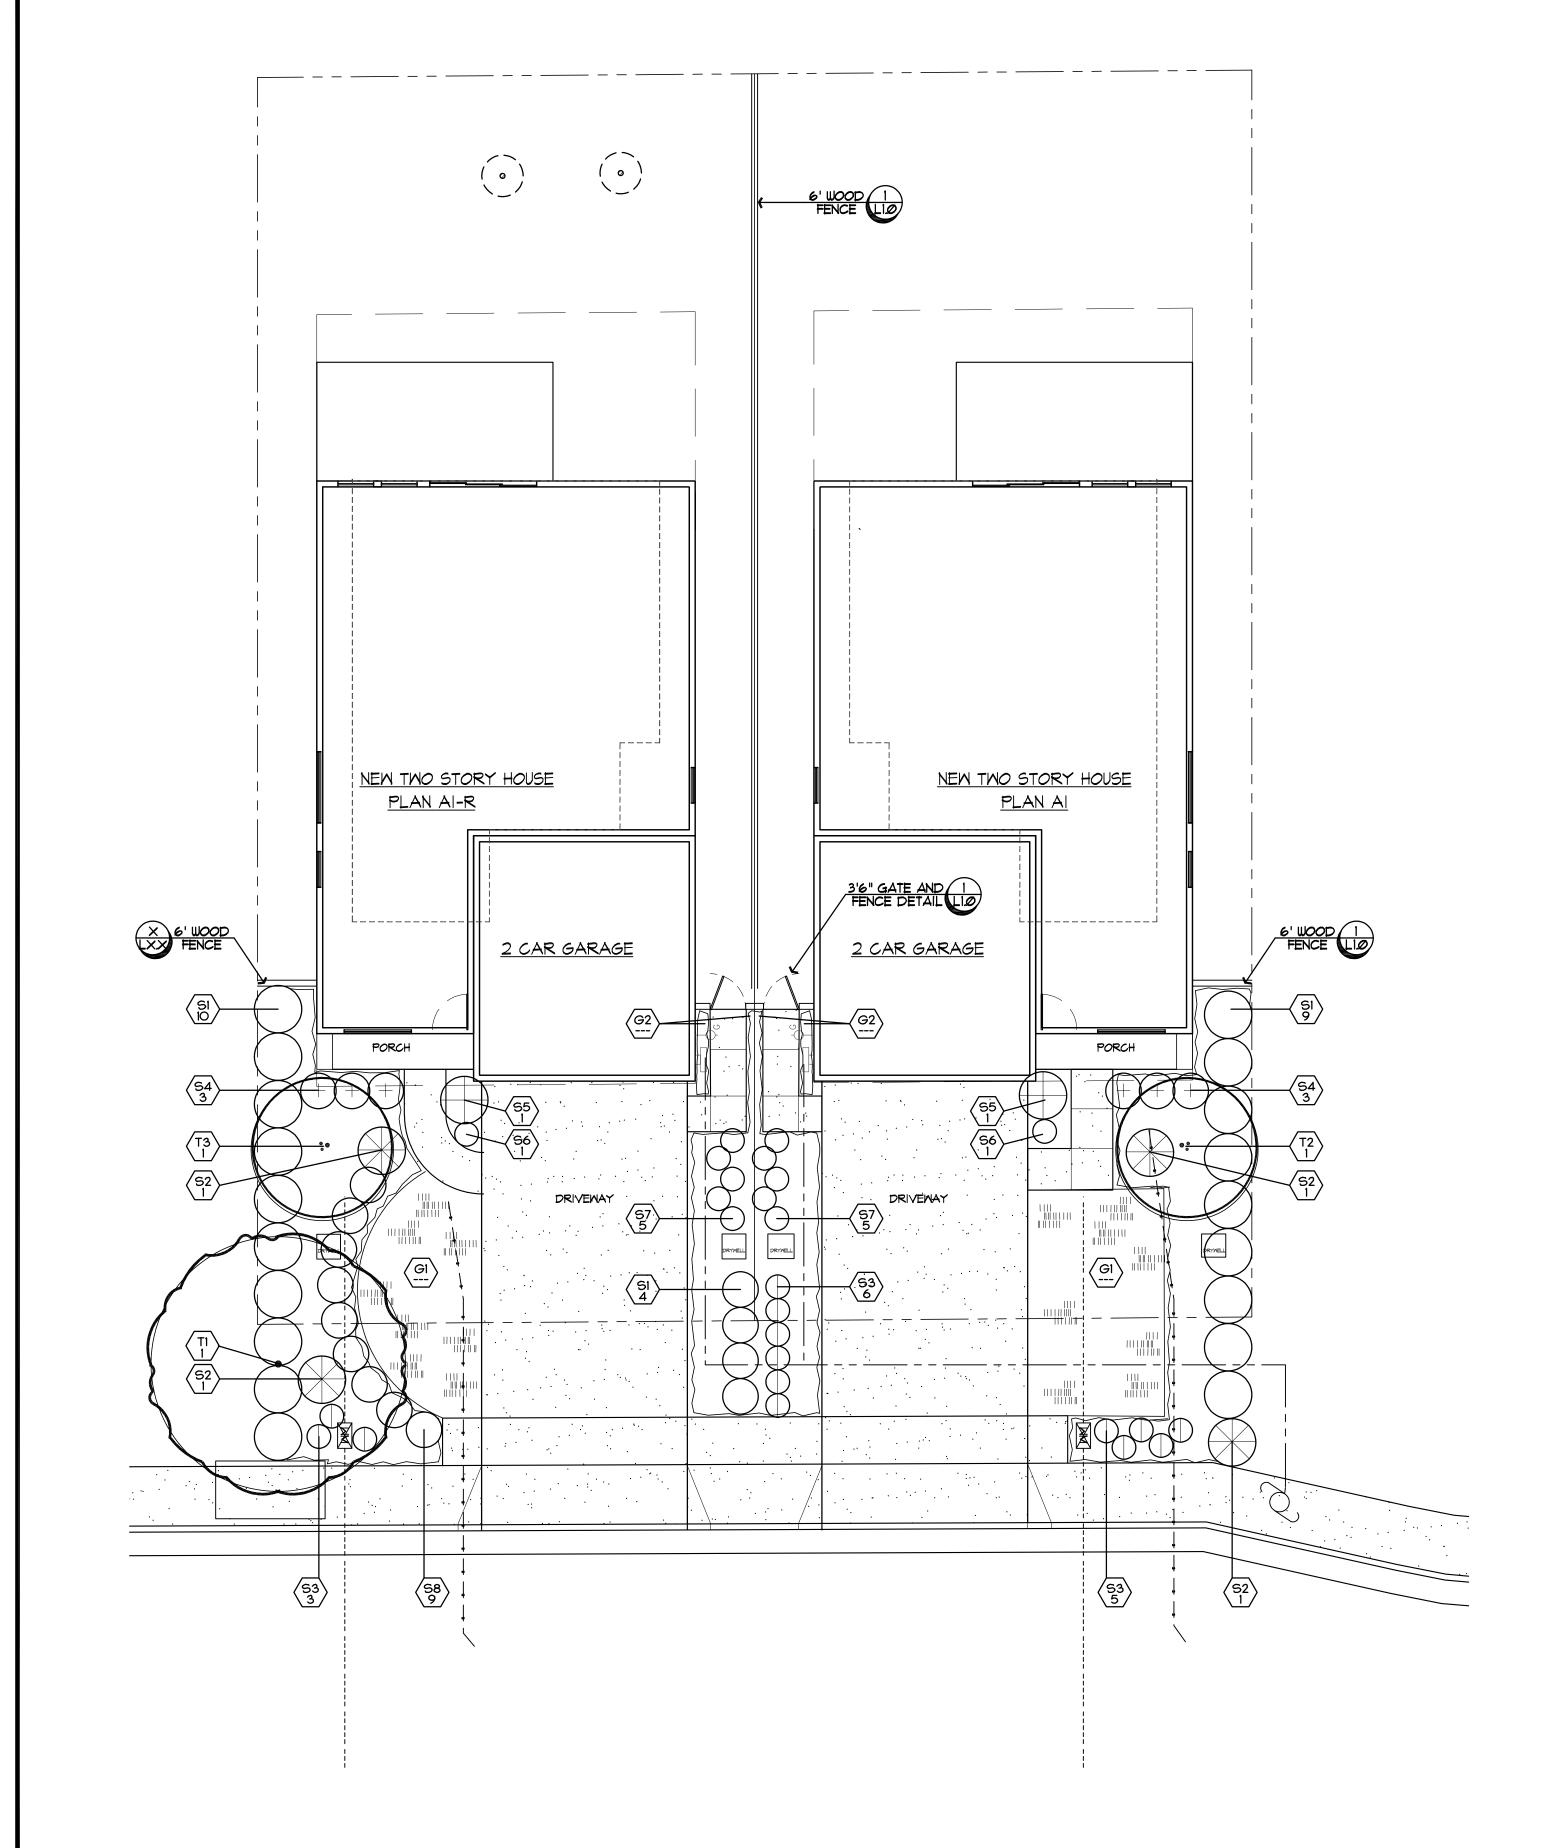

ŒY.	BOTANICAL NAME	COMMON NAME	QTY.	SIZE	REMARKS	WUCOLS
	TREES		-			-
TI	PISTACIA CHINESIS	CHINESE PISTACHE	1	24"BOX	STANDARD	LOW
T2	CERCIS C. 'FOREST PANSY'	EASTERN REDBUD	1	15 GAL	STANDARD	LOW
Ť3	LAGERSTROEMIA H. 'ARAPAHO'	HYBRID CRAPE MYRTLE	1	15 GAL	STANDARD	LOW
	SHRUBS					
S 1	RHAPHIOLEPIS U. 'MINOR'	YEDDO HAWTHORN		5 GAL		LOW
5 2	PHORMIUM H. 'JESTER'	HYBRID FLAX		5 GAL		LOW
5 3	ALOE MACULATA	SOAP ALOE		5 GAL		LOW
54	WESTRIMGIA F. 'MORNING LIGHT'	COAST ROSEMARY		5 GAL		LOW
95	NANDINA D. 'COMPACTA'	HEAVENLY BAMBOO		1 GAL		LOW
56	DIANELLA C. 'CASSA BLUE'	CASSA BLUE FLAX LILY		5 GAL		LOW
97	JUNCUS PATENS	CALIFORNIA GREY RUSH		5 GAL		LOW
58	PENNISETUM ORIENTALE	CHINESE FOUNTAIN GRASS		5 GAL		LOW
	GROUND COVERS	NATIVE MOULEDEE			-	1 000
GI	CALIFORNIA NATIVE SOD-DELTA BLUEGRASS			SOD	ļ	LOW
G2	SATUREJA DOUGLASII	YERBA BUENA		FLATS	18" O.C.	LOW


PLANT NOTES:


- THE CONTRACTOR SHALL VERIFY PLANT QUANTITIES FROM THE PLANTING PLAN. QUANTITIES SHOWN IN THE LEGEND ARE FOR CONVENIENCE ONLY.
- 2. NOTIFY THE LANDSCAPE ARCHITECT IMMEDIATELY IN THE EVENT OF ANY DISCREPANCIES BETWEEN ACTUAL SITE CONDITIONS AND THE PLANTING PLAN.
- 3. PLANT GROUNDCOVER IN SHRUB AREAS AS NOTED, USE TRIANGULAR SPACING.
- 4. SEE DETAIL AND SPECIFICATION SHEETS FOR ADDITIONAL INFORMATION.
- 5. THERE WILL BE NO MATERIALS OR PLANT MATERIALS SUBSTITUTIONS WITHOUT APPROVAL OF THE OWNER OR THE LANDSCAPE ARCHITECT.
- 6. IN THE EVENT OF ANY DISCREPANCIES BETWEEN THIS PLAN AND ACTUAL SITE CONDITIONS, THE LANDSCAPE ARCHITECT IS TO BE NOTIFIED IMMEDIATELY.
- ALL SITE UTILITIES ARE TO BE PROTECTED DURING CONSTRUCTION. IN THE EVENT OF CONFLICT BETWEEN THE PLANS AND UTILITIES THE CONTRACTOR SHALL NOTIFY THE LANDSCAPE ARCHITECT. ANY DAMAGE TO UTILITIES, STRUCTURES, OR OTHER FEATURES TO REMAIN, AND CAUSED BY THE LANDSCAPE CONTRACTOR SHALL BE REPLACED OR REPAIRED BY THE CONTRACTOR AT NO EXPENSE TO THE OWNER.
- 8. REFER TO CIVIL ENGINEER'S PLANS FOR OVERALL SITE GRADING AND DRAINAGE.
- PRIOR TO ANY DIGGING OR TRENCHING, CALL <u>UNDERGROUND SERVICE ALERT -</u> 1.800.227.2600

PLANT SYMBOLS


SXX INDICATES PLANT KEY NDICATES PLANT QUANTITY

FENCE DETAIL

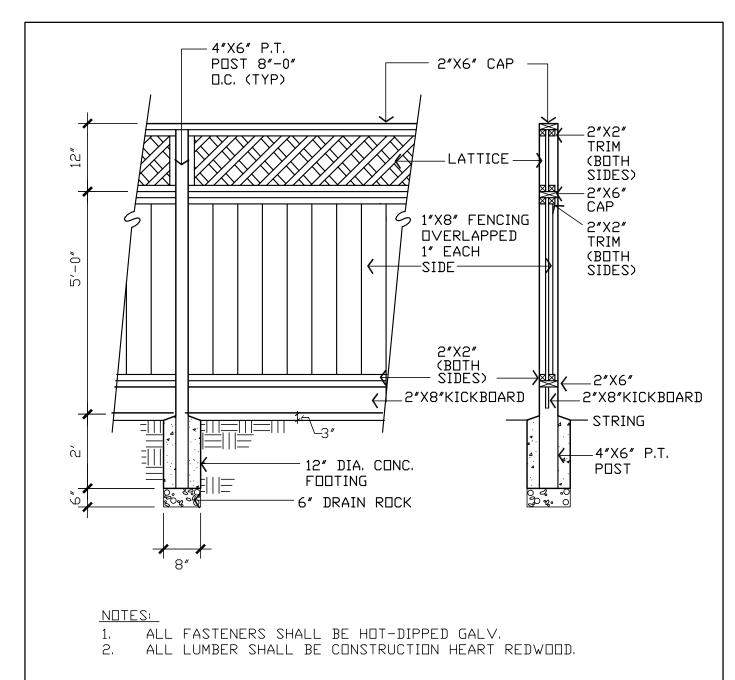

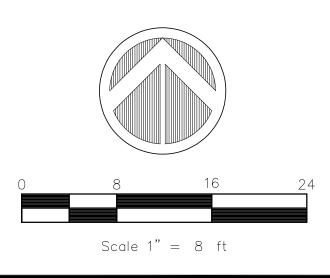



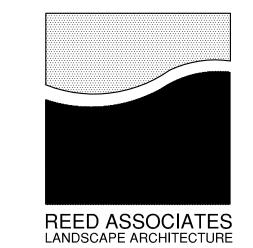

477 SOUTH TAAFFE STREET SUNNYVALE, CALIFORNIA 94086

408.481-9020 / 408.481-9022 FAX web: www.rala.net / email: paul@rala.net

E. HOMESTEAD HOMES PROJECT

> E. HOMESTEAD SUNNYVALE, CA




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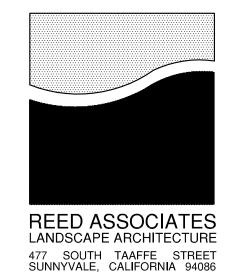
Approved PJR Drawn Reviewed Project No. 18.41

Issue Date 05.14.18

Scale

LANDSCAPE PLANTING PLAN



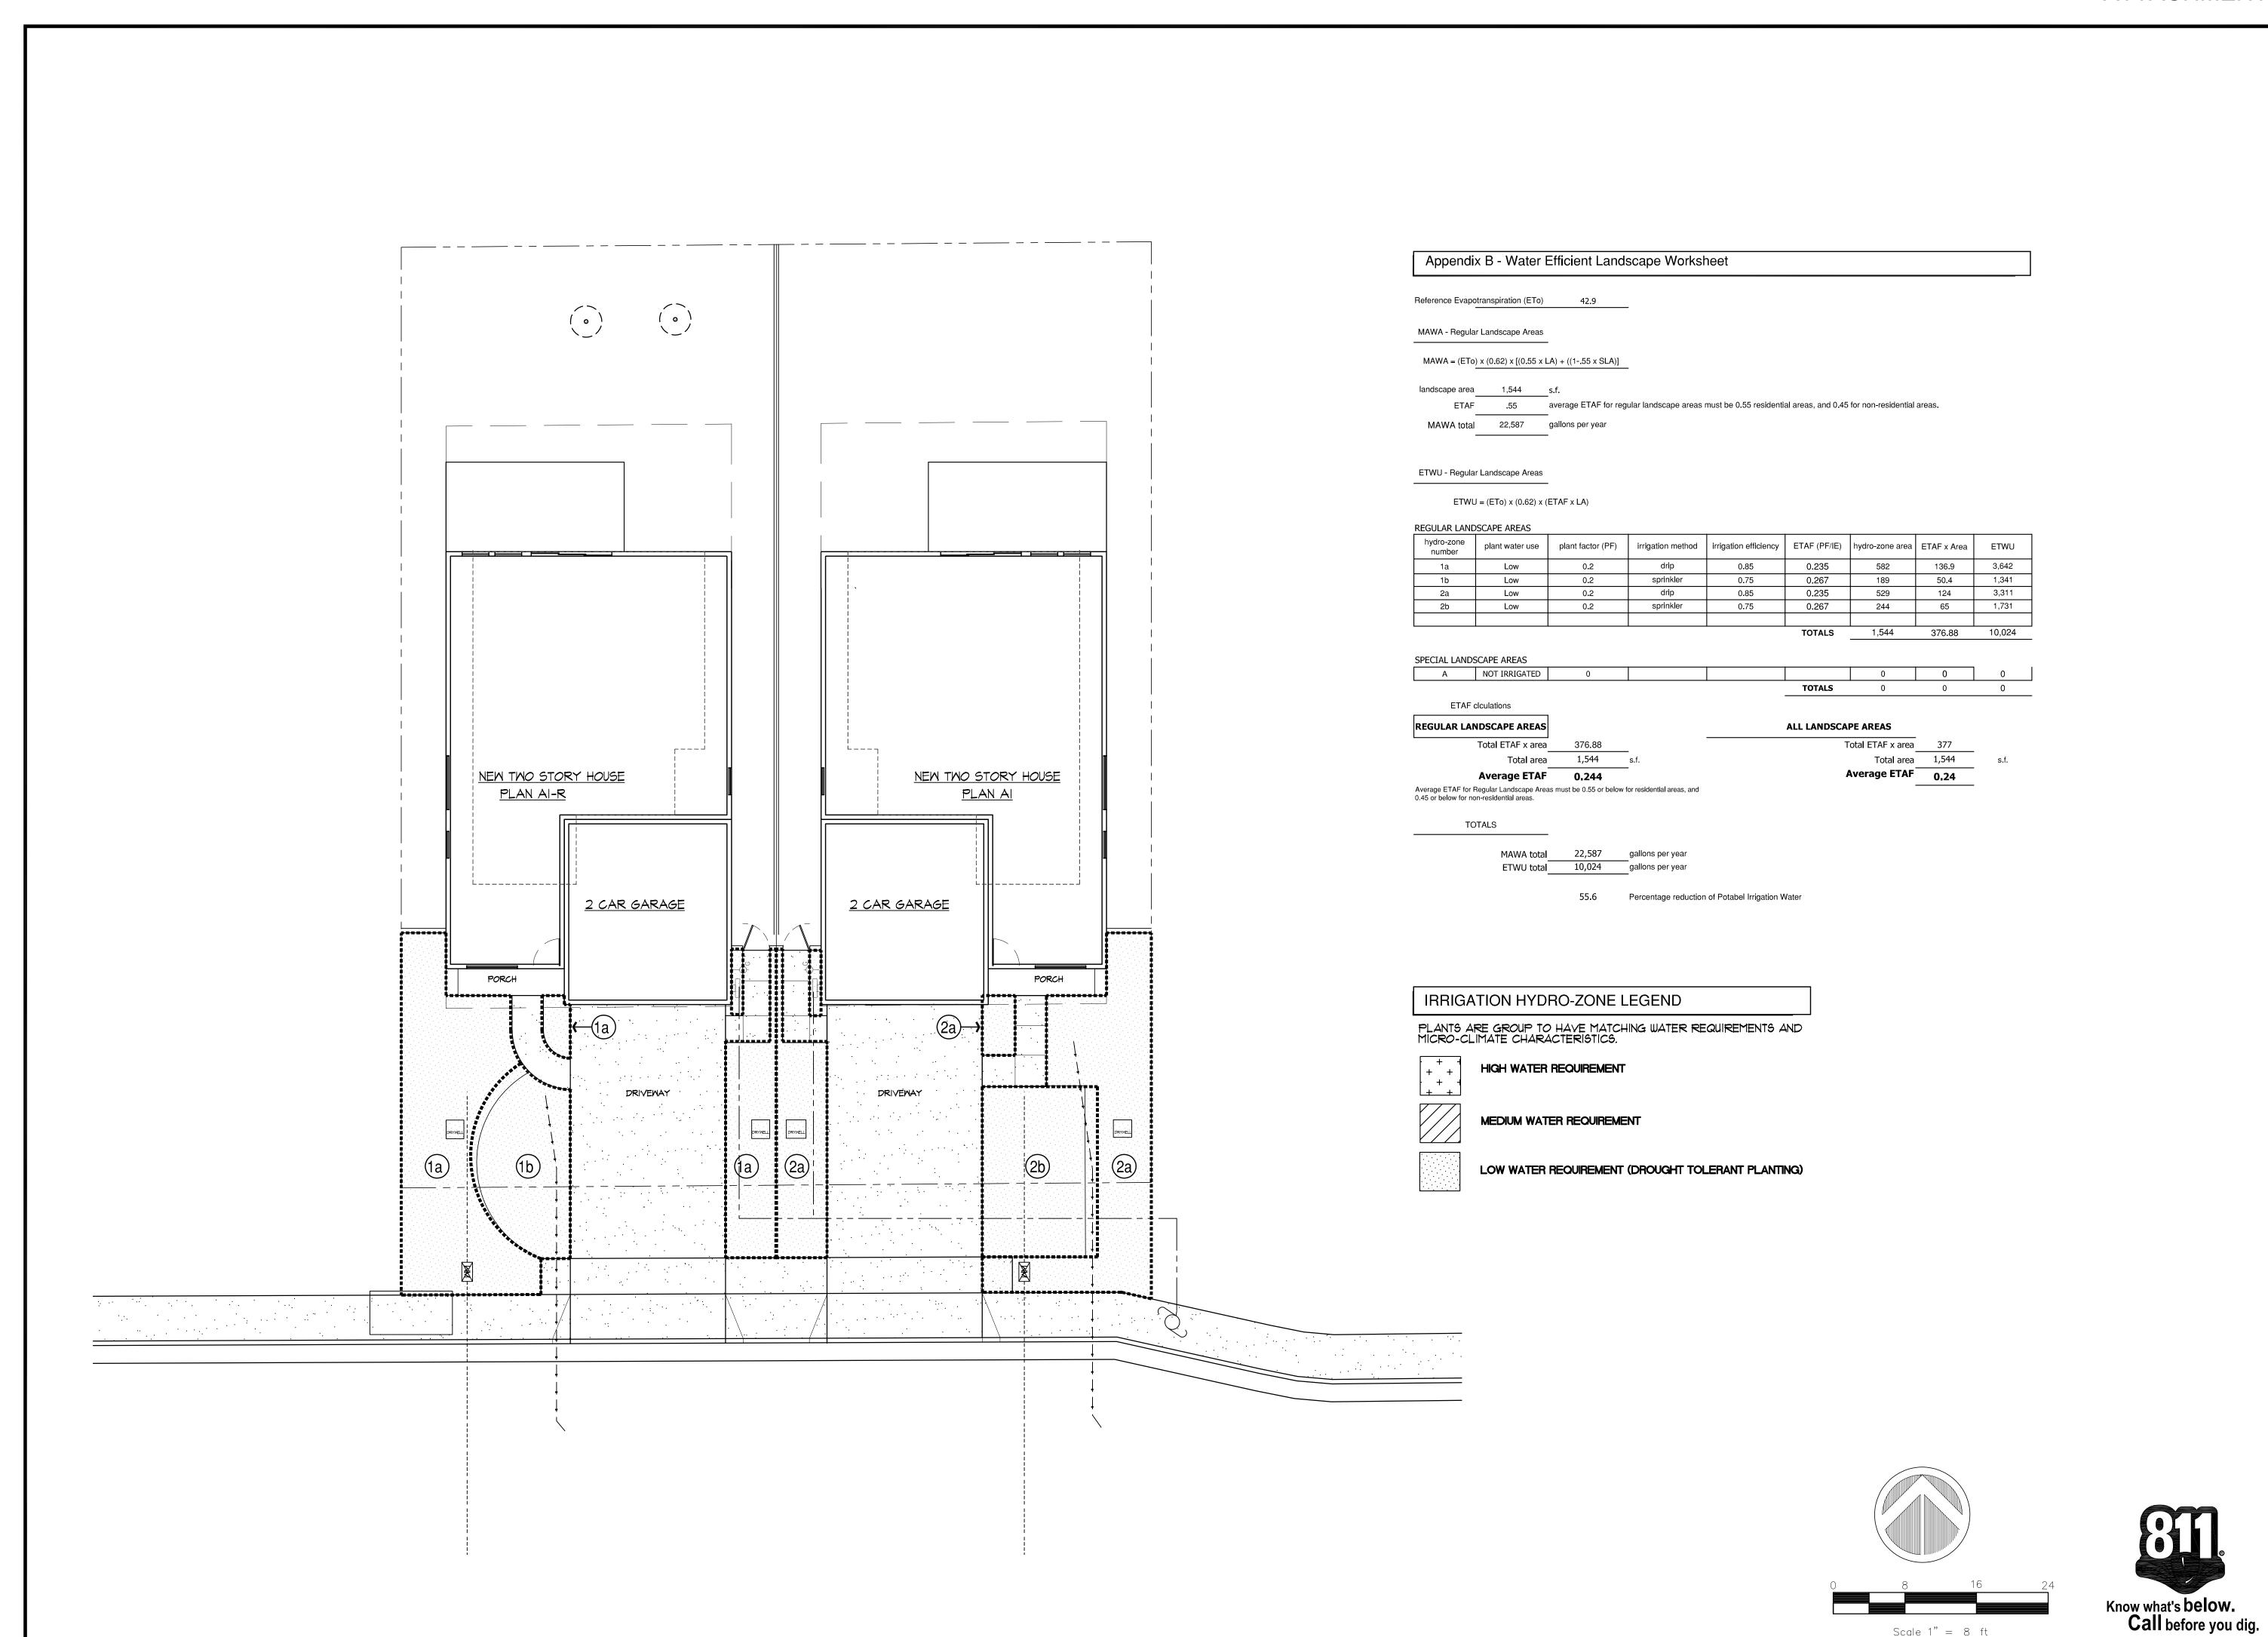

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E. HOMESTEAD

HOMES PROJECT

E. HOMESTEAD SUNNYVALE, CA



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 Approved
 PJR

 Drawn
 JH
 Reviewed
 PJR

 Project No.
 18.41

 Scale
 1/8"=1'-0"
 Issue Date
 05.14.18

LANDSCAPE HYDROZONE PLAN

L2.0

heet 0