

Kikuchi + Kankel Design Group

Landscape Architecture Environmental Design Site Planning

730 Mill Street Half Moon Bay, CA 94019 (650) 726-7100

www.kkdesigngroup.com

REAR YARD COVER STRUCTURE

OKUMURA **RESIDENCE**

1630 MANITOBA DRIVE SUNNYVALE, CA

APN: 323-22-044

NOT FOR CONSTRUCTION

Revisions:


Date: 12/11/2018 Scale: 1/8" = 1'-0"

Drawn By:


REVIEW

SITE PLAN & PROJECT DATA

Sheet No.

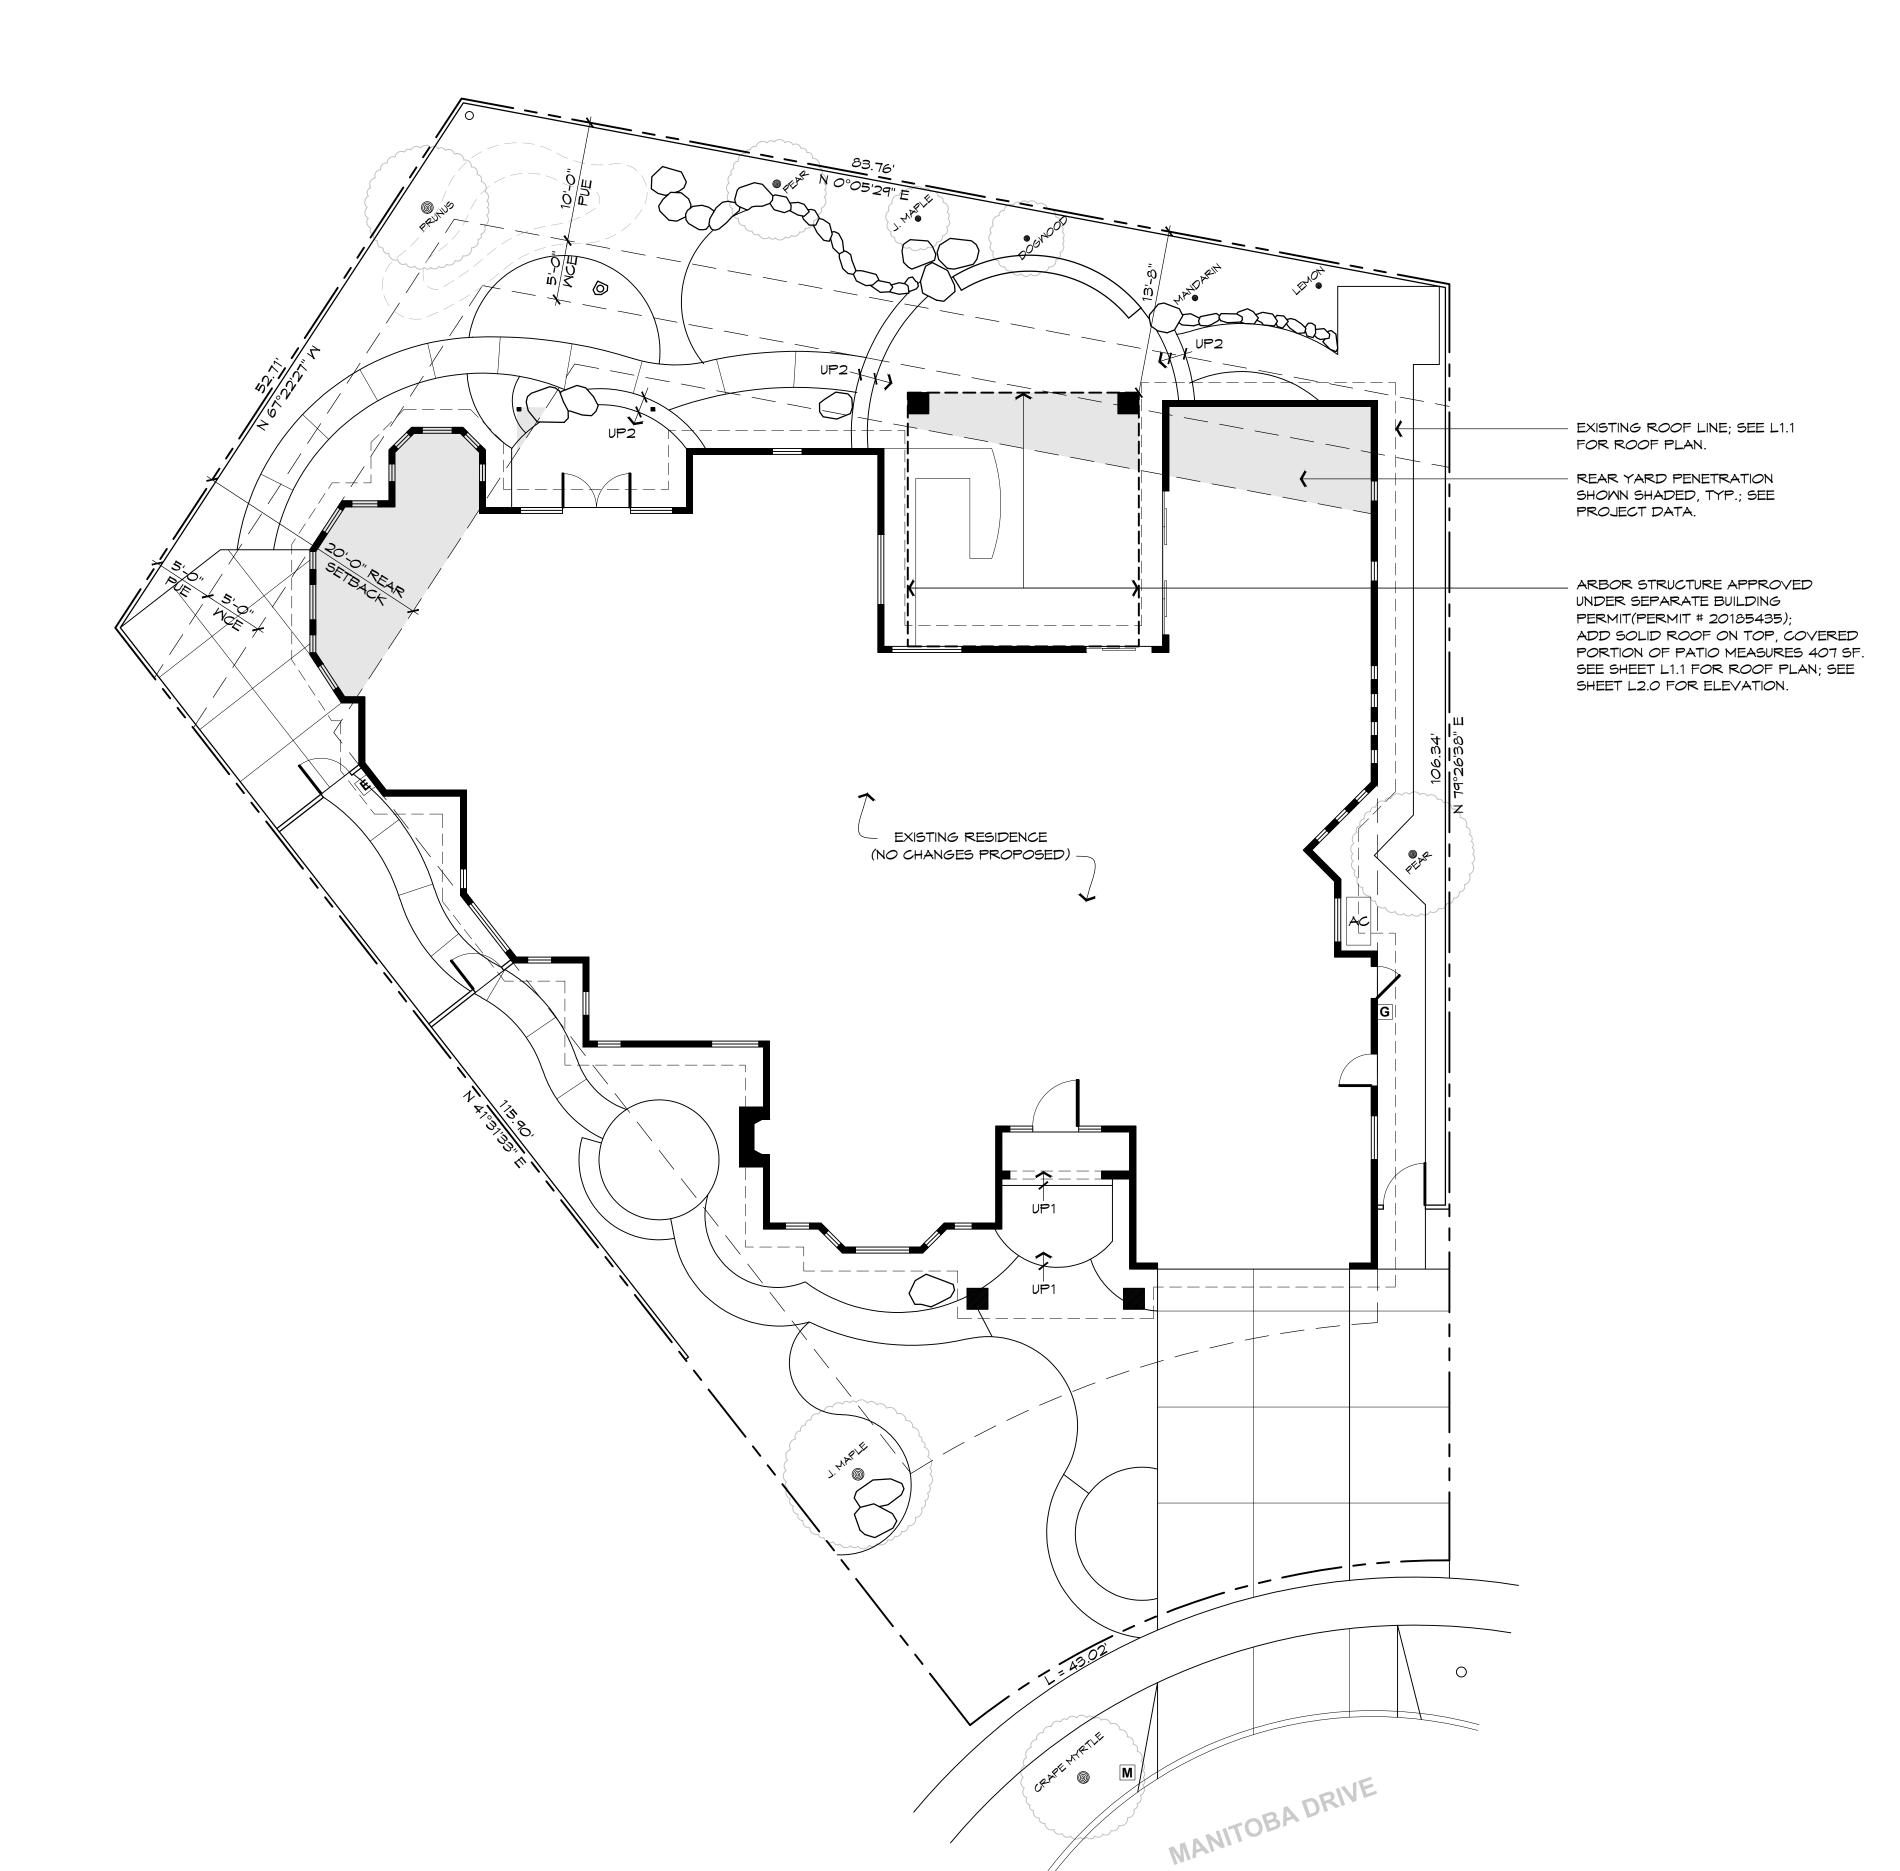

VICINITY MAP

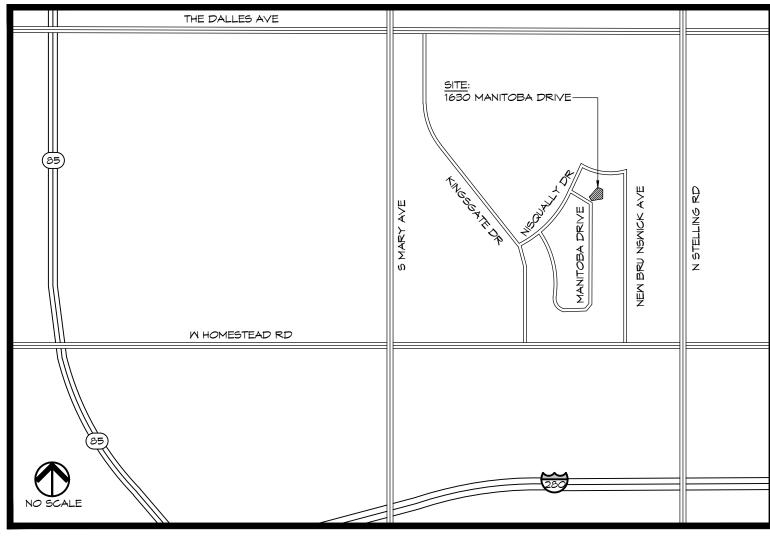

PROJECT DIRECTORY

Owners: KEN & DONNA OKUMURA 1630 MANITOBA DRIVE, SUNNYVALE, CA 94087 EMAIL: kkokumura@yahoo.com

Landscape Architect: KIKUCHI + KANKEL DESIGN GROUP Steven T. Kikuchi 730 MILL STREET HALF MOON BAY, CA 94019

SCOPE OF WORK

· ADD SOLID ROOF OVER REAR YARD ARBOR STRUCTURE PREVIOUSLY APPROVED UNDER SEPARATE BUILDING PERMIT(PERMIT # 20185435).

PROJECT DATA

· ZONING DISTRICT

<u>FLOOR AREA</u> TOTAL LOT AREA: EXISTING FLOOR AREA: FLOOR AREA TO BE ADDED:

PROPOSED TOTAL FLOOR AREA: PROPOSED TOTAL FLOOR AREA RATIO: MAXIMUM ALLOWED FLOOR AREA RATIO:

· LOT COVERAGE TOTAL LOT AREA: EXISTING LOT COVERAGE:

(* EXISTING LOT COVERAGE MATCHES TOTAL LOT COVERAGE APPROVED UNDER SEPARATE BUILDING PERMIT, PERMIT # 20185435.) LOT COVERAGE TO BE ADDED: PROPOSED TOTAL LOT COVERAGE: MAXIMUM ALLOWED LOT COVERAGE:

REAR YARD PENETRATION (NO CHANGE) TOTAL REAR YARD: EXISTING PENETRATION: MAXIMUM ALLOWED PENETRATION:

10,980 SF 4,531 SF = 41.3%

R1

10,980 SF

4,359 SF

4,766 SF

43.4%

407 SF (COVERED PATIO) 4,938 SF = 44.97% 4,941 SF = 45%

407 SF (COVERED PATIO)

2,568 SF (100%) 423 SF (16.5%) 642 SF (25%)

SHEET INDEX

L1.0 - SITE PLAN & PROJECT DATA L1.1 - ROOF PLAN L2.0 - REAR YARD ELEVATIONS

Kikuchi + Kankel Design Group

Landscape Architecture Environmental Design Site Planning

730 Mill Street Half Moon Bay, CA 94019 (650) 726-7100

www.kkdesigngroup.com

REAR YARD COVER STRUCTURE

OKUMURA RESIDENCE

1630 MANITOBA DRIVE SUNNYVALE, CA

APN: 323-22-044

NOT FOR CONSTRUCTION

Revisions:

Drawn By:

ROOF PLAN

Sheet No.

