

Michael Kalish

“Sunflower Sky”

Sunrise Senior Living
Sunnyvale, California



“Sunflower Sky” by Artist Michael Kalish

Being on the forefront of large scale interactive public art, I have always been drawn to the experience as much as the design and fabrication – pushing the interaction between the viewer and the sculpture.

With “Sunflower Sky,” my intention is to create a visually stimulating installation that will not only beautify the space, but seamlessly fit into the surrounding landscape as if it has grown from the ground to become part of the environment. Sculpted flowers, specifically *Roses*, have been part of my artistic vocabulary for over 25 years. This array of Sunflowers will be stacked and arranged on powder coated stems sprouting from the ground to create an interactive canopy of color. The details in the laser cut flowers will also create a secondary dynamic sculpture made from the shadows on the ground created by sunlight passing through the individual flowers.

The installation will be located among the trees within a landscaped area, floating above the hardscape with benches, creating an oasis for residents, their families, and the public to spend time. The piece will be visually effective from the many perspectives at street level, as well as providing another viewing experience for the residents of Sunrise Senior Living from the rooms above.

“Sunflower Sky” will be fabricated from intricately dozens of water jet cut aluminum parts and then treated with a military grade powder coating which I have used extensively to withstand extreme weather conditions. The piece will be low maintenance, requiring only a medium pressure washing as needed. The entire piece is assembled with mechanical fasteners rather than a welded construction, allowing for replacement or repair to any individual element in the event of a significant weather event. The overall scale of the piece is approximately 12’H X 17’W X 17’D.

Artist Rendering

Conceptual Image

Rendering 1



Rendering 2 Site with Tree Locations





Rendering 3
"Sunflower Sky" - upward view
12'H x 17'W x 17'D



Rendering 4
"Sunflower Sky" - downward view
12'H x 17'W x 17'D

SEAL



CONSULTANTS

PROJECT TITLE
SUNRISE OF CUPERTINO
581 E. FREMONT AVE., SUNNYVALE, CA



| ISSUED | | |
|--------|------------|--------------------------|
| # | DATE | DESCRIPTION |
| A | 2020-07-22 | INITIAL AGENCY SUBMITTAL |
| A | 2020-09-24 | BUILDING CORRECTION |
| B | 2020-11-16 | BUILDING CORRECTION |
| C | 2021-01-12 | BUILDING CORRECTION |

PROJECT IDENTIFICATION
THE DRAWINGS IN THE SHEET INDEX WERE ORIGINALLY CREATED IN AUTOCAD REVIT 2.0.00 UNLESS OTHERWISE NOTED.
THE ORIGINAL SIZE OF THIS SHEET IS 30" X 42".

THESE DRAWINGS AND SPECIFICATIONS ARE THE PROPERTY AND COPYRIGHT OF THE ARCHITECT AND SHALL NOT BE USED ON ANY OTHER PROJECT OR LOCATIONS EXCEPT AS DESCRIBED ON THE DRAWINGS, WITHOUT WRITTEN AGREEMENT WITH THE ARCHITECT.

© HPI ARCHITECTURE 2020

CITY APPROVAL



SHEET TITLE
OVERALL SITE PLAN

SHEET NUMBER

A1.01

CONSTRUCTION DOCUMENTS

1/11/2021 7:09:00 PM C:\Users\forded\Documents\Sunrise_Sunnyvale_2021_Central_2020\add_01

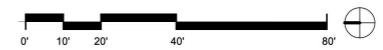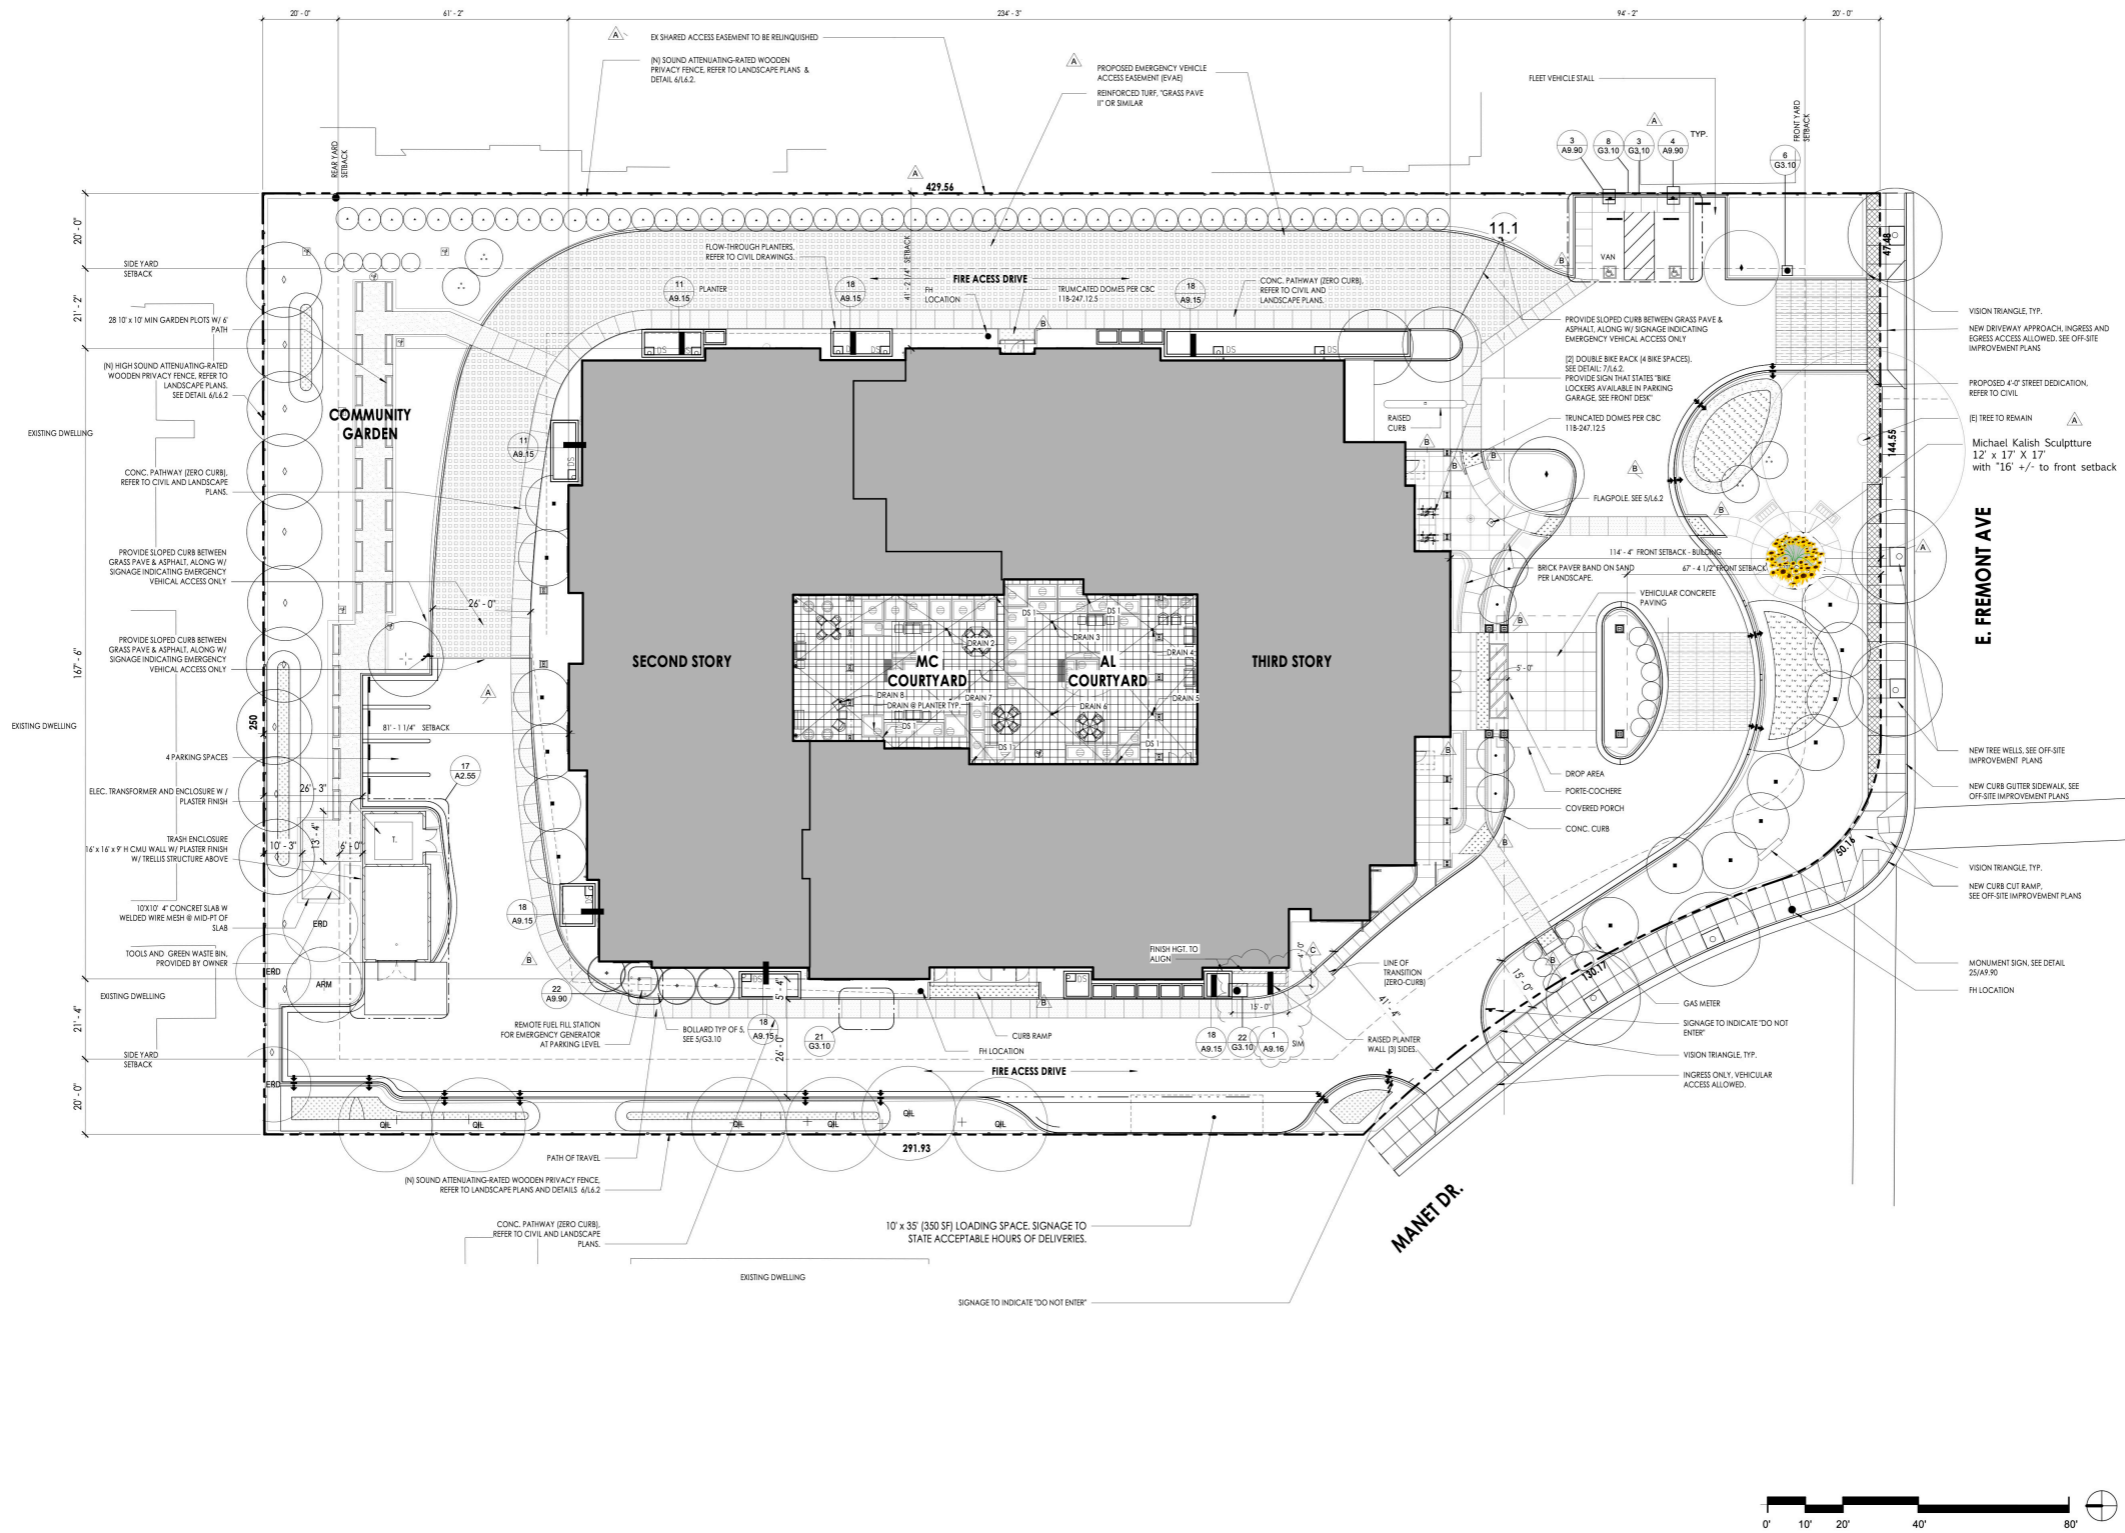

SITE PLAN SCALE 1/16" = 1'-0" 1

Related Work

Image 1, “Floral Sky,” rendering



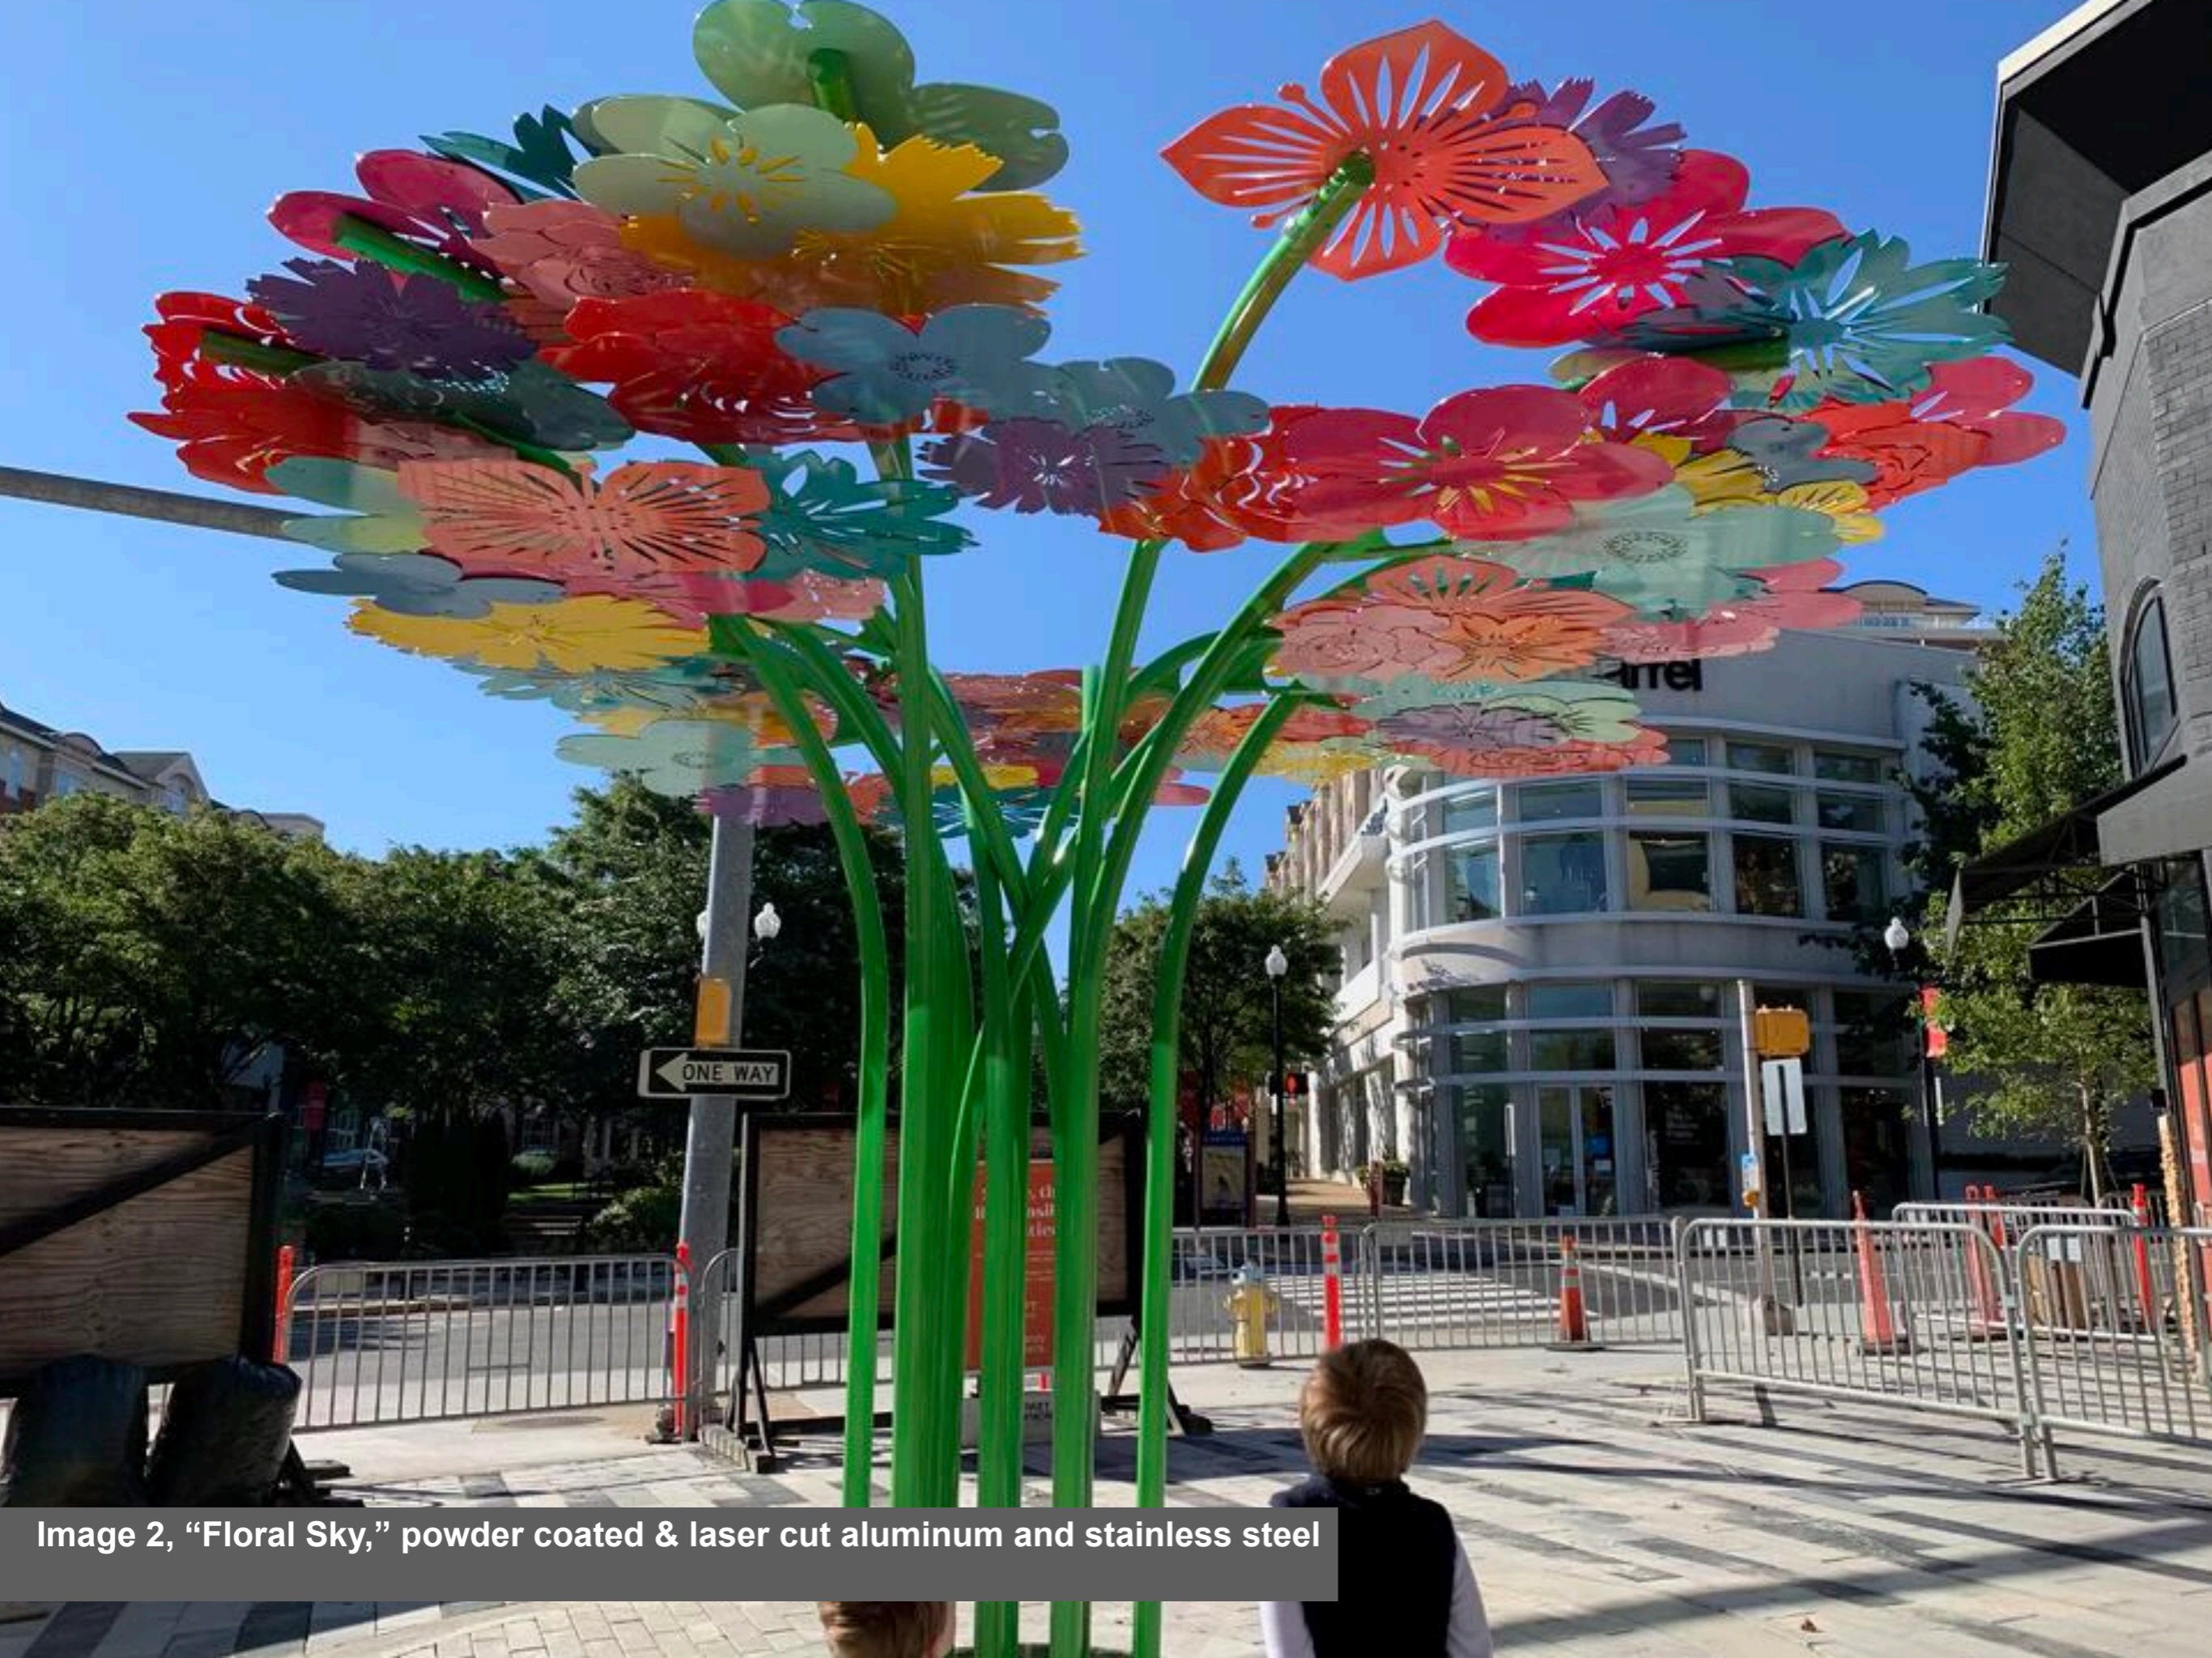


Image 2, "Floral Sky," powder coated & laser cut aluminum and stainless steel



Image 3, “Floral Sky,” powder coated & laser cut aluminum and stainless steel


LIGHTING DIAGRAM

MICHAEL KALISH SUNFLOWER SKY

(4) KISHLER 15788CBR ARTICULATING WELL LIGHTS - FLUSH MOUNT

SCULPTURE TO BE UPLIT FROM RESERVOIR IN HARDSCAPE.

NOTE: FINAL DIMENSION OF SPAN BETWEEN HOUSINGS MAY
BE CHANGED FOLLOWING ARMATURE ENGINEERING

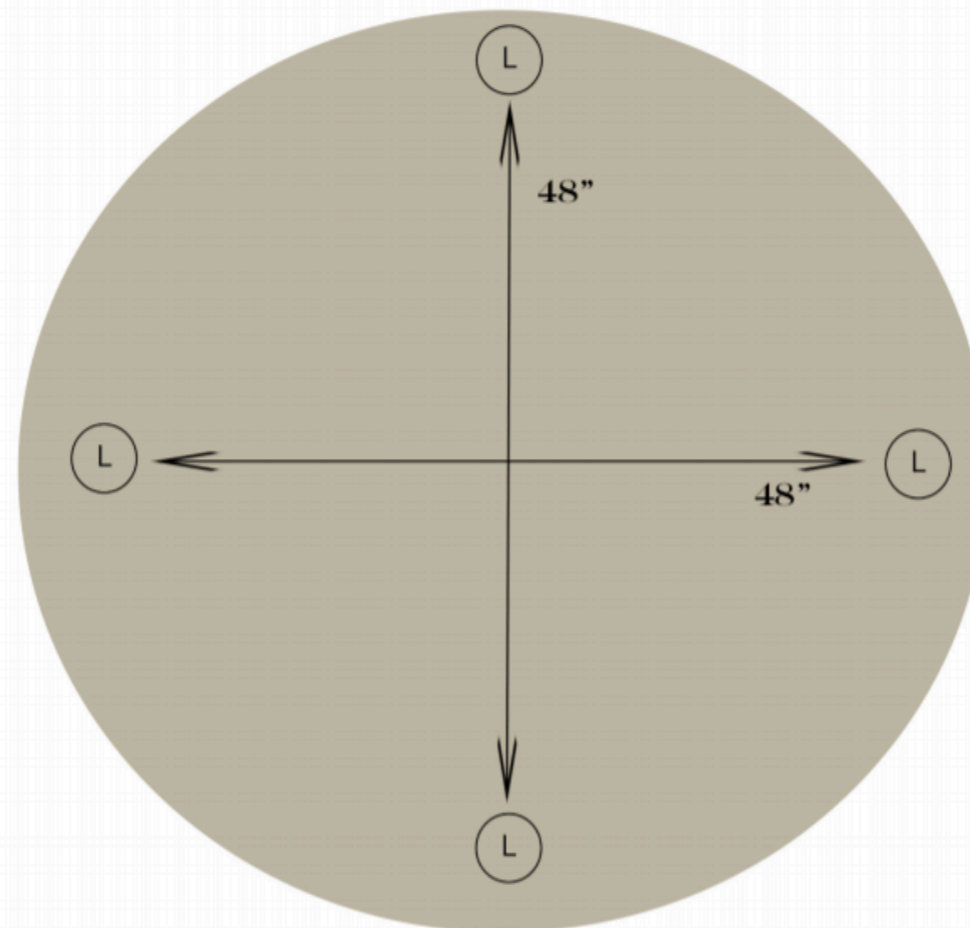

60" DIAMETER ARMATURE RESERVOIR

(L) — LIGHT

TOP VIEW

Articulating Well Light with Brass Trim Centennial Brass

15788CBR (Centennial Brass)

Project Name: _____

Location: _____

Type: _____

Qty: 4

Comments: _____



Certifications/Qualifications

| | |
|-----------------|--|
| Location Rating | Wet |
| | www.kichler.com/warranty |

Dimensions

| | |
|--------|-------|
| Height | 6.25" |
| Length | 6.75" |
| Width | 6.25" |

Electrical

| | |
|-------------------------|-----------------|
| Input Voltage | Dual (120/140)V |
| Operating Voltage Range | 12 VAC |
| Voltage | 12V |

Mounting/Installation

| | |
|-----------------|-----------|
| Connector | Yes |
| Wire Connectors | Wire Nuts |

Primary Lamping

| | |
|------------------------|--------------|
| Lamp Included | Not Included |
| Lamp Type | MR16 |
| Light Source | LED |
| # of Bulbs/LED Modules | 1 |

Product/Ordering Information

| | |
|--------|--------------|
| SKU | 15788CBR |
| Finish | Brass |
| UPC | 783927586290 |

Specifications

| | |
|----------|-------|
| Material | BRASS |
|----------|-------|

Additional Finishes



Centennial Brass

Kichler

7711 East Pleasant Valley Road Cleveland, Ohio 44131-8010
Toll free: 866.558.5706 or kichler.com

Notes:

1) Information provided is subject to change without notice.
All values are design or typical values when measured under laboratory conditions.
2) Incandescent Equivalent: The incandescent equivalent as presented is an approximate number and is for reference only.

KICHLER®