QIU RESIDENCE ADDITION

878 MCKINLEY AVE, SUNNYVALE, CA 94086



RESPONSIBILITIES TO DESIGN—BUILD ALL ELEMENTS AND

MAKE NECESSARY ADJUSTMENTS AS REQUIRED FOR THE

COMPLETION OF THE PROJECT IN ITS ENTIRETY PURSUANT

TO ALL APPLICABLE CODE REQUIREMENTS, TRADE AND

WORKMANSHIP STANDARDS. ALL CONTRACTORS SHALL

HOLD HARMLESS THE DESIGNER AND THE OWNER FROM ALL

OTHERWISE

V.I.F. VERIFY IN FIELD

WIDTH

G.C.

GDR

CONTRACTOR

GENERAL

GIRDER

THE OMISSIONS OF THE CONTRACTOR OR

SUBCONTRACTORS PERFORMING ANY OF THE WORK FOR

CONFORMANCE WITH THE PLANS AND SPECIFICATIONS.

THE FAILURE OF ANY OF THEM TO CARRY OUT THE WORK IN

ALL ATTACHMENTS, CONNECTIONS OR FASTENINGS OF ANY

HOME DESIGN

(NEW, ADDITION AND REMODEL **DESIGNERS AND ENGINEERS**

1071 Kensington Drive, Fremont, CA 94539 Tel: (510) 709-7968 / Fax:(510) 252-1528 E-MAIL:TChomedesign@yahoo.com

STAMP/SIGNATURE:

DATE: 11-22-20

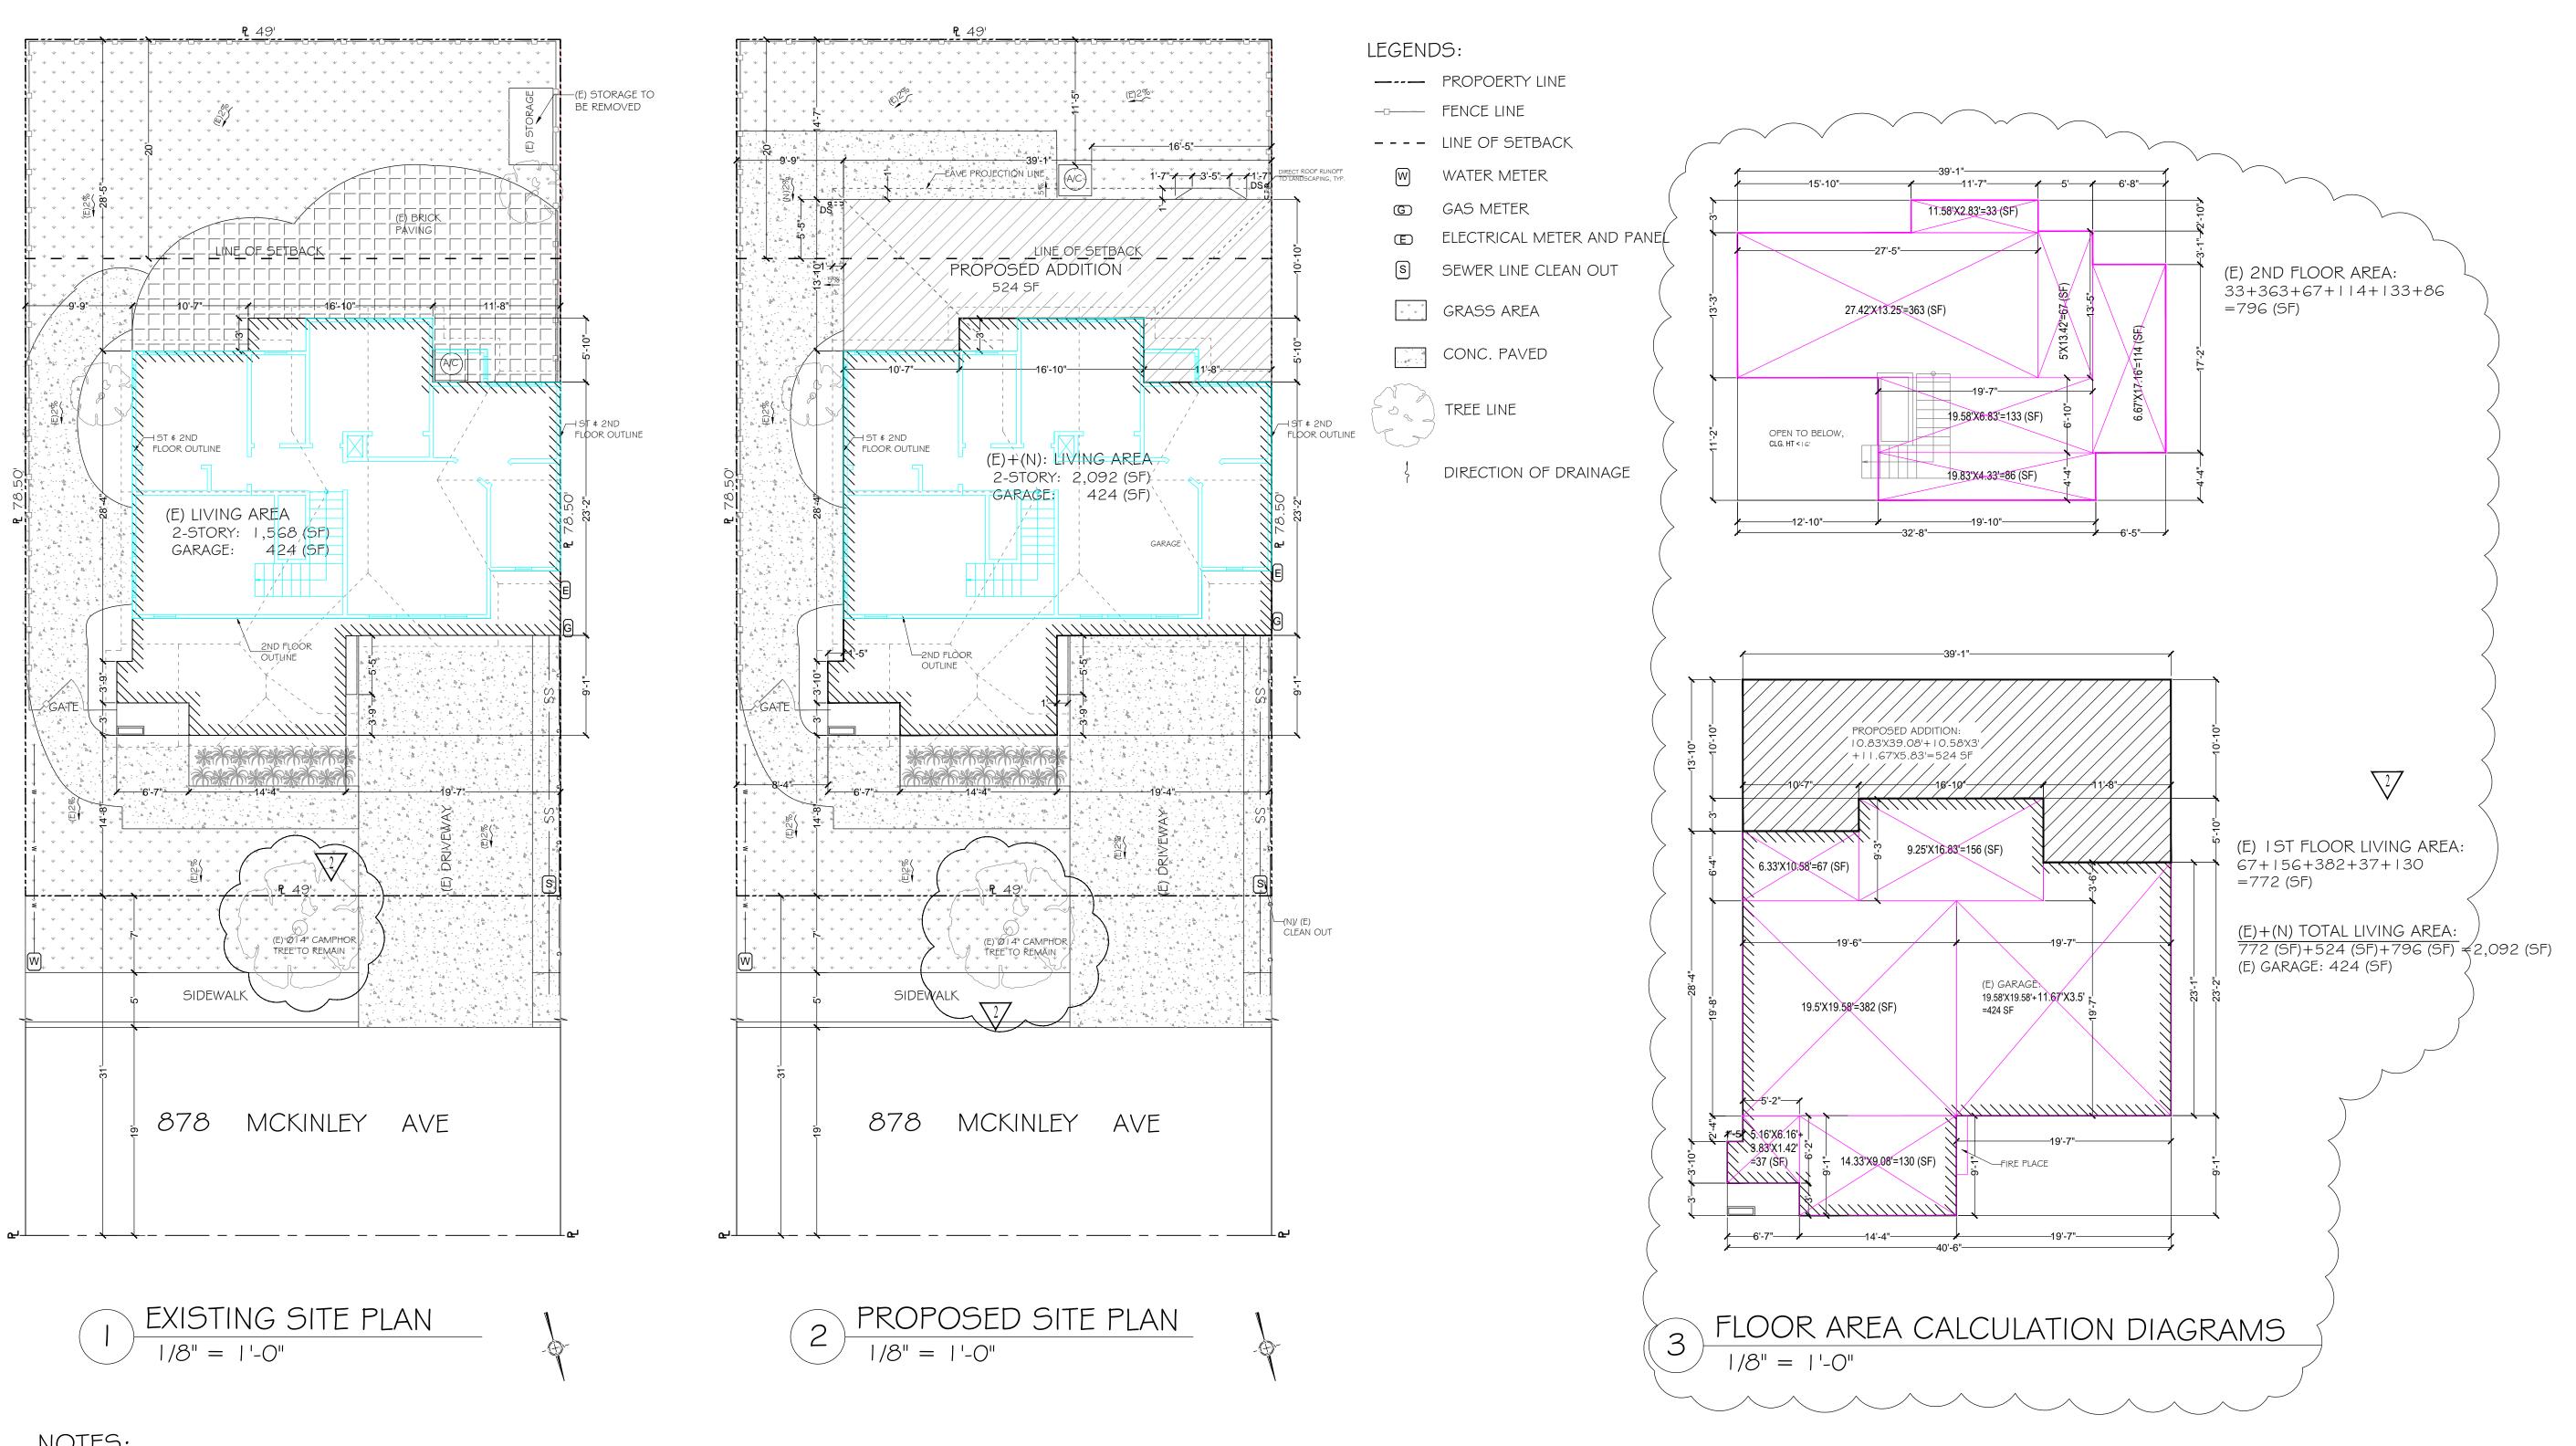
COVER SHEET REVISION

RESUBMIT: 11-22-20 ML

RESUBMIT: 1-30-21 ML

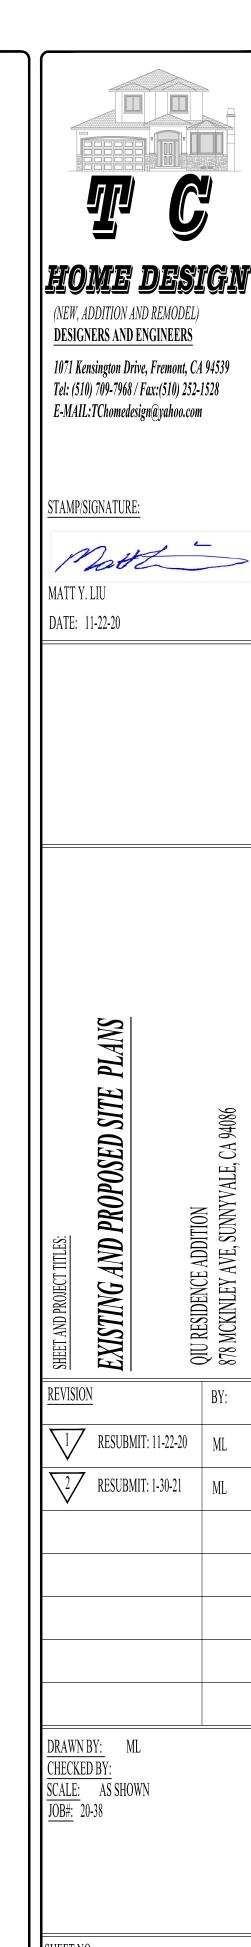
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INSPECTION DESCRIBING THE RESULTS OF THE INSPECTION.

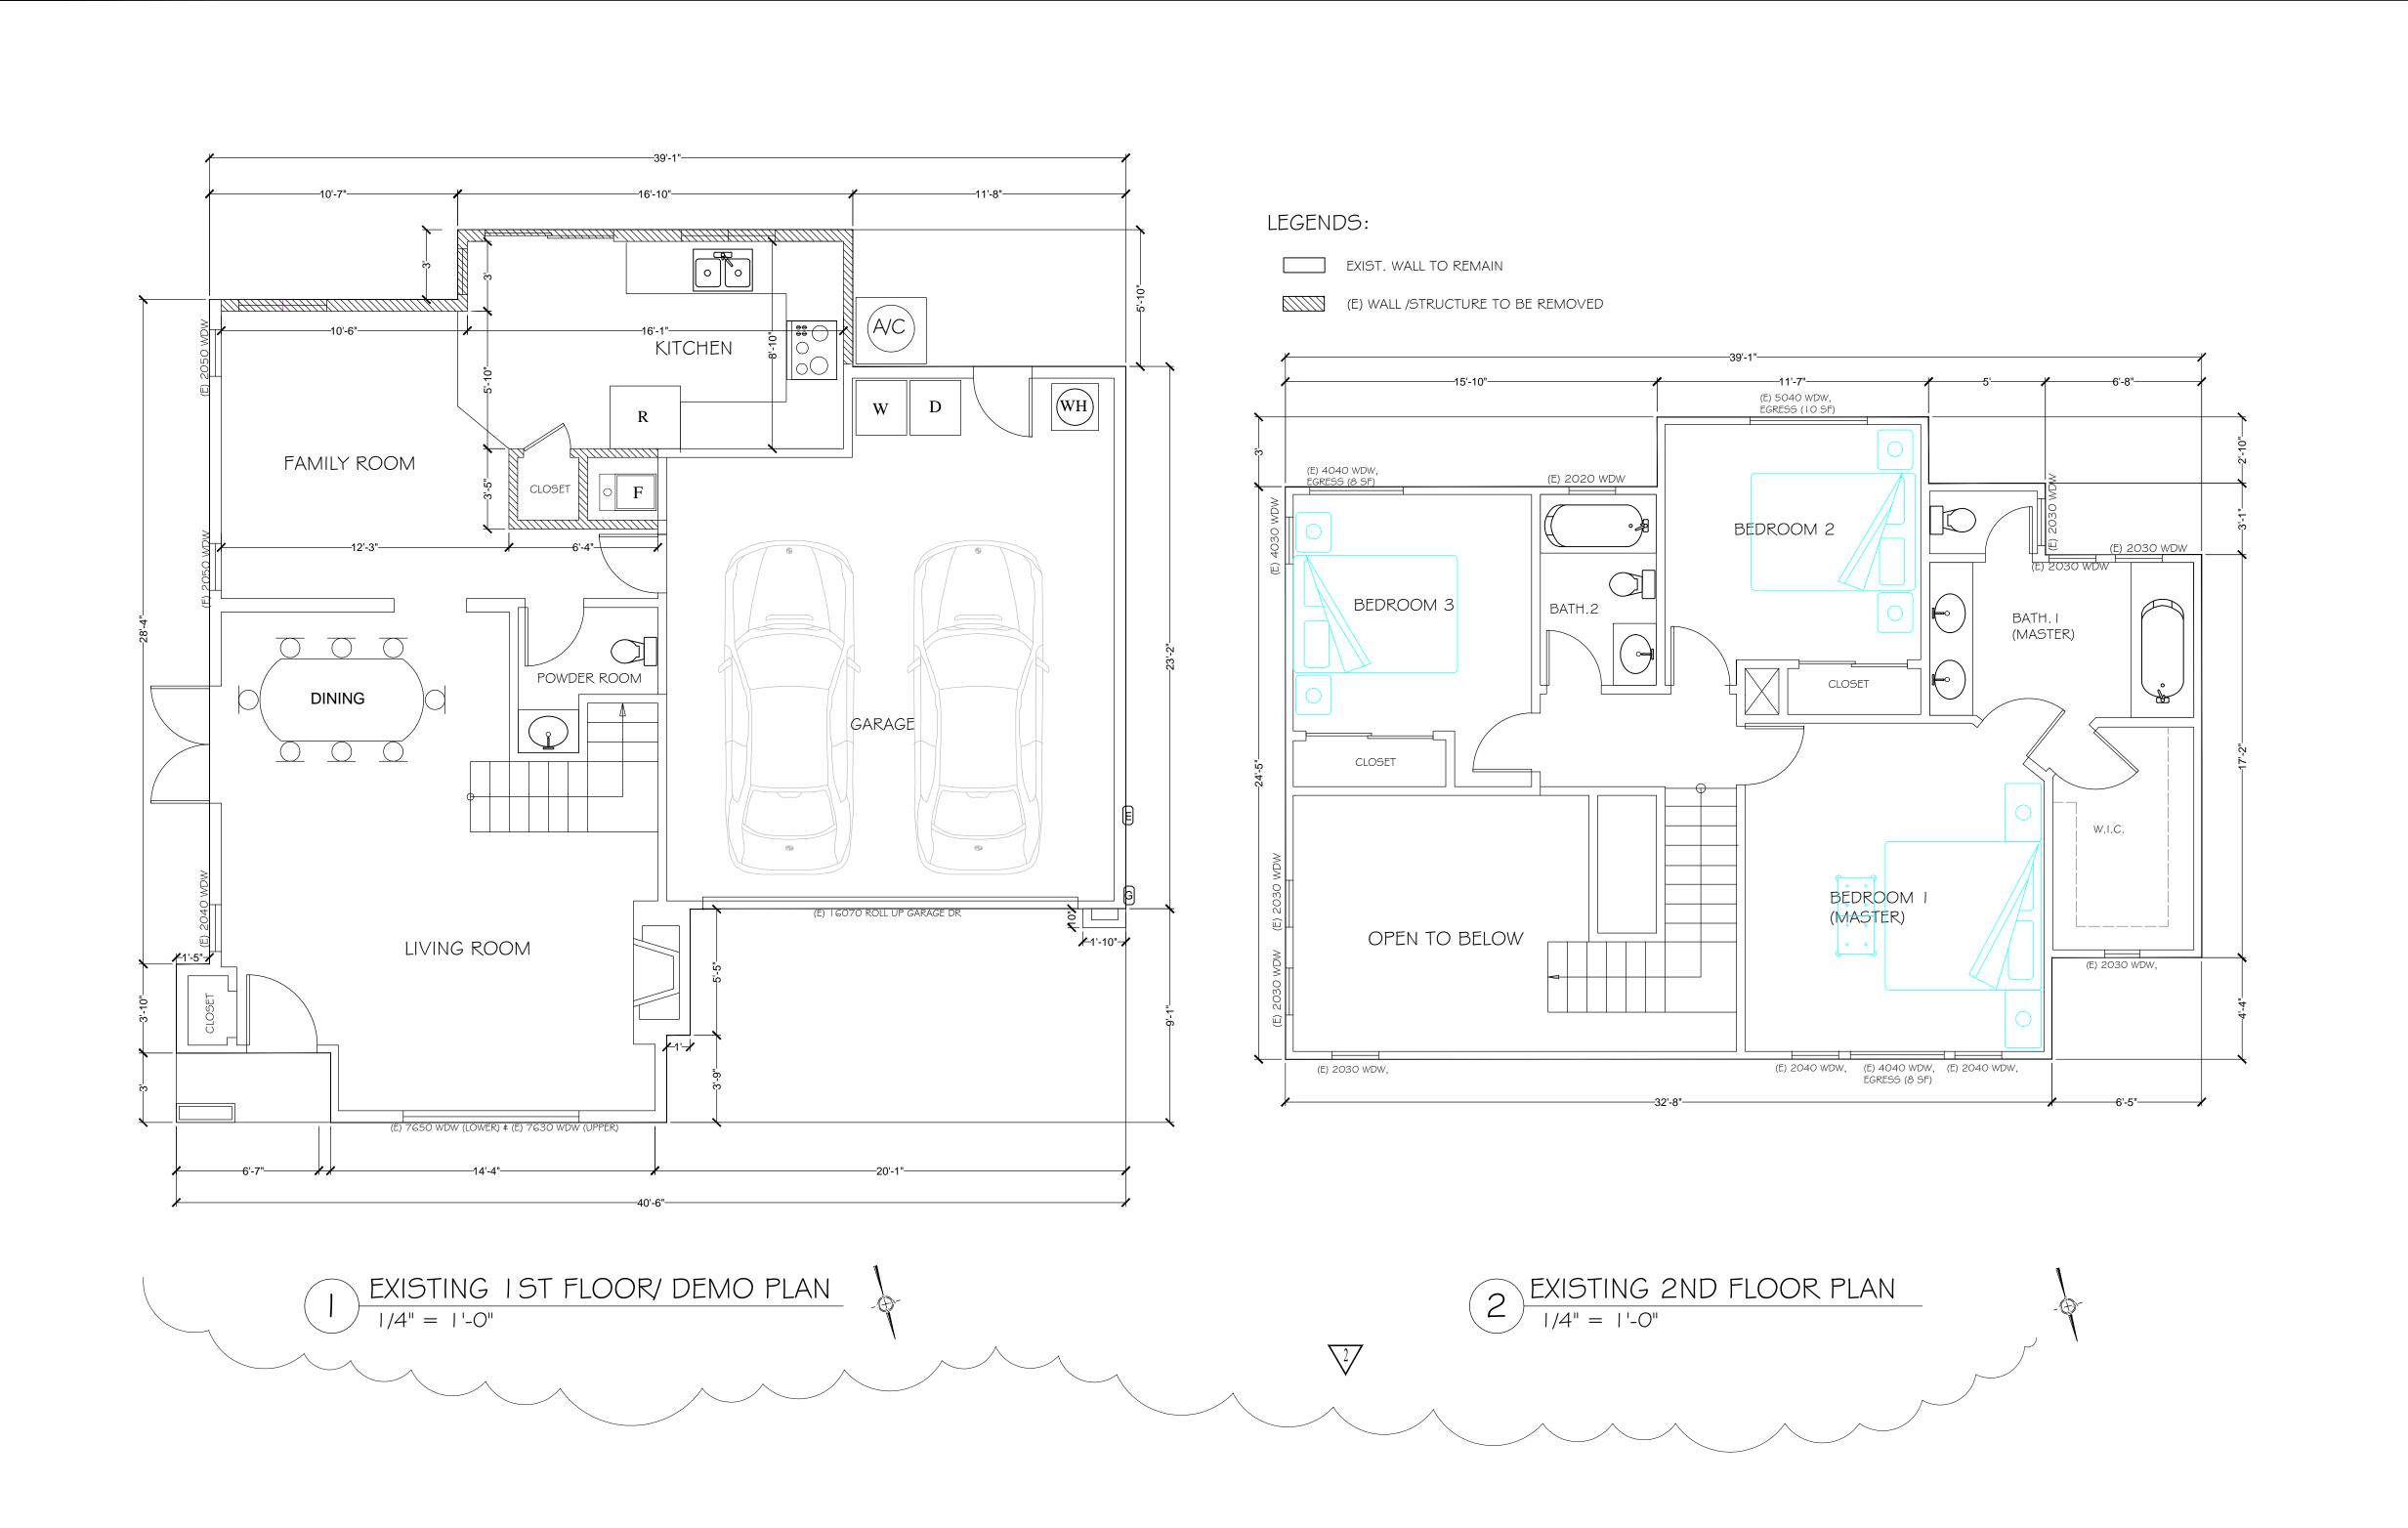


NOTES:

- I. THIS SITE PLAN IS BASED ON T C HOME DESIGN'S SITE MEASUREMENTS, AND THE SANTA CLARA
- COUNTY ASSESSOR'S PARCEL MAP BOOK 165, PAGE46.
- 2. ALL SITE MAIN FEATURES ARE DESCRIBED / SHOWN ON THIS PLAN.
- 3. THIS SITE PLAN IS FOR PLANNING AND BUILDING ADDITION PERMITS APPLICATION PURPOSE ONLY. 4. THIS SITE PLAN SHALL NOT BE USED AS A PROPERTY SURVEY DWG.
- 5. DO NOT SCALE DRAWINGS.



QIU RESIDENCE ADDITION 878 MCKINLEY AVE, SUNNYVALE, C





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EXISTING FLOOR PLANS

REVISION

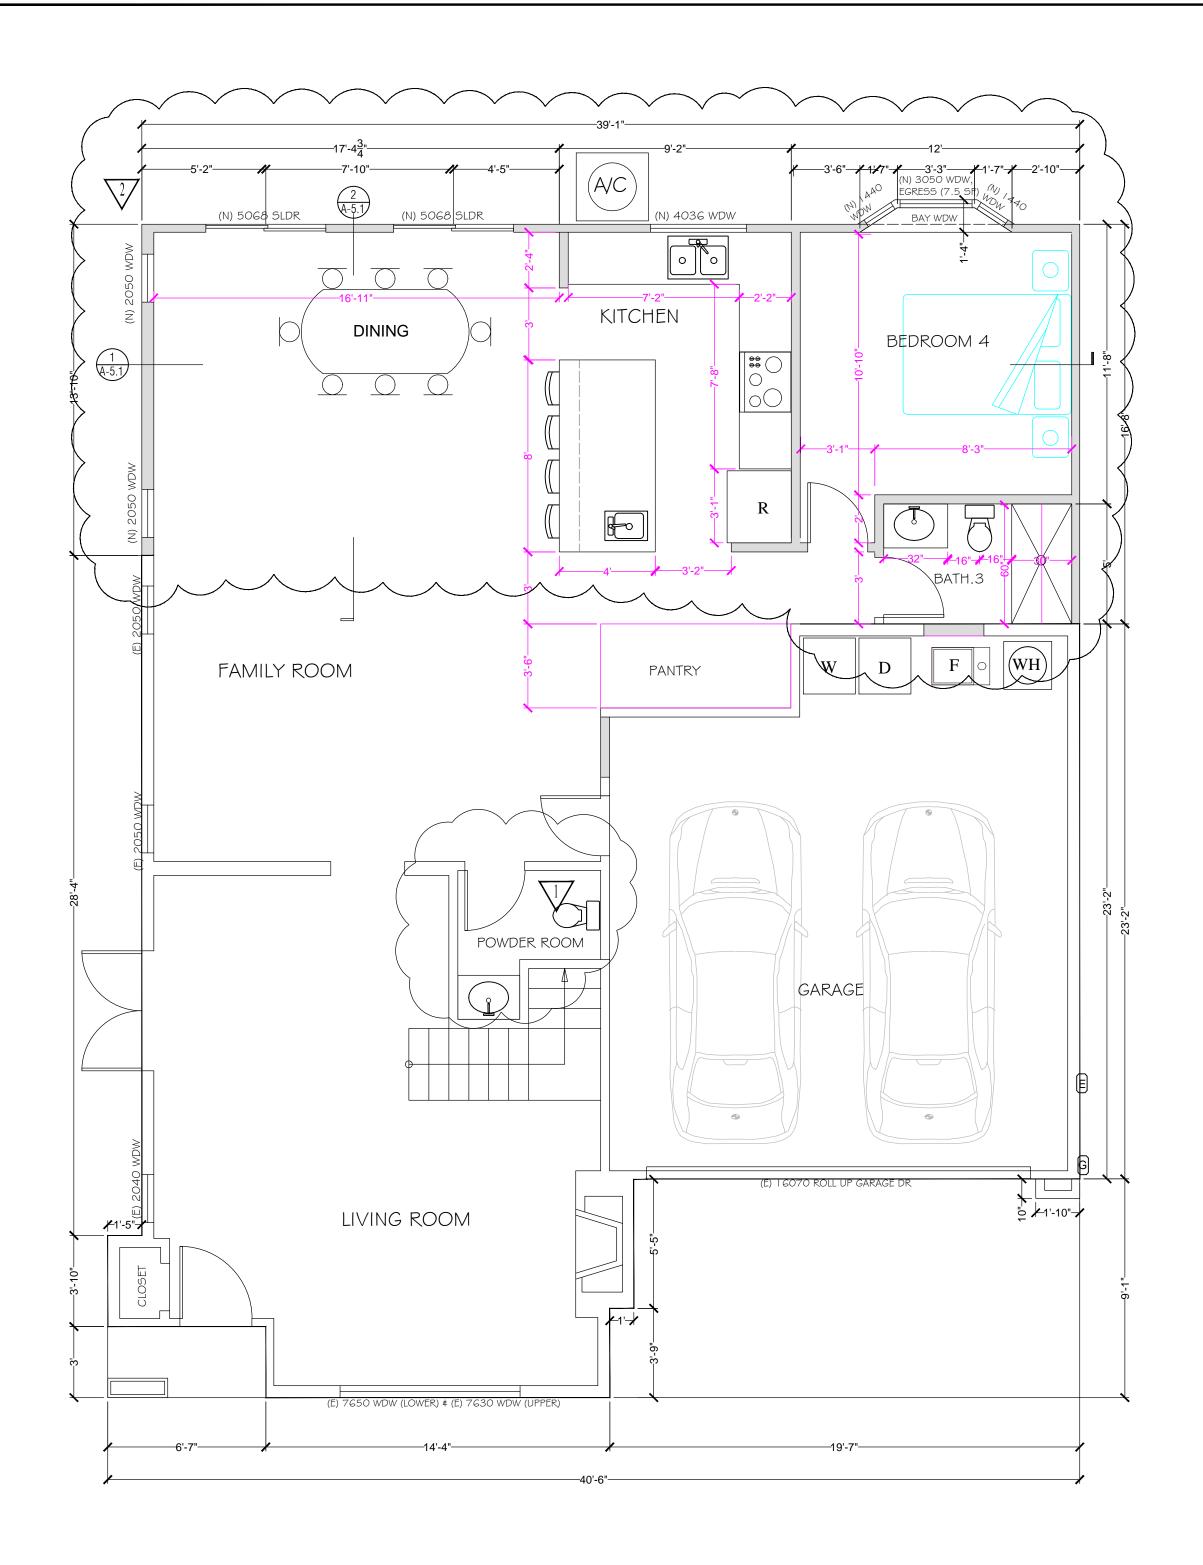
2 RESUBMIT: 1-30-21 ML

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SCALE: AS SHOWN
JOB#: 20-38

SHEET NO.:

A-2.1

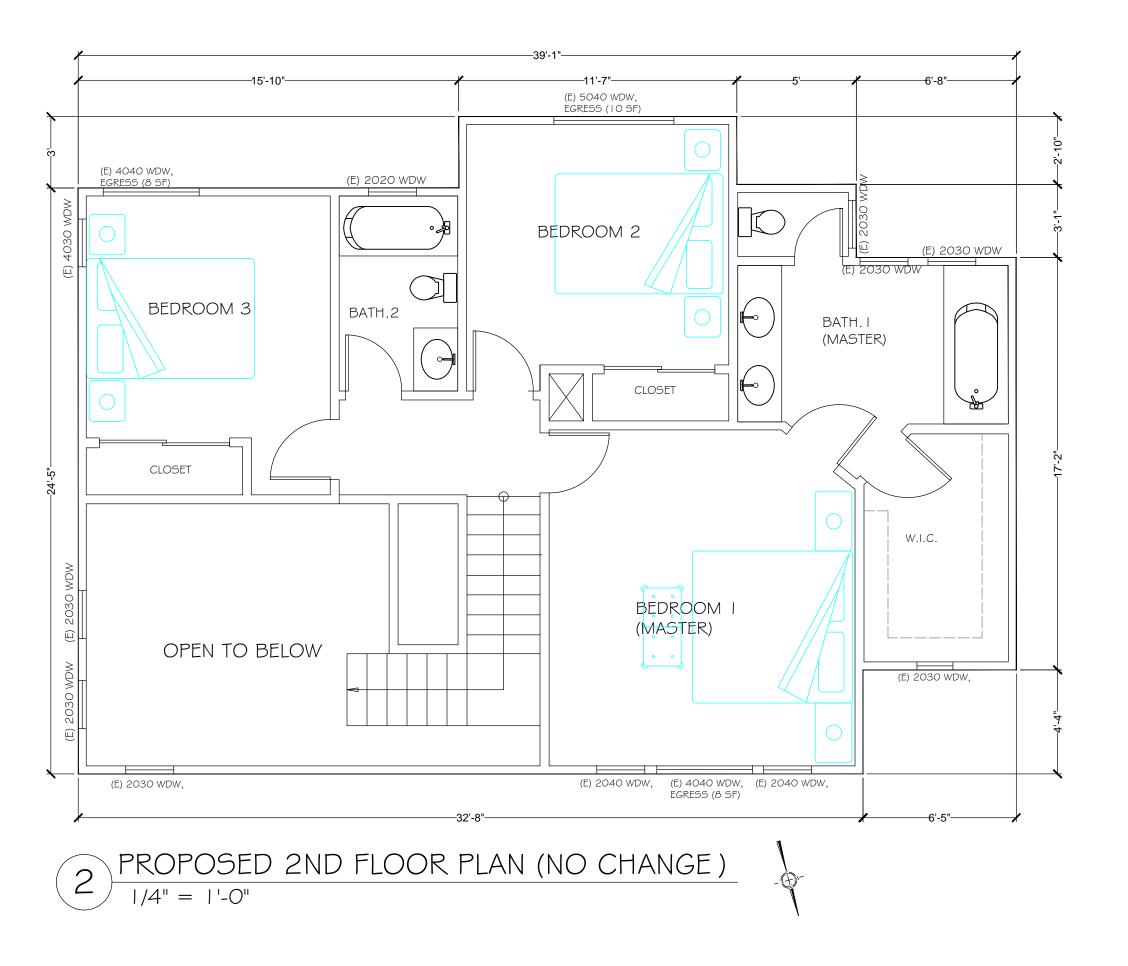




LEGENDS:

EXIST. WALL TO REMAIN

NEW WALL PER STRUCTURAL DWGS



BATHROOM INSTALLATION REQUIREMENTS:

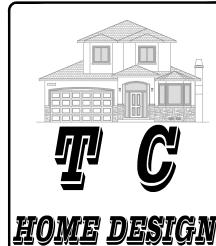
- SHOWER AND/OR TUB/SHOWER WALLS SHALL HAVE A SMOOTH, HARD, NONABSORBENT SURFACE (E.G., CERAMIC TILE, FIBERGLASS, ETC.) OVER A MOISTURE RESISTANT UNDERLAYMENT (E.G., WATER RESISTANT
- GYPSUM BOARD, GREEN BOARD, ETC.) TO A HEIGHT OF NOT LESS THAN 6' ABOVE THE FLOOR. CBC 1210.2 • ALL RECEPTACLES SHALL BE GFCI PROTECTED AND CONNECTED TO A DEDICATED 15 AND 20 AMPS CIRCUIT (CEC 210.8)
- A MINIMUM OF ONE HIGH EFFICACY LUMINAIRE SHALL BE INSTALLED IN EACH BATHROOM; AND ALL OTHER LIGHTING INSTALLED IN EACH BATHROOM SHALL BE HIGH EFFICACY OR CONTROLLED BY VACANCY SENSORS. (CEES 150.0 (K)(5))
- EXHAUST FANS AND LIGHTING SHALL HAVE SEPARATE CONTROL SWITCHES (EVEN IFS COMBINATION UNIT IS INSTALLED). THE EXHAUST FAN MAY NEED TO BE SUPPLIED BY A GFCI PROTECTED CIRCUIT BASED ON THE
- MANUFACTURER'S REQUIREMENTS. (CEES 150.0(O)) EXHAUST FANS ARE REQUIRED IN ALL BATHROOMS, EVEN IF AN OPERABLE WINDOW IS INSTALLED. (CA ENERGY EFFICIENCY STANDARDS SECTION 150)
- EXHAUST FANS SHALL TERMINATE A MINIMUM OF 3' FROM PROPERTY LINE AND 3' FROM OPENINGS INTO A BUILDING. (CMC 504.5) EXHAUST FANS AT SHOWER SHALL BE LISTED FOR WET LOCATION AND SHALL BE GFCI PROTECTED. (CEC 2 I O) UNLESS FUNCTIONING AS A COMPONENT OF A WHOLE HOUSE VENTILATION SYSTEM FANS MUST BE CONTROLLED BY A HUMIDITY CONTROL.
- SHOWER ENCLOSURE DOORS SHALL OPEN OUTWARD AND MAINTAIN 22" CLEARANCE (CPC 408.5). SHOWER COMPARTMENT SHALL BE A MINIMUM 1,024 SQUARE INCHES ENCOMPASSING A 30" CIRCLE. (CPC 408.) WATER CLOSETS (MAXIMUM 1.28 GPM) SHALL BE CLEAR 30 INCHES WIDE (15 INCHES CII CENTER) AND 24 INCHES IN FRONT.
- SHOWER HEADS (MAXIMUM 2.0 GPM) \$ FAUCETS (MAXIMUM 1.2 GPM) (CPC 403.0)
- BATHTUB/WHIRLPOOLS AND SHOWER VALVES SHALL BE APPROVED PRESSURE-BALANCED OR THERMOSTATIC MIXING TYPE ADJUSTED TO A MAXIMUM OF 120 DEGREES. (CPC 408.3)

KITCHEN INSTALLATION REQUIREMENTS:

- KITCHEN DOORS LEADING FROM THE GARAGE SHALL BE 1-3/8 THICK SOLID WOOD OR HONEY COMB CORE STEEL DOORS OR 20 MINUTE FIRE-RATED DOORS EQUIPPED WITH SELF-CLOSING AND SELF-LATCHING DEVICES. (CRC R302.5. I)
- MINIMUM OF 50% OF TOTAL RATED WATTAGE OF PERMANENTLY INSTALLED LIGHTING SHALL BE HIGH EFFICACY. (TITLE 24-- BUILDING ENERGY EFFICIENCY STANDARDS 150.0 (K))
- MINIMUM 30 INCHES CLEARANCE REQUIRED ABOVE KITCHEN RANGE, EXCEPT WHERE 24 INCHES IS ALLOWED PER CODE OR MANUFACTURER'S SPECIFICATION. (CIVIC 9 | 6.1.2)
- DOMESTIC DISHWASHING MACHINE SHALL NOT BE DIRECTLY CONNECTED TO A DRAINAGE SYSTEM OR FOOD WASTE DISPOSER WITHOUT THE USE OF AN APPROVED AIR GAP FITTING ON THE DISCHARGE SIDE OF THE MACHINE. (CPC 807.4)
- HOUSEHOLD COOKING APPLIANCES SHALL HAVE A VERTICAL CLEARANCE ABOVE THE COOKING TOP OF NOT LESS THAN THIRTY (30) INCHES TO COMBUSTIBLE MATERIAL OR METAL CABINETS.
- EXHAUST DUCTS SHALL TERMINATE OUTSIDE THE BUILDING AND SHALL BE EQUIPPED WITH A BACK-DRAFT DAMPER PER CMC SECTION 504. I.
- ALL RECEPTACLES SHALL BE GFCI PROTECTED AND TAMPER-RESISTANT (TR).
- RECEPTACLES SHALL BE LOCATED SO THAT NO POINT IS MORE THAN 24 INCHES FROM A RECEPTACLE OUTLET MEASURED HORIZONTALLY ALONG THE WALL.
- RECEPTACLES SHALL BE LOCATED NO MORE THAN 20 INCHES ABOVE COUNTERTOP.
- ON THE DISCHARGE SIDE OF THE DISHWASHER PROVIDE A LISTED AIR GAP FITTING. LISTED AIR GAPS SHALL BE INSTALLED WITH THE FLOOD LEVEL (FL) MARKING AT OR ABOVE THE FLOOD LEVEL OF THE SINK OR DRAIN BOARD WHICHEVER IS HIGHER PER CPC SECTION 807.4.

WINDOWS INSTALLATION REQUIREMENTS:

- FENESTRATION SHALL BE LOW E AND DUAL PANE.
- MAXIMUM U-FACTOR OF 0.32, SHGC 0.25. • EMERGENCY EGRESS WINDOWS (BEDROOMS) SHALL HAVE A MINIMUM OF 5.0 SQUARE FEET OF CLEAR OPENING ON GRADE LEVEL FLOOR AND 5.7 SQUARE FEET ON SUBSEQUENT FLOORS, WITH A MINIMUM CLEAR OPENING WIDTH OF 20 INCHES AND HEIGHT OF 24 INCHES.
- GLAZING SHALL BE TEMPERED IF
- A. LOCATED IN THE WILDLAND URBAN INTERFACE AREA
- B. LOCATED LESS THAN 60 INCHES MEASURED VERTICALLY ABOVE WALKING SURFACE OF SHOWER/TUB/STEAM ROOMS, ETC.
- C. LOCATED IN HAZARDOUS LOCATIONS AS INDICATED PER CRC R308.4.
- PROVIDE FALL PREVENTION DEVICE IF THE OPENING IS LOCATED MORE THAN 72 INCHES ABOVE THE FINISHED GRADE AND THE LOWEST PART OF CLEAR OPENING IS LESS THAN 24 INCHES ABOVE FINISHED FLOOR.



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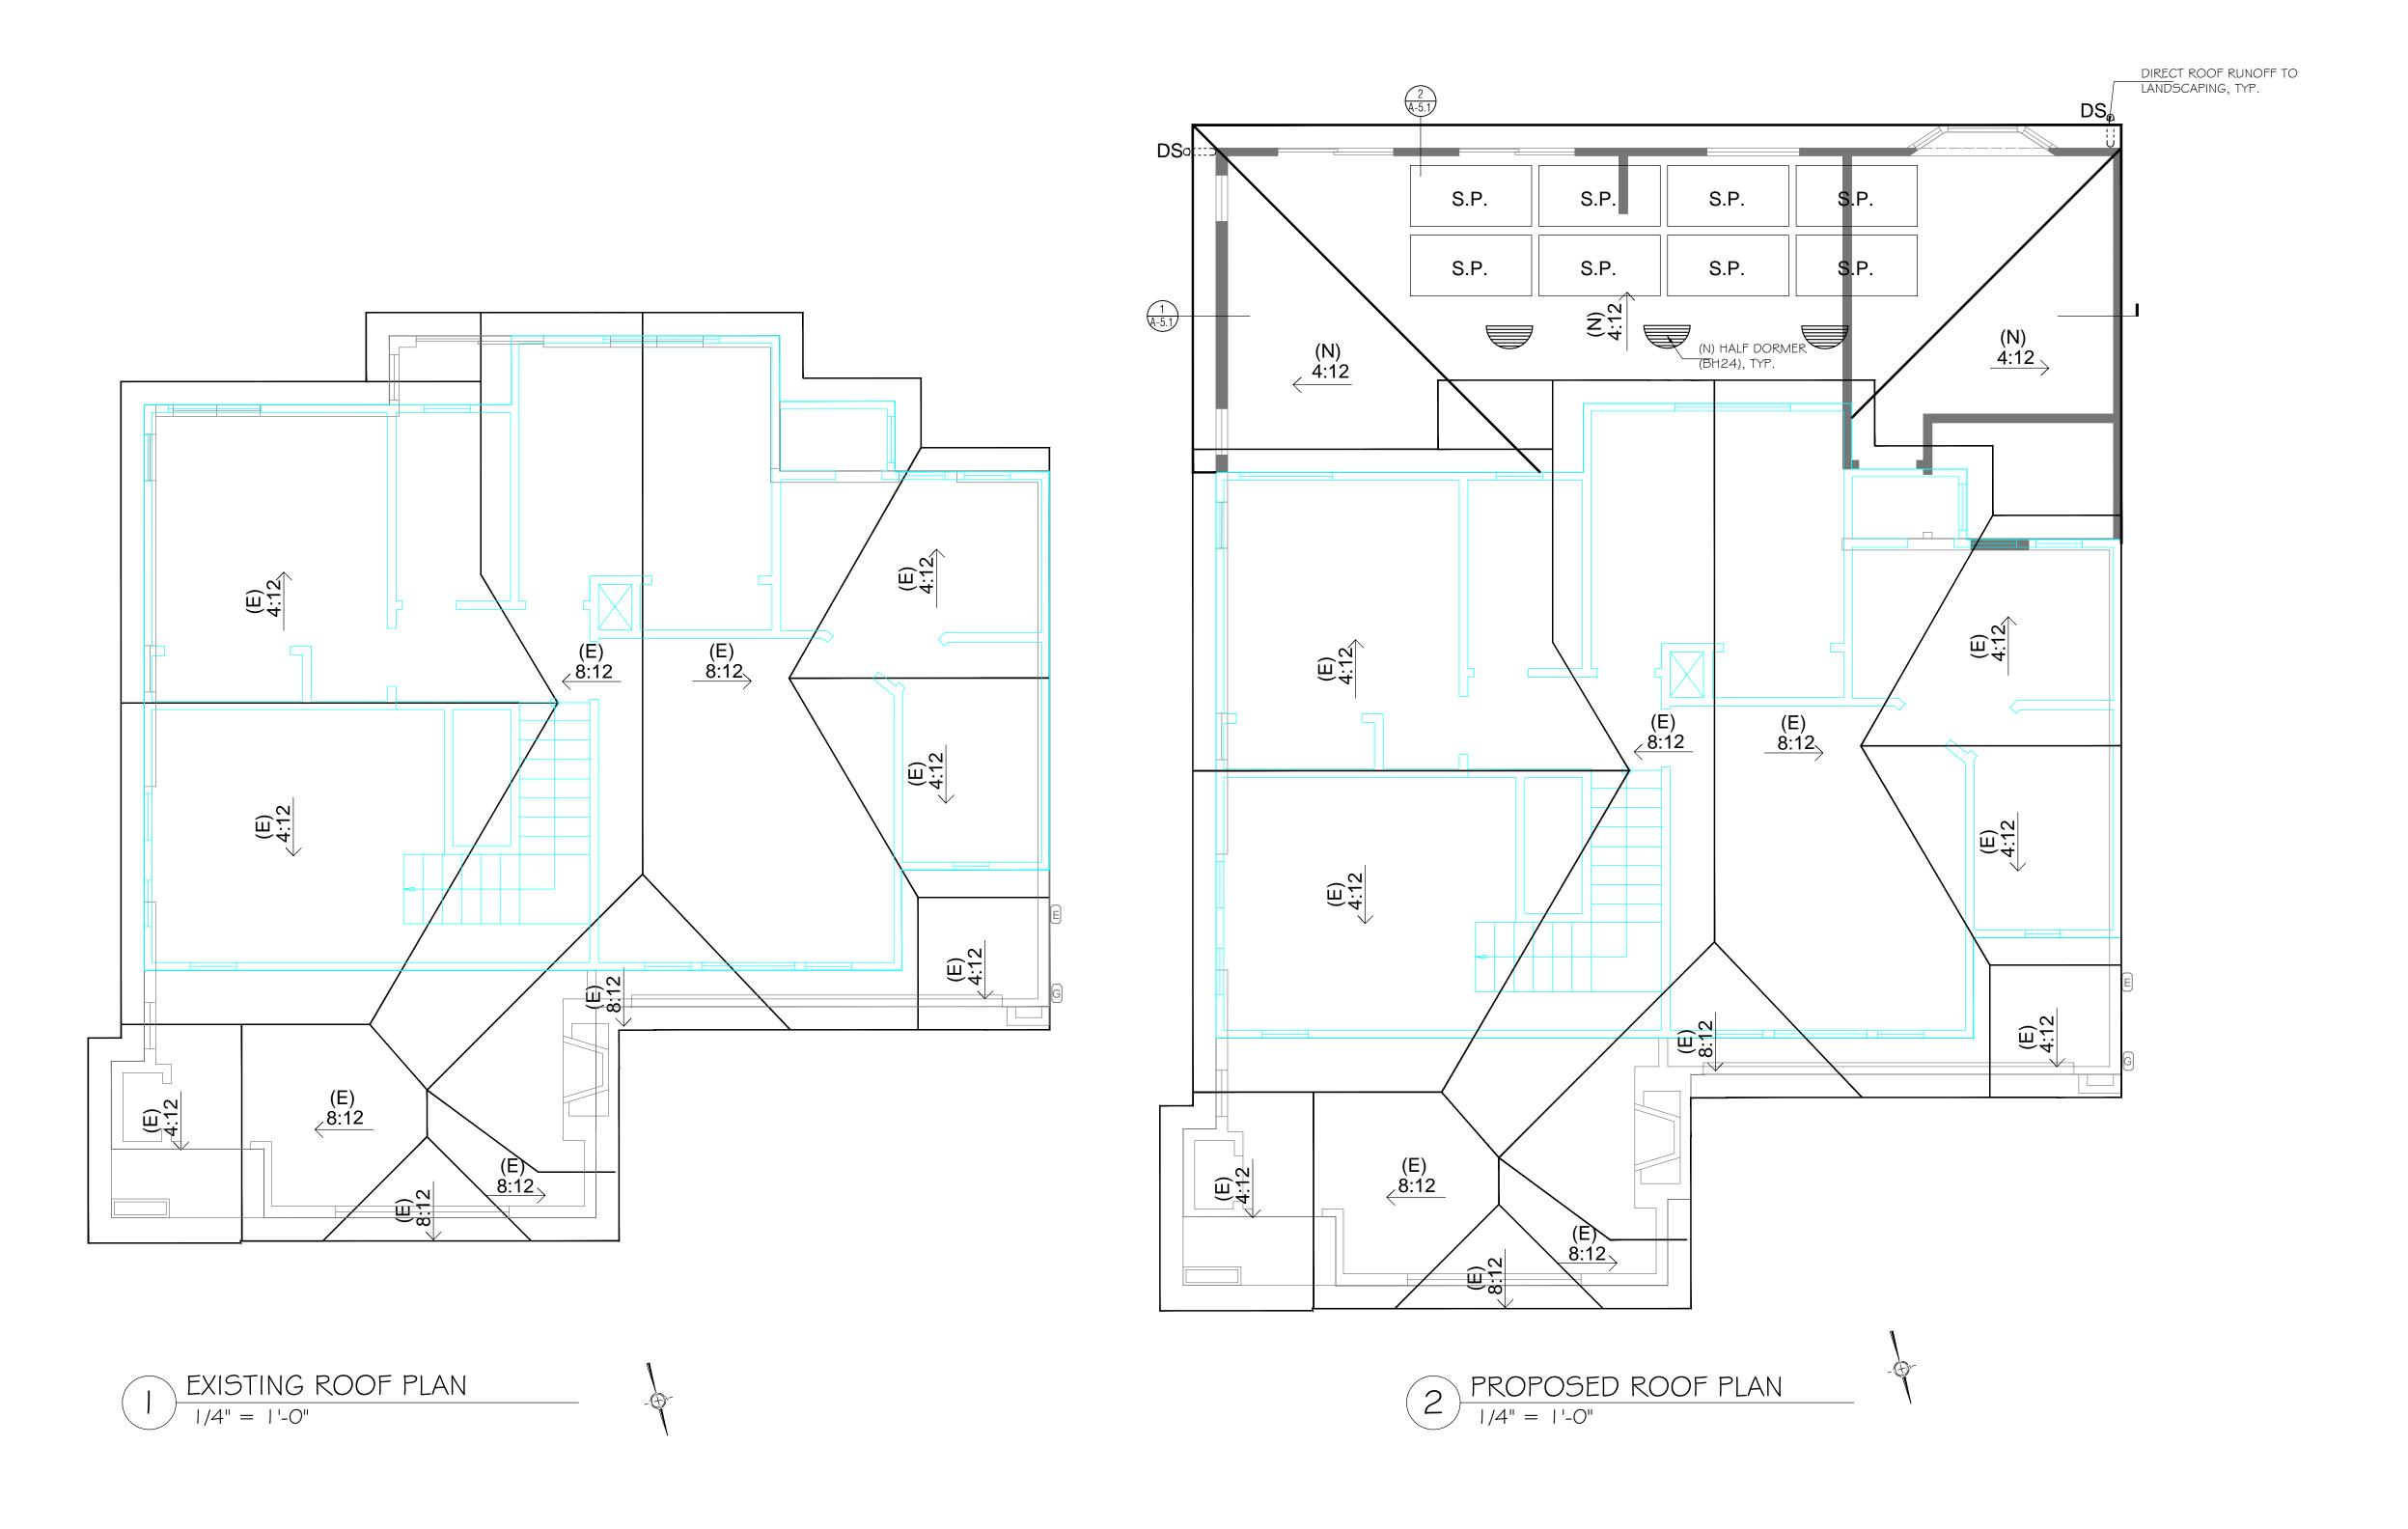
PROPOSED FLOOR

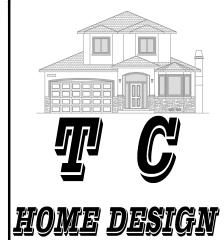
REVISION RESUBMIT: 11-22-20 | ML

2 RESUBMIT: 1-30-21

DRAWN BY: ML

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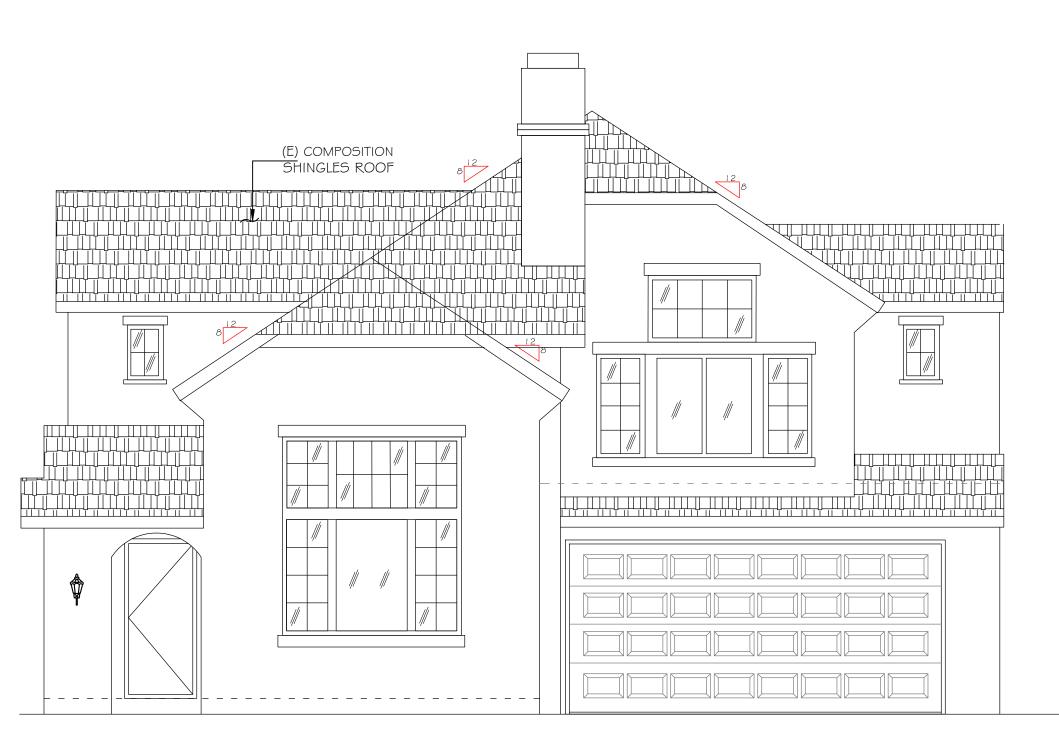
SHEET AND PROJECT TITLES:

EXISTING AND PROPOSED ROOF PLANS

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RESUBMIT: 1-30-21 ML

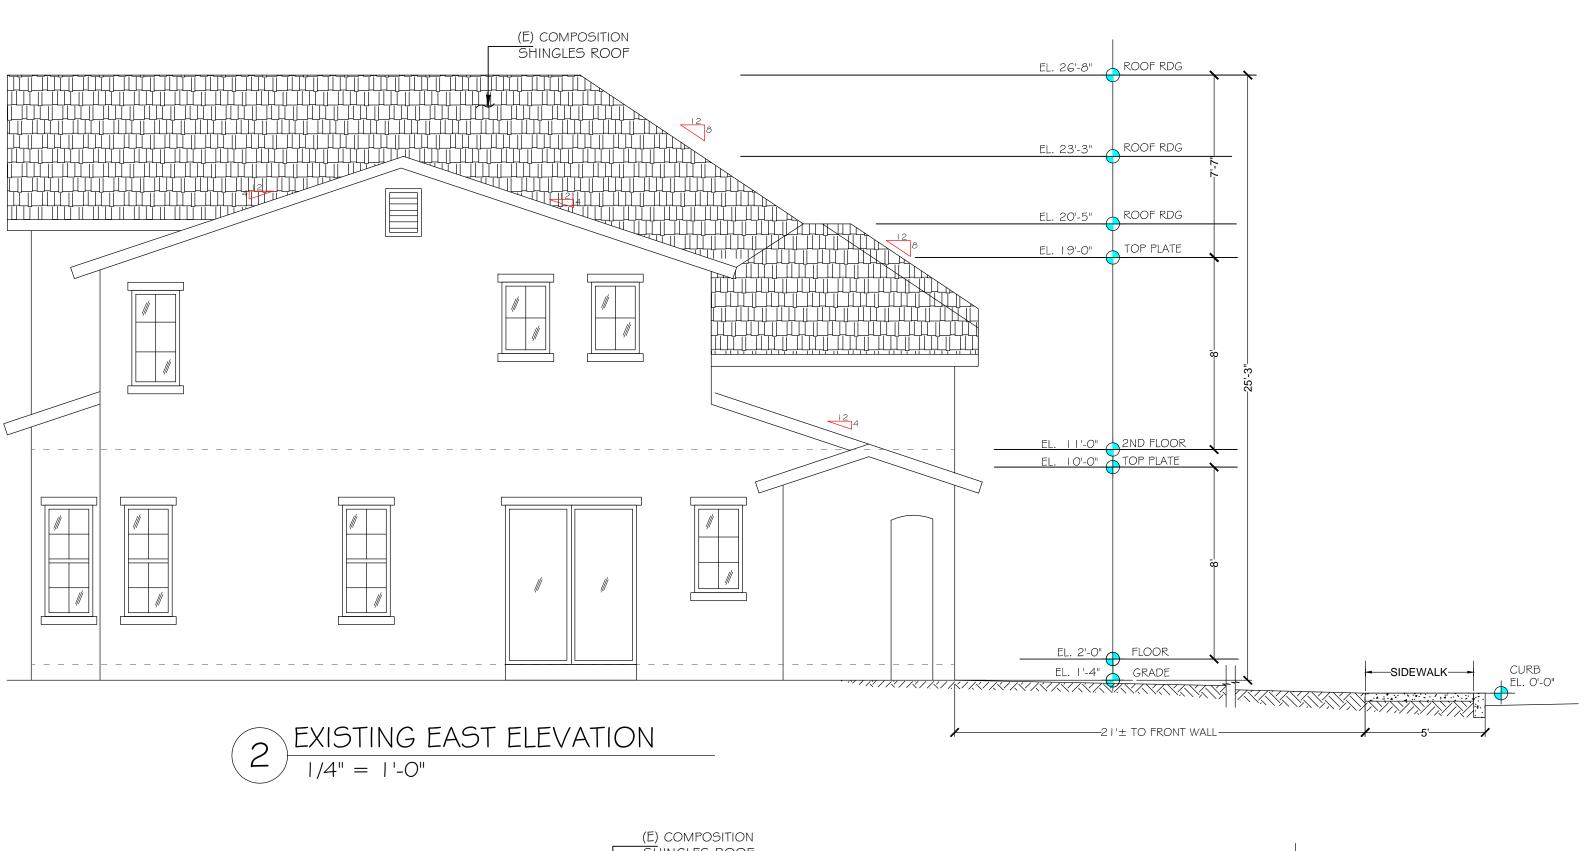
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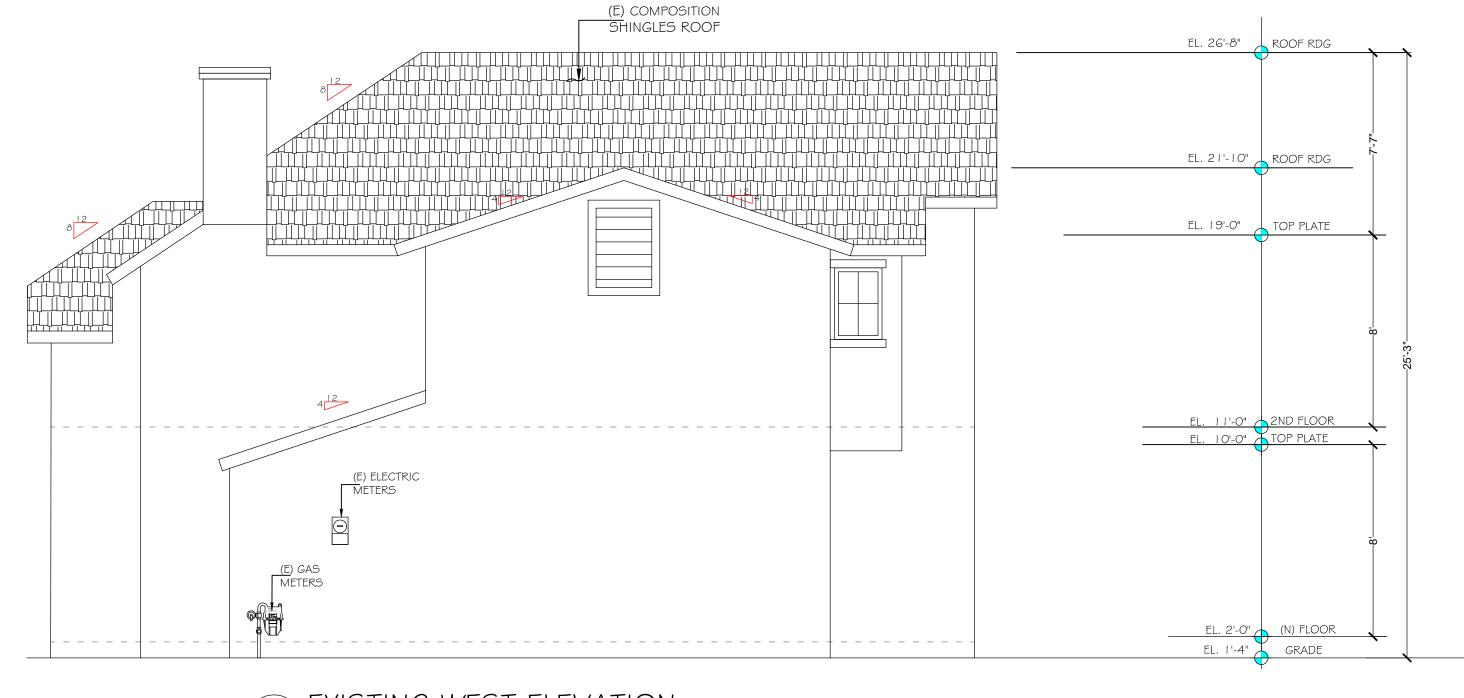






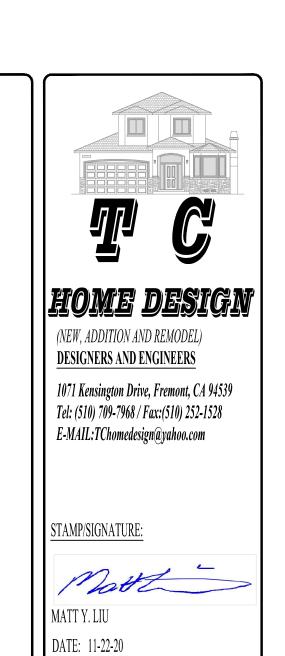
 $3 \frac{\text{EXISTING SOUTH ELEVATION}}{1/4" = 1'-0"}$





EXISTING WEST ELEVATION

1/4" = 1'-0"



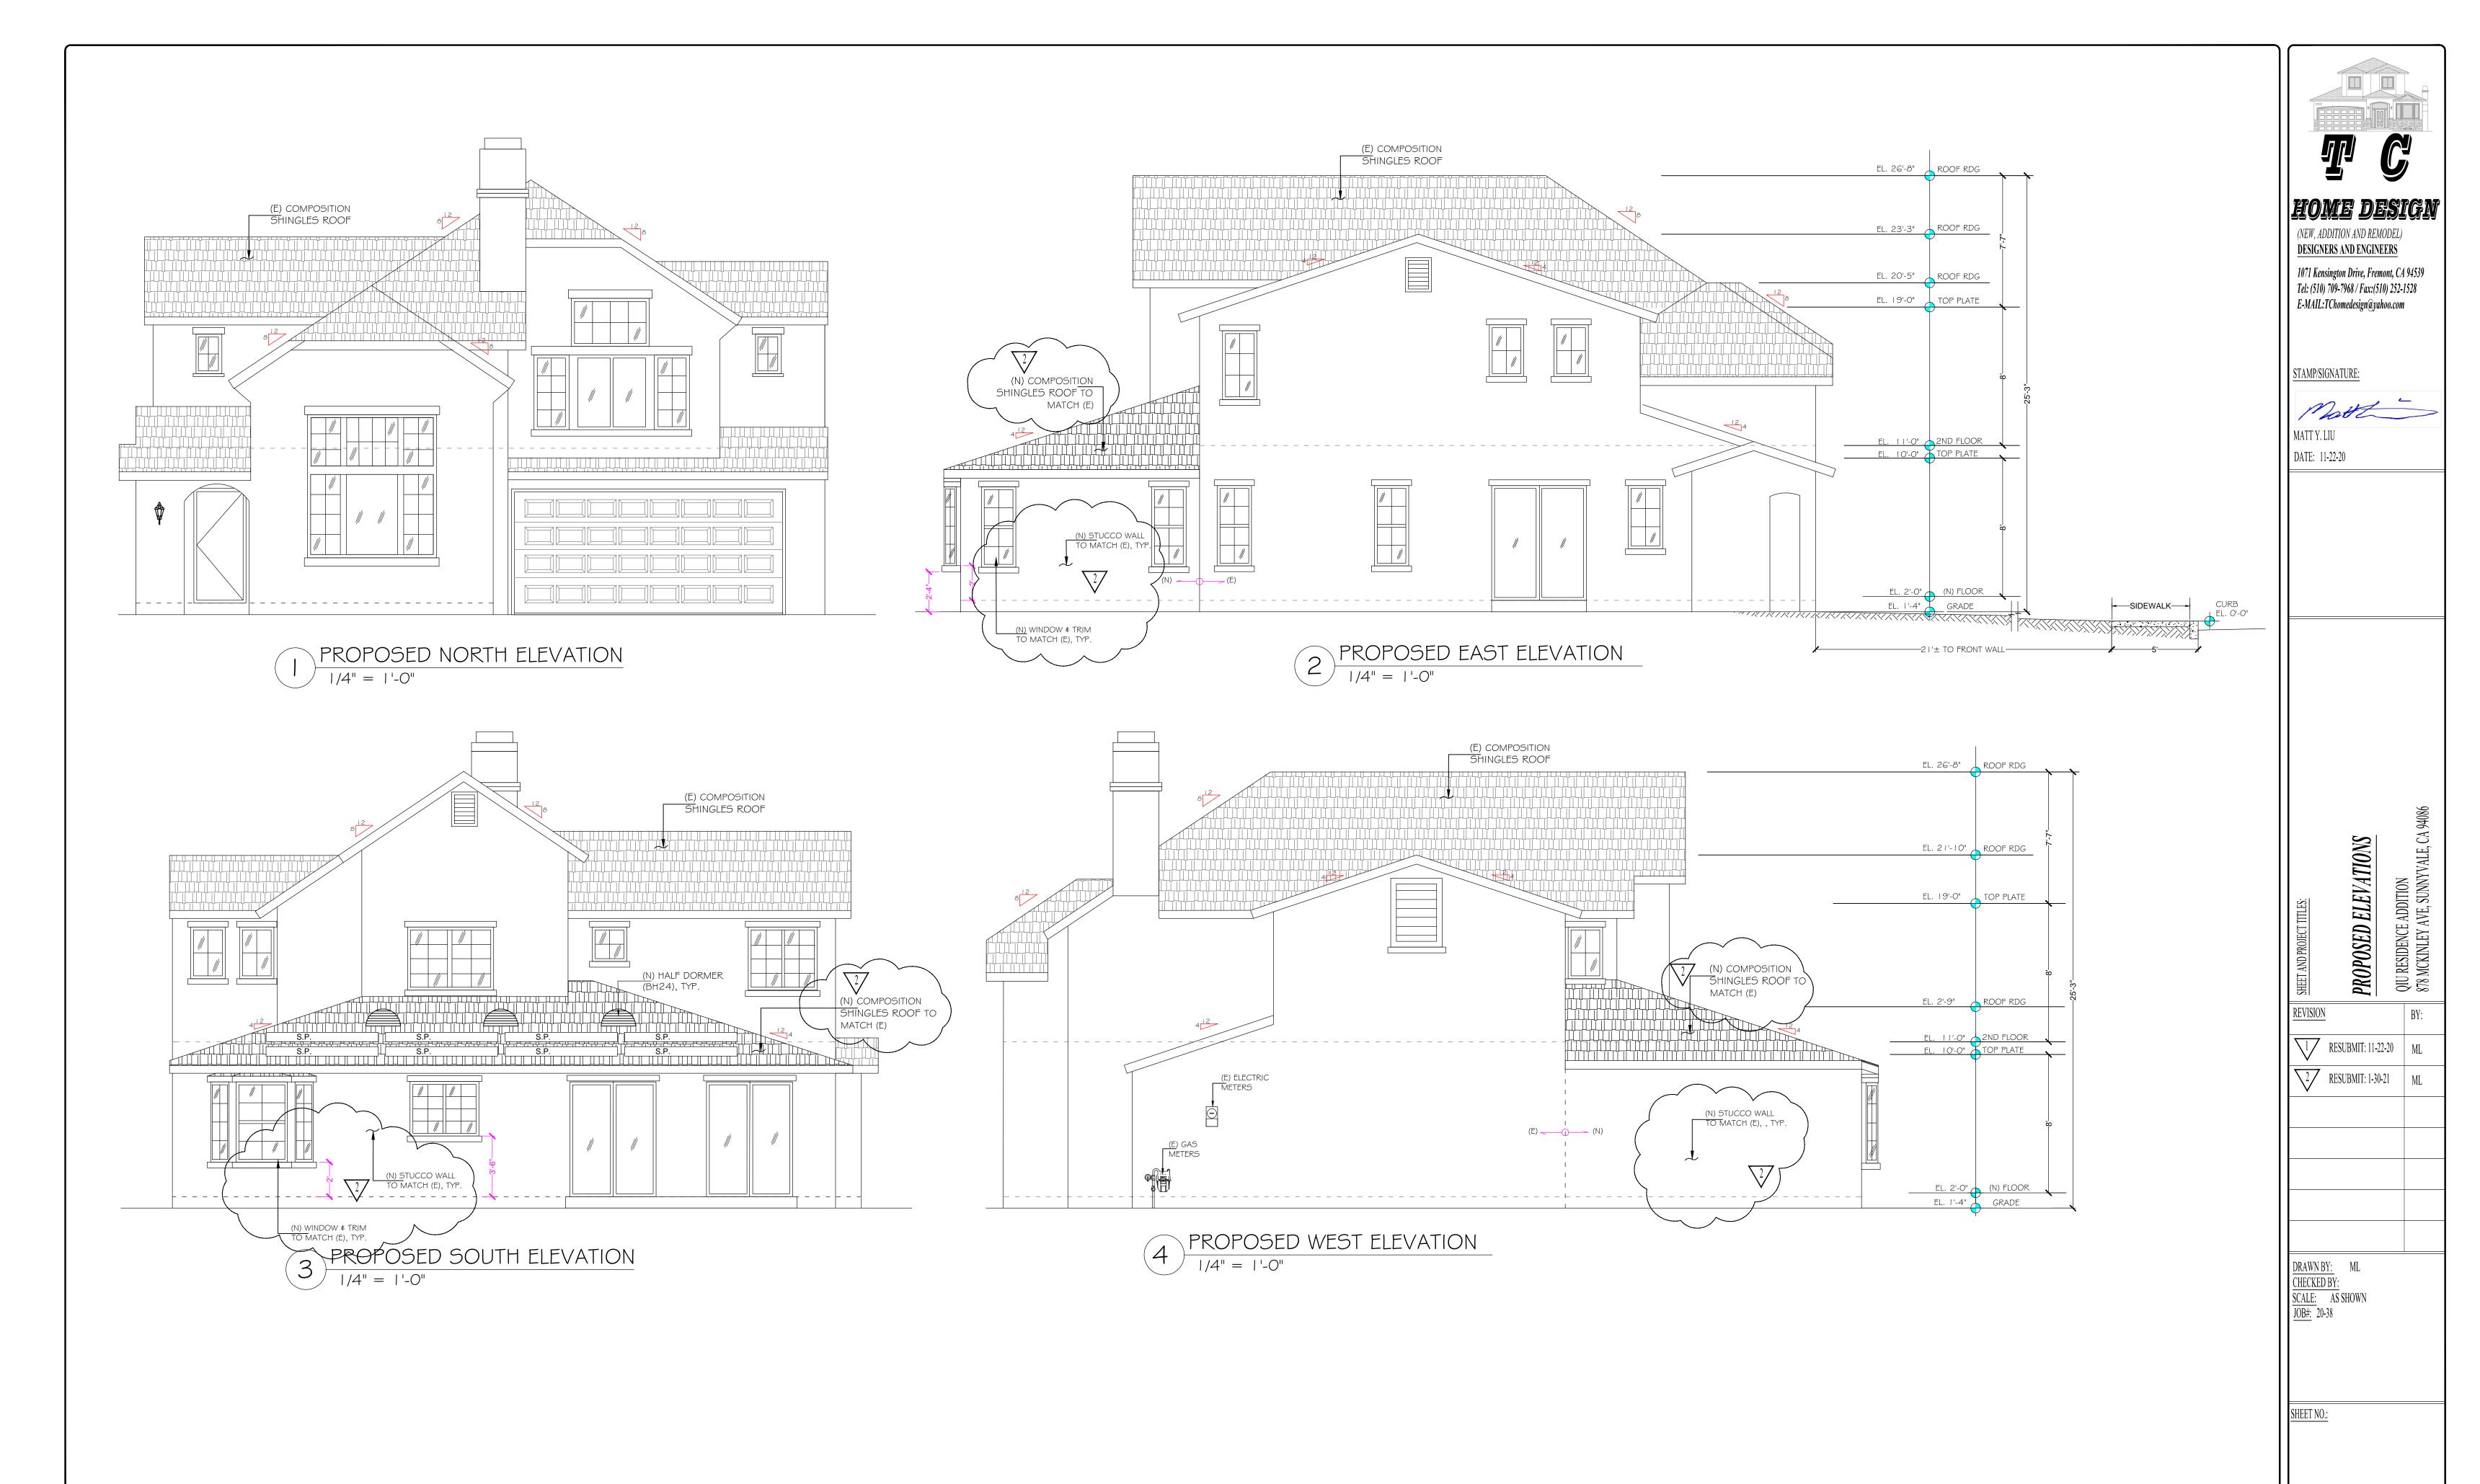
EXISTING ELEVATIONS

1 RESUBMIT: 11-22-20 ML

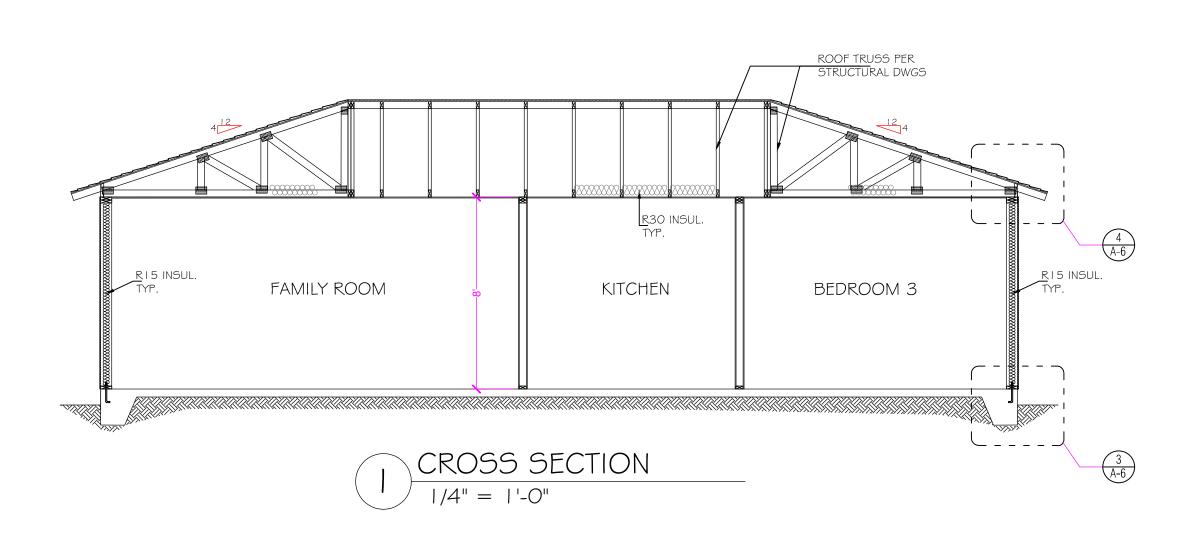
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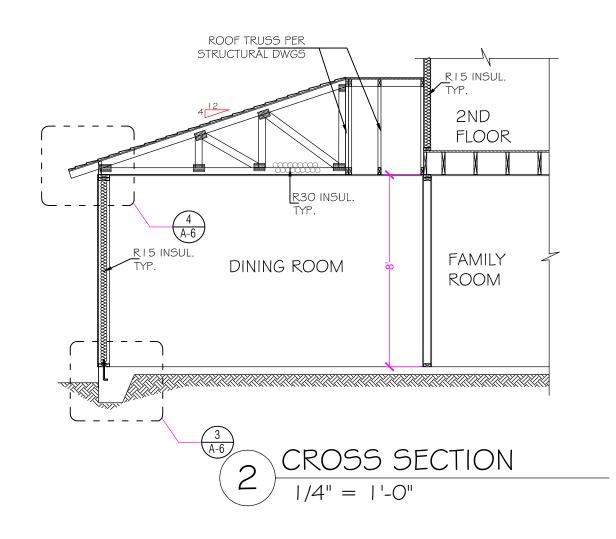
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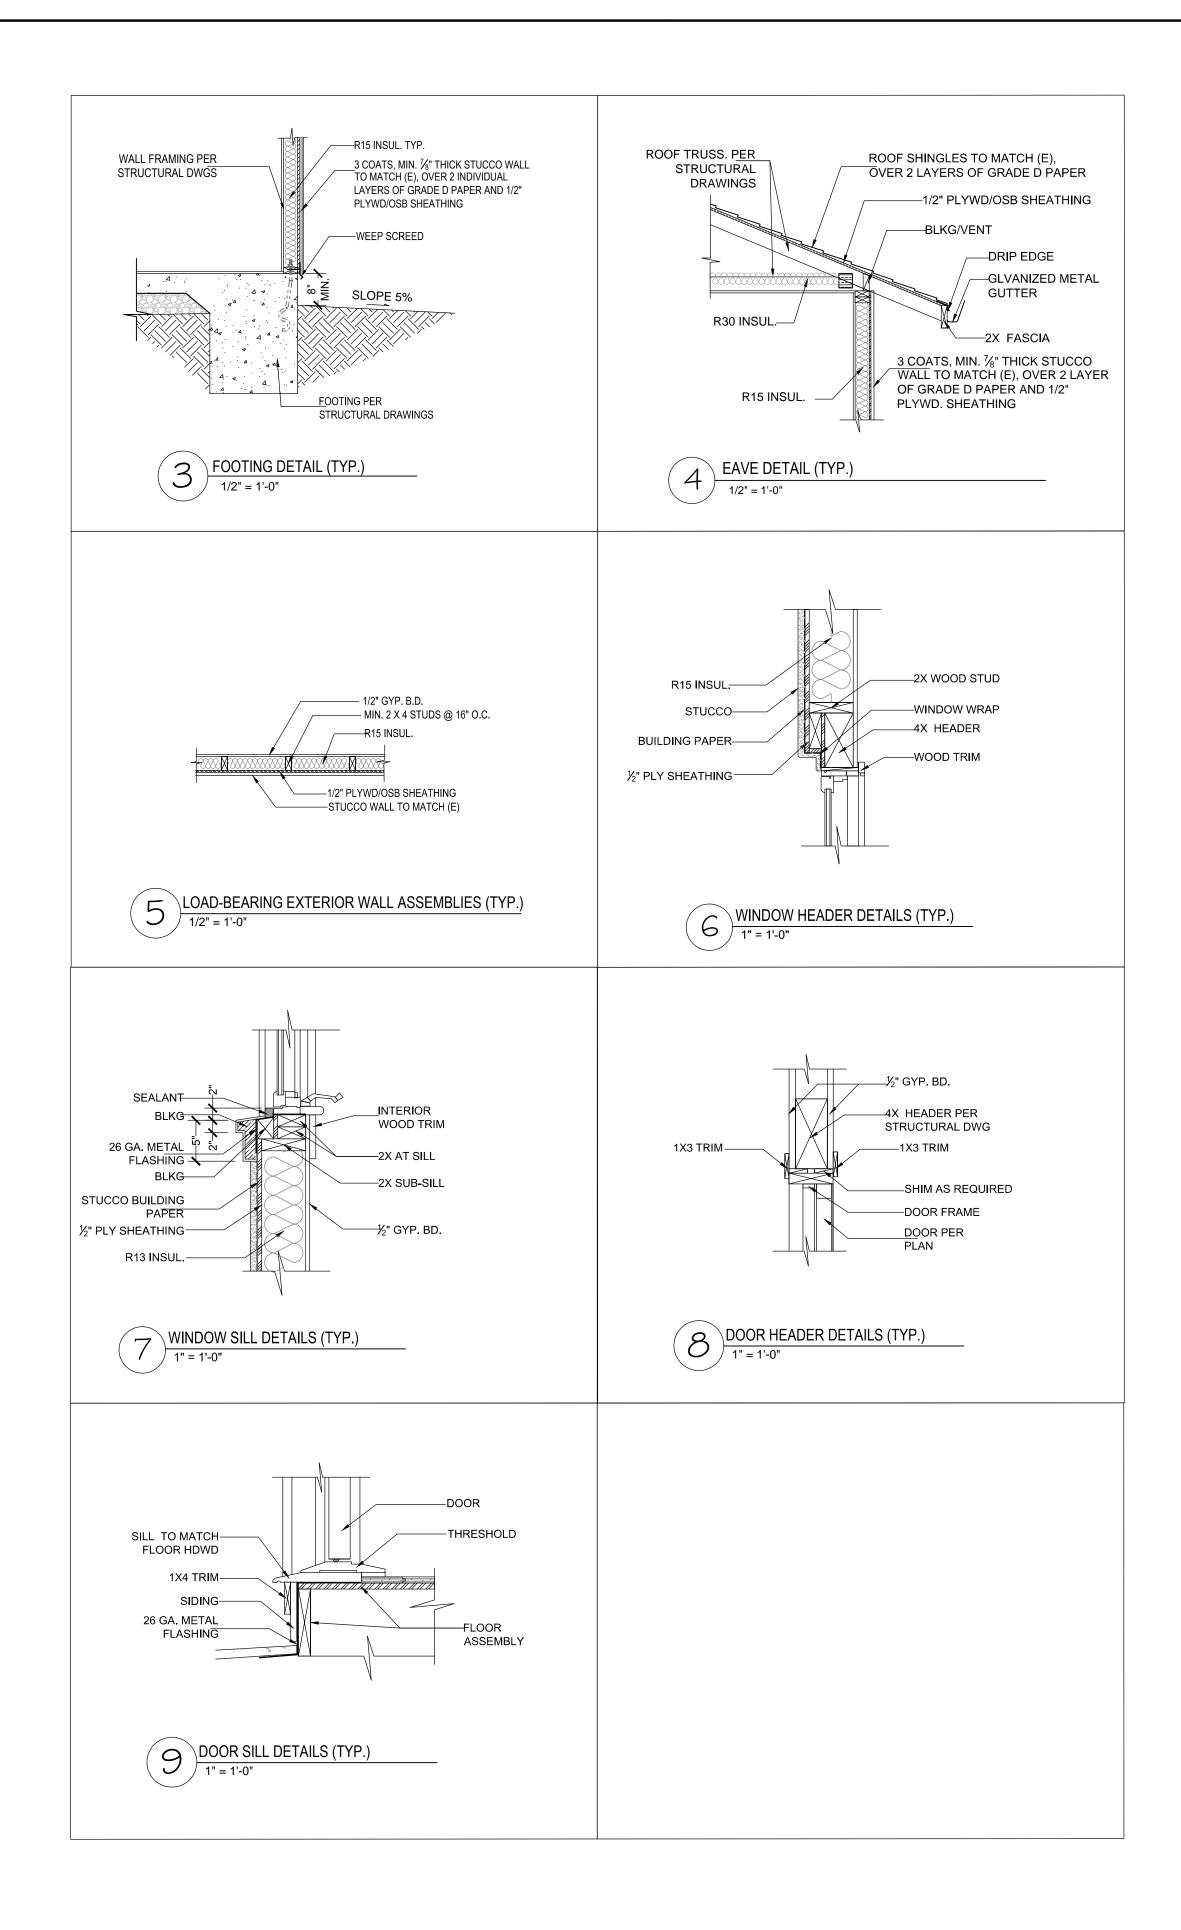
REVISION

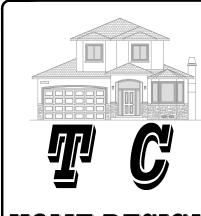


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CROSS SECTIONS AND DETAILS QIU RESIDENCE ADDITION 878 MCKINLEY AVE, SUNNYVALE, C.

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